# DRAWING LIST VOLUME 1:

BUILDING CODE ANALYSIS, EGRESS PLANS, TYPICAL DETAILS DOCUMENTS PRIMARILY FOR THE CONSTRUCTION STRUCTURE, ENVELOPE, CORE / SHELL AND MAJOR BUILDING SYSTEMS.

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CD-101	DEMOLITION PLAN
C-101	SITE PLAN
C-101	FIRE TRUCK CIRCULATION PLAN
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BALANCE OF ENGINEERING SCOPE CONTINU	ES IN VOLUME 2


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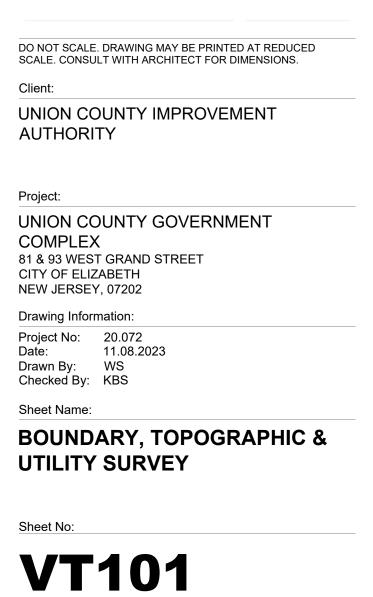
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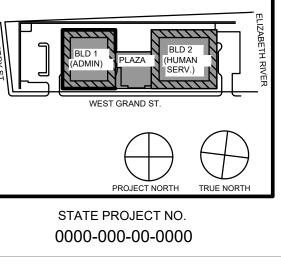
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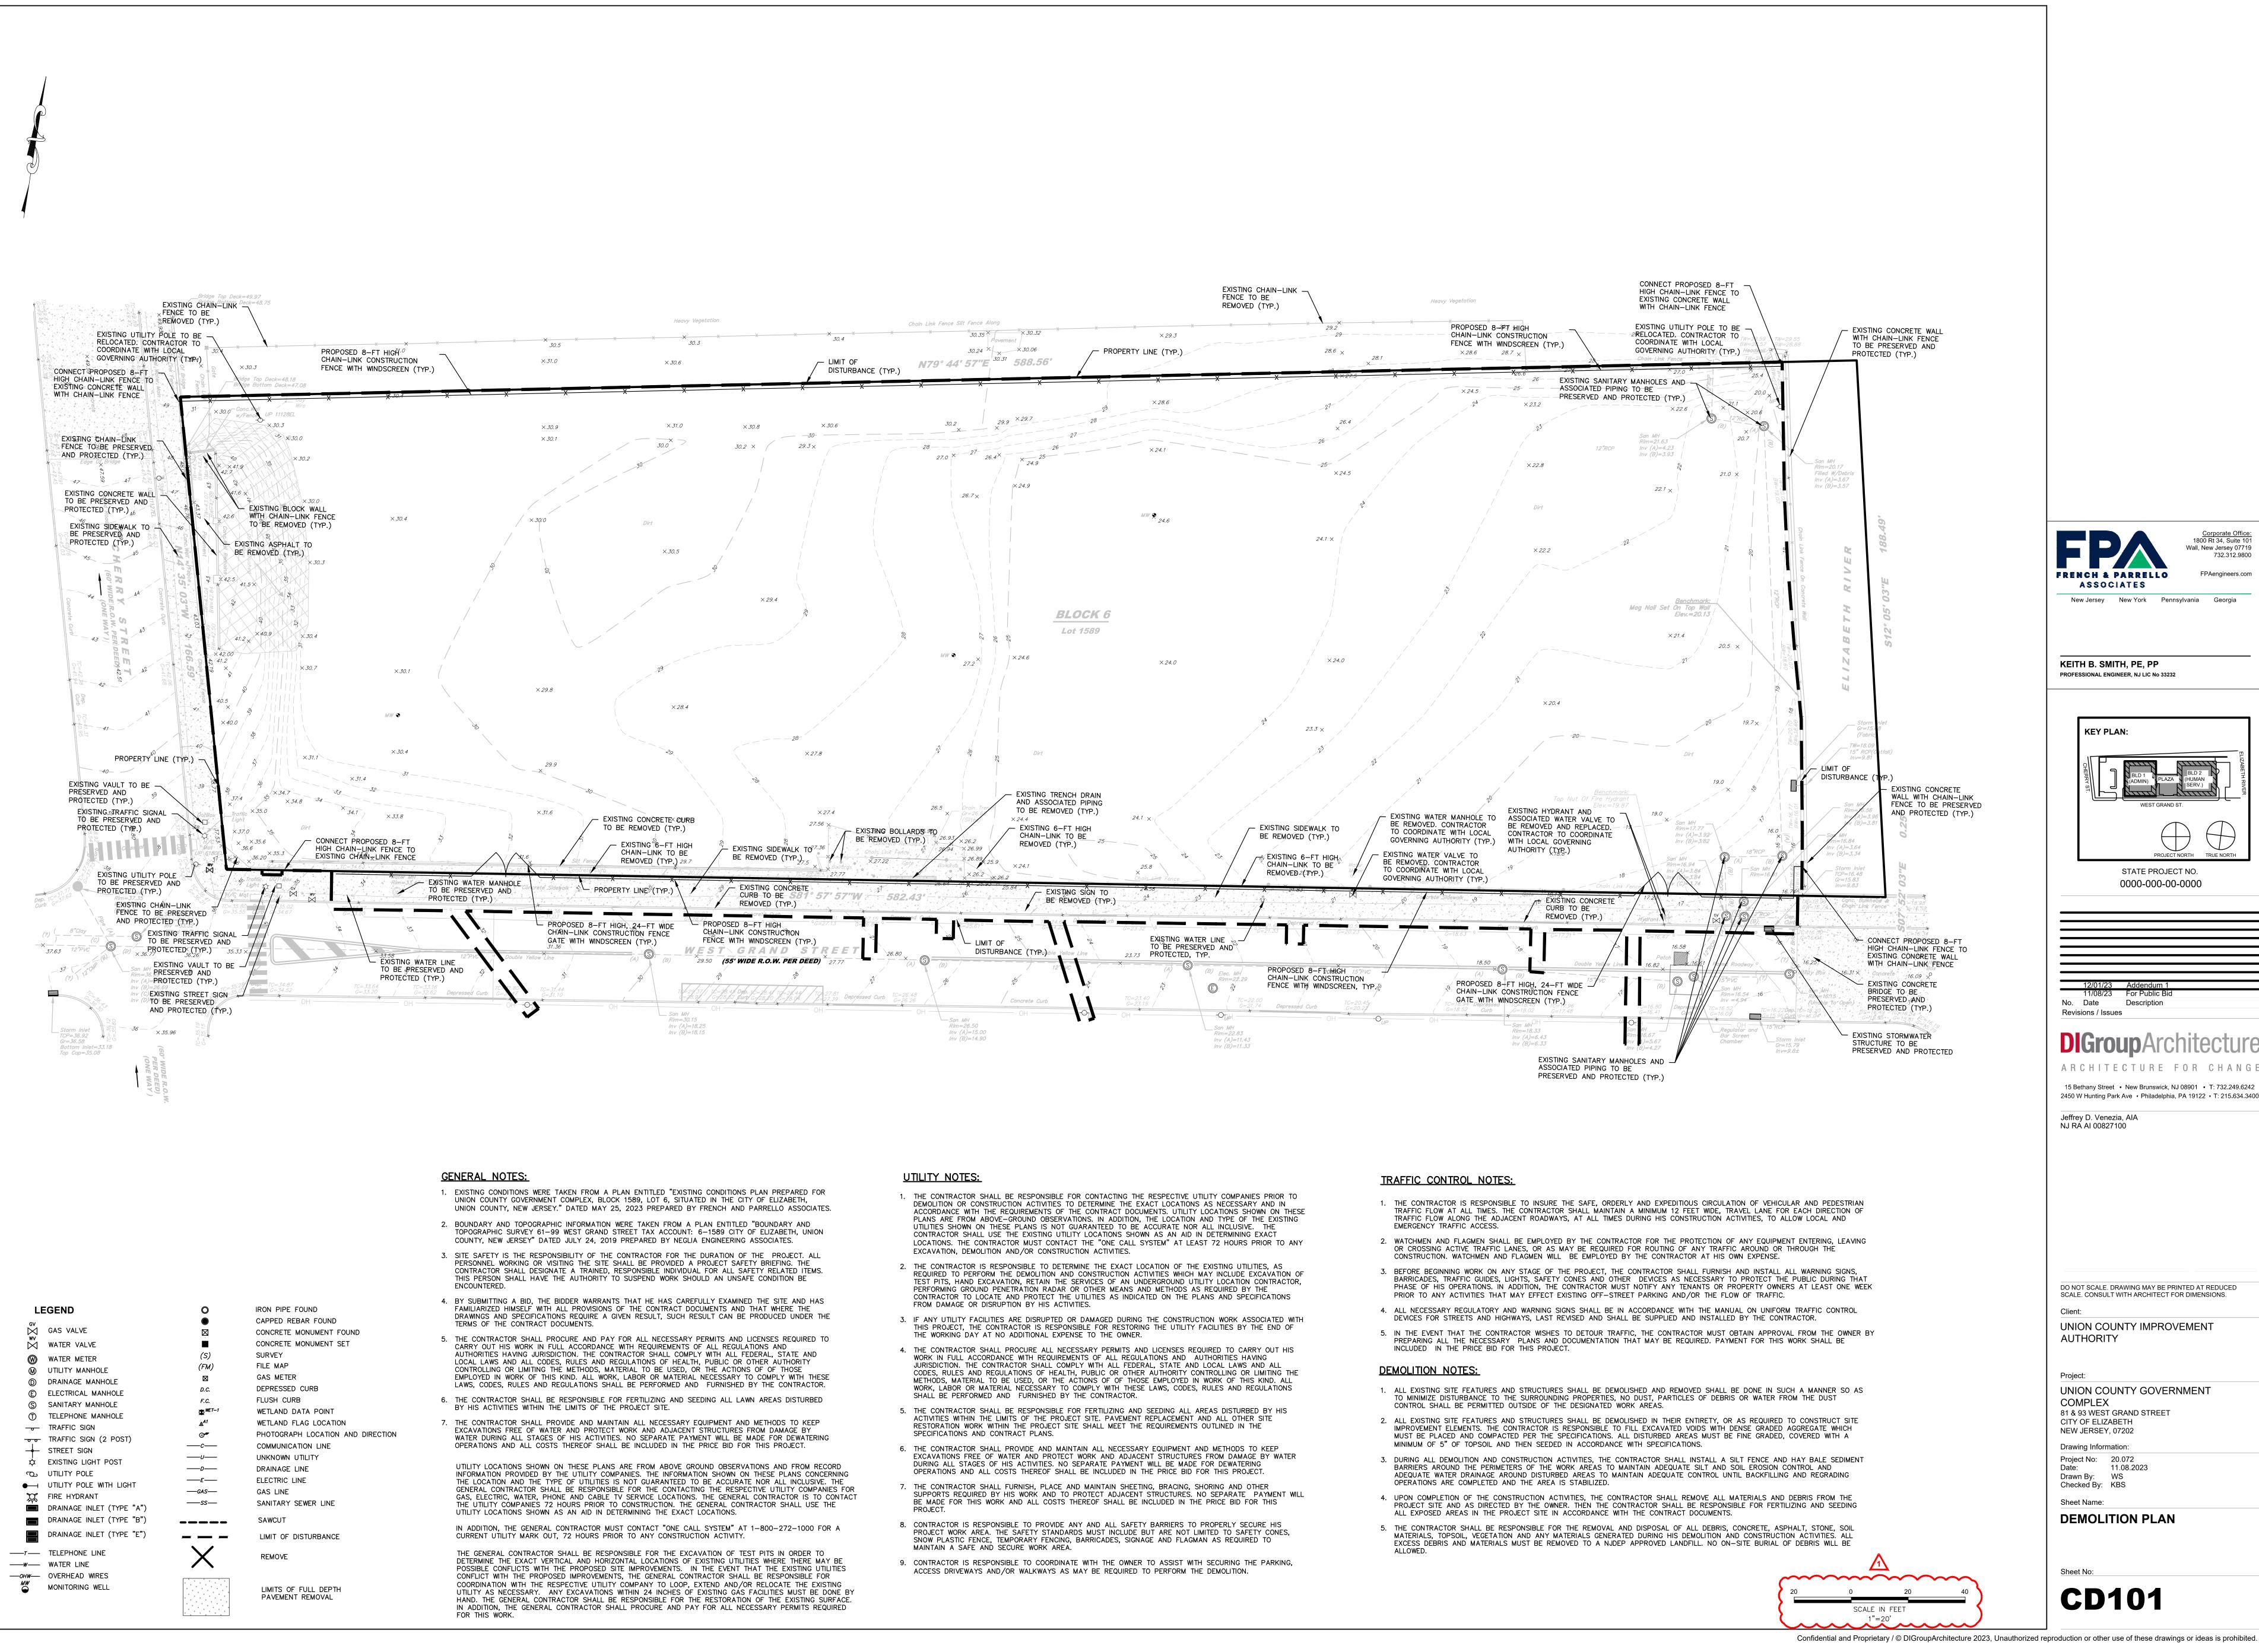
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Sheet Name: **DEMOLITION PLAN** Sheet No: **CD101** 

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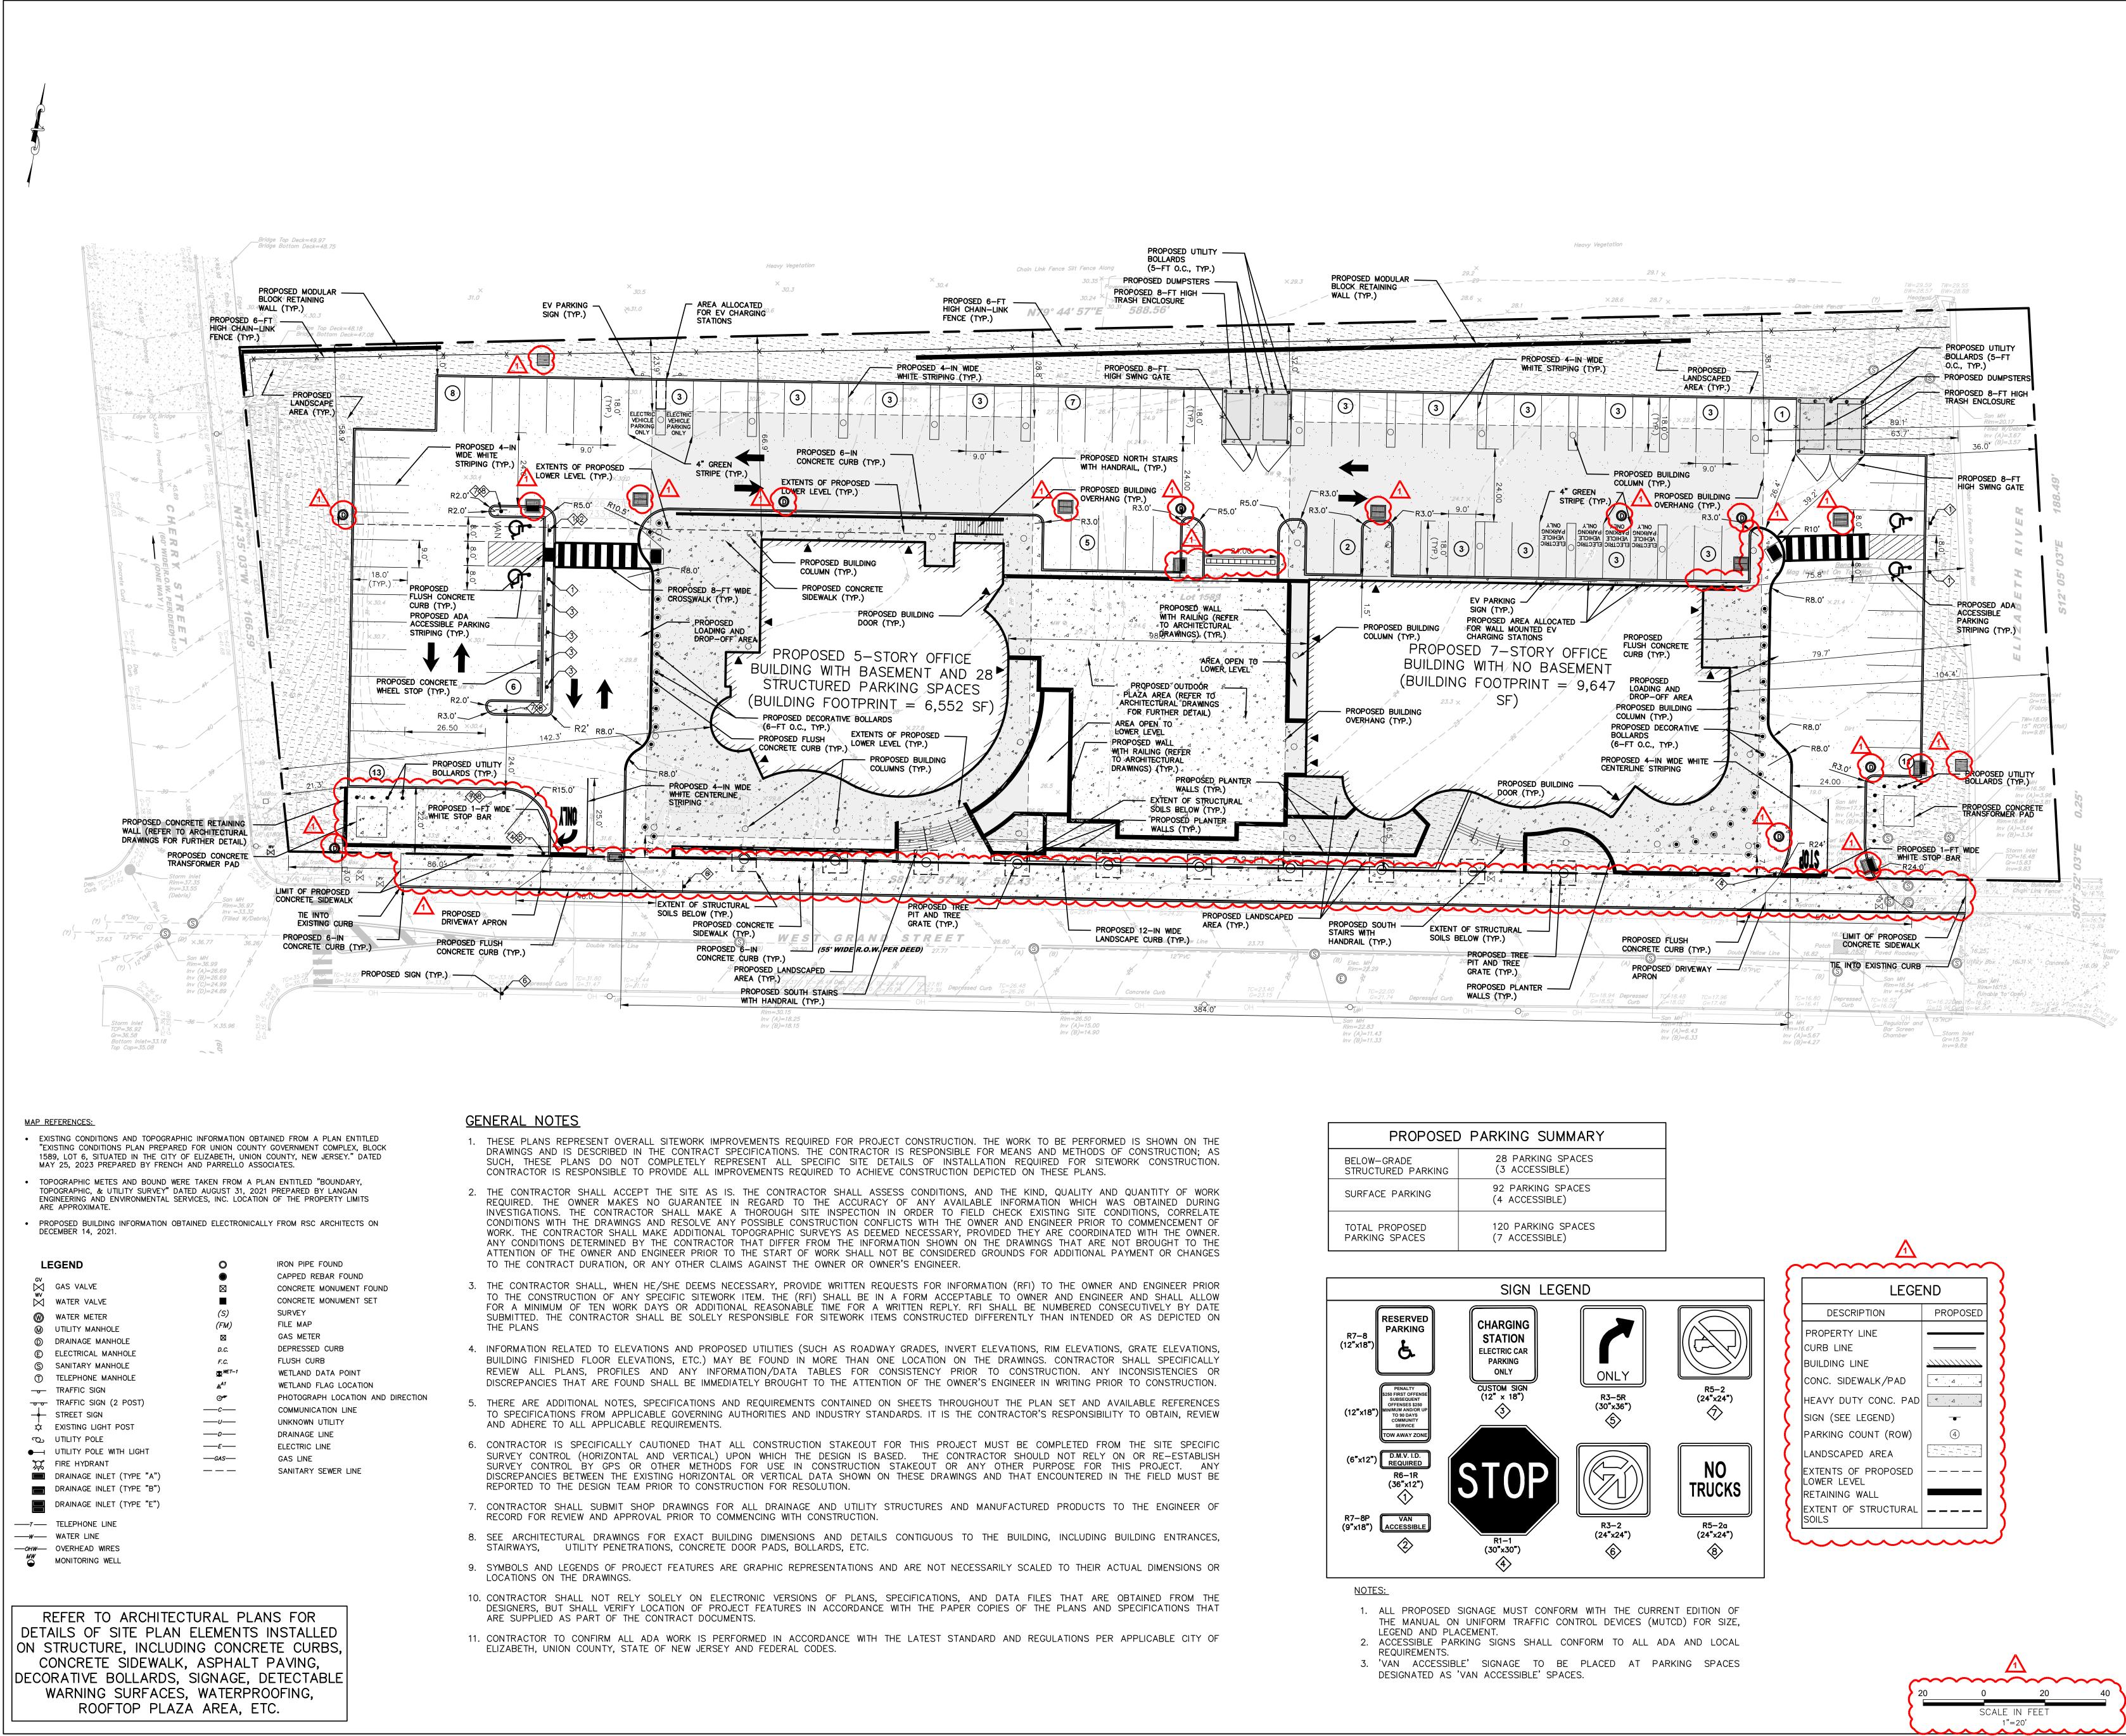
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5	92 PARKING SPACES (4 ACCESSIBLE)
	120 PARKING SPACES (7 ACCESSIBLE)


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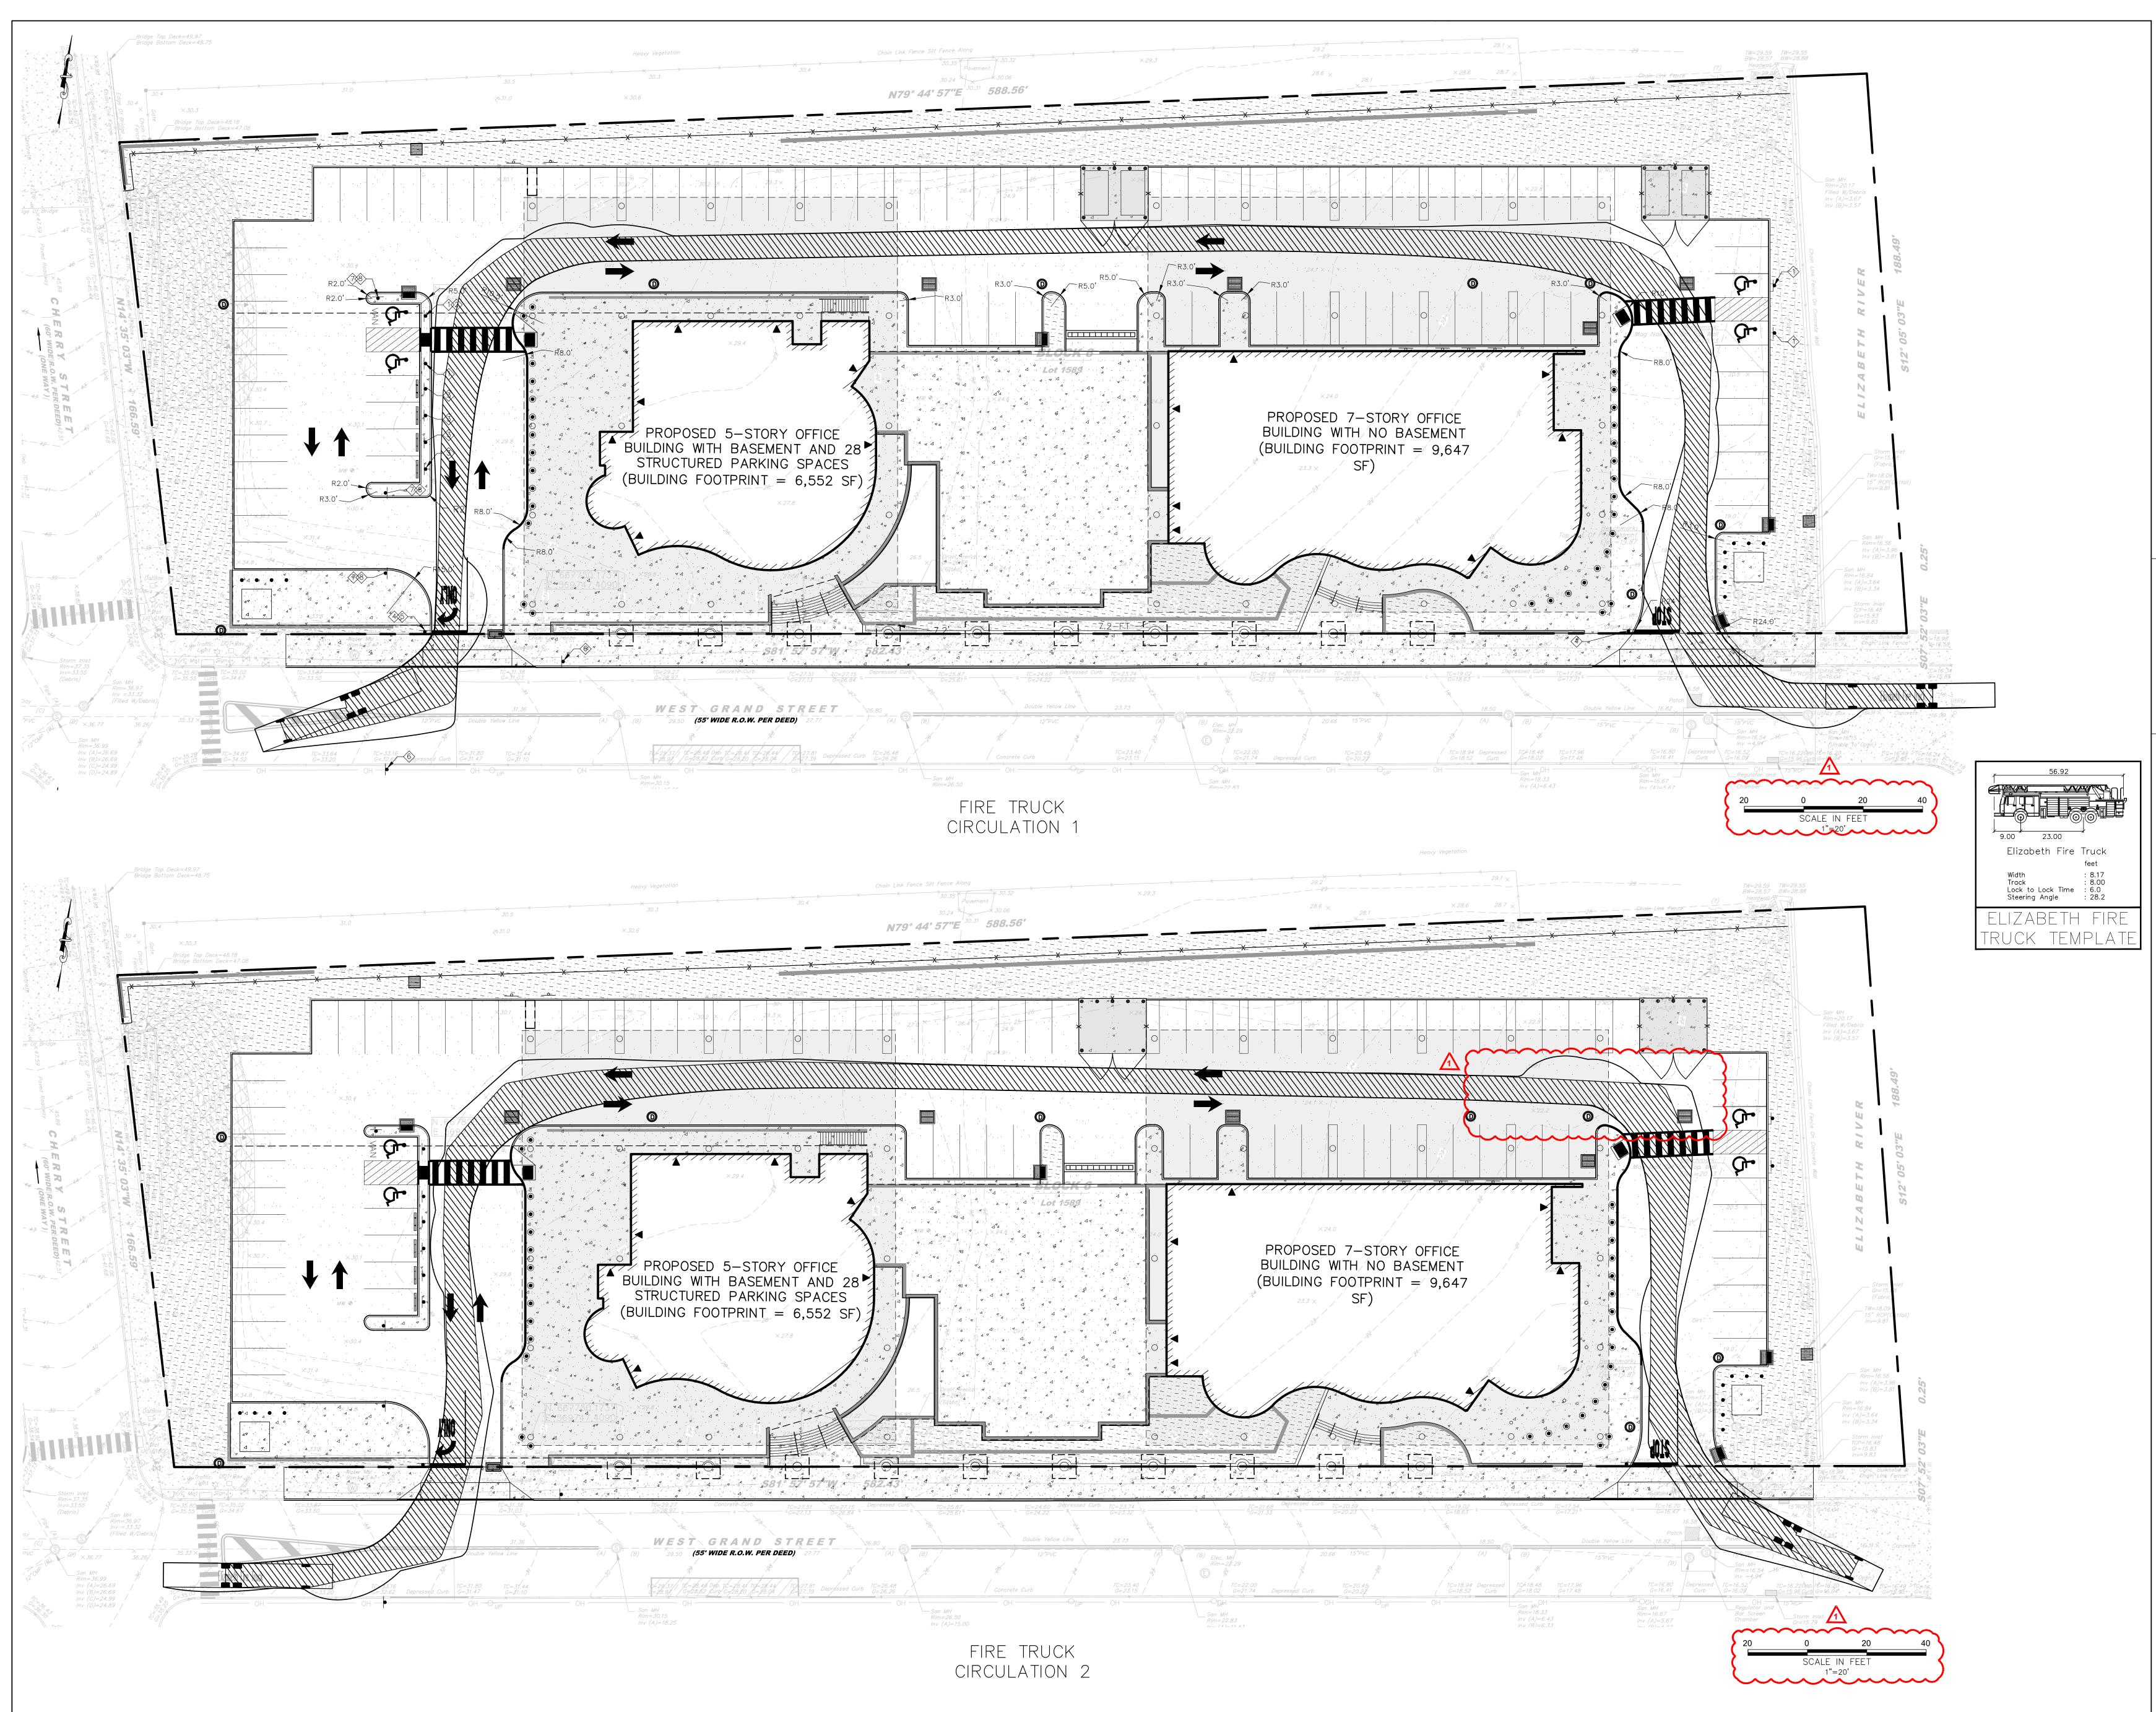
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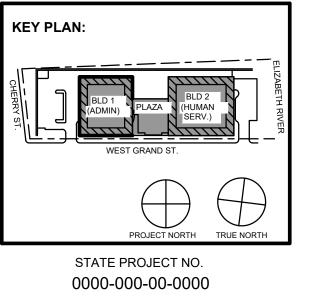
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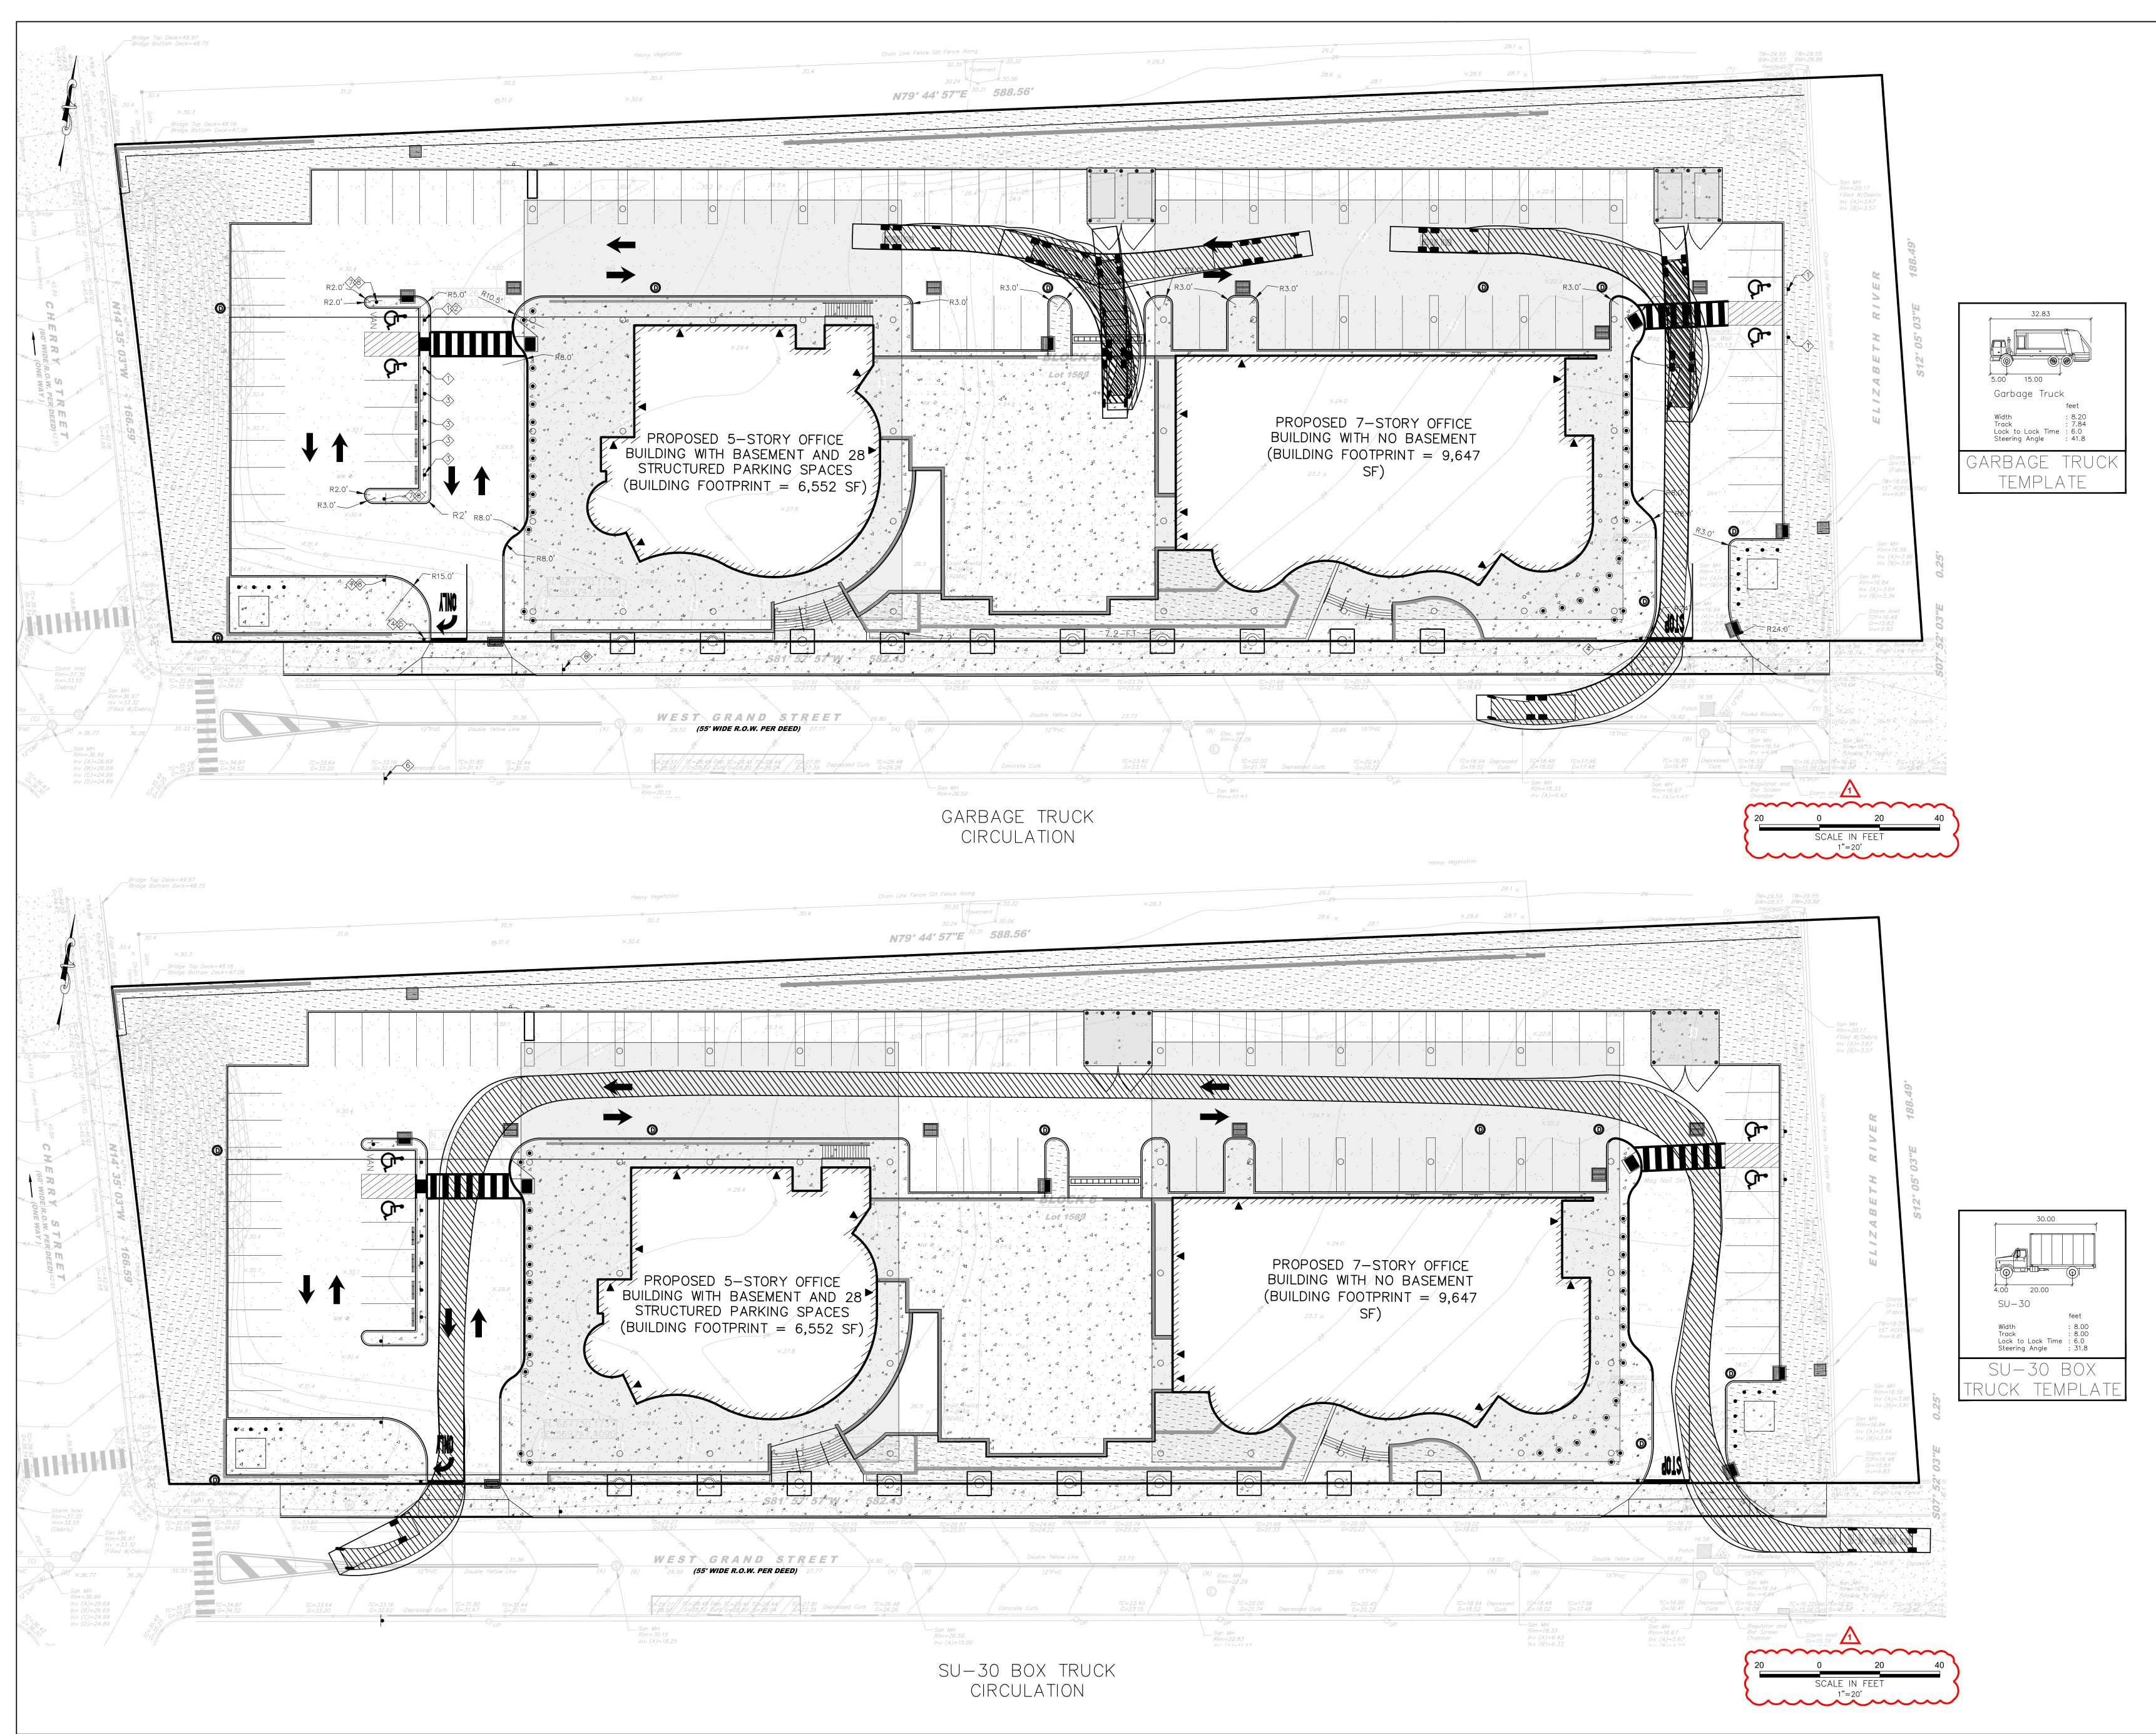
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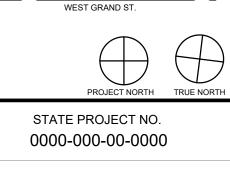


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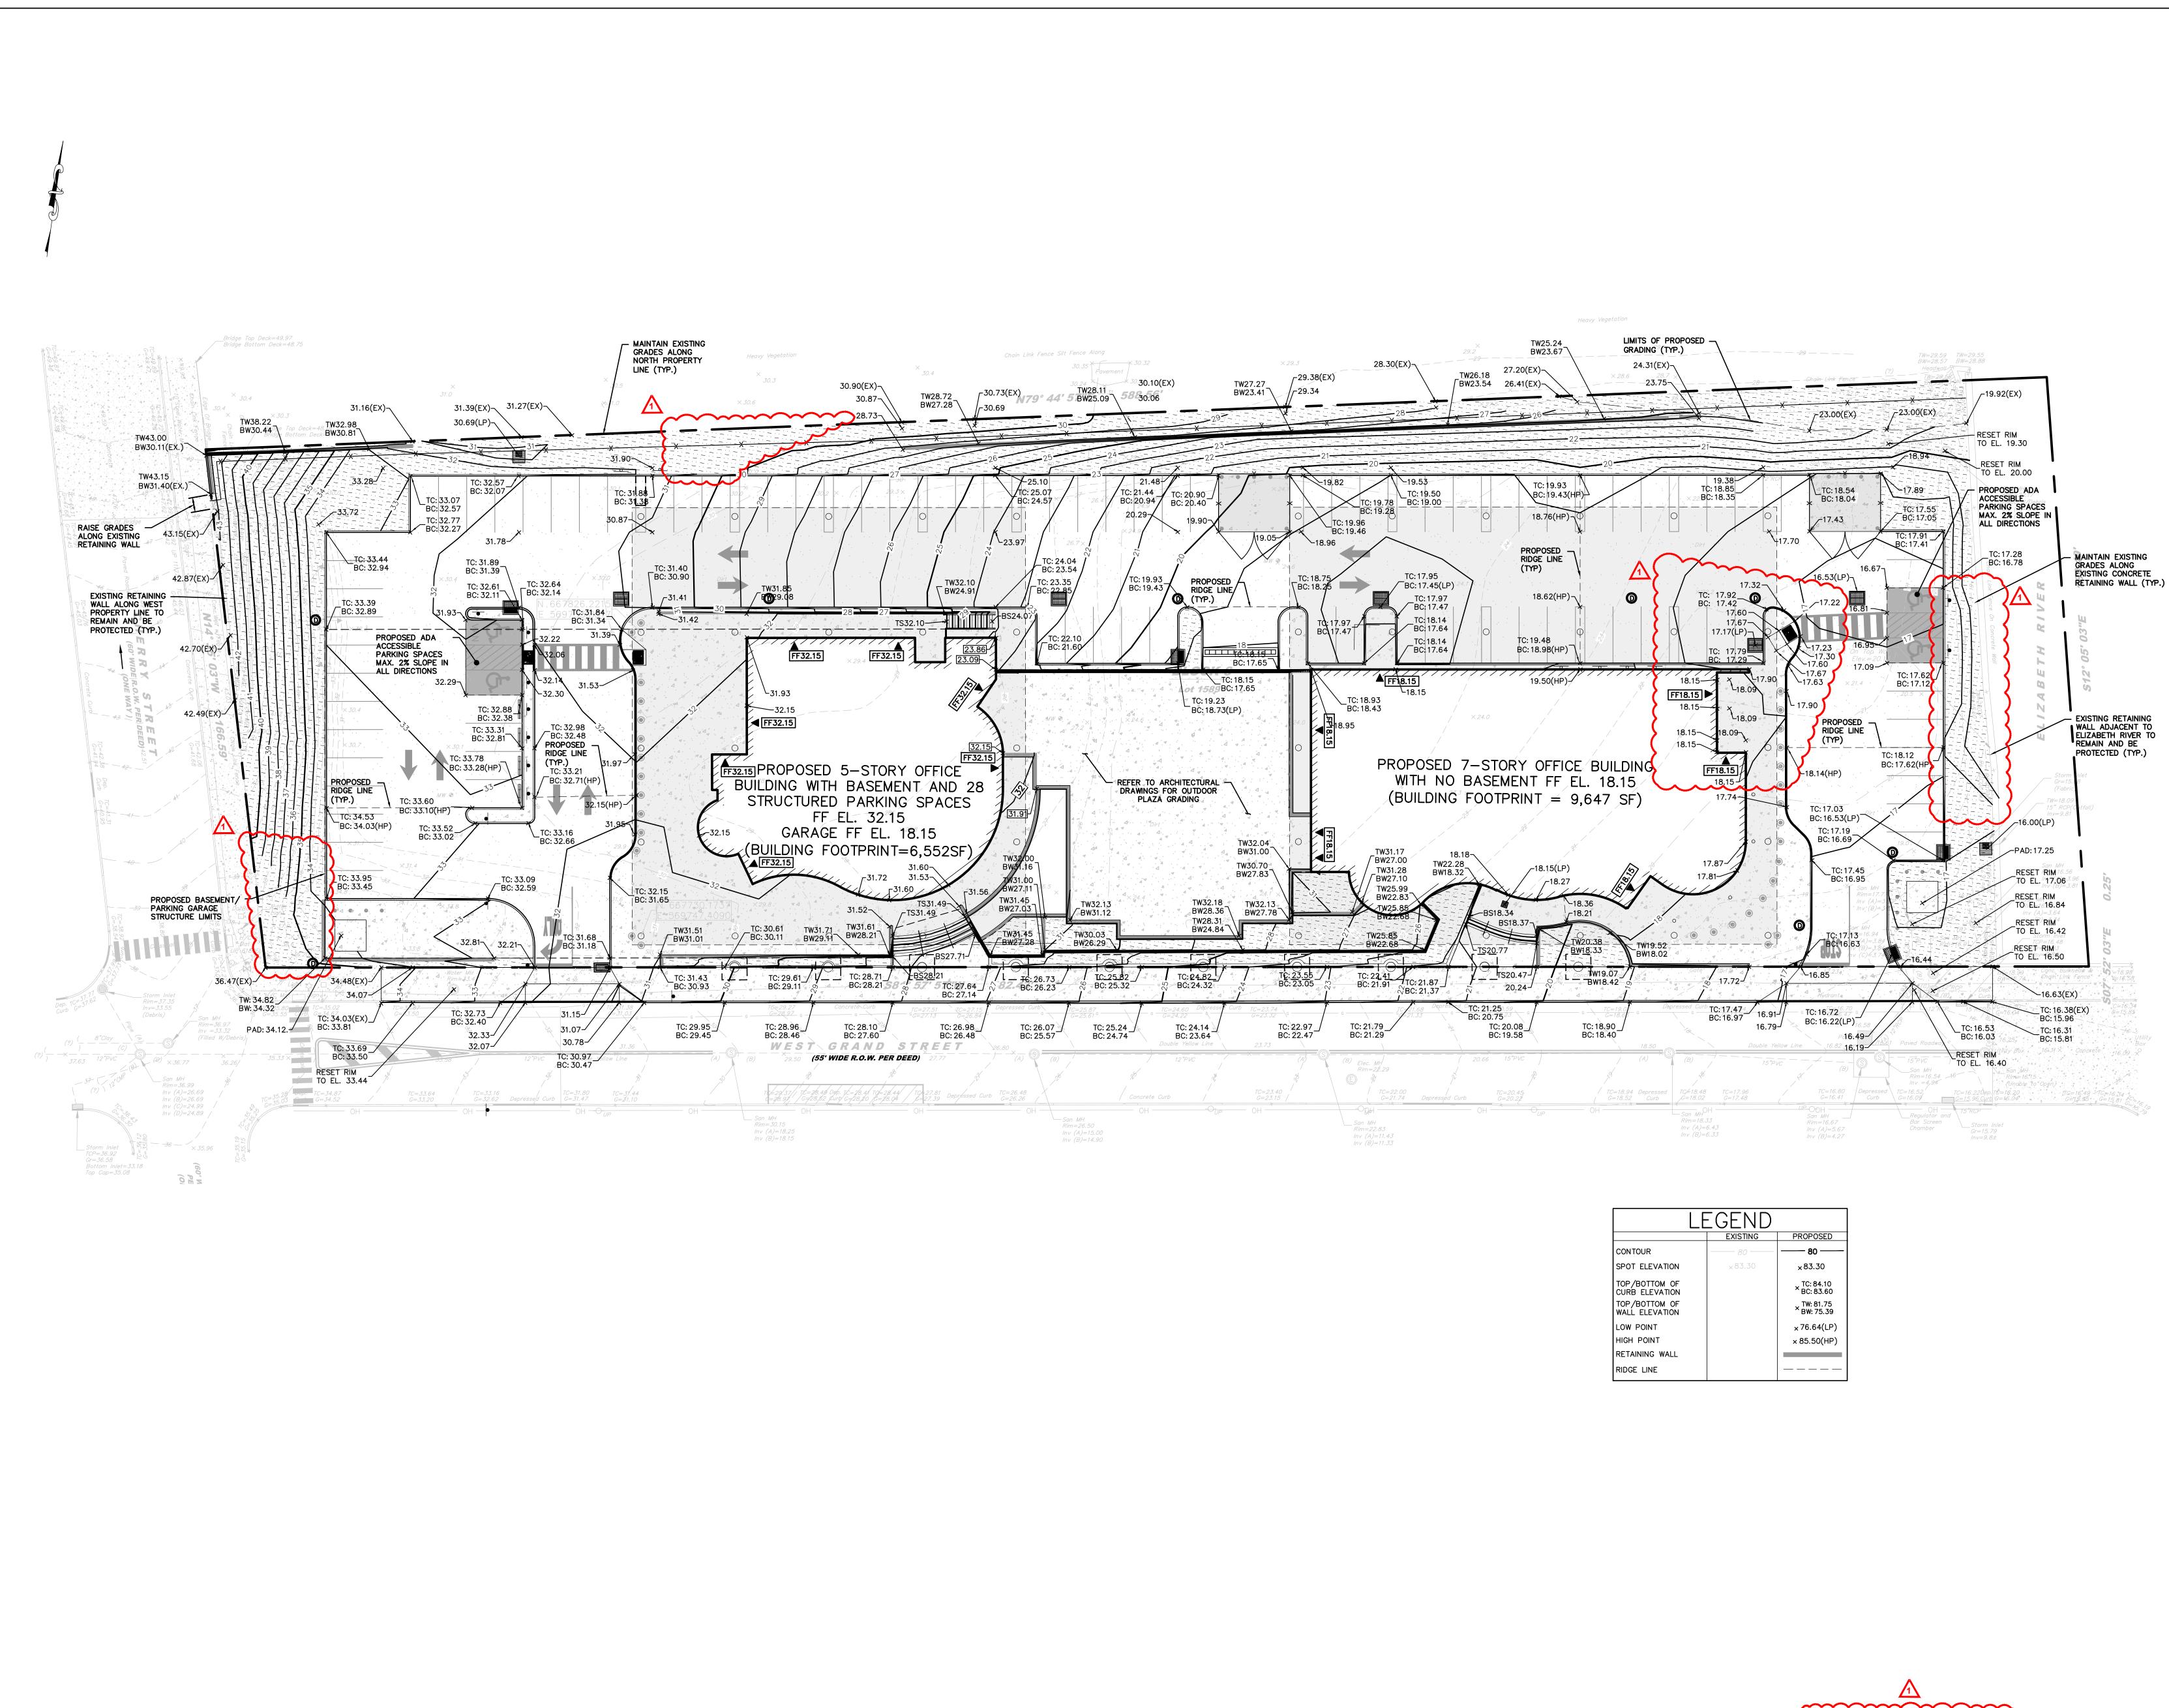
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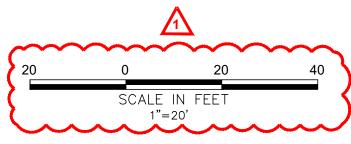
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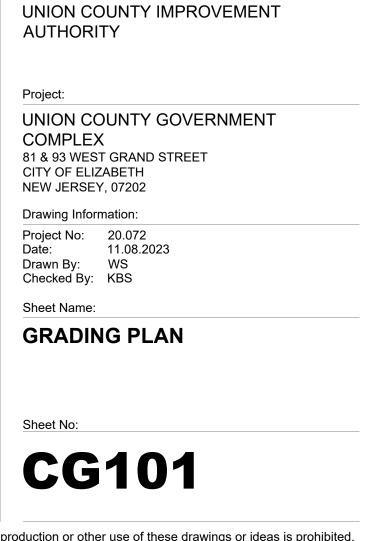
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LE	EGEND	
	EXISTING	PROPOSED
CONTOUR	<i> 80</i>	80
SPOT ELEVATION	×83.30	× 83.30
TOP/BOTTOM OF CURB ELEVATION		× TC: 84.10 × BC: 83.60
TOP/BOTTOM OF WALL ELEVATION		× TW: 81.75 × BW: 75.39
LOW POINT		× 76.64(LP)
HIGH POINT		× 85.50(HP)
RETAINING WALL		
RIDGE LINE		



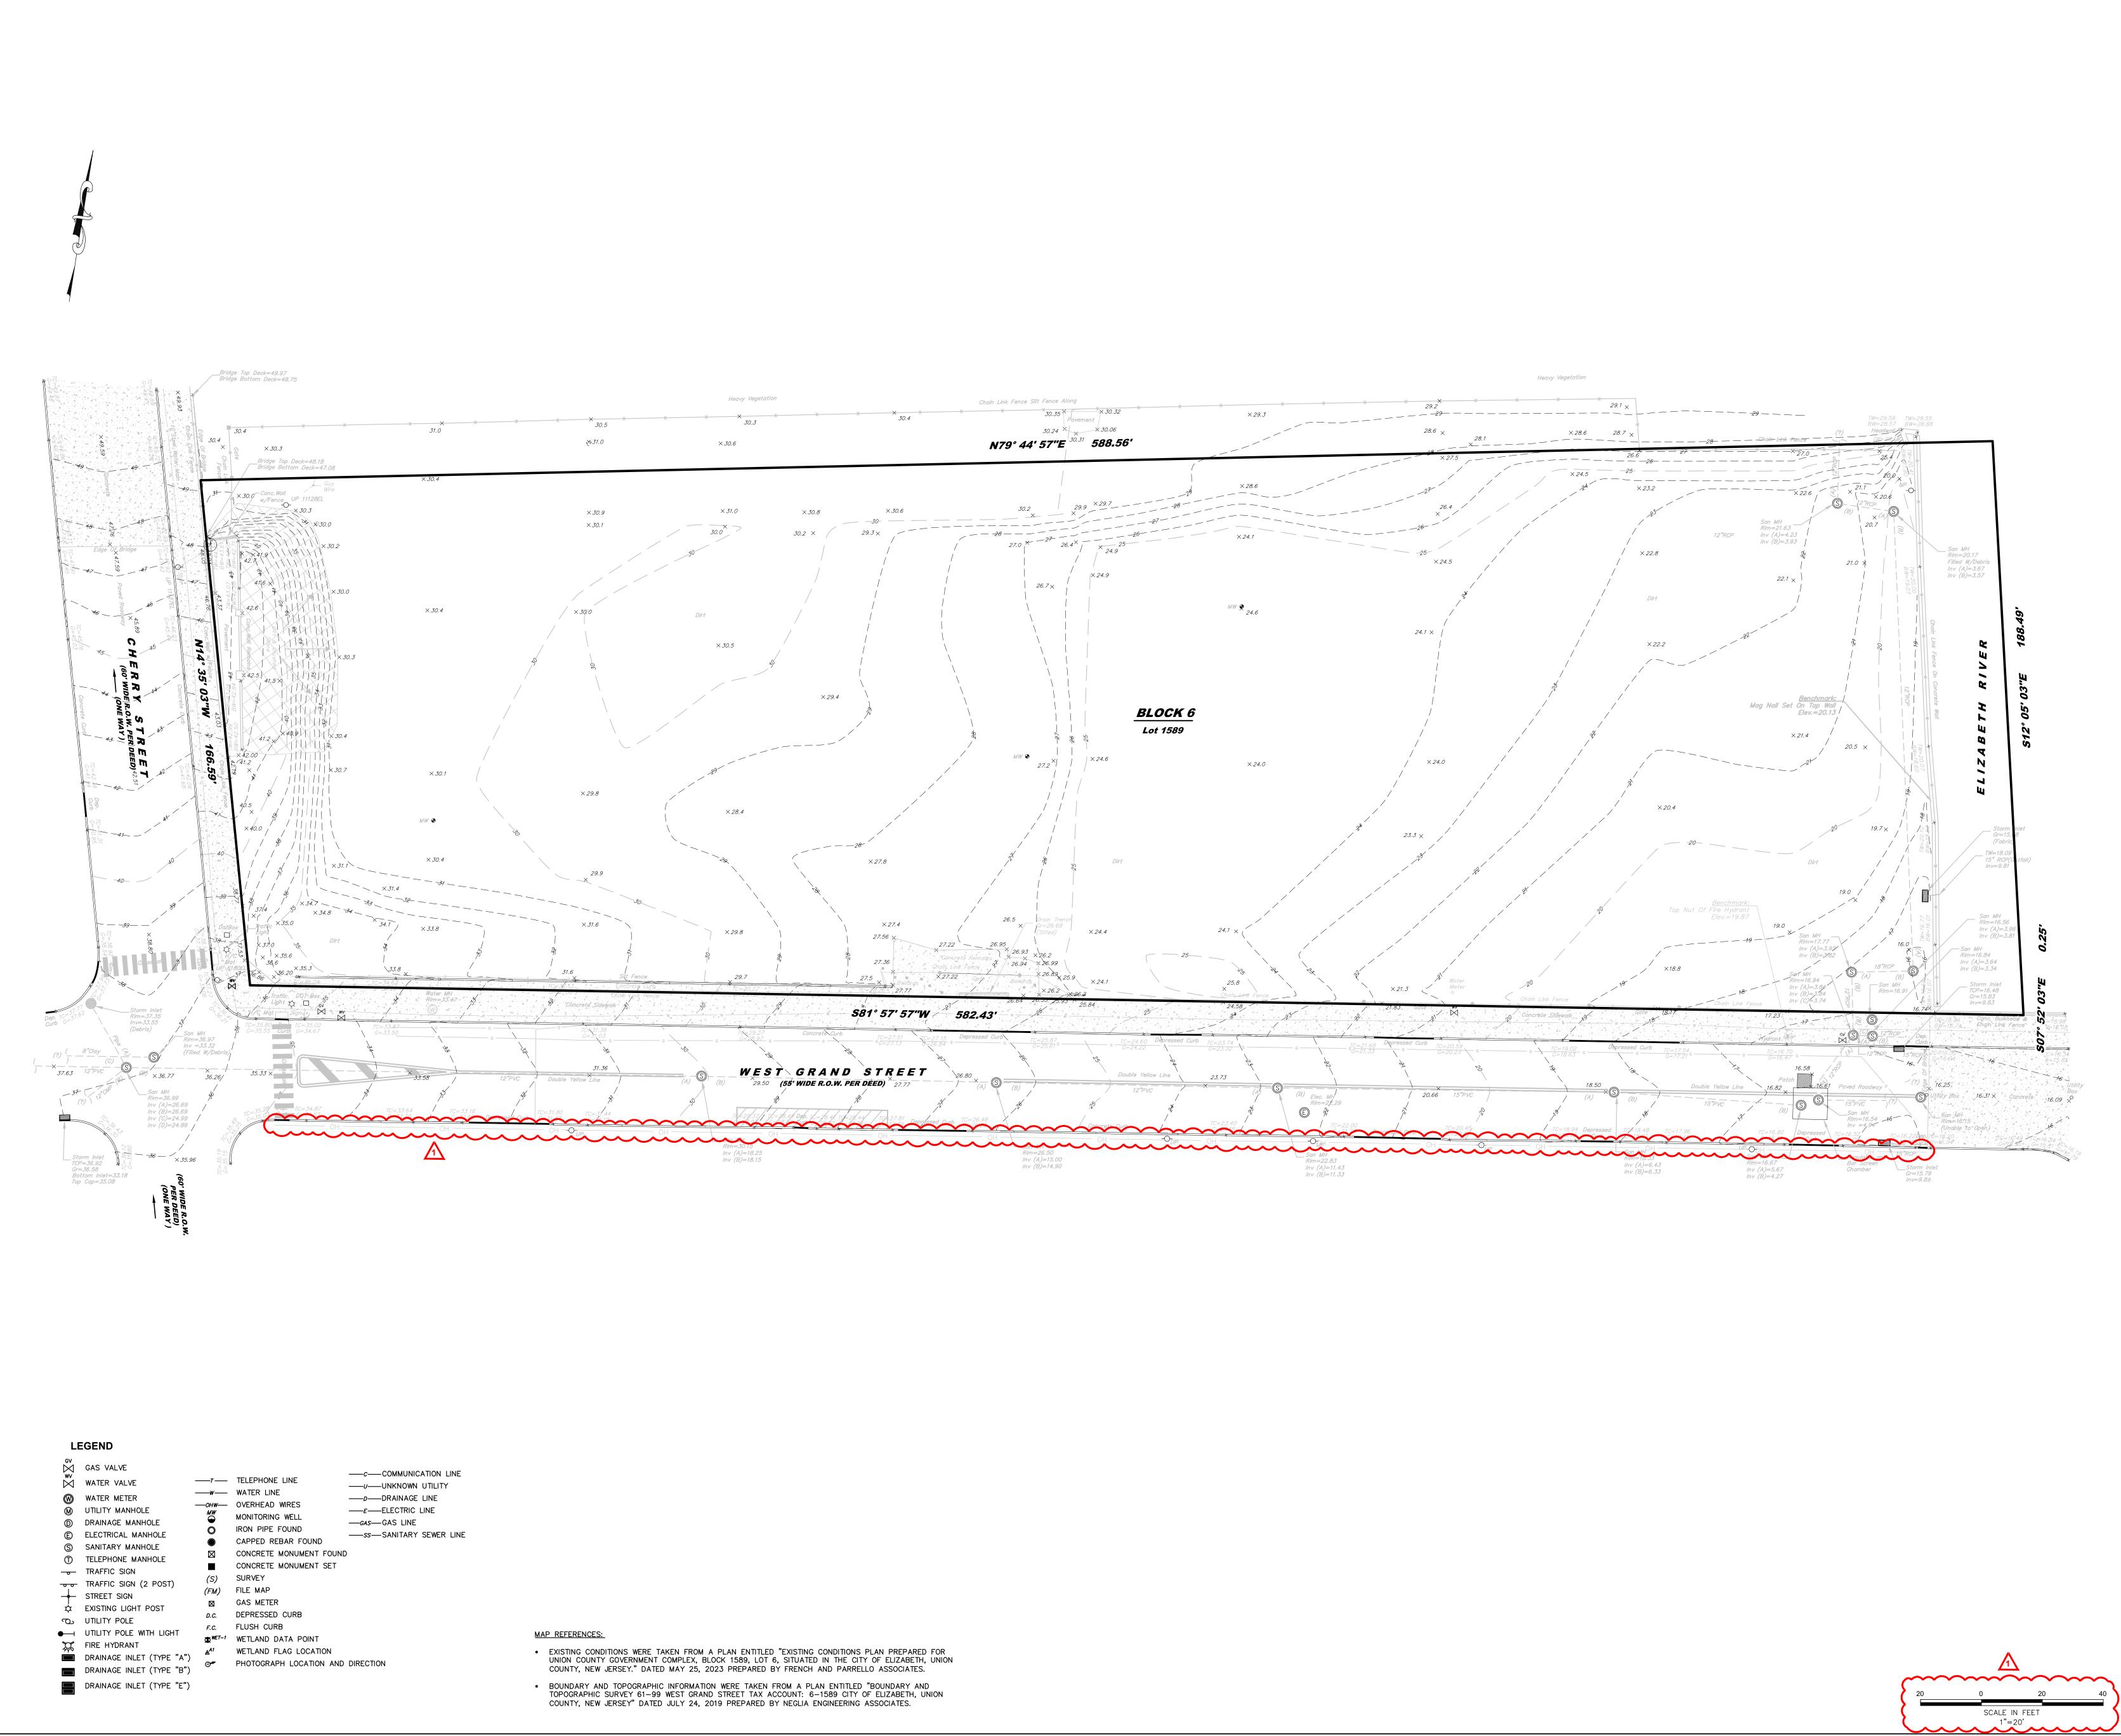

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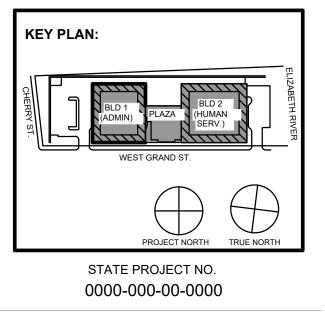
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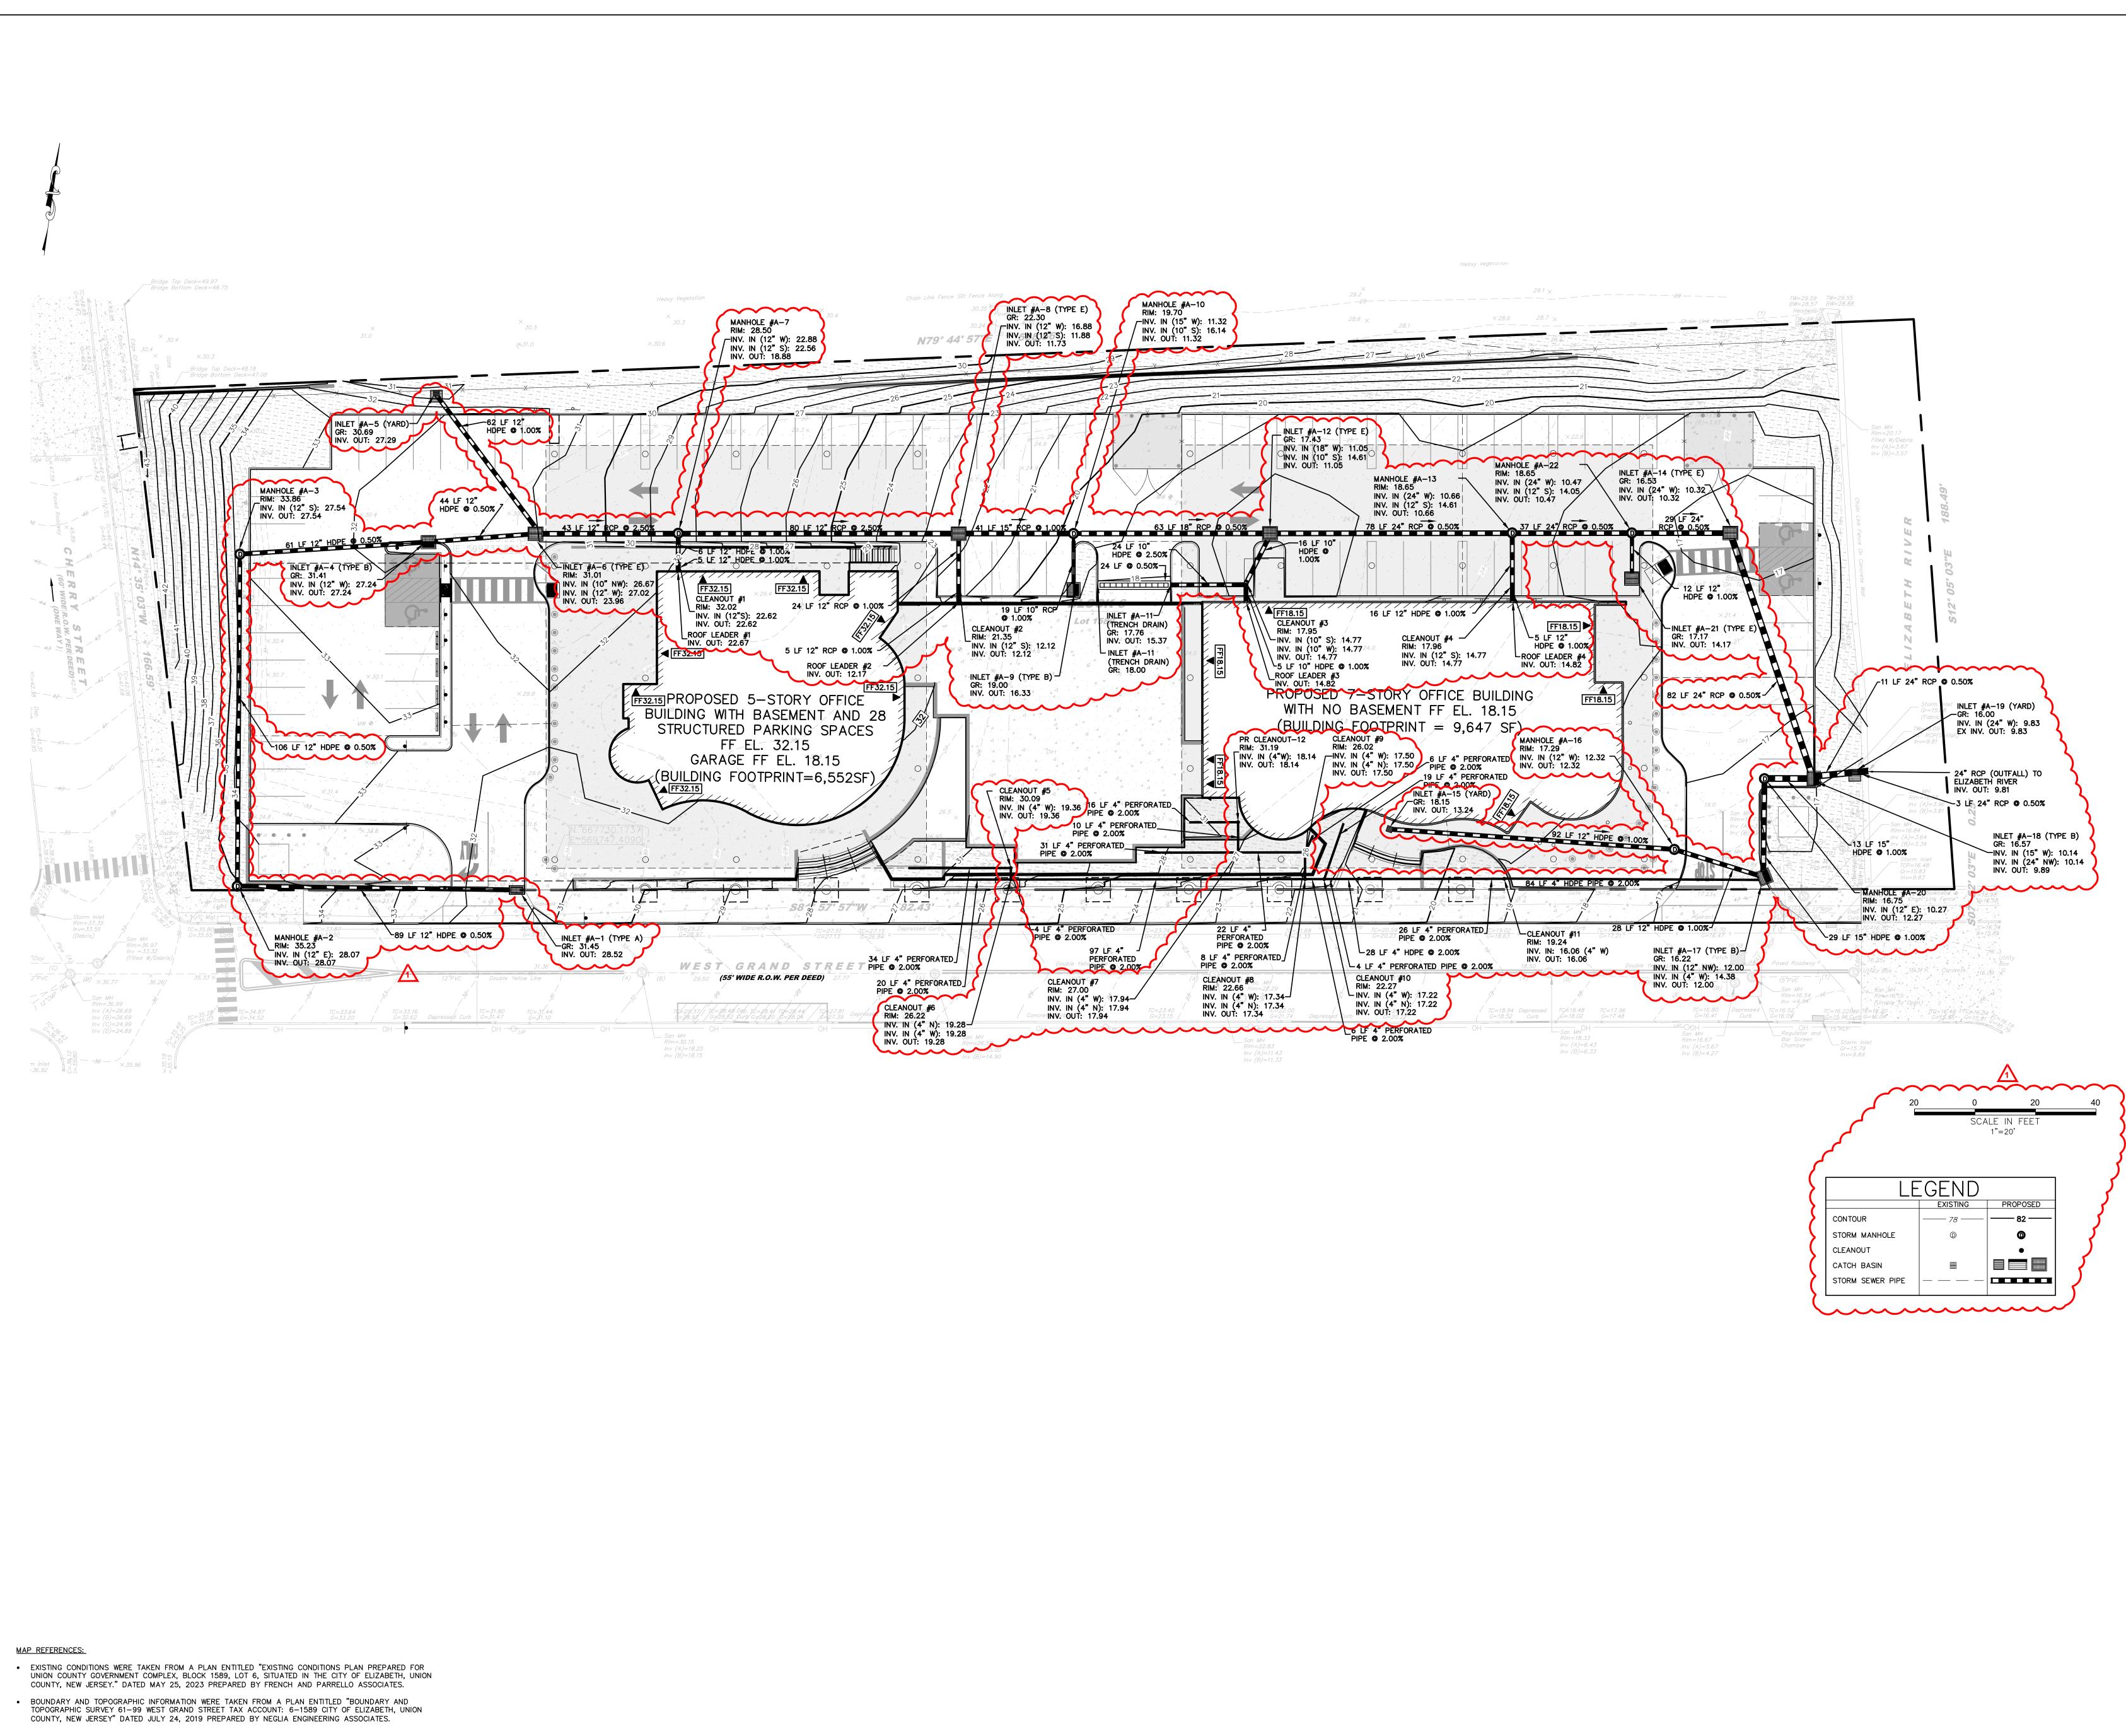
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**Revisions / Issues** 

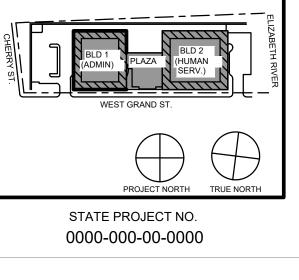









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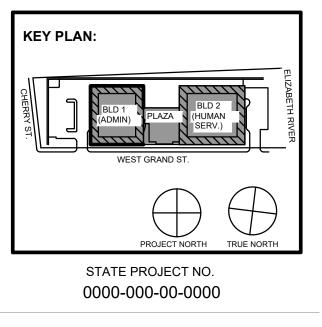
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 Addendum 1

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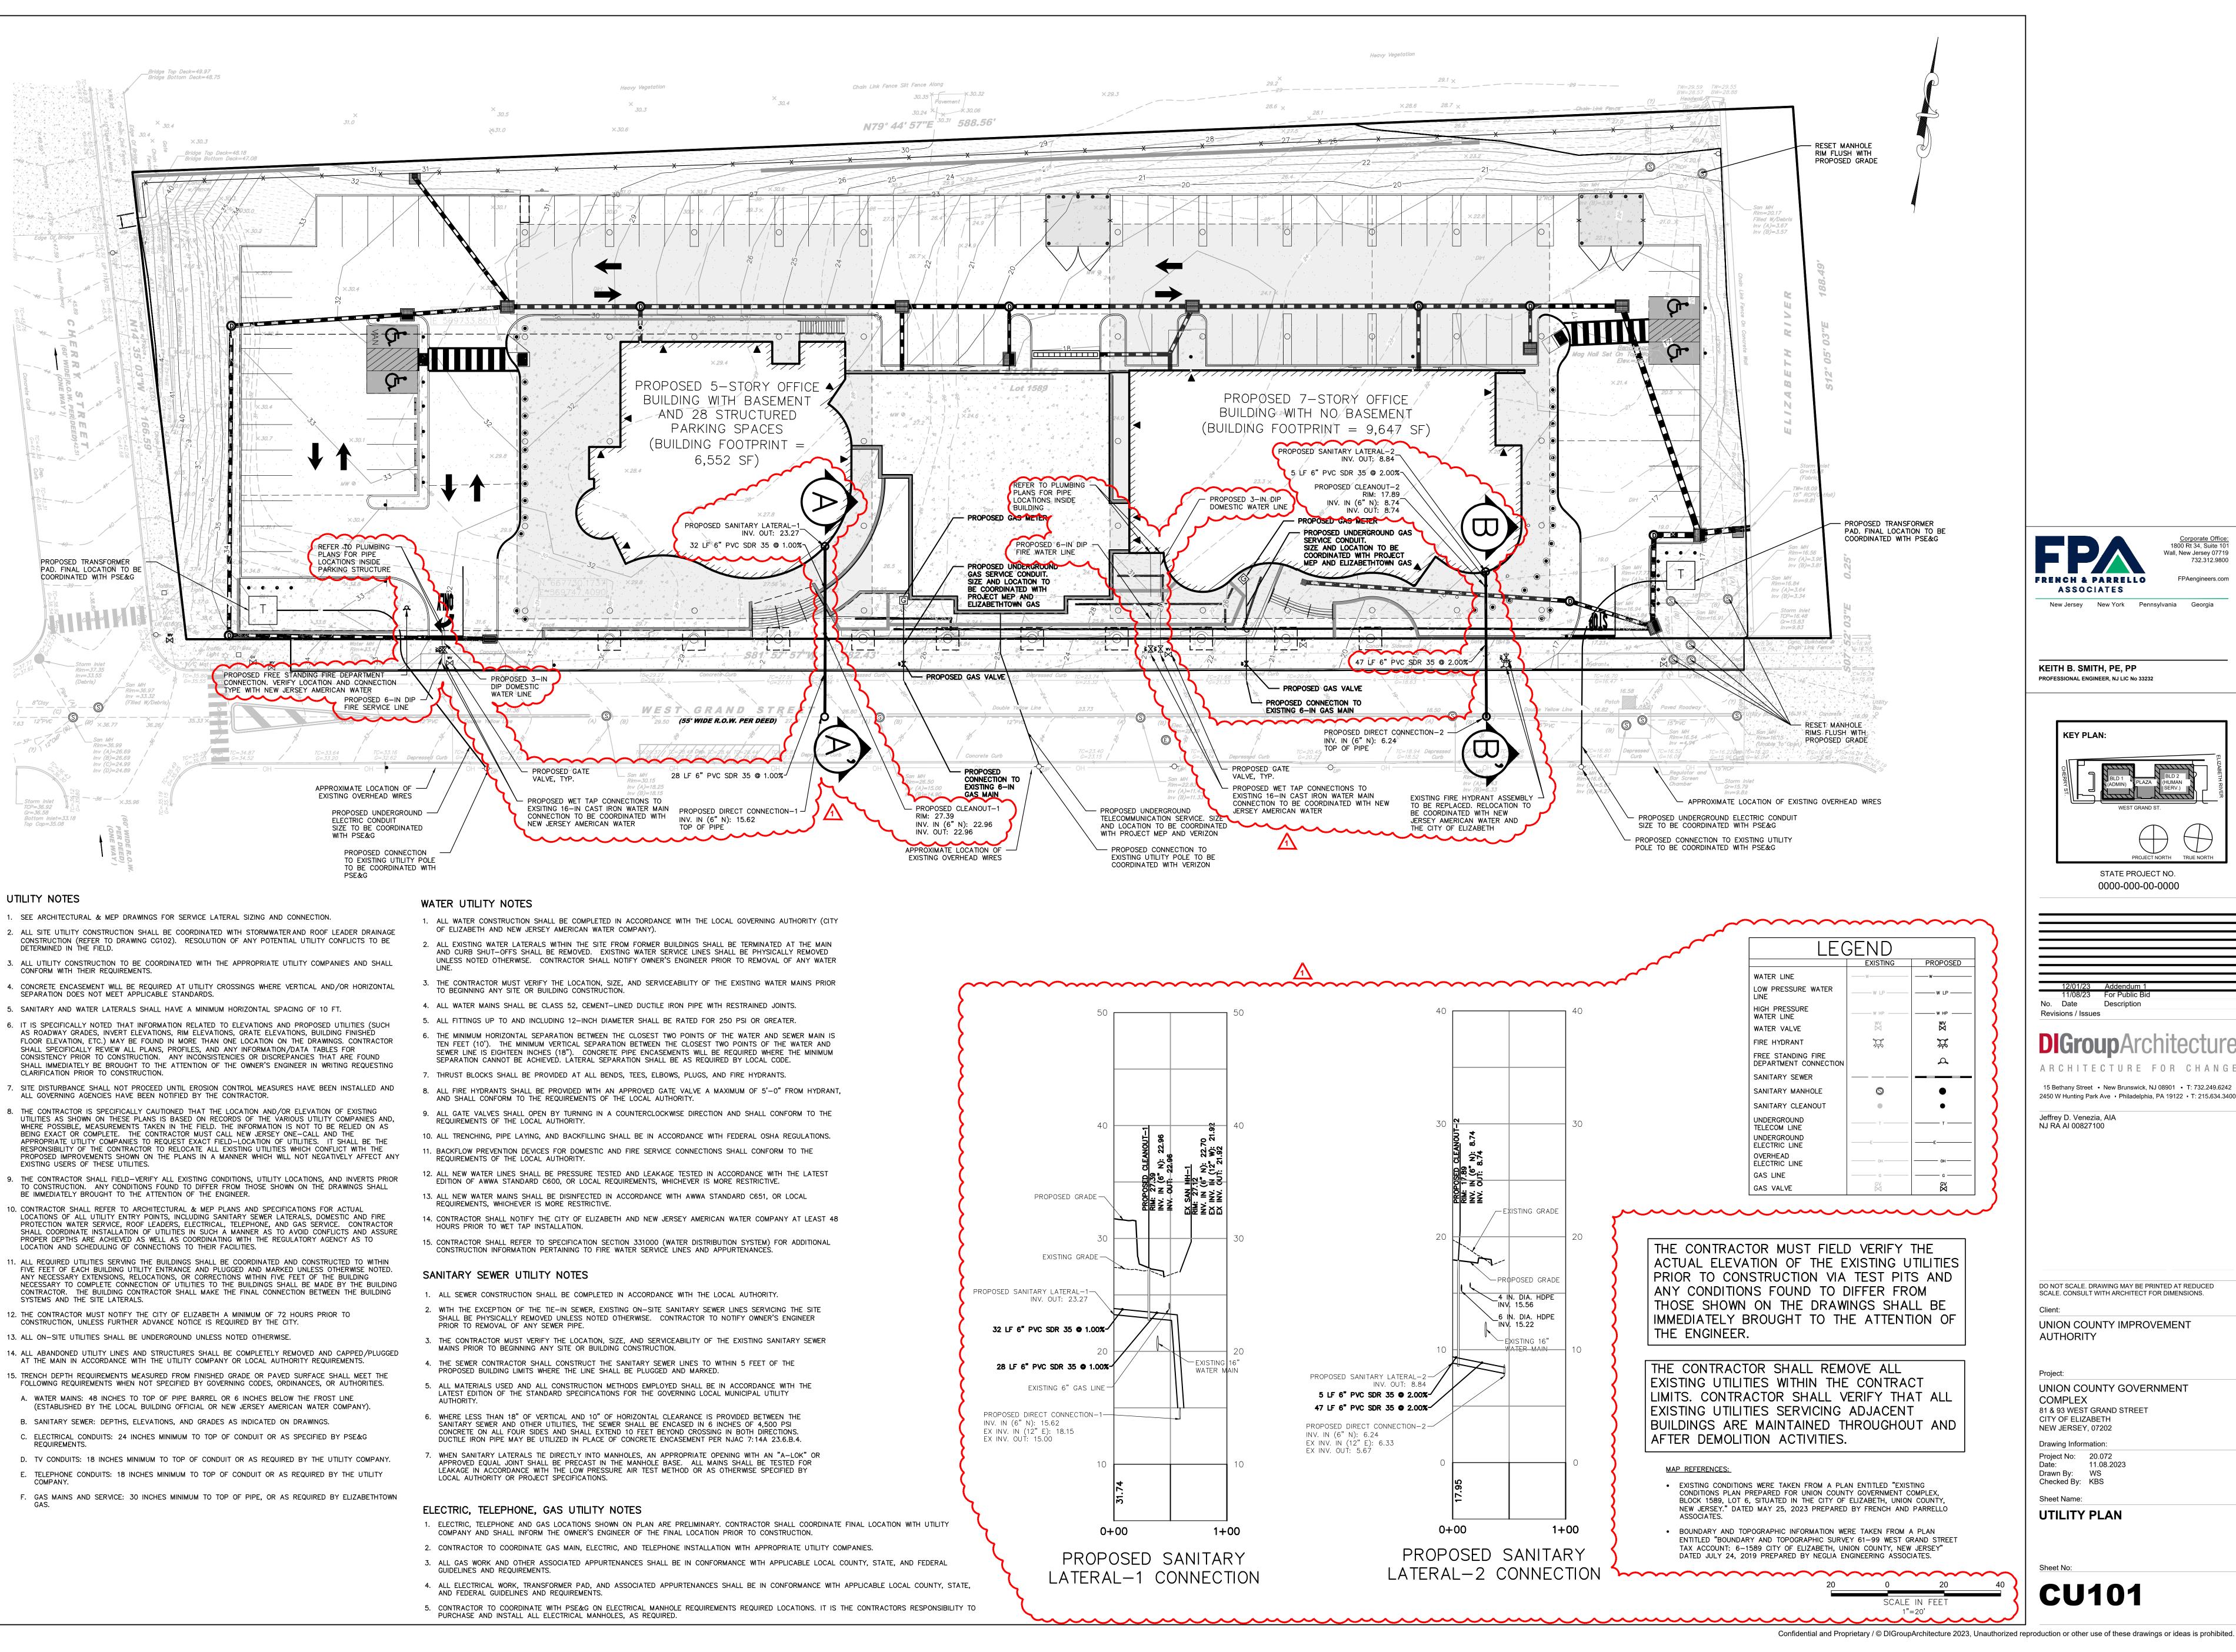
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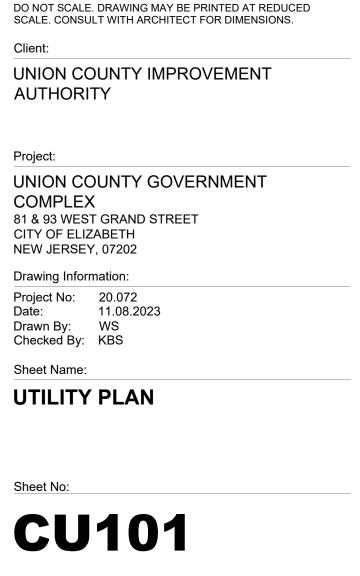
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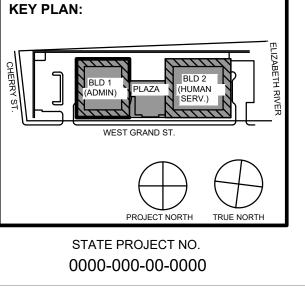




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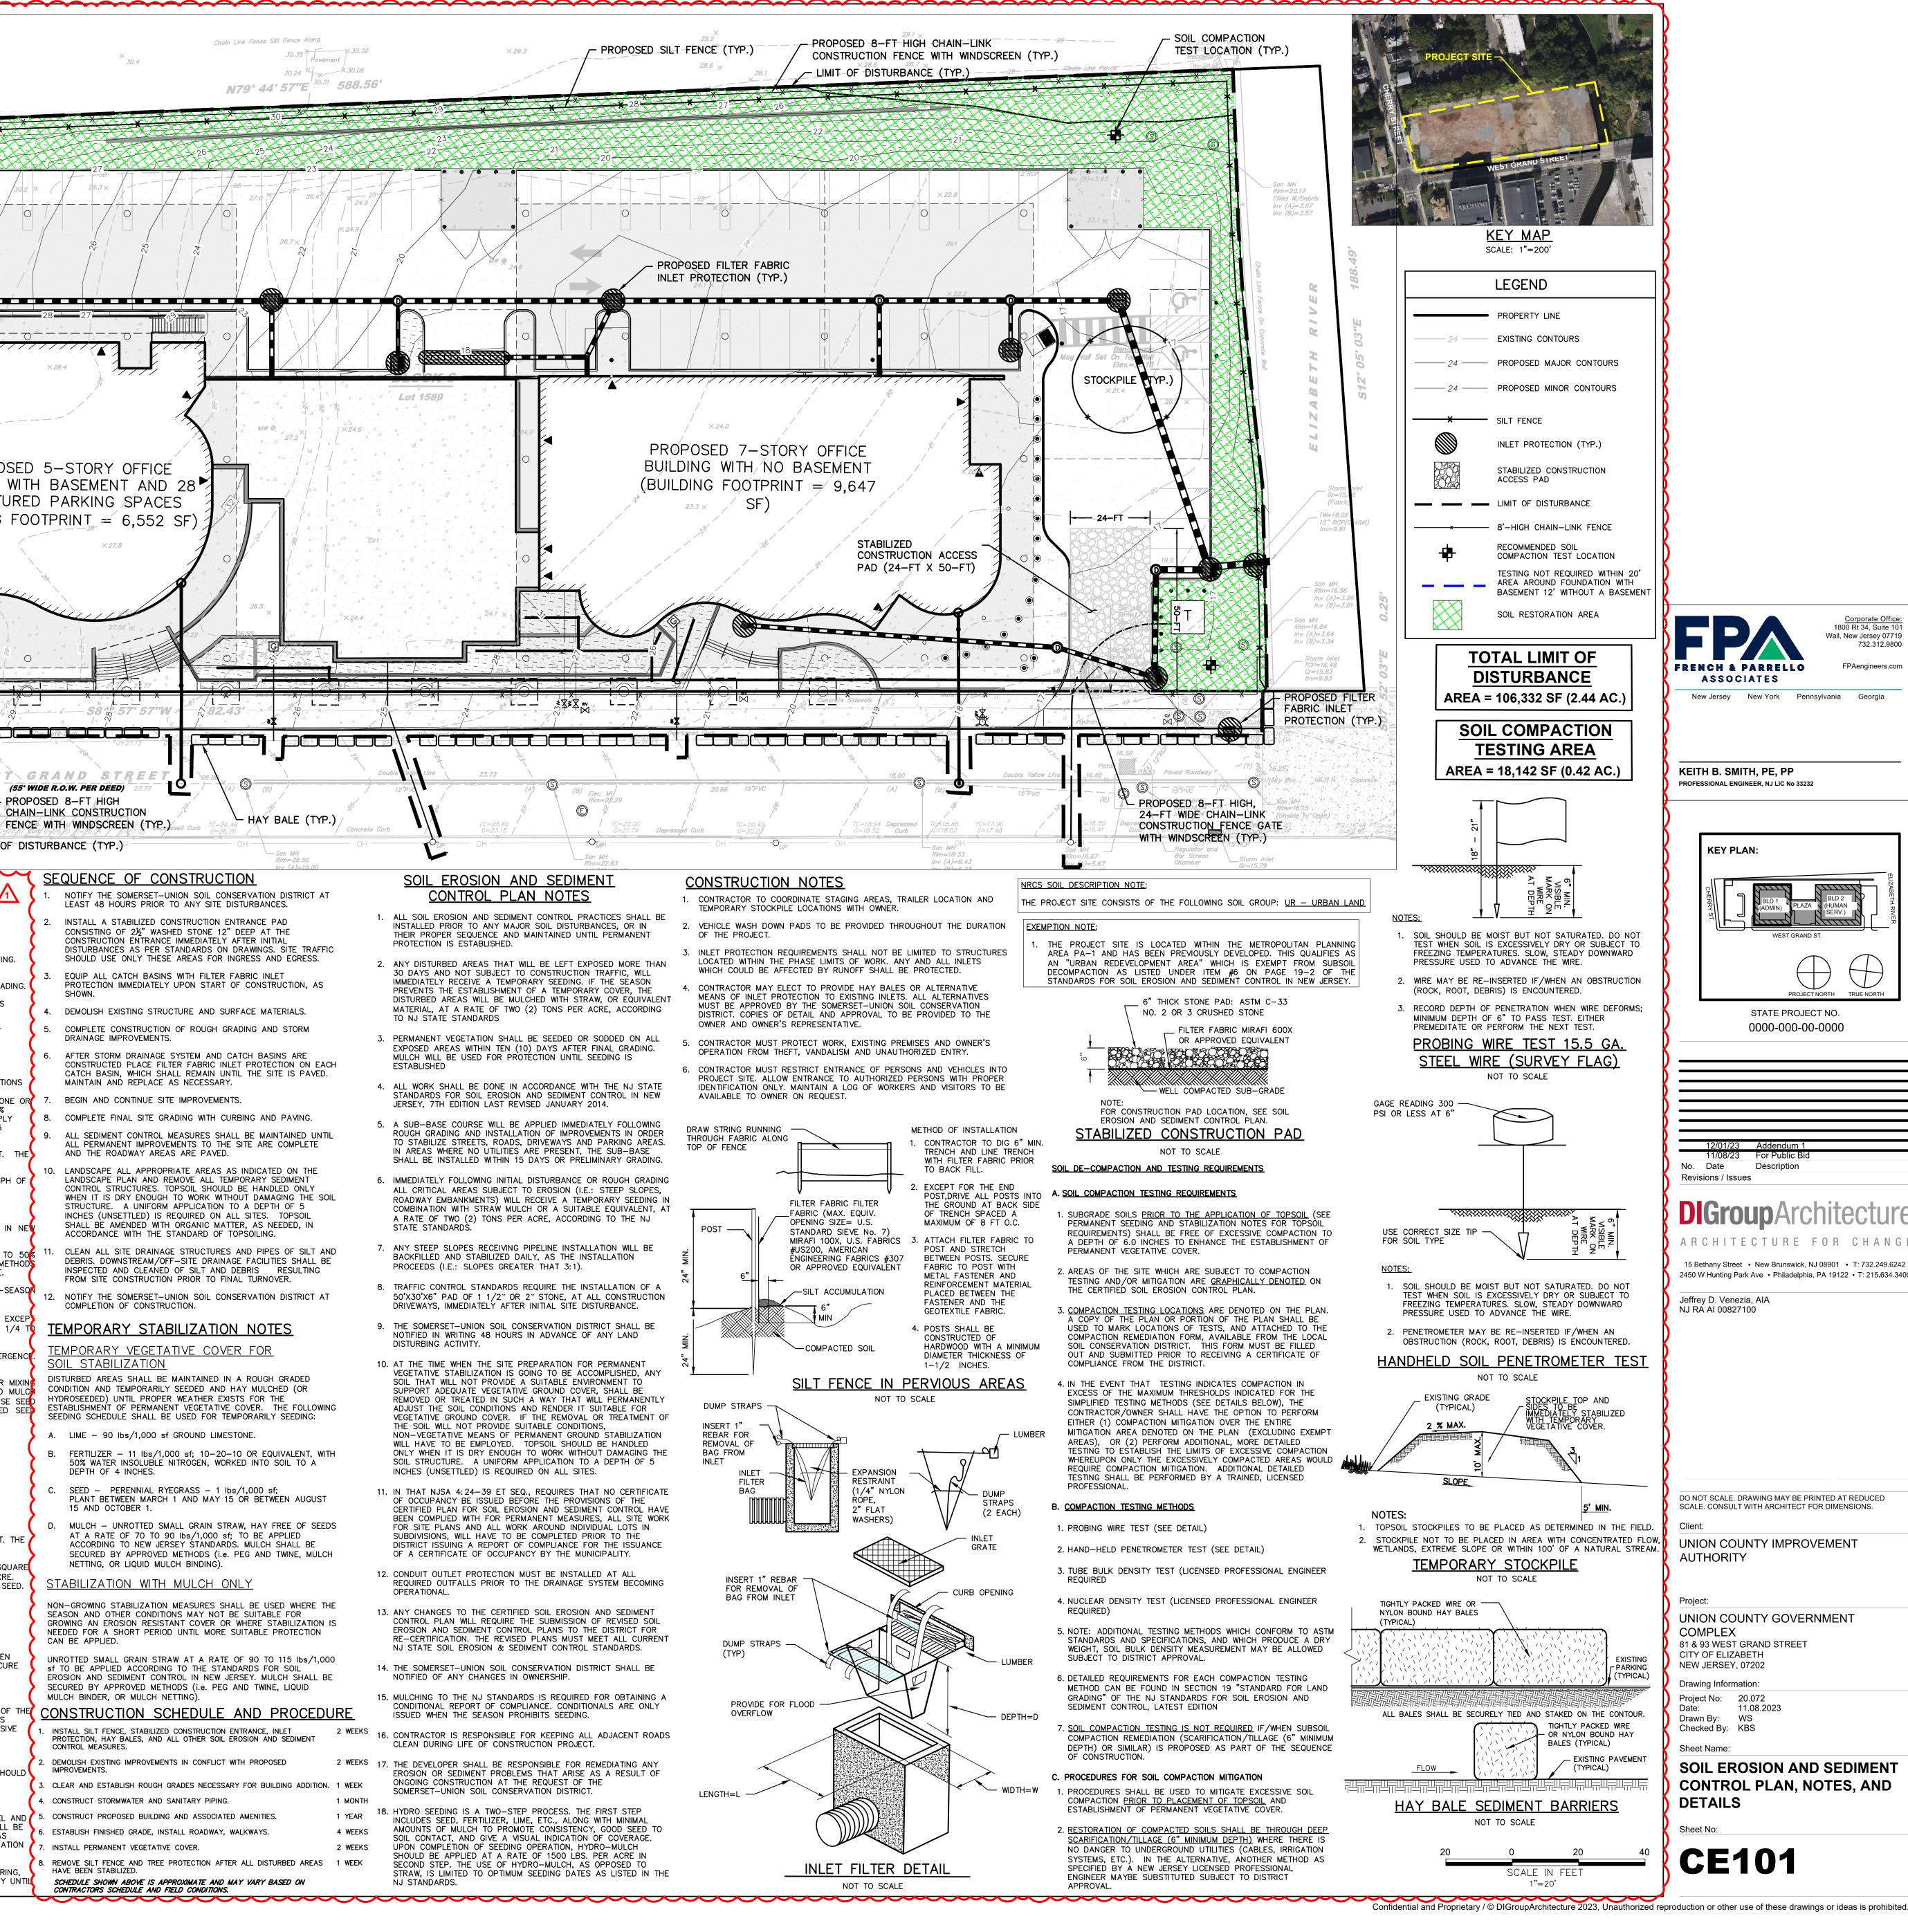
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	Bridge Top Deck=49.97 Bridge Bottom Deck=48.75	× 31.0	× 30.5 %31.0	Heavy Vegetation × 30.3 ×30.6
		32 32 STOCKPILE (TYP.)	PROPOSE FABRIC II PROTECT	
		x 30. 2 30. 4 30. 7 X 30. 1 X 30. 1 X 30. 4 X 30. 4		PROPO BUILDING STRUCTU (BUILDING
	38 DatBox D	→ → → → → → → → → → → → → → → → → → →		LIZED TRUCTION ACCESS (24-FT X 50-FT)
	San MH       PROPOSED (SIL T=1)67         Rim=36.97       FENCE (TYP.)         Inv = 33.32       (Filled W/Debris)         (Filled W/Debris)       3         36.77       36.26/         MH       3         =36.99       1         (A)=26.69       1         (C)=24.99       5         (D)=24.89       1         (D)=24.89       1	С=3.50 С=33.64 С=33.64 С=33.20 ОН ОН ОН ОН	18 17 17 17 17 17 17 17 17 17 17 17 17 17	
SITE PR A. GRA ALL B. IMMI C. TOP (UN: D. INST BAS SEEDBEI A. UNIF SUC (HT EQU WAT ONE	<u>EPARATION</u> DE AS NEEDED AND FEASIBLE TO PERMIT THE U GRADING SHOULD BE DONE IN ACCORDANCE WI EDIATELY PRIOR TO SEEDING AND TOPSOIL APPL SOIL SHOULD BE HANDLED ONLY WHEN IT IS DR SETTLED) IS REQUIRED ON ALL SITES. TOPSOIL FALL NEEDED EROSION CONTROL PRACTICES OR INS, AND WATERWAYS. D PREPARATION FORMLY APPLY GROUND LIMESTONE AND FERTILIZ H AS OFFERED BY RUTGERS CO-OPERATIVE EXT TP: //NJAES.RUTGERS.EDU/COUNTY/). LIME SHA IVALENT. FERTILIZER SHALL BE APPLIED AT THE ER INSOLUBLE NITROGEN UNLESS A SOIL TEST I	TANDARDS FOR SOIL EROSION AND SEDIMENT CO JSE OF CONVENTIONAL EQUIPMENT FOR SEEDBED TH STANDARD FOR LAND GRADING. JICATION, THE SUBSOIL SHALL BE EVALUATED FOR RY ENOUGH TO WORK WITHOUT DAMAGING THE SO SHALL BE AMENDED WITH ORGANIC MATTER, AS FACILITIES SUCH AS DIVERSIONS, GRADE-STABILI ZER, WHERE REQUIRED, TO TOPSOIL WHICH HAS E TENSION SOIL SAMPLE MAILERS ARE AVAILABLE F ALL BE APPLIED AT A RATE 3,900 POUNDS PER RATE OF 500 POUNDS PER ACRE OR 11 POUND INDICATES OTHERWISE AND INCORPORATED INTO T EDBED PREPARATION AND REPEAT ANOTHER ONE	PREPARATION, SEEDING, MULCH APP R COMPACTION IN ACCORDANCE WITH DIL STRUCTURE. A UNIFORM APPLICA NEEDED, IN ACCORDANCE WITH THE ZATION STRUCTURES, CHANNEL STAB BEEN SPREAD AND FIRMED, ACCORDIN ROM THE LOCAL RUTGERS COOPERA ACRE OR 90 POUNDS PER 1,000 SQ IS PER 1,000 SQUARE FEET OF 10–1 THE SURFACE 4 INCHES. IF FERTILIZ	ATION TO A DEPTH OF 5 INCHES STANDARD FOR TOPSOILING. BILIZATION MEASURES, SEDIMENT TIVE EXTENSION OFFICES UARE FEET OF GROUND LIMESTON IO-10 OR EQUIVALENT WITH 50% ZER IS NOT INCORPORATED, APPL
FINA C. HIGH 5 O SEEDING A. CONT JERSE 1. SEEI RED OF 3 2. WAR GRA B. CONV FOR 1 1/2 1	AL HARROWING OR DISCING OPERATION SHOULD I A ACID PRODUCING SOIL. SOILS HAVING A PH OF R MORE BEFORE INITIATING SEEDBED REPARATIO  RACTOR SHALL USE SEED MIXTURE NO. 6 AND EY. DING RATES SPECIFIED ARE REQUIRED WHEN A UCTION IN RATES MAY BE USED WHEN PERMANE SEEDING. ESTABLISHING PERMANENT VEGETATION M—SEASON MIXTURES ARE GRASSES AND LEGUN SSES SHALL BE THE AMOUNT OF PURE LIVE SEE ENTIONAL SEEDING IS PERFORMED BY APPLYING DRILLED, HYDROSEEDED OR CULTIPACKED SEEDIN NCH, BY RAKING OR DRAGGING. DEPTH OF SEE	RLY AS PRACTICAL TO A DEPTH OF 4 INCHES WI BE ON THE GENERAL CONTOUR. CONTINUE TILLA F 4 OR LESS OR CONTAINING IRON SULFIDE SHAL ON. SEE STANDARD FOR MANAGEMENT OF HIGH D THE CORRESPONDING RATES IN TABLE 4–3 A REPORT OF COMPLIANCE IS REQUESTED PRIOF ENT VEGETATION IS ESTABLISHED PRIOR TO A RE N MEANS 80% VEGETATIVE COVERAGE WITH THE ED (PLS) AS DETERMINED BY GERMINATION TESTI G SEED UNIFORMLY BY HAND, CYCLONE (CENTRI NGS, SEED SHALL BE INCORPORATED INTO THE S ED PLACEMENT MAY BE 1/4 INCH DEEPER ON CO GATED ROLLER WILL ASSURE GOOD SEED-TO-SO	AGE UNTIL A REASONABLE UNIFORM S L BE COVERED WITH A MINIMUM OF ACID-PRODUCING SOILS FOR SPECIF OF THE STANDARDS FOR SOIL ERO R TO ACTUAL ESTABLISHMENT OF F PORT OF COMPLIANCE INSPECTION. SPECIFIED SEED MIXTURE FOR THE S ATURES GENERALLY 85°F AND ABOVE NG RESULTS. IFUGAL) SEEDER, DROP SEEDER, DRI SOIL WITHIN 24 HOURS OF SEEDBED DARSE-TEXTURED SOIL.	SEEDBED IS PREPARED. 12 INCHES OF SOIL HAVING A PARTIC REQUIREMENTS. DSION AND SEDIMENT CONTROL I PERMANENT VEGETATION. UP T THESE RATES APPLY TO ALL ME SEEDED AREA AND MOWED ONCE. E. PLANTING RATES FOR WARM—S ILL OR CULTIPACKER SEEDER. I PREPARATION TO A DEPTH OF
D. HYDR SEED, MAY AND GERM E. SEED	OSEEDING IS A BROADCAST SEEDING METHOD U , WATER AND FERTILIZER AND SPRAYING THE M BE APPLIED WITH A HYDROSEEDER FOLLOWING S FERTILIZER ARE APPLIED TO THE SURFACE A INATION AND GROWTH. MIXTURE – SEED MIX NO. 6 FINE FESCUE (BLEND) – 3 Ibs/1,000 sf HARD FESCUE CHEWINGS FESCUE STRONG CREEPING RED FESCUE KENTUCKY BLUE GRASS – 0.1 Ibs/1,000 sf PERENNIAL RYEGRASS – 0.5 Ibs/1,000 sf MAL PLANTING PERIOD BETWEEN AUGUST 15TH –	O ON THE CONTOUR, SHEET EROSION WILL BE MIN USUALLY INVOLVING A TRUCK, OR TRAILER-MOUN MIX ONTO THE PREPARED SEEDBED. MULCH SH SEEDING. (ALSO SEE SECTION 4-MULCHING BELOY AND NOT INCORPORATED INTO THE SOIL. WHEN ONT INCORPORATED INTO THE SOIL. WHEN	ITED TANK, WITH AN AGITATION SYS ALL NOT BE INCLUDED IN THE TAN W). HYDROSEEDING IS NOT A PREFE	TEM AND HYDRAULIC PUMP FOR K WITH SEED. SHORT-FIBERED ERRED SEEDING METHOD BECAUS
EXISTENCE A. STRAW FEET), MULCH APPLICA HAND-S ANCHOF DEPEND	OF VEGETATION SUFFICIENT TO CONTROL SOIL OR HAY. UNROTTED SMALL GRAIN STRAW, HAY EXCEPT THAT WHERE A CRIMPER IS USED INST CHOPPER-BLOWERS MUST NOT GRIND THE MUL ATION – SPREAD MULCH UNIFORMLY BY HAND C SPREAD MULCH, DIVIDE AREA INTO APPROXIMATE RING SHALL BE ACCOMPLISHED IMMEDIATELY AFT DING UPON THE SIZE OF THE AREA, STEEPNESS		IS MULCHING REQUIREMENT. OF 1-1/2 TO 2 TONS PER ACRE (7 R ADHESIVE AGENT), THE RATE OF A TABLISHING FINE TURF OR LAWNS DU HE SOIL SURFACE IS COVERED. FOR TE 70 TO 90 POUNDS WITHIN EACH WATER. THIS MAY BE DONE BY ONE	70 TO 90 POUNDS PER 1,000 SQ APPLICATION IS 3 TONS PER ACR IE TO THE PRESENCE OF WEED S & UNIFORM DISTRIBUTION OF SECTION.
2. 3. 4.	BEFORE OR AFTER APPLYING MULCH. SECURE TWINE AROUND EACH PEG WITH TWO OR MORE MULCH NETTINGS – STAPLE PAPER, JUTE, COTT CRIMPER (MULCH ANCHORING COULTER TOOL) – BROADCAST LONG FIBER MULCH 3 TO 4 INCHES TRAVERSABLE BY A TRACTOR, WHICH MUST OPE AGENT IS REQUIRED. LIQUID MULCH-BINDERS – MAY BE USED TO AN A. APPLICATIONS SHOULD BE HEAVIER AT EDGES	TON, OR PLASTIC NETTINGS TO THE SOIL SURFAC - A TRACTOR-DRAWN IMPLEMENT, SOMEWHAT LIK S INTO THE SOIL SO AS TO ANCHOR IT AND LEAV ERATE ON THE CONTOUR OF SLOPES. STRAW MU	BETWEEN PEGS IN A CRISS-CROSS E. USE A DEGRADABLE NETTING IN E A DISC HARROW, ESPECIALLY DESI VE PART STANDING UPRIGHT. THIS JLCH RATE MUST BE 3 TONS PER A	AND A SQUARE PATTERN. SECU AREAS TO BE MOWED. IGNED TO PUSH OR CUT SOME O TECHNIQUE IS LIMITED TO AREAS CRE. NO TACKIFYING OR ADHESI
	BE UNIFORM IN APPEARANCE. B. USE ONE OF THE FOLLOWING: (1) ORGANIC AND VEGETABLE BASED BINDERS WHEN APPLIED TO MULCH UNDER SATISFA PHYSIOLOGICALLY HARMLESS AND NOT RE	S – NATURALLY OCCURRING, POWDER-BASED, HY ACTORY CURING CONDITIONS WILL FORM MEMBRAN ESULT IN A PHYTOTOXIC EFFECT OR IMPEDE GROU TO ANCHOR MULCH MATERIALS. MANY NEW PROE	YDROPHILIC MATERIALS WHEN MIXED NED NETWORKS OF INSOLUBLE POLYM WTH OF TURF GRASS. USE AT RATE	WITH WATER FORMULATES A GEL IERS. THE VEGETABLE GEL SHALL ES AND WEATHER CONDITIONS AS

(2) SYNTHETIC BINDERS - HIGH POLYMER SYNTHETIC EMULSION, MISCIBLE WITH WATER WHEN DILUTED AND, FOLLOWING APPLICATION OF MULCH, DRYING AND CURING, SHALL NO LONGER BE SOLUBLE OR DISPERSIBLE IN WATER. BINDER SHALL BE APPLIED AT RATES RECOMMENDED BY THE MANUFACTURER AND REMAIN TACKY UNTIL GERMINATION OF GRASS



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### Jeffrey D. Venezia, AIA NJ RA AI 00827100


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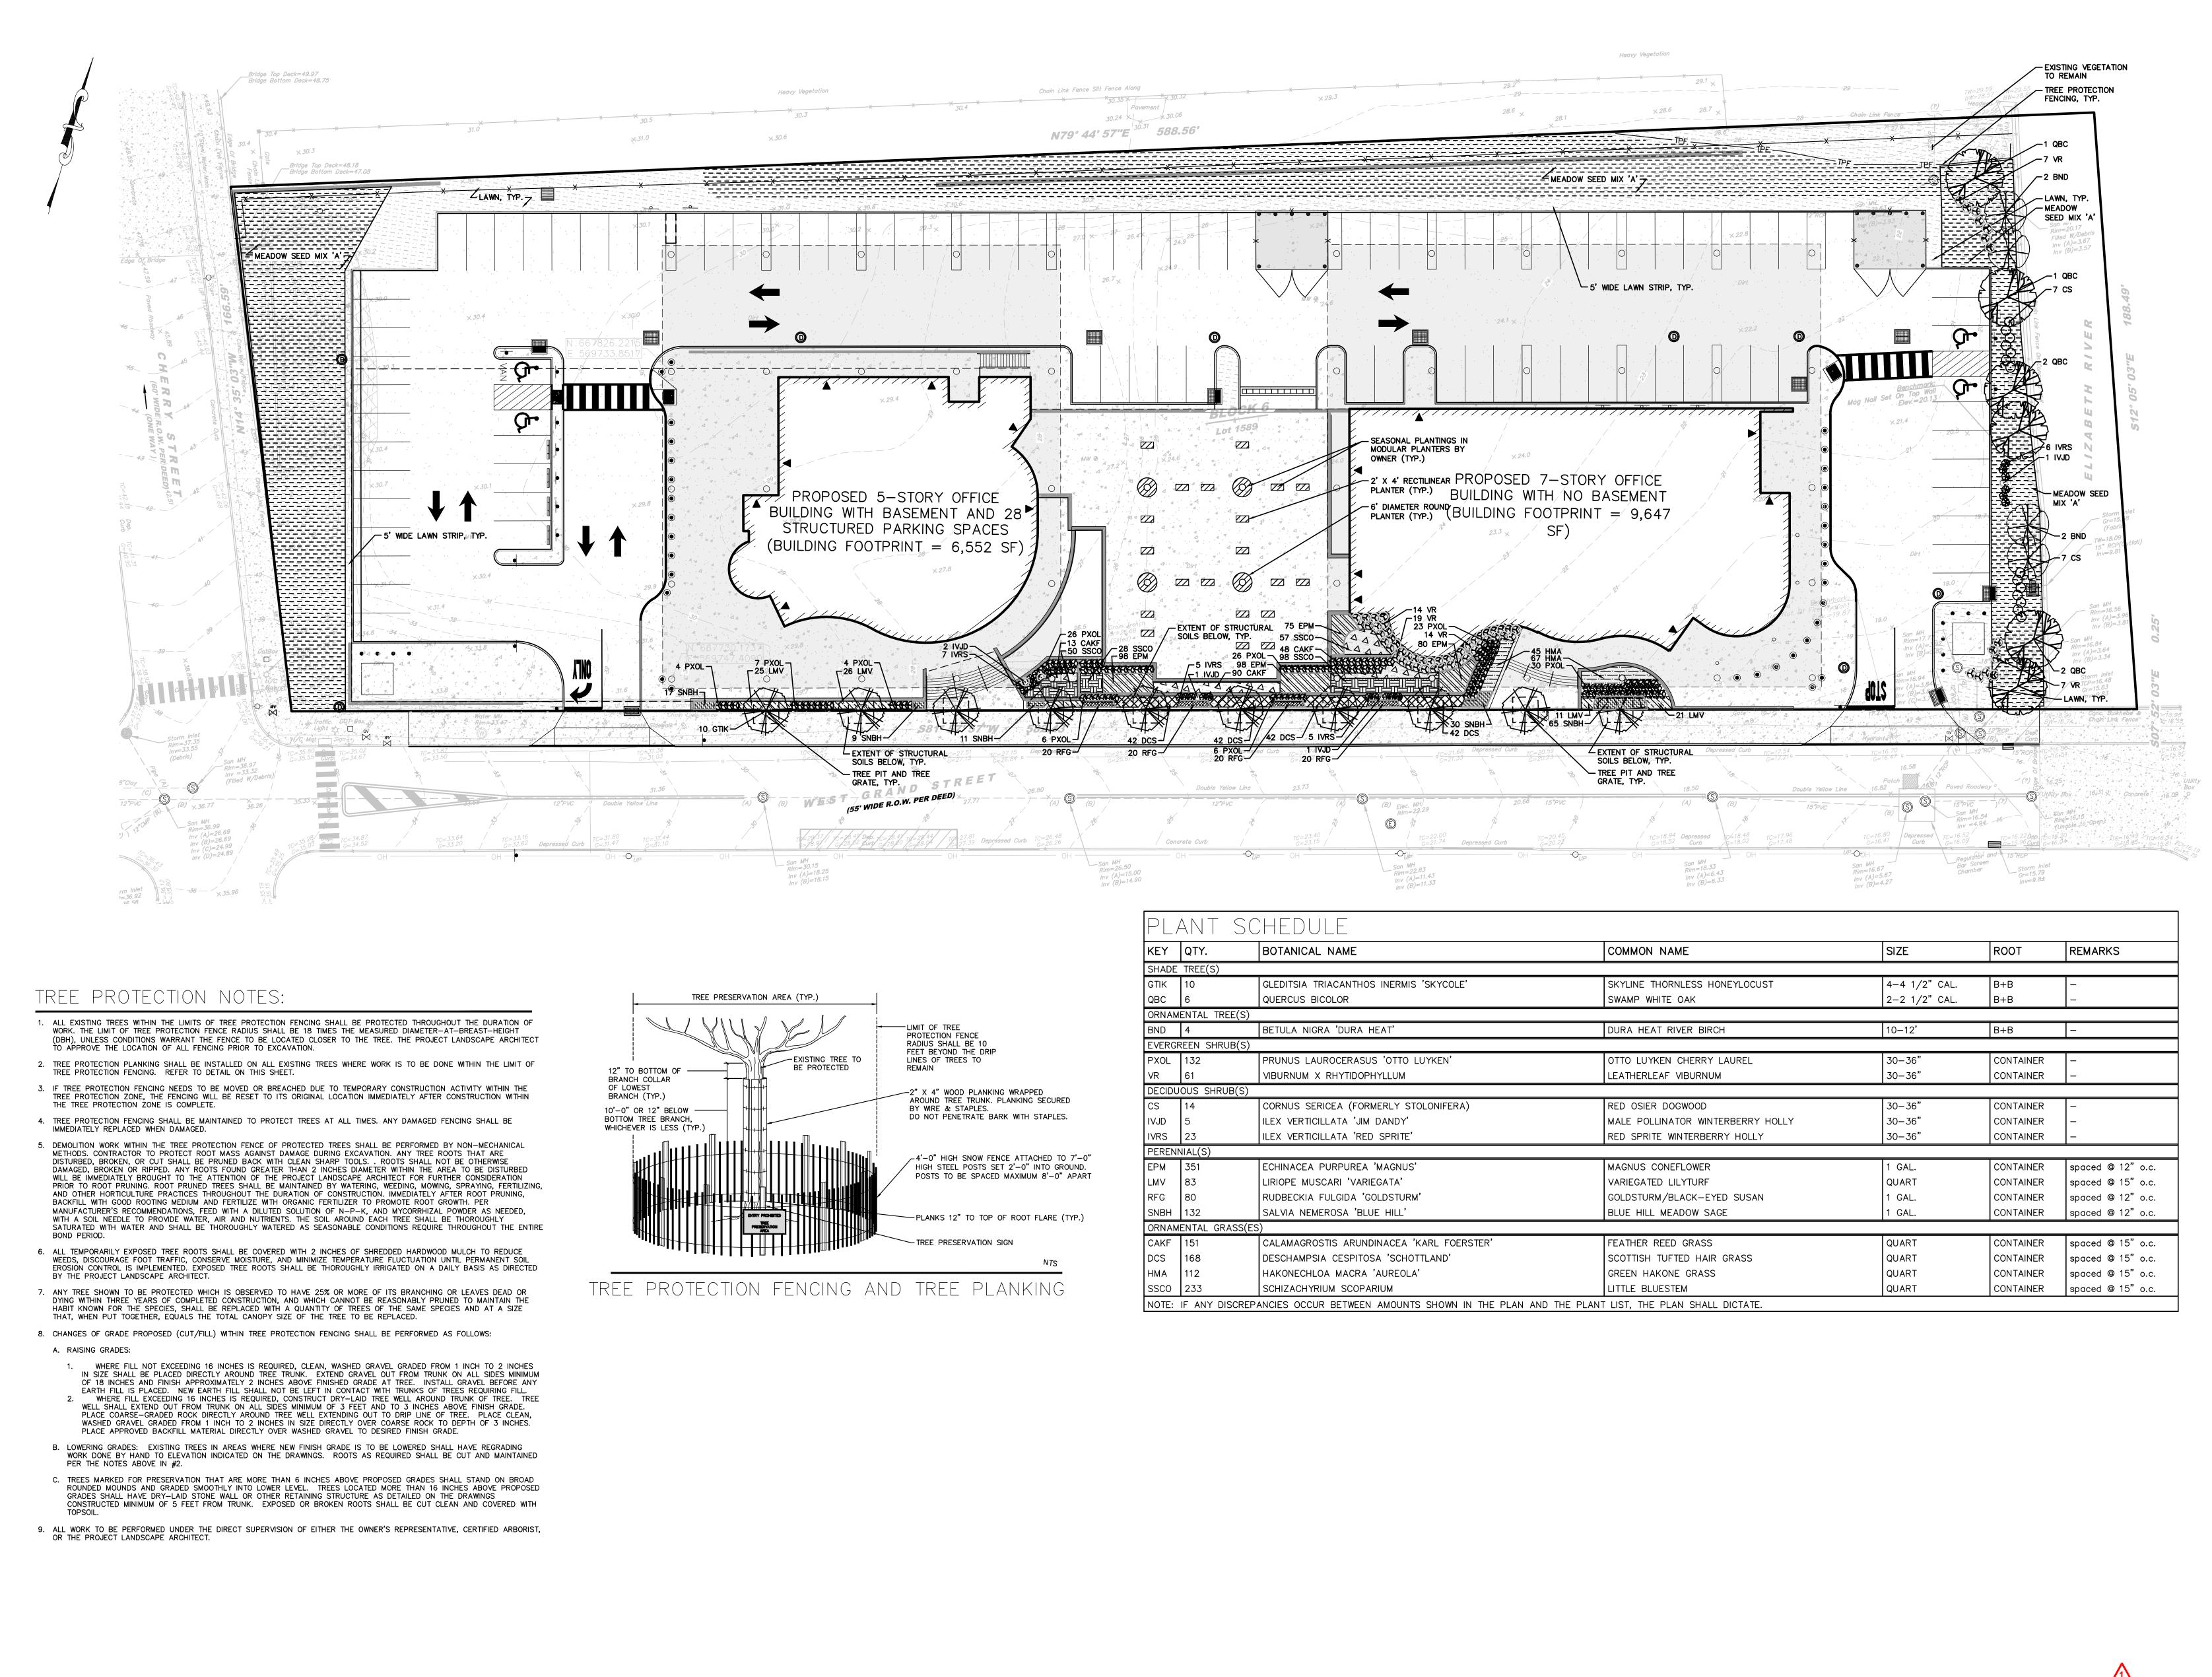
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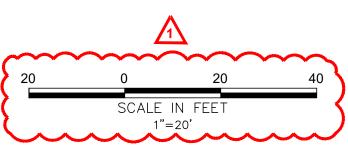
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KEY	QTY.	BOTANICAL NAME	COMMON NAME	SIZE	ROOT	REMARKS
SHADE	TREE(S)					1
GTIK	10	GLEDITSIA TRIACANTHOS INERMIS 'SKYCOLE'	SKYLINE THORNLESS HONEYLOCUST	4-4 1/2" CAL.	B+B	-
QBC	6	QUERCUS BICOLOR	SWAMP WHITE OAK	2-2 1/2" CAL.	B+B	-
ORNAM	IENTAL TREE(S				•	
BND	4	BETULA NIGRA 'DURA HEAT'	DURA HEAT RIVER BIRCH	10–12'	B+B	-
EVERG	REEN SHRUB(S					
PXOL	132	PRUNUS LAUROCERASUS 'OTTO LUYKEN'	OTTO LUYKEN CHERRY LAUREL	30-36"	CONTAINER	-
√R	61	VIBURNUM X RHYTIDOPHYLLUM	LEATHERLEAF VIBURNUM	30-36"	CONTAINER	-
DECIDU	JOUS SHRUB(S					
CS	14	CORNUS SERICEA (FORMERLY STOLONIFERA)	RED OSIER DOGWOOD	30-36"	CONTAINER	-
VJD	5	ILEX VERTICILLATA 'JIM DANDY'	MALE POLLINATOR WINTERBERRY HOLLY	30-36"	CONTAINER	-
VRS	23	ILEX VERTICILLATA 'RED SPRITE'	RED SPRITE WINTERBERRY HOLLY	30-36"	CONTAINER	-
PEREN	NIAL(S)					
EPM	351	ECHINACEA PURPUREA 'MAGNUS'	MAGNUS CONEFLOWER	1 GAL.	CONTAINER	spaced @ 12" o.c
MV	83	LIRIOPE MUSCARI 'VARIEGATA'	VARIEGATED LILYTURF	QUART	CONTAINER	spaced @ 15" o.c
RFG	80	RUDBECKIA FULGIDA 'GOLDSTURM'	GOLDSTURM/BLACK-EYED SUSAN	1 GAL.	CONTAINER	spaced @ 12" o.c
SNBH	132	SALVIA NEMEROSA 'BLUE HILL'	BLUE HILL MEADOW SAGE	1 GAL.	CONTAINER	spaced @ 12" o.c
ORNAM	IENTAL GRASS	(ES)				
CAKF	151	CALAMAGROSTIS ARUNDINACEA 'KARL FOERSTER'	FEATHER REED GRASS	QUART	CONTAINER	spaced @ 15" o.c
CS	168	DESCHAMPSIA CESPITOSA 'SCHOTTLAND'	SCOTTISH TUFTED HAIR GRASS	QUART	CONTAINER	spaced @ 15" o.c
IMA	112	HAKONECHLOA MACRA 'AUREOLA'	GREEN HAKONE GRASS	QUART	CONTAINER	spaced @ 15" o.c
SSCO	233	SCHIZACHYRIUM SCOPARIUM	LITTLE BLUESTEM	QUART	CONTAINER	spaced @ 15" o.c



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Sheet No:	
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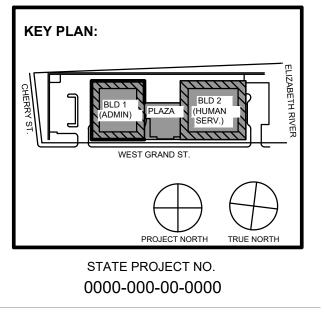
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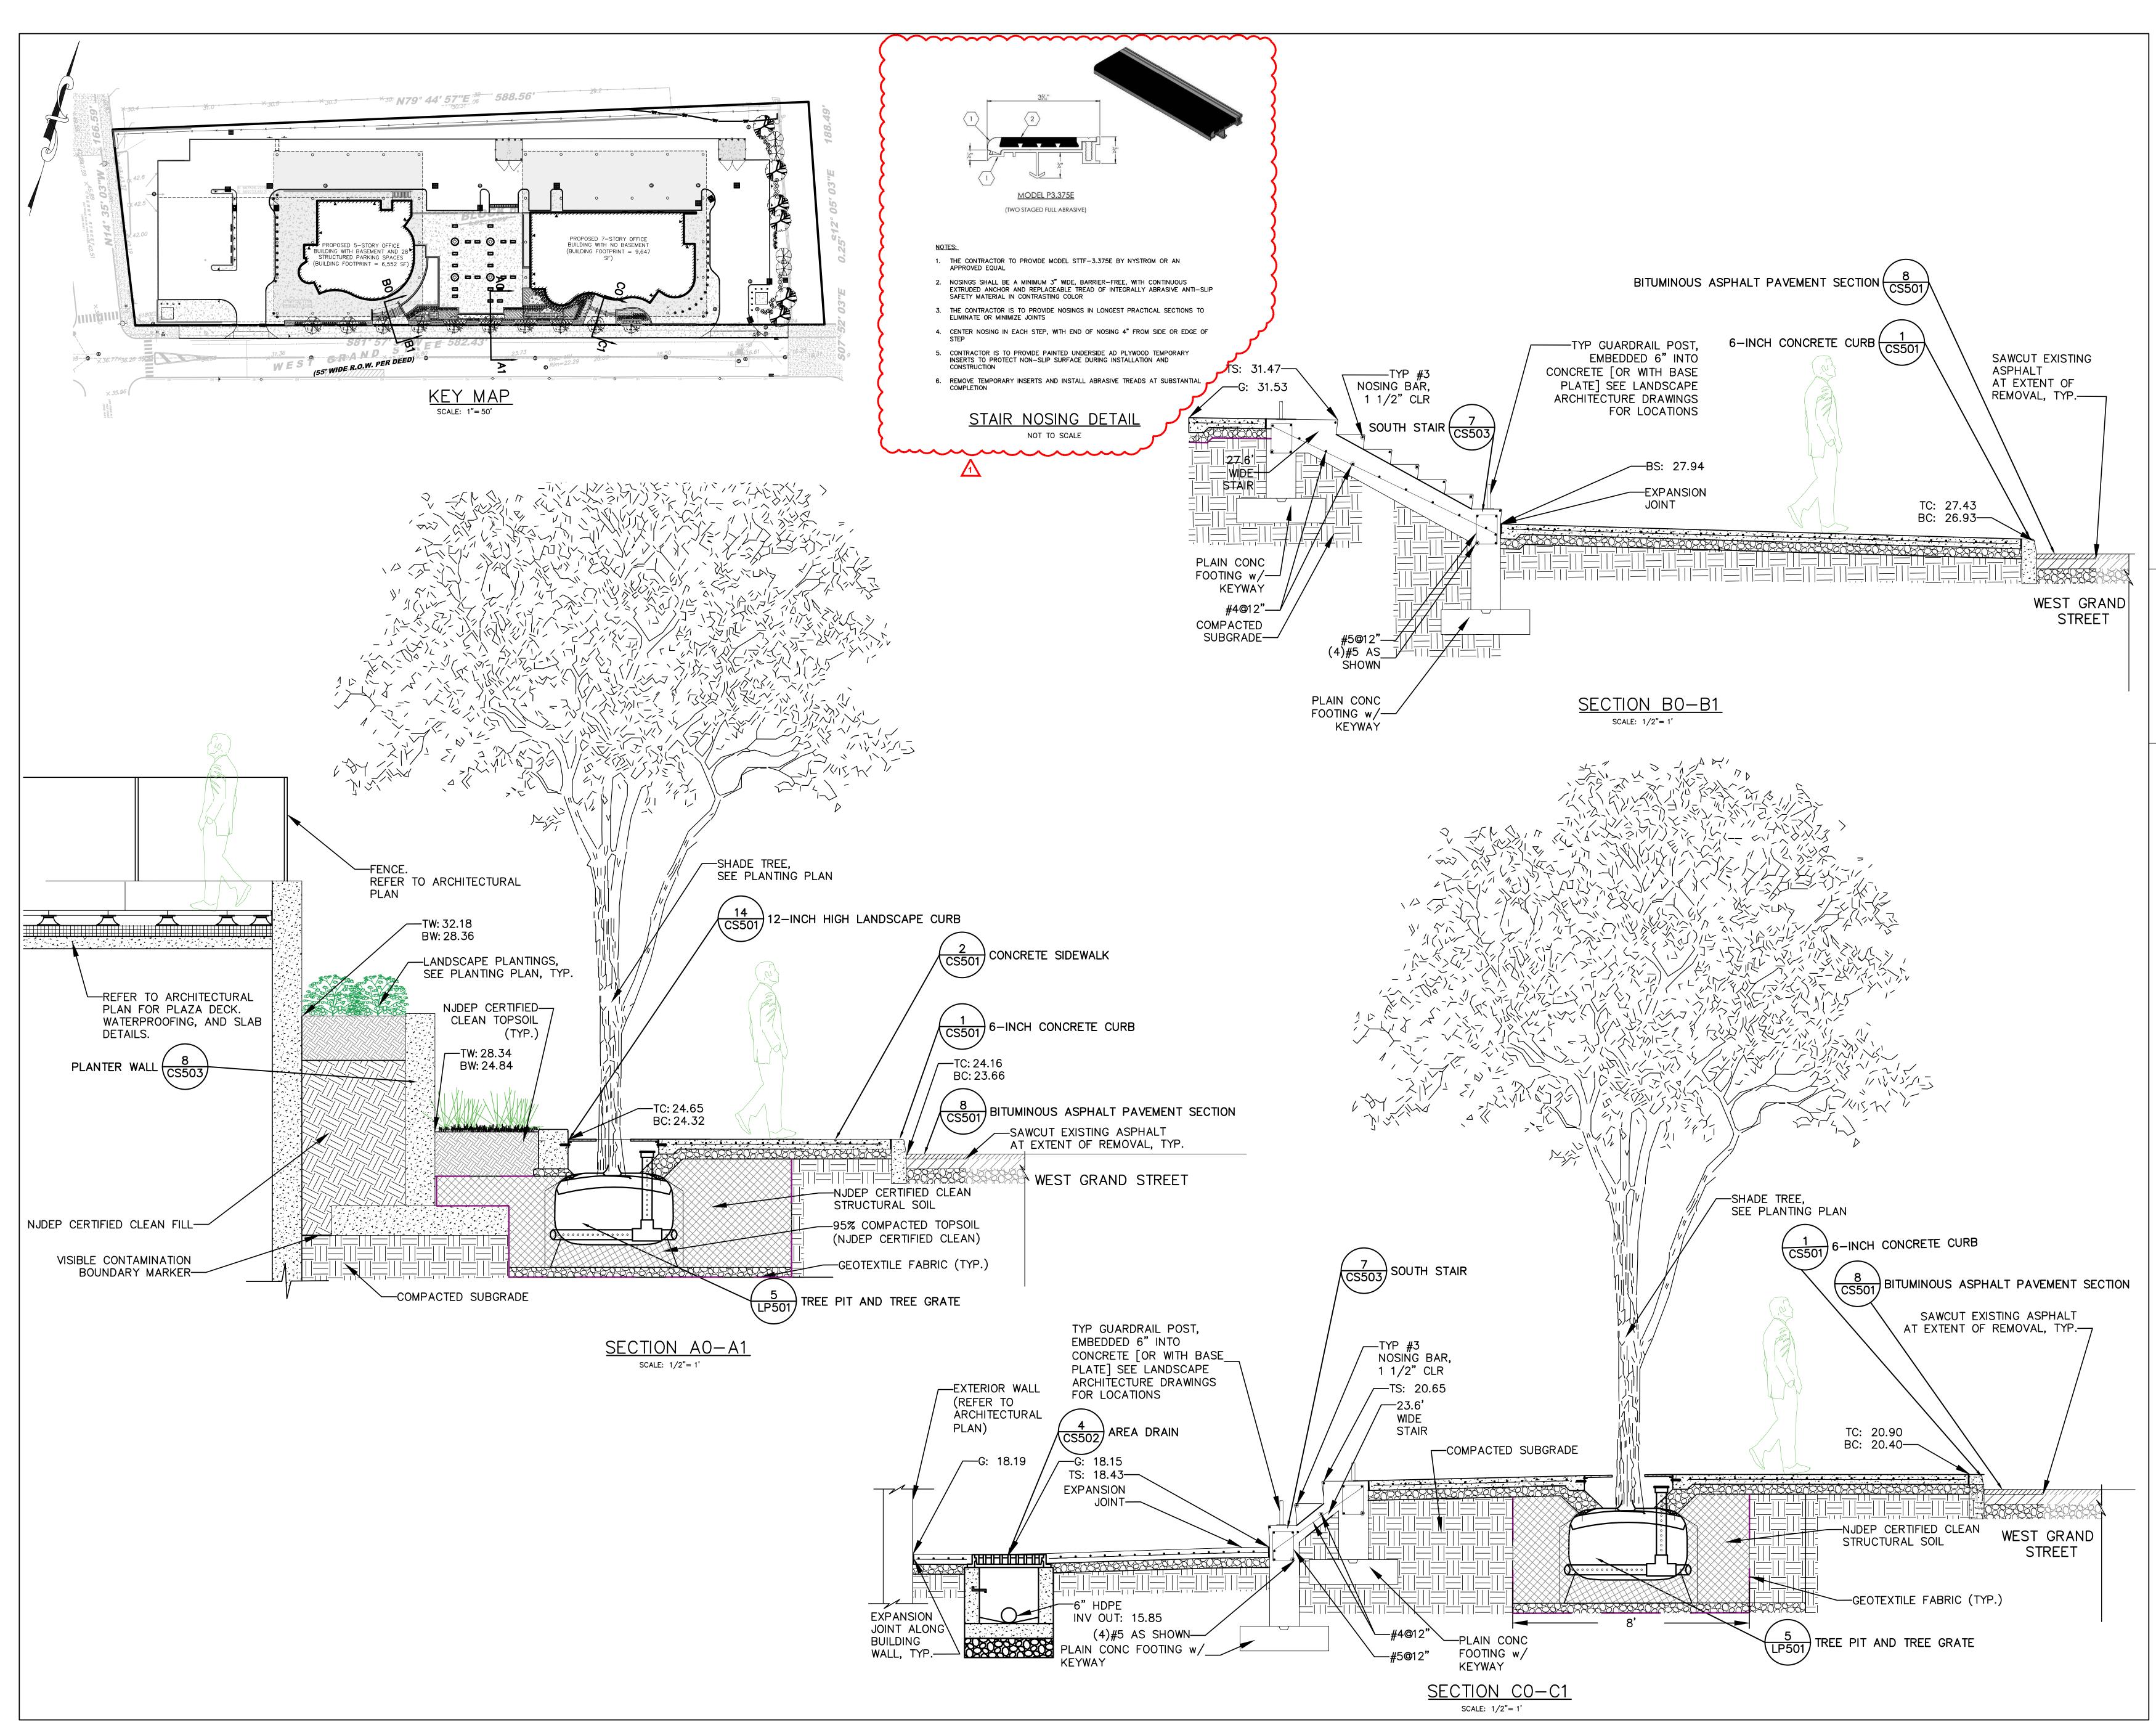
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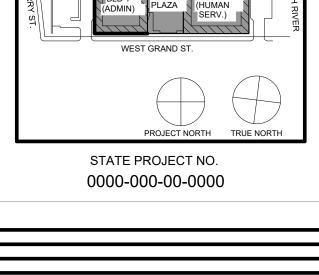
UNION COUNTY IMPROVEMENT AUTHORITY Project: UNION COUNTY GOVERNMENT COMPLEX 81 & 93 WEST GRAND STREET CITY OF ELIZABETH NEW JERSEY, 07202 Drawing Information: Project No: 20.072 Date: 20.072 Date: 21.08.2023 Drawn By: WS Checked By: KBS Sheet Name:

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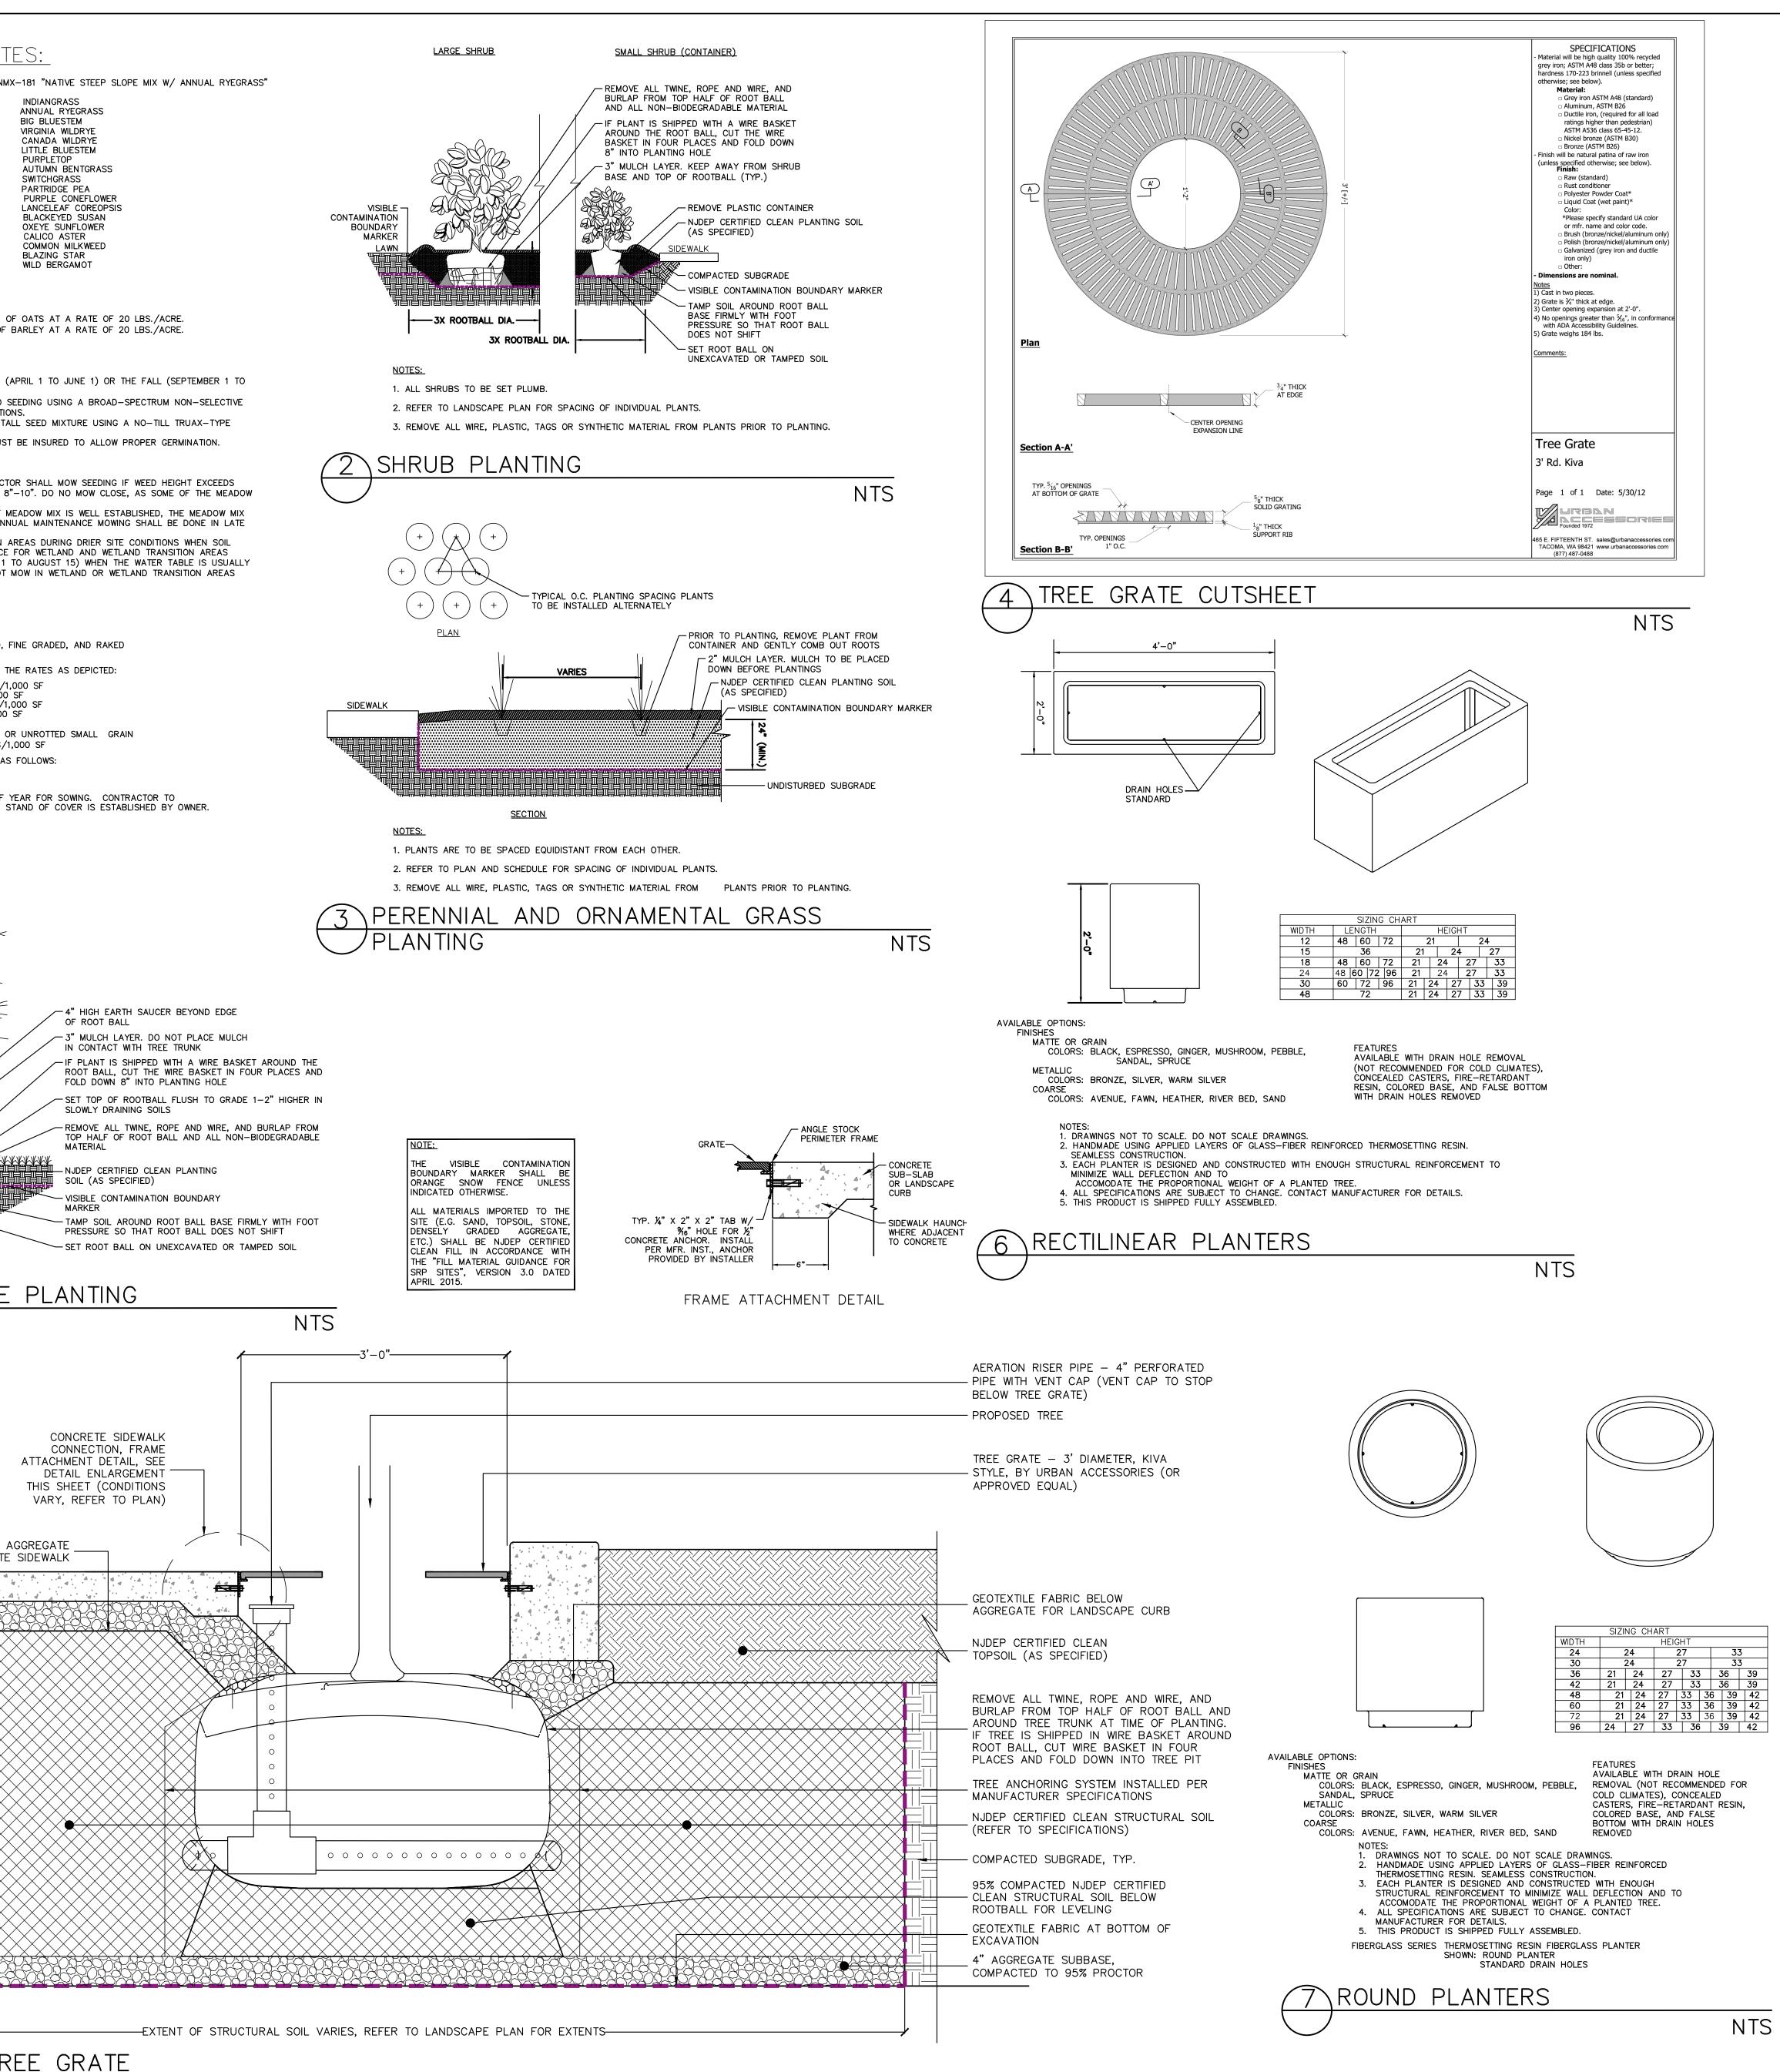
Revisions / Issues **DIGTOUPACTONE** ARCHITECTURE FOR CHANGE 15 Bethany Street • New Brunswick, NJ 08901 • T: 732.249.6242 2450 W Hunting Park Ave • Philadelphia, PA 19122 • T: 215.634.3400 Jeffrey D. Venezia, AIA NJ RA AI 00827100

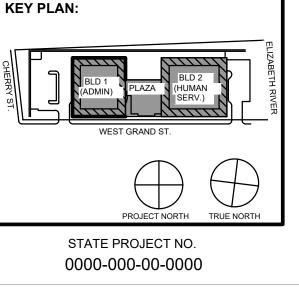

### KEITH B. SMITH, PE, PP PROFESSIONAL ENGINEER, NJ LIC NO 33232



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<text><text><list-item><list-item><list-item><list-item><list-item></list-item></list-item></list-item></list-item></list-item></text></text>	1. NAMES OF PLANTS AS DESCRIBED ON THIS PLAN CONFORM TO THOSE GIVEN IN "STANDARDIZED PLANT NAMES", 1942 EDITION PREPARED BY THE AMERICAN JOINT COMMITTEE ON HORTICULTURAL NOMENCLATURE. NAMES OF PLANT VARIETIES NOT INCLUDED THEREIN CONFORM TO NAMES GENERALLY	20.0% LOLIUM MULTIFLORUM
<text><text><list-item></list-item></text></text>	2. STANDARDS FOR TYPE, SPREAD, HEIGHT, ROOT BALL AND QUALITY OF NEW PLANT MATERIAL SHALL BE IN ACCORDANCE WITH GUIDELINES AS SET FORTH IN THE "AMERICAN STANDARD FOR NURSERY STOCK", PUBLISHED BY THE AMERICAN ASSOCIATION OF NURSERYMEN. PLANT MATERIAL SHALL HAVE NORMAL HABIT OF GROWTH AND BE HEALTHY, VIGOROUS, AND FREE FROM DISEASES AND INSECT	<ul> <li>10.0% ELYMUS VIGINICUS, PA ECOTYPE</li> <li>7.0% ELYMUS CANADENSIS</li> <li>6.1% SCHIZACHYRIUM SCOPARIUM</li> <li>5.0% TRIDENS FLAVU</li> <li>4.0% AGROSTIS PERENNANS</li> <li>3.0% PANICUM VIRGATUM, 'SHAWNEE'</li> </ul>
<text></text>	BE SET PLUMB AND SHALL BEAR THE SAME RELATIONSHIP TO FINISHED GRADE AS THE PLANT'S ORIGINAL GRADE BEFORE DIGGING. PLANT MATERIAL OF THE SAME SPECIES AND SPECIFIED AS THE SAME SIZE SHOULD BE SIMILAR IN SHAPE, COLOR AND HABIT. THE LANDSCAPE ARCHITECT HAS THE RIGHT TO REJECT PLANT MATERIAL THAT DOES NOT CONFORM TO THE TYPICAL OR SPECIFIED HABIT	1.2%ECHINACEA PURPUREA1.0%COREOPSIS LANCEOLATA1.0%RUDBECKIA HIRTA0.8%HELIOPSIS HELIANTHOIDES0.5%ASTER LATERIFLORUS0.3%ASCLEPIAS SYRIACA
<text><text><list-item><list-item><list-item><list-item><ul> <li>Characterized and a sequence of the second of the sec</li></ul></list-item></list-item></list-item></list-item></text></text>	OBTAINABLE, THE CONTRACTOR SHALL SUBMIT PROOF OF NON-AVAILABILITY TO THE LANDSCAPE ARCHITECT AND OWNER TOGETHER WITH A WRITTEN PROPOSAL FOR USE OF AN EQUIVALENT MATERIAL.	0.2% MONARDA FISTULOSA
<text></text>	COMPLIANCE WITH REQUIREMENTS FOR GENUS, SPECIES, VARIETY, SIZE, AND QUALITY. THE LANDSCAPE ARCHITECT RETAINS THE RIGHT TO FURTHER REVIEW PLANT MATERIALS FOR SIZE AND CONDITION OF BALLS AND ROOT SYSTEM, INSECTS, INJURIES, AND LATENT DEFECTS, AND TO REJECT UNSATISFACTORY OR DEFECTIVE MATERIAL AT ANY TIME DURING PROGRESS OF WORK. THE CONTRACTOR SHALL REMOVE REJECTED PLANT MATERIALS IMMEDIATELY FROM PROJECT SITE AS	2. FOR SPRING SEEDING, APPLY A NURSE CROP 3. FOR FALL SEEDING, APPLY A NURSE CROP OF
<list-item><ul> <li>A Support of a lower product of the p</li></ul></list-item>	1. REUSE SURFACE SOILS STOCKPILED ON SITE, VERIFYING COMPLIANCE WITH PLANTING SOIL AND TOPSOIL CRITERIA IN THIS SPECIFICATION THROUGH TESTING. CLEAN SURFACE SOIL OF ALL ROOTS, PLANTS, SOD, AND GRAVEL OVER 1" IN DIAMETER AND DELETERIOUS MATERIALS. IF ON-SITE SOILS ARE TO BE USED FOR PROPOSED PLANTING, THE CONTRACTOR SHALL DEMONSTRATE, THROUGH SOIL TESTING, THAT ON-SITE SOILS MEET THE SAME CRITERIA AS INDICATED IN NOTES PLANS AND	<ol> <li>ELIMINATE UNWANTED VEGETATION PRIOR TO HERBICIDE PER MANUFACTURER'S SPECIFICATION</li> <li>IT IS RECOMMENDED THAT CONTRACTOR INST.</li> </ol>
<list-item><list-item><list-item><ul> <li>A. S. C. S. S.</li></ul></list-item></list-item></list-item>	2. SUPPLEMENT WITH IMPORTED OR MANUFACTURED TOPSOIL FROM OFF SITE SOURCES WHEN TOPSOIL AND PLANTING SOIL QUANTITIES ARE INSUFFICIENT. OBTAIN SOIL DISPLACED FROM NATURALLY WELL-DRAINED SITES WHERE TOPSOIL OCCURS AT LEAST 4" DEEP. DO NOT OBTAIN FROM	1. DURING THE ESTABLISHMENT YEAR, CONTRAC MEADOW MIX HEIGHT. MOW AT A HEIGHT OF 8
<text></text>	3. IF DEPTH OF PLANTING SOILS AND TOPSOIL IS NOT INDICATED IN PLANS OR DETAILS, A MINIMUM 18" DEPTH SHALL BE PROVIDED FOR ALL TREES AND LARGE SHRUBS; MINIMUM 12" DEPTH SHALL BE PROVIDED FOR GROUNDCOVERS, HERBACEOUS AND MEADOW OR ORNAMENTAL GRASS AREAS AND A MINIMUM 6" LAYER SHALL BE INSTALLED IN ALL LAWN AREAS. TOPSOIL AND PLANTING SOIL DEPTH INDICATED ON PLANS AND PLANTING DETAILS AND NARRATIVE SPECIFICATIONS SHALL GOVERN DEPTH	<ol> <li>AFTER THE FIRST GROWING SEASON, AND IF SHALL BE MOWED ONLY ONCE ANNUALLY. AN WINTER DURING THE MONTH OF MARCH.</li> <li>MOW IN WETLAND AND WETLAND TRANSITION DISTURBANCE WILL NOT OCCUR. MAINTENANCE SHALL OCCUR DURING LATE SUMMER (JULY 1</li> </ol>
<ul> <li>P. F. M. 1997 P. HOLD R. M. 1997 P. M. 1993 P.</li></ul>	4. WHERE PLANTING AREAS ARE PROPOSED FOR FORMER PAVED OR GRAVEL AREAS, BEDS SHALL BE EXCAVATED TO A MINIMUM 30" DEPTH AND, AT A MINIMUM, BE BACKFILLED WITH BOTTOM LAYER OF	ESTABLISHMENT OF MEADOW MIX.
<list-item><ul> <li>A. ANTHON CLUB PART IN ALL PLANTER ON PARTY OF ALL PLANTER COMPANY ON PARTY OF ALL PLANTER OF ALL</li></ul></list-item>	<ul> <li>PLACED AT DEPTHS INDICATED IN PLANS, DETAILS AND NOTES.</li> <li>5. IF THE QUANTITY OF SOILS FROM THE SITE IS NOT ADEQUATE TO FILL PLANTING AREAS TO THE DEPTH INDICATED IN THE PLANS AND DETAILS, CONTRACTOR SHALL FURNISH PLANTING SOILS THAT ARE FREE OF BROKEN GLASS, PAINT CHIPS, PLASTIC, DELETERIOUS MATERIALS, ROOTS, WEEDS, BOULDERS, COBBLES AND GRAVEL OVER 1" IN DIAMETER AND COMPLY WITH THE FOLLOWING CRITERIA: -SOILS SHALL MEET ALL APPLICABLE SOIL REMEDIATION STANDARDS</li> <li>ORGANIC CONTENT: 2–5% IN NATIVE SOILS; UP TO 10% IN AMENDED SOILS</li> <li>SOLUBLE SALTS: LESS THAN 0.5 MM HOS/CM</li> <li>SOIL PH: 4.5–7% TO BE AMENDED PER SOIL TEST RESULTS</li> <li>-PHYSICAL (SIEVE) ANALYSIS/ SOIL TEXTURE</li> <li>SAND: 40–60% SILT: 25–60% CLAY: 5–20%</li> </ul>	<ol> <li>PRIOR TO SEEDING, AREA IS TO BE TOPSOILED, OF ALL DEBRIS LARGER THAN 2" DIAMETER.</li> <li>THE FOLLOWING SEED MIX SHALL BE SOWN AT " RED FESCUE 1 1/2 LBS./' PERENNIAL RYEGRASS 1 LBS./1,000 KENTUCKY BLUEGRASS 1 1/2 LBS./1 SPREADING FESCUE 1 LBS./1,000</li> <li>SEED MIX SHALL BE MULCHED WITH SALT HAY (</li> </ol>
<ul> <li>In the set of the set of</li></ul>	6. ALL PLANTING SOILS SHALL BE SUBMITTED FOR TESTING TO THE STATE COOPERATIVE EXTENSION SERVICE, OR APPROVED EQUAL, PRIOR TO DELIVERY TO THE SITE. CONTRACTOR SHALL FURNISH SOIL SAMPLES AND SOIL TEST RESULTS TO LANDSCAPE ARCHITECT OR OWNER AT A RATE OF ONE SAMPLE PER 500 CUBIC YARDS TO ENSURE CONSISTENCY ACROSS THE TOTAL VOLUME OF PLANTING SOIL REQUIRED. TEST RESULTS SHALL EVALUATE FOR ALL CRITERIA LISTED IN THIS SPECIFICATION. IF TESTING AGENCY DETERMINES THAT THE SOILS ARE DEFICIENT IN ANY MANNER AND MAY BE CORRECTED BY ADDING AMENDMENTS, THE CONTRACTOR SHALL FOLLOW STATED RECOMMENDATIONS FOR SOIL IMPROVEMENT AND FURNISH SUBMITTALS FOR ALL AMENDMENTS PRIOR TO DELIVERY OF SOIL	<ol> <li>SEEDING DATES FOR THIS MIXTURE SHALL BE A SPRING: APRIL 1 – MAY 31 FALL: AUGUST 16 – OCTOBER 31</li> </ol>
<ul> <li>Particle List and Particle Park and Part Ale 1000 Carlete Part Ale LORDER CORPORE SCIENCE ALE ALE ALE ALE ALE ALE ALE ALE ALE AL</li></ul>	WEED FREE, ORGANIC MATTER. ORGANIC AMENDMENT SHALL BE WELL COMPOSTED, PH RANGE OF 6-8; MOISTURE CONTENT 35-55% BY WEIGHT 100% PASSING THROUGH 1" SIEVE; SOLUBLE SALT CONTENT LESS THAN 0.5 MM HOS/CM; MEETING ALL APPLICABLE ENVIRONMENTAL CRITERIA FOR CLEAN FILL; FREE OF BROKEN GLASS, PAINT CHIPS, PLASTIC, DELETERIOUS MATERIALS, ROOTS, WEEDS, BOULDERS,	
<ul> <li>In control with a state of the second process of the second proces of the second proces of the second process of the second</li></ul>	PLANTING SOILS AND TOPSOIL SHALL BE PLACED IN 12-18" LIFTS THAT ARE LOOSELY COMPACTED. NO	
<ul> <li>Direct LU-LER, MD MLL 20102 AT 3EL</li> <li>PIERE AN SPREET THE CONSTRUCT CALLER OWNER THE ALL SPREET DO CONTROL AND THE DOCUMENT THE ALL SPREET DOCUMENT CALLER AND THE ALL SPREET TALES AND THE ALL</li></ul>	1. PACKAGED MATERIALS: PACKAGED MATERIALS SHALL BE DELIVERED IN CONTAINERS SHOWING WEIGHT,	
<ul> <li>a must be all in the ball in the ball of the</li></ul>	DURING DELIVERY, AND WHILE STORED AT SITE. 2. TREES AND SHRUBS: THE CONTRACTOR SHALL PROVIDE TREES AND SHRUBS DUG FOR THE GROWING SEASON FOR WHICH THEY WILL BE PLANTED. DO NOT PRUNE PRIOR TO DELIVERY UNLESS OTHERWISE DIRECTED BY THE LANDSCAPE ARCHITECT. DO NOT BEND OR BIND-TIE TREES OR SHRUBS IN SUCH A MANNER AS TO DAMAGE BARK, BREAK BRANCHES, OR DESTROY NATURAL SHAPE. PROVIDE	
<ul> <li>Hencom Her Sumach Sin Moo Locations.</li> <li>A metatrike have een committing and next week available to be exact week available to be exact of the exac</li></ul>	3. ALL PLANTS SHALL BE BALLED AND BURLAPPED OR CONTAINER GROWN AS SPECIFIED. NO CONTAINER GROWN STOCK WILL BE ACCEPTED IF IT IS ROOT BOUND. ALL ROOT BALL WRAPPING AND BINDING MATERIAL MADE OF SYNTHETICS OR PLASTICS SHALL BE REMOVED FROM THE TOP OF THE BALL AT THE TIME OF PLANTING, IF THE PLANT IS SHIPPED WITH A WIRE BASKET AROUND THE ROOT BALL, THE WIRE BASKET SHALL BE CUT AND FOLDED DOWN 8" INTO THE PLANTING HOLE. WITH	
<ul> <li>In the comparison while watery that indexide in the contract sector building and owner methods and owner methods in the contract. In the contract sector building and owner methods and owner methods in the contract sector building and owner methods. The contract sector building and th</li></ul>	4. THE CONTRACTOR SHALL HAVE TREES AND SHRUBS DELIVERED TO SITE AFTER PREPARATIONS FOR PLANTING HAVE BEEN COMPLETED AND PLANT IMMEDIATELY. IF PLANTING IS DELAYED MORE THAN 6 HOURS AFTER DELIVERY, THE CONTRACTOR SHALL SET TREES AND SHRUBS IN SHADE, PROTECT FROM WEATHER AND MECHANICAL DAMAGE AND KEEP ROOTS MOIST BY COVERING WITH MULCH, BURLAP OR	
<ul> <li>REPORTED FOR TWANTERSON.</li> <li>2. THE CONTRACTOR TO THE CANTON LOCATIONS. FOR PENEW AND APPROVAL BY THE LANDSCAPE ARCHITED AND/ONE SMALL BEACH THE CONTRACTOR WITH RESIN. INTERT UNLESS OF REFORE THE CONTRACTOR IS THE STALL STOLENGE.</li> <li>3. AND FLATT SHALL BE PUT INTO THE GROUND BETTOR PROJECT BERING AND ADDRESS THE STALLESS OF REFORMED AND ADDRESS THE STALLESS OF REGISTION OF PLATE ADDRESS. THE ADDRESS OF REFORE ADDRESS AND ADDRES</li></ul>	1. THE CONTRACTOR SHALL VERIFY THE LOCATION OF ALL EXISTING UNDERGROUND UTILITY AND SEWER LINES PRIOR TO THE START OF EXCAVATION ACTIVITIES. NOTIFY THE PROJECT ENGINEER AND OWNER	DECIDUOUS TREE
<ul> <li>3. NO PLANT SHULL BE PUT INTO THE GROUND BEFORE ROUGH GRADING HAS BEEN COMPLETE AND APPROVED BY THE FRANCET LANGEAGE ARKING TO FRANCET COMPLETE REMIRER.</li> <li>4. ALL LANGEARD ARKAN SHALL BE LEVELO THE CARGE THE FRANCE PROCEED REMIRER.</li> <li>5. ALL FLANT MATERAL SHALL BE NETALED AS FEB DETALS. NOTES AND CONTRACT SPECIFICATIONS.</li> <li>6. THE CONTRACTOR SHALL KEP AREA CLEAN DURING DELICERY AND INSTALLATION OF PLANT MITTERM STRACE PROCEEDRES.</li> <li>7. AFTER PROVIDE JAMES SHALL BE NETALED AS FEB DETALS. NOTES AND CONTRACT SPECIFICATIONS.</li> <li>8. AFTER PROVIDE MARK THERM THISTALTION AND MATERIANCE PROCEEDRES.</li> <li>8. AFTER PROVIDE MARK THERE AND CARD. ALT TWAN HANTING DERISES MATERIALS.</li> <li>9. AFTER TRAVER DATA THE PART LOCATION. ALT TWAN HANTING DERISE MATERIALS.</li> <li>9. AFTER TRAVER MARK THE SHOLD DETAL THE THE TAXATION. AND TWAN THATTERAL. TO MURST MATERIAL DERISE OF THE INSTALLATION.</li> <li>9. MULCH SHOLD NOT BE PHILD DETAL TRAVER AND THE THE AND ADDRESS.</li> <li>9. AFTER TRAVER MARK THE THE THAT MARK THE AND ADDRESS ATTER THE TAXATION.</li> <li>9. MULCH SHOLD NOT BE PHILD DETAL TRAVER AND AND THE THE ADDRESS THE INSTALLATION.</li> <li>9. MULCH SHOLD NOT BE ASSOCIATED THE THE TAXATION.</li> <li>9. MULCH SHOLD THE CHILD AND THE THE TAXATION AND THE THE TAXATION.</li> <li>9. MULCH SHOLD THE CHILD AND THE THE TAXATION AND THE THERE TAXATION.</li> <li>9. MULCH SHOLD THE CHILD AND THE THE TAXATION AND THE THE TAXATION.</li> <li>9. MULCH SHOLL THE ARE NOT COMERED STATISTICATION.</li> <li>9. MULCH SHOLL THE ARE ADD THAT THAT ARE NOT COMERED THAT THE TAXATION TO ADMITTANT AND THE THE TAXATION TO ADMITTANT AND THE TAXATION.</li> <li>9. MULCH SHALL SHAPPLY SUPPLICIENTATION OF BANKES THAT MATTERIAL TO MULCH THE AND THE THE TAXATION OF BANKES THAT THAT TAXATION TO ADMITTANT TO ADMITTANT THE TAXATION TO ADMITTANT AND THE THE TAXATION OF BANKES THAT TAXATION TO ADMITTANT TO ADMITTANT TO ADMITTANT TO ADMITTANT TO ADMITTANT THE TAXATION TO ADMITTANT TO ADMITTANT TO ADMITTANT TO ADMITTANT</li></ul>	RESPONSIBLE FOR ANY DAMAGE. 2. THE CONTRACTOR TO STAKE OUT PLANTING LOCATIONS, FOR REVIEW AND APPROVAL BY THE LANDSCAPE ARCHITECT AND/OR OWNER BEFORE PLANTING WORK BEGINS. THE LANDSCAPE ARCHITECT AND/OR OWNER SHALL DIRECT THE CONTRACTOR IN THE FINAL PLACEMENT OF ALL PLANT MATERIAL AND LOCATION OF PLANTING BEDS TO ENSURE COMPLIANCE WITH DESIGN INTENT UNLESS OTHERWISE	
<ul> <li>ALL FIRE CRADED AREAS SHOLLD BE HAND RAKED SMOOTH ELIMINATING ANY CLUMPS AND UNEVEN SUFFACES FROM TO FLANDS.</li> <li>ALL FIRE CRADED AREA AS SHOLLD BE HERTALED AS PER ETALS, NOTES AND CONTRACT SPECIFICATIONS. THE LANDSCAPE ARCHITEK MAY RELEW BRAILLATION AND MATEHANARE SPECIFICATIONS. THE CONTRACTOR STALL KEEP AREA DISM. DISMOLTANT DATA MATEHANARE SPECIFICATIONS. THE CONTRACTOR STALL KEEP AREA DISM. DISMOLTANT DATA MATEHANARE SPECIFICATIONS. THE CONTRACTOR STALL KEEP AREA DISM. DISMOLTANT DATA THAN THE RAKE TO ADACENT MAY ERAL TANK AND REDUNINE TO CONTRACT. SPECIFIC DATA MATEHANAR SPECIFIC DATA SPECIFIC DATA MATEHANAR SPECIFIC DATA MATEHANAR SPECIFIC DATA MATEH</li></ul>	3. NO PLANT SHALL BE PUT INTO THE GROUND BEFORE ROUGH GRADING HAS BEEN COMPLETED AND	
<ul> <li>THE LANGSAPE ARCHITECT MAY REVEW INSTALLATION AND MAINTEANCE PROCEDURES.</li> <li>THE CONTRACTOR SHALL SEEP AREA CLAM DUBY COMMUNICATE DEBRES ON LANGSAPE MATERIALS. REPARE DAMAGE TO ADJACENT AREAS CAUSED BY LANDSCAPE INSTALLATION OF PLANT MATERIALS. REVOVE AND DESCRIPTER TO ADJACENT AREAS CAUSED BY LANDSCAPE INSTALLATION OF PLANT MATERIALS. REVOVE AND DESCRIPTER YEAR SHALLED TO ADJACENT ON THE URLAPS SHALLE BY PLANT IN FELCALED DUBY SO 1/3 OF THE ROOT BALL IS. EXPOSED SINTERIES BUILDING SEE OWNELELY AND REVOLD DE PULLED DUBY SO 1/3 OF THE ROOT BALL IS. EXPOSED SINTERIES USUAL BY EVENTABLY DUBY ATTENTIATION OF THE ROOT BALL IS. EXPOSED SO THE RUNCE ON THE RUNCE OF ANY PLANT MATERIAL NO. MUCH OR TOPOSILIS SHALLED TO BE PLILD UP AROUND THE RUNCE OF ANY PLANT MATERIAL NO. MUCH OR TOPOSILIS SHALL BE WATERED TRACOLOGIES AND HEALTHY PLANT GROWTH.</li> <li>ALL PLANTS SHALL BEST WATERED TRACOLOGY TIMES DUBY OR THE RIST 24 HOUR PERIOD AFTER COMPILETION OF A PROLECT ALL EXPOSED GROUND SURFACES THAT ARE NOT PARED WITHIN THE CONTRACT INTITUE AROUTH AT RETERIOR DE ALIVE AND IN YEOGROUS GROWTHE AND WEATHER CONDITIONS TO MAINTAIN VGOROUS AND HEALTHY PLANT GROWTH.</li> <li>ALL PLANTS SHALL BEN BE ARE NOT COXED DEAR OR APPROVED COLAL MUCH THAT HE CONTRACT IN ALL BLAND ON FAR ARE NOT POWER.</li> <li>GUARANTEE</li> <li>NEW PLANT MATERIAL SHALL BE CHARANTERD TO DE ALIVE AND IN YGOROUS GROWTHE CONDITION THE CONTRACT IN ALL BLAND ACCEPTIANCE BY THE OWNER.</li> <li>MAINTENANCE</li> <li>I. DEBRIS AND WEED CONTROL THIS TASK SHALL INCLUE THE REMOVAL OF ALL UNDESIRABLE UTTER, MAINTANUE APPEARAMEE. AND EXERCISE OR THAK IS TO PROVIDE ANIATANE MITTER THE ALFOLD TO BE AND AND THE CONTRACT AT NO EXPENSE TO THE OWNER.</li> <li>MAINTENANCE</li> <li>MAINTENANCE APPEARAMEE. AND EXPERSION OR AN ECCURATELY AND THE AND AND AND AND AND AND AND AND AND AND</li></ul>	ALL FINE GRADED AREAS SHOULD BE HAND RAKED SMOOTH ELIMINATING ANY CLUMPS AND UNEVEN	
<ul> <li>REPAIR DAMAGE TO ADJACENT AREAS CAUSE BY LANSCAPE INSTALLATION OPERATIONS.</li> <li>A PETR PLANT IS PLACED IN TREE PT LOCATION, ALL TWAE HOLDING ROOT BALL TOGETHER SHOULD BE COMMETERLY REMOVED AND THE BURLAP SHOULD BE PULLED COMIN SO 13 OF THE ROOT BALL IS ENDODED STIMIETTO BURLAP SHOULD BE CUMPLETELY REMOVED AFTER INSTALLATION.</li> <li>MULCH SHOULD DE TOUCHING THE BASK OF THE TRUNK OF ANY PLANT MATERIAL NO MULCH OR TOPSOL SHOULD DE TOUCHING THE BASK OF THE TRUNK OF ANY PLANT MATERIAL NO MULCH OR TOPSOL SHOULD DE TOUCHING THE BASK OF THE TRUNK OF ANY PLANT MATERIAL NO MULCH OR TOPSOL SHOULD DE TOUCHING THE BASK OF THE TRUNK OF ANY PLANT MATERIAL NO MULCH OR TOPSOL SHOULD DE TOUCHING THE BASK OF THE TRUNK OF ANY PLANT MATERIAL NO MULCH OR TOPSOL SHOULD DE TOUCHING THE BASK OF THE TRUNK OF ANY PLANT MATERIAL NO MULCH OR TOPSOL SHOULD DE TOUCHING THE BASK OF THE TRUNK OF ANY PLANT MATERIAL NO. MULCH OR SHELFORD SHOLE BOOKED BY AND THE ADDITION OF DUST.</li> <li>IO. AFTER COMPLETION OF A PROJECT, ALL EXPOSED CROUND SUFFACES THAT ARE NOT PAVED WITHIN THE CONTRACTOR SHALL SUPPLY SUPPLEMENTARY BRIGATION UNTIL ACCEPTANCE BY OWNER.</li> <li>CUARANTEE</li> <li>II. CONTRACTOR SHALL SHALL BE CUARANT RIGATION UNTIL ACCEPTANCE BY OWNER.</li> <li>CUARANTEE</li> <li>I. DEBRIS AND WEED CONTROL. THIS TASK SHALL INCLUE THE REMOVED AND REPLACED IN KIND BY THE CONTRACTOR AT NO EXPENSE TO THE OWNER.</li> <li>MAINTENANCE</li> <li>MAINTENANCE</li> <li>MAINTENANCE ANY ORIGOTS OR PLANTS WHICH OR FRANCING CONDITION OTHER MAINTEND ASSAES TO THE OWNER.</li> <li>MAINTENANCE</li> <li>MAINTENANCE</li> <li>DEBRIS AND WEED CONTROL. THIS TASK SHALL INCLUE THE REMOVED AND REPLACED IN KIND BY THE CONTRACTOR AT IN MEDIATION OF DISS.</li> <li>MAINTENANCE</li> <li>MAINTENANCE AND DEPLAND OR SPECIES OR PLANTS WHICH OR CREATE A HEALTH OR SAFELY HACARDO OR AND INFORMED ASSAES THE HEAD ONE ON STALL BE REMOVED MAINTEN OTHER MAINTENAL SUBJLICH ASSAES THE NEED FOR DEAR SPECIES OR PLANTS MEDIATION OF ALEXAND AND AND AND AND AND AND AND AND AND</li></ul>	THE LANDSCAPE ARCHITECT MAY REVIEW INSTALLATION AND MAINTENANCE PROCEDURES. 6. THE CONTRACTOR SHALL KEEP AREA CLEAN DURING DELIVERY AND INSTALLATION OF PLANT	
<ul> <li>EXPOSED. SYNTHETIC BURLAP SHOULD BE COMPLETELY REMOVED AFTER INSTALLATION.</li> <li>MULCH SHOULD NOT BE PILED UP AROUND THE TRUNK OF ANY PLANT MATERIAL IN MULCH OR TOPSSOL SHOULD BE TOOKING THE BASE OF THE TRUNK ADV. THE ROOT COLLAR.</li> <li>PLANTING, ALL PLANTS SHALL THEN DE WATERD WERK THE ROOT COLLAR.</li> <li>PLANTING, ALL PLANTS SHALL THEN DE WATERD WERKEY OR AS RECOVERD BY OWNER AND WEATHER CONDITIONS TO MAINTAIN WOORDUS AND HEALTHY PLANT GROWTH.</li> <li>AFTER COMPLETION OF A PROJECT, ALL EXPOSED GROUND SURFACES THAT ARE NOT PAVED WITHIN THE CONTRACT LIMIT LIME. AND THAT ARE NOT COVERD BY LANDSCAPE PLANTING OR SECOND AS STORTAGET LIMIT LIME. AND THAT ARE NOT COVERD BY LANDSCAPE PLANTING OR SECOND AS THE CONTRACTOR SHALL SUPPLY SUPPLEMENTARY IRRIGATION UNTIL ACCEPTANCE BY OWNER.</li> <li>QUARANTEE</li> <li>I. CONTRACTOR SHALL SUPPLY SUPPLEMENTARY IRRIGATION UNTIL ACCEPTANCE BY OWNER. PLANT MATERIAL SHALL BE QUARANTEED TO BE ALIVE AND IN VIGOROUS GROWING CONDITION FOME-ATIV. OWNER DEAD DUBING ONES SHALL BE REMOVED AND REPLACED IN KND BY THE CONTRACTOR AT NO EXPENSE TO THE OWNER. SHALL BE REMOVED AND REPLACED IN KND BY THE CONTRACTOR AT NO EXPENSE TO THE OWNER. SHALL BE REMOVED AND REPLACED IN KND BY THE CONTRACTOR AT NO EXPENSE TO THE OWNER. SHALL BE REMOVED AND REPLACED IN KND BY THE CONTRACTOR AT NO EXPENSE TO THE OWNER. SHALL BE REMOVED AND ARE SWHET ON SAFETY HAZARD OF AN UNATURAL VISUAL NUISARES SHALL BE REMOVED AND ALE SHALL OR SAFETY HAZARD OF AN UNATURAL WISUAL NUISARES SHALL BE REMOVED AND AND EVENT.</li> <li>J. PLANTING BEDS WITH EXISTING OR SPECIFIED OR CANKE MULCH OF AN EQUIVALENT. TO MAINTAIN THIS WEEDS, BARE GROUND OR SOLL ARE DESCEND. SHE DED DE RACE AND AS SUCH OR SAFETY HAZARD FRANKLE BUANTAINED WITH A HARE AMALED AND AN EQUIVALENT. TO MAINTAIN THIS WEEDS, BARE GROUND OR SOLL ARE DERAWED AND AS AND AN EQUIVALENT. TO MAINTAINTO WEEDS, BARE GROUND OR SOLL ARE DERAWED AND AS MEED AND AND AND AND AND WEEDS, BARE GROUND OR SOLL ARE DERAWED AND AS MEET WITH SIRKL WIRKS WITH SIRKL WARD</li></ul>	REPAIR DAMAGE TO ADJACENT AREAS CAUSED BY LANDSCAPE INSTALLATION OPERATIONS. 7. AFTER PLANT IS PLACED IN TREE PIT LOCATION, ALL TWINE HOLDING ROOT BALL TOGETHER SHOULD	GEOTEXTILE FABRIC BELOW FOR CONCRETE
<ul> <li>CONDITIONS TO MAINTAIN VIGOROUS AND HEALTHY PLANT GROWTH.</li> <li>10. AFTER COMPLETION OF A PROJECT, ALL EXPOSED GROUND SURFACES THAT ARE NOT PAVED WITHIN THE CONTRACT UNIT LINE, AND THAT ARE NOT COVERED BY LANDSCAPE PLANTING OR SEEDING AS SPECIFED, SHALL BE COVERED BY A SHREDDED HARDWOOD BARK OR APPROVED EQUAL MULCH THAT MILL PREVENT SOLL RESOLVED BY A SHREDDED HARDWOOD BARK OR APPROVED EQUAL MULCH THAT MILL PREVENT SOLL RESOLVED THE EMANATION OF DUST.</li> <li>11. CONTRACTOR SHALL SUPPLY SUPPLEMENTARY IRRIGATION UNTIL ACCEPTANCE BY OWNER.</li> <li>GUARANTEE</li> <li>15. ON TRACTOR AT NO EXPENSE TO THE GUARANTEED TO BE ALIVE AND IN VIGOROUS GROWING CONDITION FOR HEAT AND RED ACCEPTANCE BY THE WOMEP. HANTON TO BE UNHERLATHY DYING OR DEAD DURING THIS PERIOD, SHALL BE REMOVED AND REPLACED IN KIND BY THE CONTRACTOR AT NO EXPENSE TO THE OWNER. HANTON MATERIAL FOLDAD TO BE UNHERLATHY DYING OR DEAD DURING THIS PERIOD, SHALL BE REMOVED AND REPLACED IN KIND BY THE CONTRACTOR AT NO EXPENSE TO THE OWNER. HANTONE AND REAL FOR DEAT SANCE THAT AN EXPLANTION OF DISTANCE STARLE STALL SUBSECTIONS TALK IS TO PROVIDE A NEAL FOR DEAT SANCE AND WEEDS. THE OBJECTIVE OF THIS SUBSECTIONS TALK IS TO PROVIDE AN REAL FOR DEAT SANCE AND WEEDS. THE OBJECTIVE OF THIS SUBSECTIONS TALK IS TO PROVIDE A NEAL TO REALT OR SAFETY HAZARO OR AN UNMATAN USUAL NUISANCE SHALL BE REMOVED ARRAY MILLING MEDIATELY.</li> <li>MULCHING ALL PLANTING BEDS WITH ANSTRING AS REPORTED ORGANIC MULCH OF AND EQUIVALENT. TO KANTANT THIS LEVEL WITH A MINIMUM TWO-INCH DEPTING OS REPERIOR AS RECEED. AREAS WITH A MARE AND EXAMPTER AND AND ASTRICH SANCE AND AT SUCH A LEVEL THAT NO WEEDS, BARE GROUND OR SOLLARE SHALL BE MAINTAINED AND THE LEVELS THAT AND AND AND AND AND AND AND AND AND AND</li></ul>	EXPOSED. SYNTHETIC BURLAP SHOULD BE COMPLETELY REMOVED AFTER INSTALLATION. 8. MULCH SHOULD NOT BE PILED UP AROUND THE TRUNK OF ANY PLANT MATERIAL. NO MULCH OR TOPSOIL SHOULD BE TOUCHING THE BASE OF THE TRUNK ABOVE THE ROOT COLLAR. 9. ALL PLANTS SHALL BE WATERED THOROUGHLY TWICE DURING THE FIRST 24-HOUR PERIOD AFTER	
<ul> <li>GUARANTEE</li> <li>NEW PLANT MATERIAL SHALL BE GUARANTEED TO BE ALIVE AND IN VIGOROUS GROWING CONDITION FOR A PERIOD OF ONE YEAR FOLLOWING ACCEPTANCE BY THE OWNER. PLANT MATERIAL FOUND TO BE UNHEALTHY, DYING OR DEAD DURING THIS PERIOD, SHALL BE REMOVED AND REPLACED IN KIND BY THE CONTRACTOR AT NO EXPENSE TO THE OWNER.</li> <li>MAINTENANCE</li> <li>DEBRIS AND WEED CONTROL. THIS TASK SHALL INCLUDE THE REMOVAL OF ALL UNDESIRABLE LITTER, WELL-MAINTAINED APPEARANCE. ANY OBJECTS OR FLAINTS WHICH CREATE A HEALTH OR SAFETY HAZARD OR AN UNNATURAL VISUAL NUISANCE SHALL BE REMOVED IMMEDIATELY.</li> <li>MULCHING, ALL PLANTING BEDS WTH EXISTING OR SPECIFED ORGANIC MULCH CREATE A HEALTH OR SAFETY HAZARD OR AN UNNATURAL VISUAL NUISANCE SHALL BE REMOVED IMMEDIATELY.</li> <li>MULCHING, ALL PLANTING BEDS WTH EXISTING OR SPECIFED ORGANIC MULCH OR ALE VELITHAT NO WETDS, BARE GROUND OR SOIL ARE EXPOSED.</li> <li>PLANTINGS, LANDSCAPE MAINTENANCE SHALL INCLUDE THE RESEEDING OR REPLANTING OF LANDSCAPE AREAS WHICH ARE DAMAGED, DESTROYED, OR FAILING DUE TO INSECTS, DISEASE, WEATHER OR PHYSICAL DAMAGE, ALL LANDSCAPED AREAS WHICH ARE DAMAGED, DESTROYED OR ARE FAILING, AS DESCRIBED ABOVE, SHALL BE REPLACED DURING THE NEXT PLANTING SEASON.</li> <li>EXISTING AND PROPOSED PLANT MATERIAL SHALL BE MAINTAINED TO PROVIDE MINIMUM SIGHT DOWN TO WITHIN A FEE INFL.</li> <li>CONTRACTOR SHALL ASSESS THE NEED FOR DEER PROTECTION ON SITE. IF DEEMED NECESSARY, SHADE AND ORNAMENTAL TREES SHALL BE REPLACED DIRING THE NEXT PLANTING SEASON.</li> <li>EXISTING AND PROPOSED PLANT MATERIAL SHALL BE MAINTAINED TO PROVIDE MINIMUM SIGHT DOWN TO WITHIN A FEE INCLUD. THE GROUND, THE GUARDS CAN BE REMOVED IN SPRING AND SAVED FOR RE-INSTALLATION DURING THE RESCENTION THE SPRAL WRAP TREE GUARDS, OR APPROVED EQUAL, PROTECTION HER FOR THIS SPRING AND SAVED FOR RE-INSTALLATION DURING THE RESCENT AS A PART OF A MAINTENNAL RAPT TREE GUARDS, OR APPROVED EQUAL, PROTECTION LIENGTH TO BE FROM BELOW THE SPRING AND SAVED FOR RE-INSTALLATION DURING THE FOLLOWING WITHER AS A</li></ul>	CONDITIONS TO MAINTAIN VIGOROUS AND HEALTHY PLANT GROWTH. 10. AFTER COMPLETION OF A PROJECT, ALL EXPOSED GROUND SURFACES THAT ARE NOT PAVED WITHIN THE CONTRACT LIMIT LINE, AND THAT ARE NOT COVERED BY LANDSCAPE PLANTING OR SEEDING AS SPECIFIED, SHALL BE COVERED BY A SHREDDED HARDWOOD BARK OR APPROVED EQUAL MULCH THAT	
<ul> <li>N. NEW PLANT MATERIAL SHALL BE GUARANTEED TO BE ALIVE AND IN OROROUS GROWING CONDITION FOR A PERIOD OF ONE YEAR FOLLOWING CACEPTANCE BY THE OWNER. PLANT MATERIAL FOUND TO BE UNHEALTHY, DYING OR DEAD DURING THIS PERIOD, SHALL BE REMOVED AND REPLACED IN KIND BY THE CONTRACTOR AT NO EXPENSE TO THE OWNER.</li> <li>MAINTENANCE</li> <li>DEBRIS, AND WEEDS. THE OBJECTIVE OF THIS SUBSECTION'S TALK IS TO PROVIDE A NEAT, ORDERLY, WELL-MAINTAINED APPEARANCE. ANY OBJECTS OR PLANTS WHICH CREATE A HEALTH OR SAFETY HAZARD OR AN UNNATURAL VISUAL NUISANCE SHALL BE REMOVED IMMEDIATELY.</li> <li>WULCHING, ALL PLANTING BEDS WITH EXISTING OR SPECIFIED ORGANIC MULCH SHALL BE MAINTAINED WITH A MINIMUM TWO-INCH DEPTH OF SHREIDED BARK MULCH OR AN EQUIVALENT. TO MAINTAIN THIS LEVEL, NEW MULCH SHALL BE APPLIED EACH SPRING AS NEEDED. ARE AS WITH DECORATIVE STONE OR OTHER MATERIALS SHALL BE MAINTAINED WITH A NEAT APPEARANCE AND AT SUCH A LEVEL THAT NO WEEDS, BARE GROUND OR SOIL ARE EXPOSED.</li> <li>PLANTINGS, LANDSCAPE MAINTENANCE SHALL INCLUEE THE RESEEDING OR REPLANTING OF LANDSCAPE AREAS WHICH ARE DAMAGED, DESTROYED, OR FAILING DUE TO INSECTS, DISEASE, WEATHER OR PHYSICAL DAMAGE. ALL LANDSCAPED AREAS WHICH ARE DAMAGED, DESTROYED OR ARE FAILING, AS DESCRIBED ABOVE, SHALL BE MAINTAINED WITH A NEAT APPEARANCE AND AT SUCH A LEVEL THAT NO SAVED FOR REPROVED EQUAL PROTECTION LENGT THROUGH WINITER WITH SPIRAL WRAP TREE GUARDS, OR APPROVED EQUAL PROTECTION LENGT THROUGH WINITER WITH SPIRAL WRAP TREE GUARDS, OR APPROVED EQUAL PROTECTION LENGT DER ROM BELOWT THE SURAL WRAP TREE GUARDS, OR APPROVED EQUAL PROTECTION LENGT THROUGH WINITER WITH SPIRAL WRAP TREE GUARDS, OR APPROVED EQUAL PROTECTION LENGT DE REPORTECTION ON SITE. IF DEEMED NECESSARY, SHADE AND ORNAMENTAL TREES SHALL BE PROTECTED THROUGH WINITER WITH SPIRAL WRAP TREE GUARDS, OR APPROVED EQUAL PROTECTION LENGT DE REPORTECTION DISTRICE THE STRING AND DOWN TO WITHIN A FEW INCHES OF THE GROUND. THE GUARDS CAN PAR TO FA MAINTENANCH AND DOWN TO WITHIN A FEW INCHES OF THE GROUND. THE</li></ul>		
<ul> <li>DEBRIS, AND WEEDS. THE OBJECTIVE OF THIS SUBSECTION'S TALK IS TO PROVIDE A NEAT, ORDERLY, WELL-MAINTAINED APPEARANCE. ANY OBJECTS OR PLANTS WHICH CREATE A HEALTH OR SAFETY HAZARD OR AN UNNATURAL VISUAL NUISANCE SHALL BE REMOVED IMMEDIATELY.</li> <li>2. MULCHING, ALL PLANTING BEDS WITH EXISTING OR SPECIFIED ORGANIC MULCH SHALL BE MAINTAINED WITH A MINIMUM TWO-INCH DEPTH OF SHREDDED BARK MULCH OR AN EQUIVALENT. TO MAINTAIN THIS LEVEL, NEW MULCH SHALL BE APPLIED EACH SPRING AS NEEDED. AREAS WITH DECORATIVE STONE OR OTHER MATERIALS SHALL BE APPLIED EACH SPRING AS NEEDED. AREAS WITH DECORATIVE STONE OR OTHER MATERIALS BE APPLIED EACH SPRING AS NEEDED. AREAS WITH DECORATIVE STONE OR OTHER MATERIALS BE APPLIED EACH SPRING AS NEEDED. AREAS WITH DECORATIVE STONE OR OTHER MATERIALS BALL BE MAINTAINED WITH A NEAT APPEARANCE AND AT SUCH A LEVEL THAT NO WEEDS, BARE GROUND OR SOIL ARE EXPOSED.</li> <li>3. PLANTINGS. LANDSCAPE MAINTENANCE SHALL INCLUDE THE RESEEDING OR REPLANTING OF LANDSCAPE AREAS WHICH ARE DAMAGED, DESTROYED OR ARE FAILING, AS DESCRIBED ABOVE, SHALL BE REPLACED DURING THE NEXT PLANTING SEASON.</li> <li>4. EXISTING AND PROPOSED PLANT MATERIAL SHALL BE MAINTAINED TO PROVIDE MINIMUM SIGHT DISTANCE THROUGHOUT THE SITE.</li> <li>5. CONTRACTOR SHALL ASSESS THE NEED FOR DEER PROTECTION ON SITE. IF DEEMED NECESSARY, SHADE AND ORNAMENTAL TREES SHALL BE PROTECTED THROUGH WINTER WITH SPIRAL WRAP TREE GUARDS, OR APPROVED EQUAL, PROTECTION LENGTH TO BE FROM BELOW THE LOWEST BRANCH AND DOWN TO WITHIN A FEW INCHES OF THE GROUND. THE GUARDS CAN BE REMOVED IN SPRING AND SAVED FOR RE-INSTALLATION DURING THE FOLLOWING WINTERS AS PART OF A MAINTEMANCE</li> </ul>	FOR A PERIOD OF ONE YEAR FOLLOWING ACCEPTANCE BY THE OWNER. PLANT MATERIAL FOUND TO BE UNHEALTHY, DYING OR DEAD DURING THIS PERIOD, SHALL BE REMOVED AND REPLACED IN KIND BY THE CONTRACTOR AT NO EXPENSE TO THE OWNER.	
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	DISTANCE THROUGHOUT THE SITE. 5. CONTRACTOR SHALL ASSESS THE NEED FOR DEER PROTECTION ON SITE. IF DEEMED NECESSARY, SHADE AND ORNAMENTAL TREES SHALL BE PROTECTED THROUGH WINTER WITH SPIRAL WRAP TREE GUARDS, OR APPROVED EQUAL. PROTECTION LENGTH TO BE FROM BELOW THE LOWEST BRANCH AND DOWN TO WITHIN A FEW INCHES OF THE GROUND. THE GUARDS CAN BE REMOVED IN SPRING AND SAVED FOR RE-INSTALLATION DURING THE FOLLOWING WINTERS AS PART OF A MAINTENANCE	5 TREE PIT AND TH



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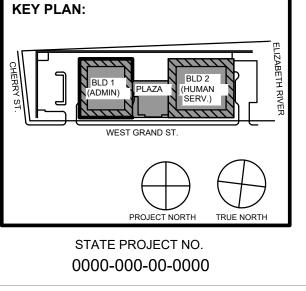
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Client:
UNION COUNTY IMPROVEMENT AUTHORITY
Project:
COMPLEX 81 & 93 WEST GRAND STREET CITY OF ELIZABETH NEW JERSEY, 07202 Drawing Information:
Project No: 20.072 Date: 11.08.2023 Drawn By: WS Checked By: KBS
Sheet Name:
LANDSCAPE PLANTING NOTES AND DETAILS
LP501

### Jeffrey D. Venezia, AIA NJ RÁ AI 00827100


Revisions / Issues

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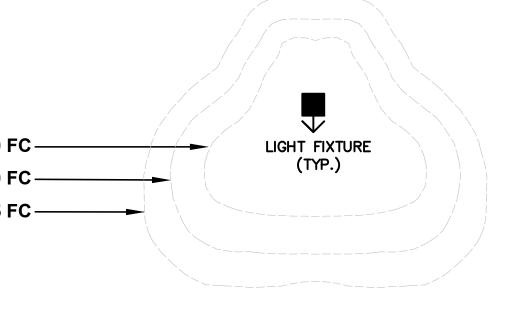
<u>RENCE NOTES:</u> EXISTING TOPOGRAPHIC INFORMATION OBTAINED FROM A PLAN TITLED "BOUNDARY TOPOGRAPHIC & UTILITY SURVEY" PREPARED BY LANGAN ENGINEERING AND ENVIRONMENTAL SERVICES, INC. DATED 31 AUGUST 2021. PROPOSED BUILDING INFORMATION OBTAINED ELECTRONICALLY FROM RSC ARCHITECTS ON 14 DECEMBER 2021.

SEE SHEET LL-501 FOR LIGHTING NOTES AND DETAILS

Max	Min	Avg/Min	Max/Min
1.1	0.0	N.A.	N.A.
10.6	0.3	10.80	35.33

	ССТ	Lum. Lumens	LLF	Lum. Watts	Pole / Bracket	Mounting AFG (FT)
-VOLTS-DIM-30-70CRI-	4000	16812	0.880	160	2250/50505S4/1A/COLOR/R56 ON 2.5' CC	25
256					PIER	
-VOLTS-DIM-30-70CRI-	3000	15336	0.880	160	2250/50505S4/1A/COLOR/R56 ON 2.5' CC	25
256					PIER	
UNV COLOR R56	3000	689	0.880	12	BOLLARD @ 3.5' AFF	3.5
FL VOLTS FSD 1 COLOR	3000	1744	0.880	18.8	RECESSED IN CANOPY	12

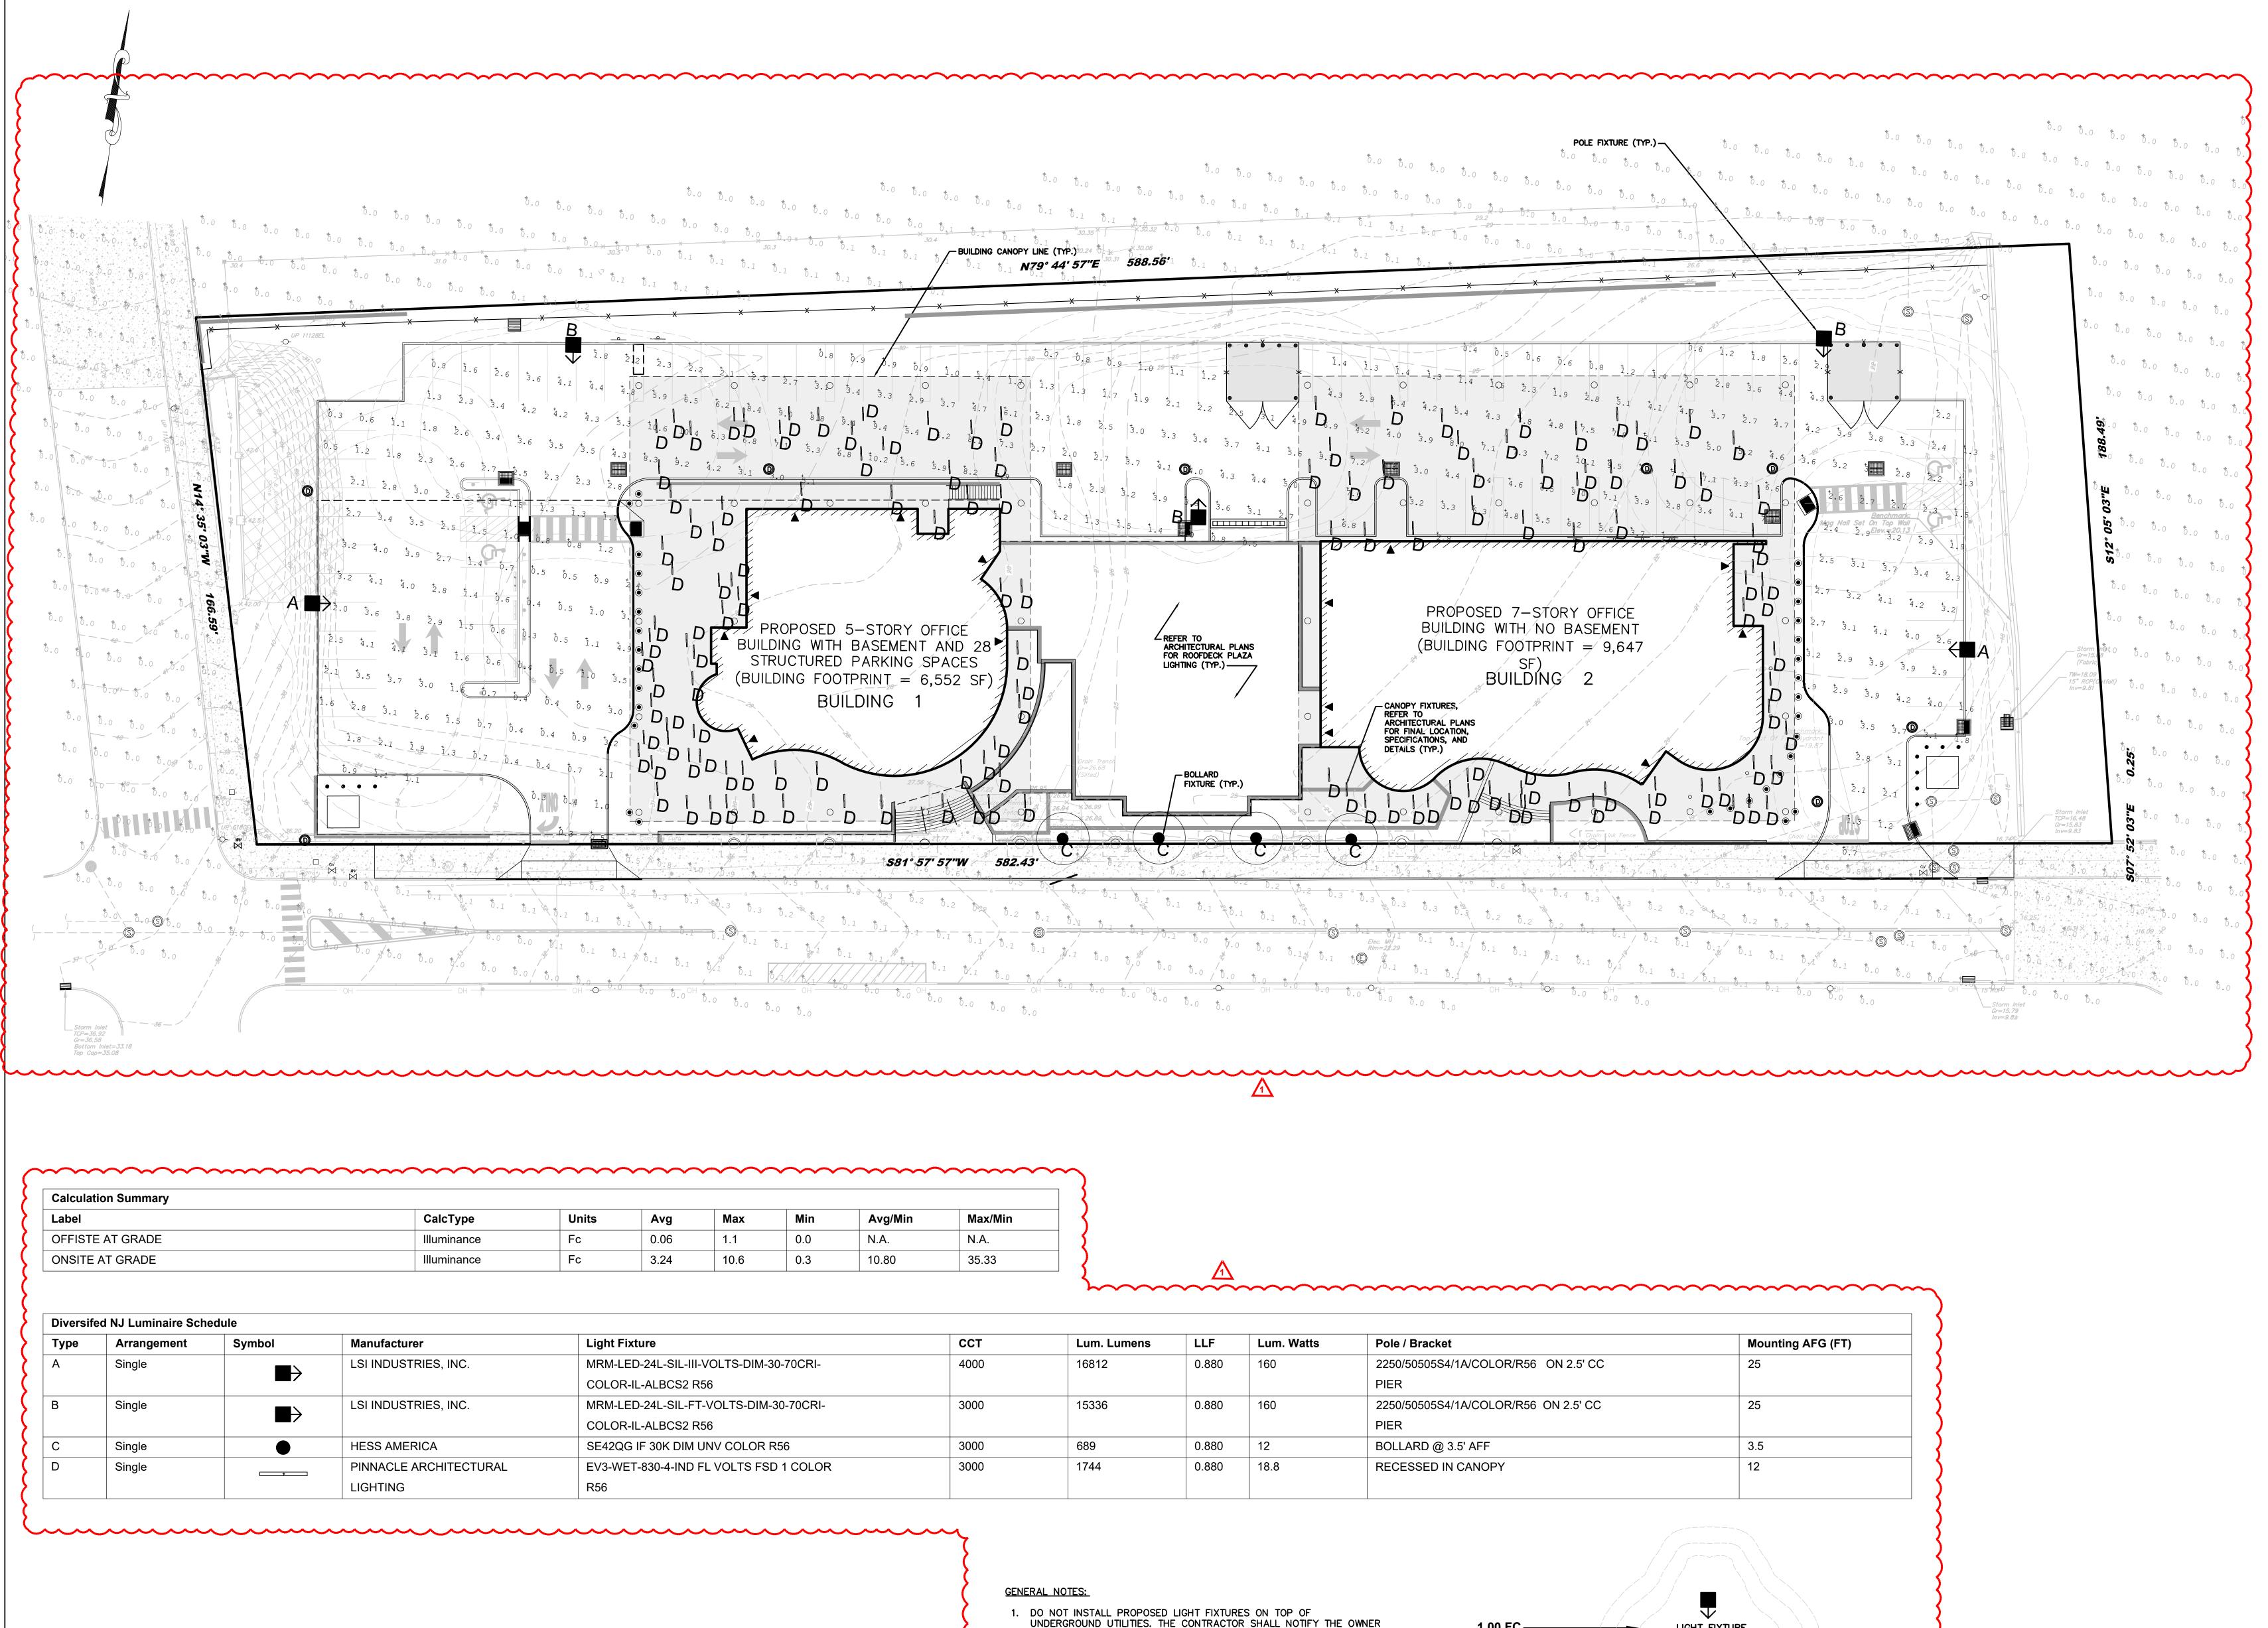ζ	
<u>GENERAL_NOTES:</u>	
1. DO NOT INSTALL PROPOSED LIGHT FIXTURES ON TOP OF UNDERGROUND UTILITIES. THE CONTRACTOR SHALL NOTIFY THE OWNER AND PROJECT PROFESSIONAL OF ANY CONFLICTS PRIOR TO THE INSTALLATION OF THE LIGHT FIXTURES.	1.00 F0 0.50 F0
2. ANY ADJUSTMENTS MADE TO LIGHT FIXTURES SHALL BE REVIEWED AND APPROVED BY THE OWNER PRIOR TO PURCHASING OF ANY MATERIALS.	0.25 FC
3. ALL PARKING LOT FIXTURES SHALL BE INSTALLED A MINIMUM OF 3'-0" FROM THE BACK OF THE CURB TO THE FACE OF THE FOOTING.	



**TYPICAL LIGHTING FOOTCANDLES VALUES** NOT TO SCALE

0 20 40 SCALE IN FEET 1"=20'

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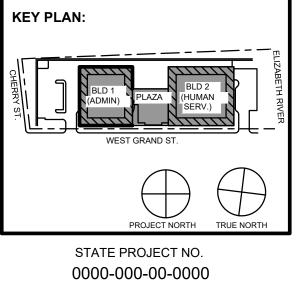
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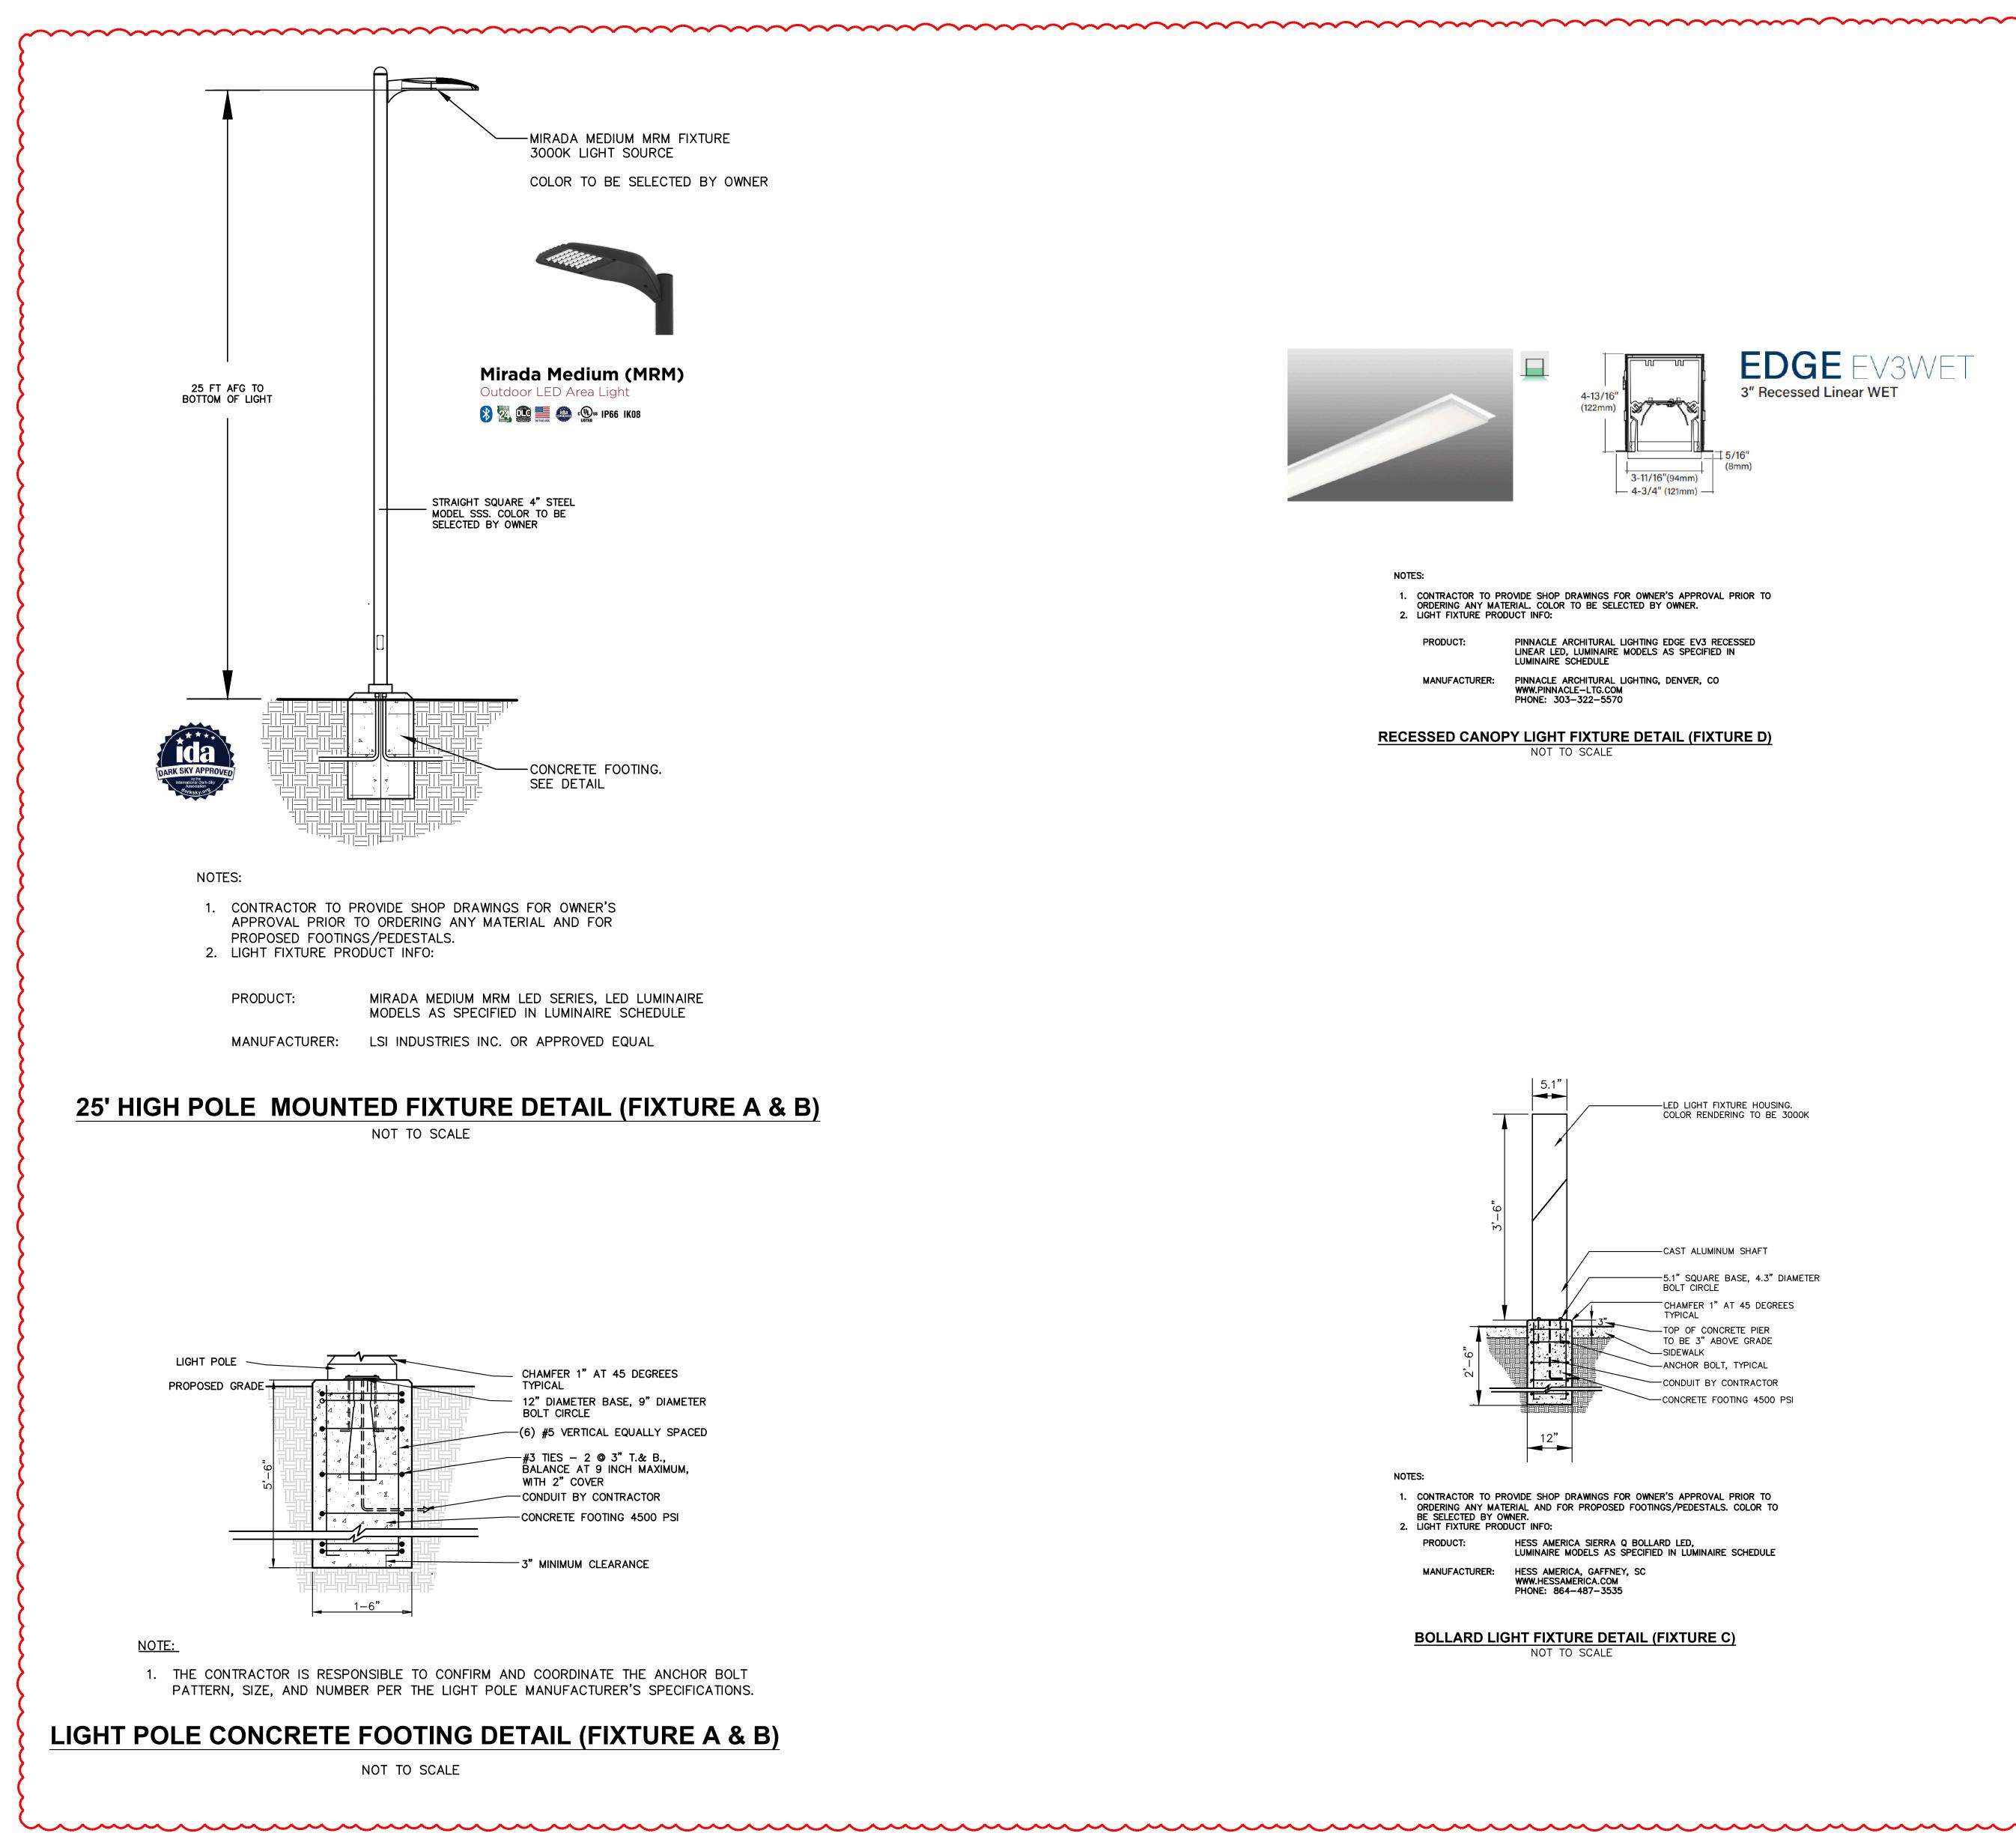
No. Date Description

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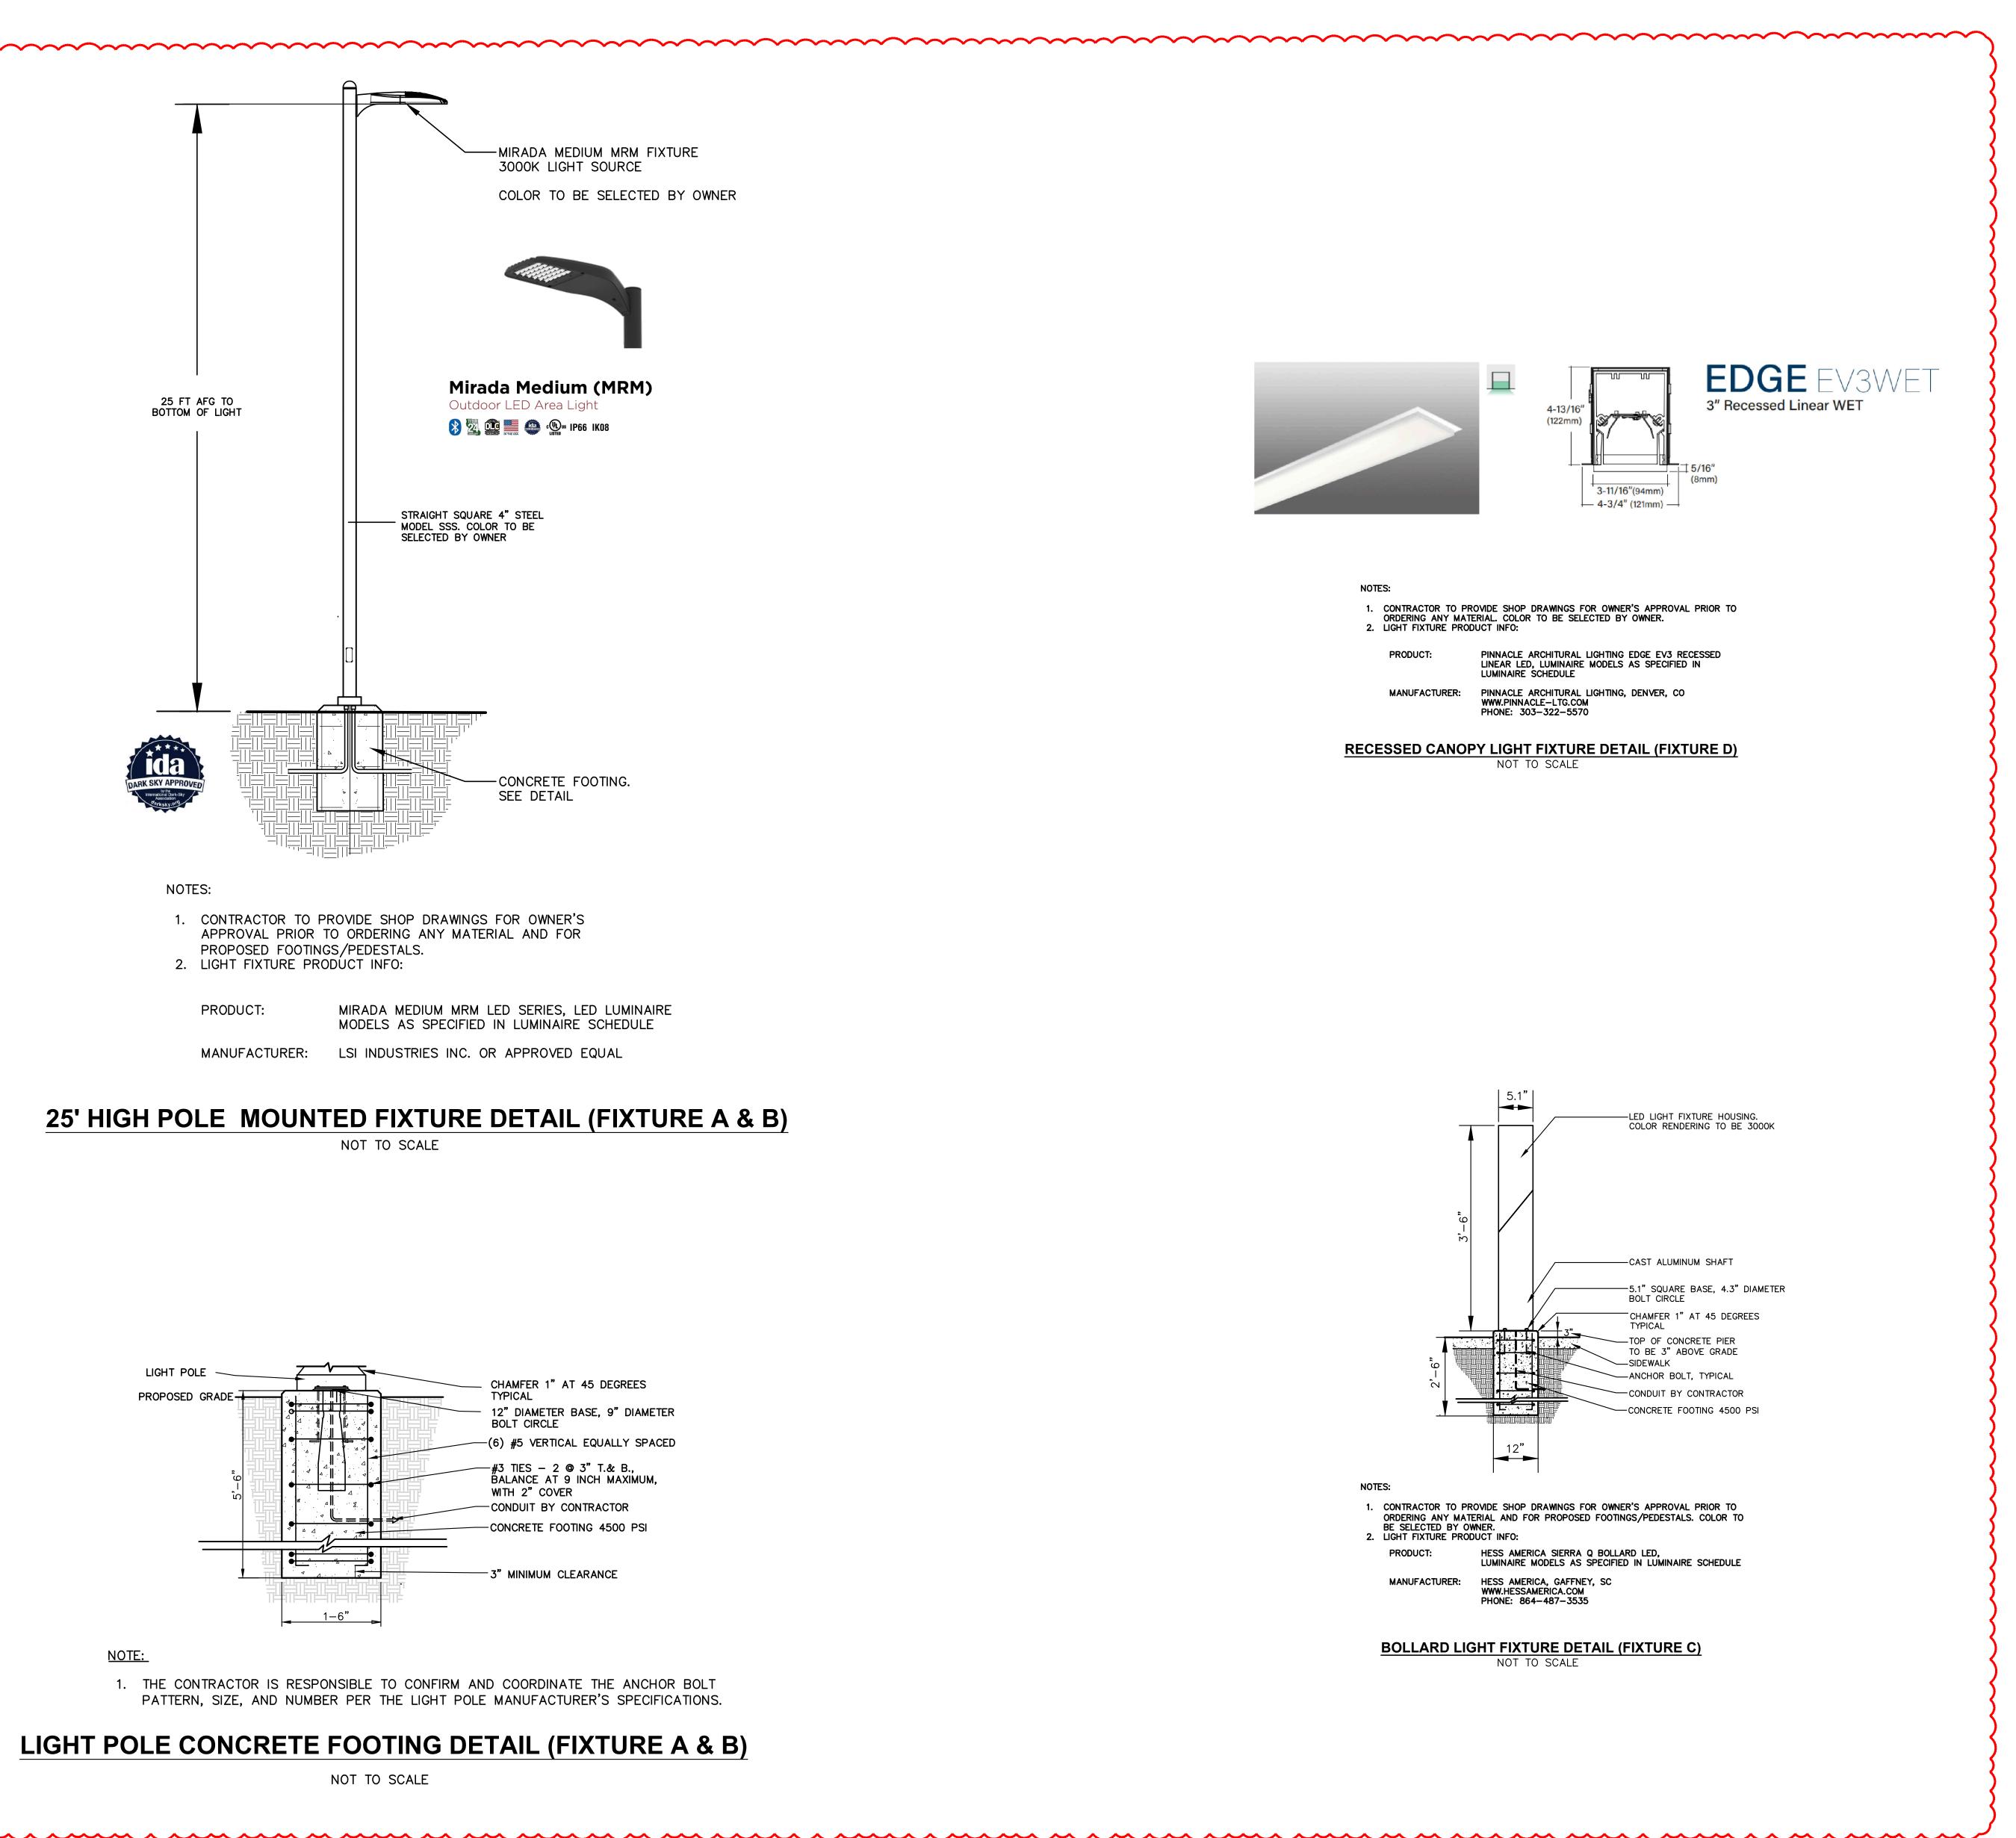


-MIRADA MEDIUM MRM FIXTURE 3000K LIGHT SOURCE COLOR TO BE SELECTED BY OWNER



Mirada Medium (MRM)

CHAMFER 1" AT 45 DEGREES 12" DIAMETER BASE, 9" DIAMETER -(6) #5 VERTICAL EQUALLY SPACED -CONCRETE FOOTING 4500 PSI



**LL501** 


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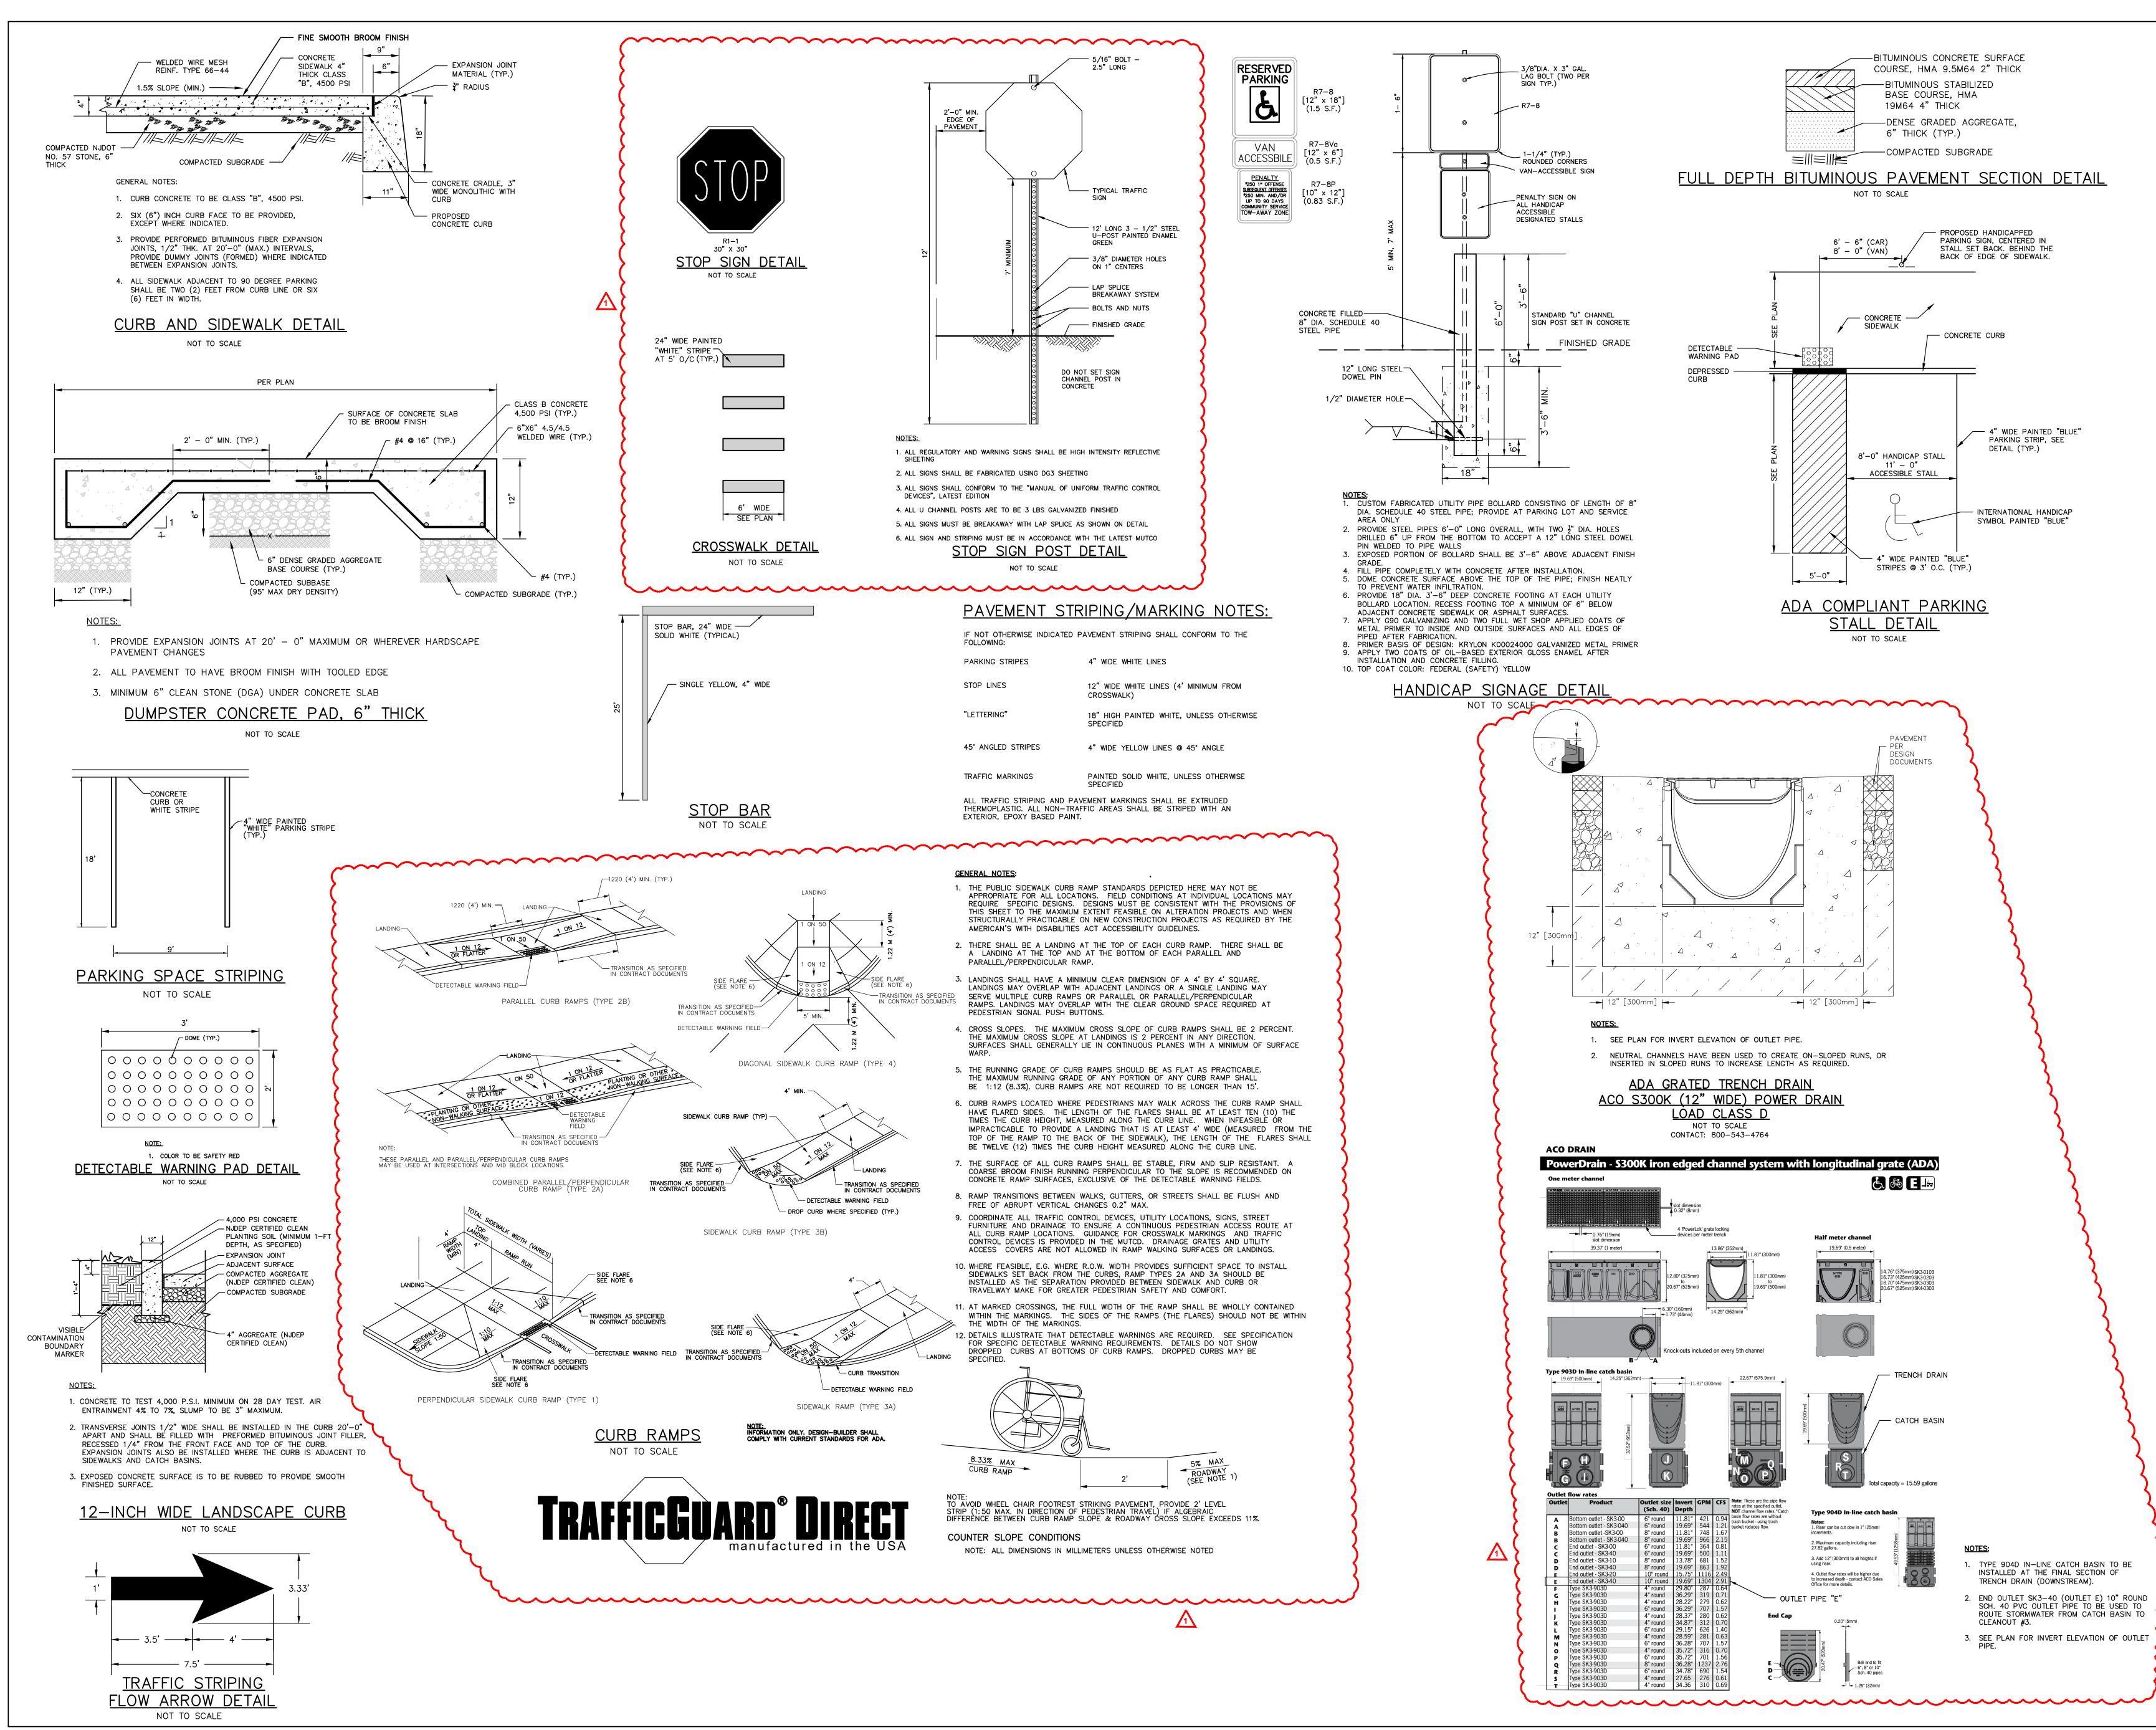
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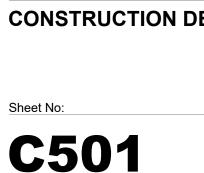
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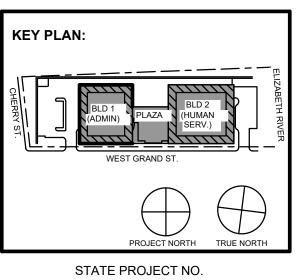
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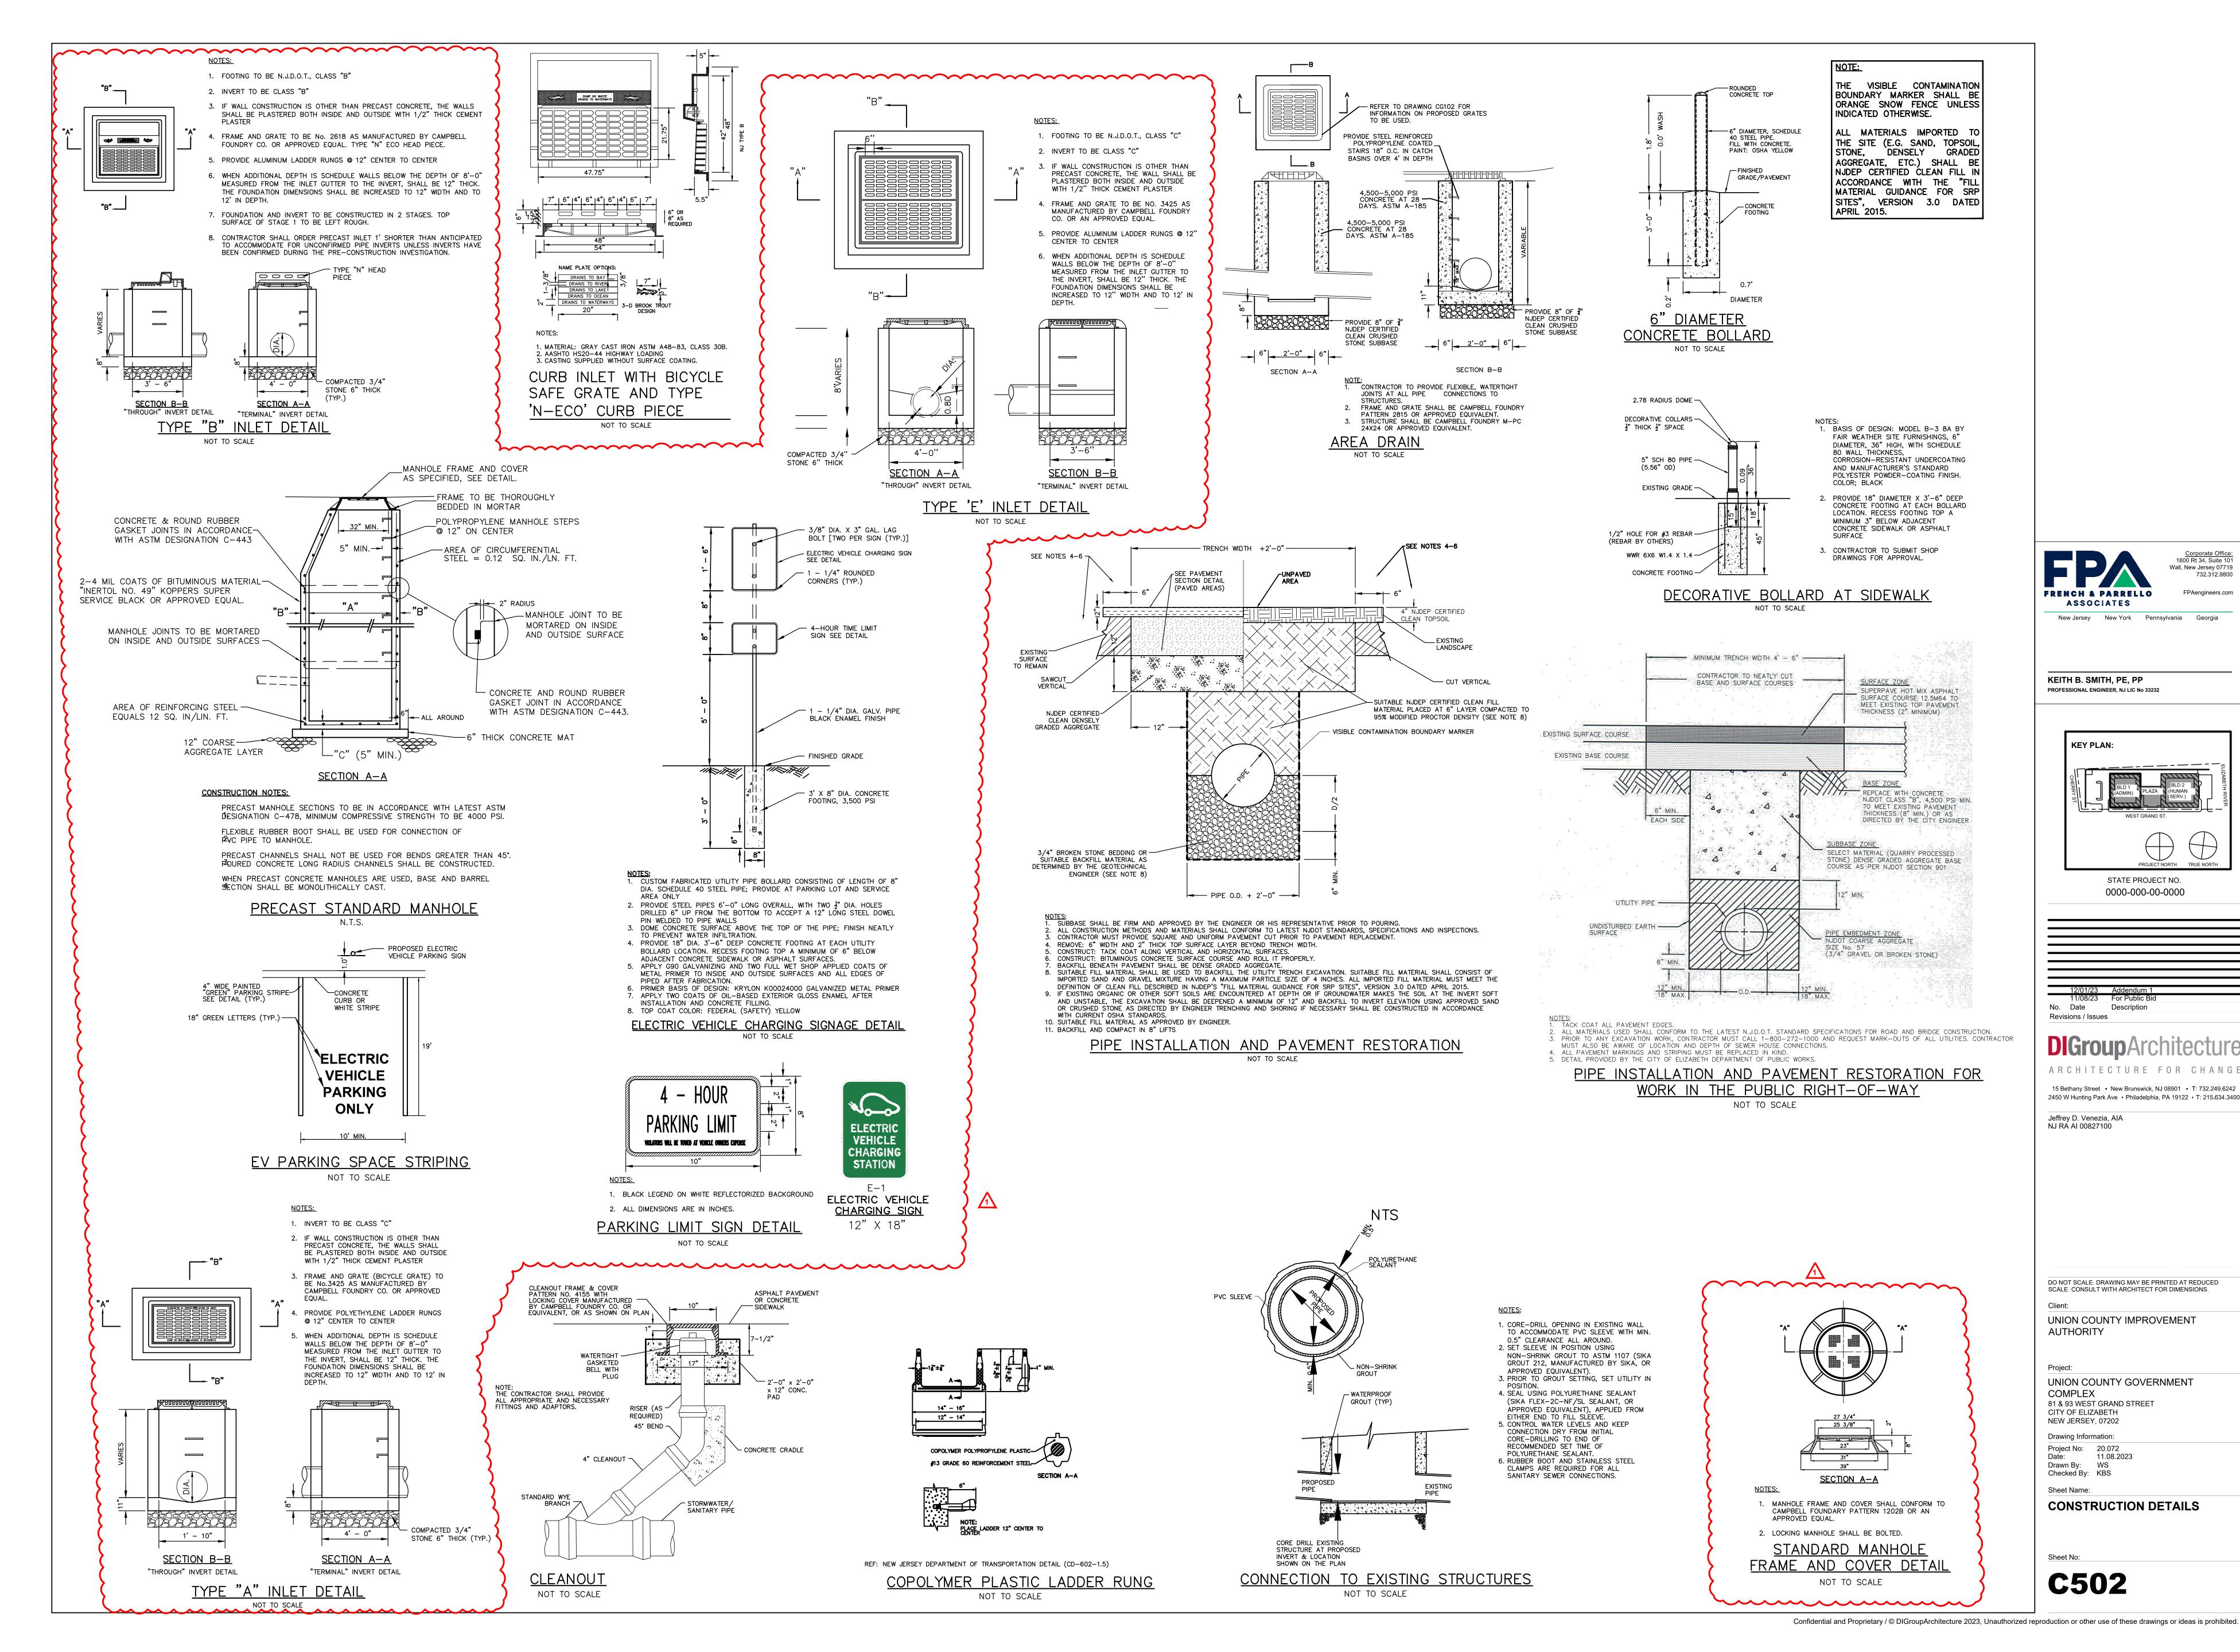
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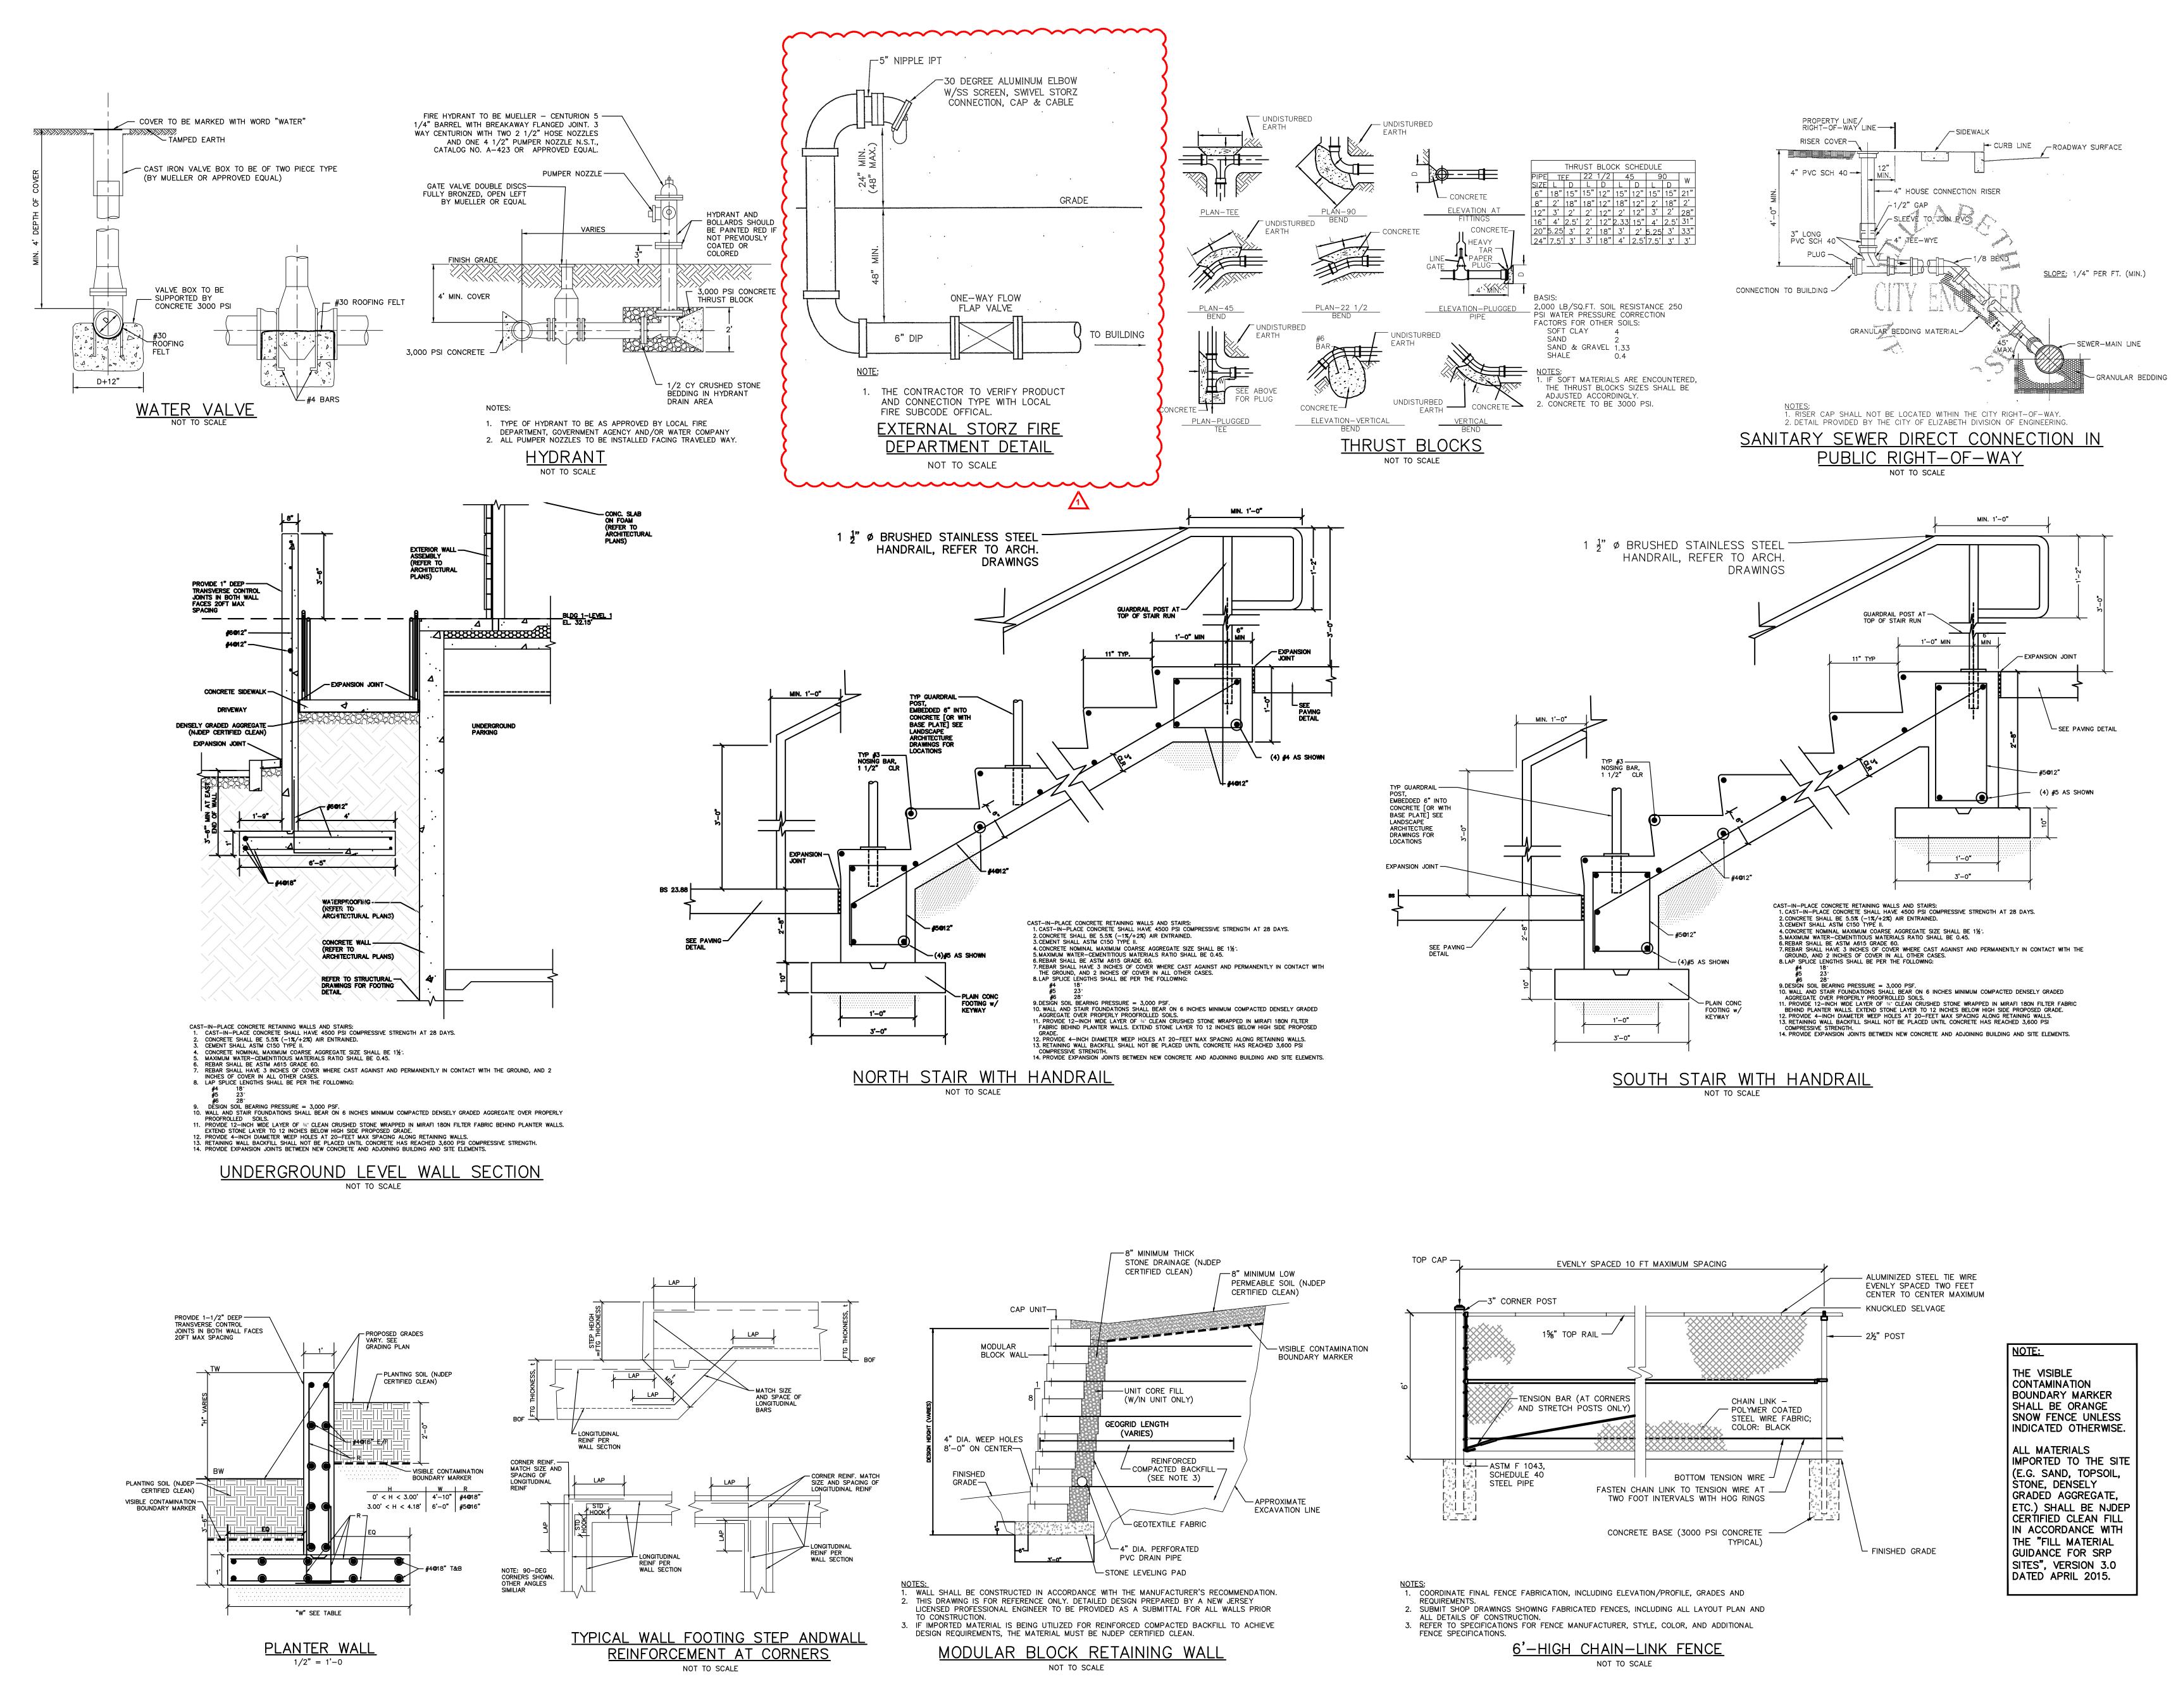
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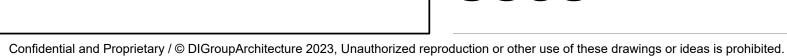
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KEITH B. SMITH, PE, PP PROFESSIONAL ENGINEER, NJ LIC No 33232







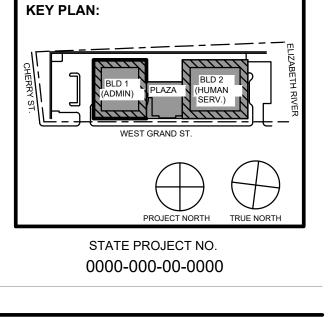

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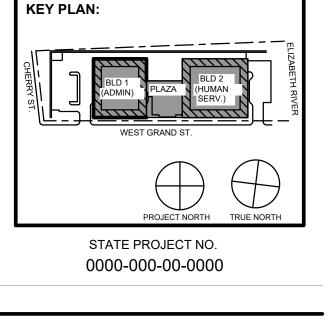
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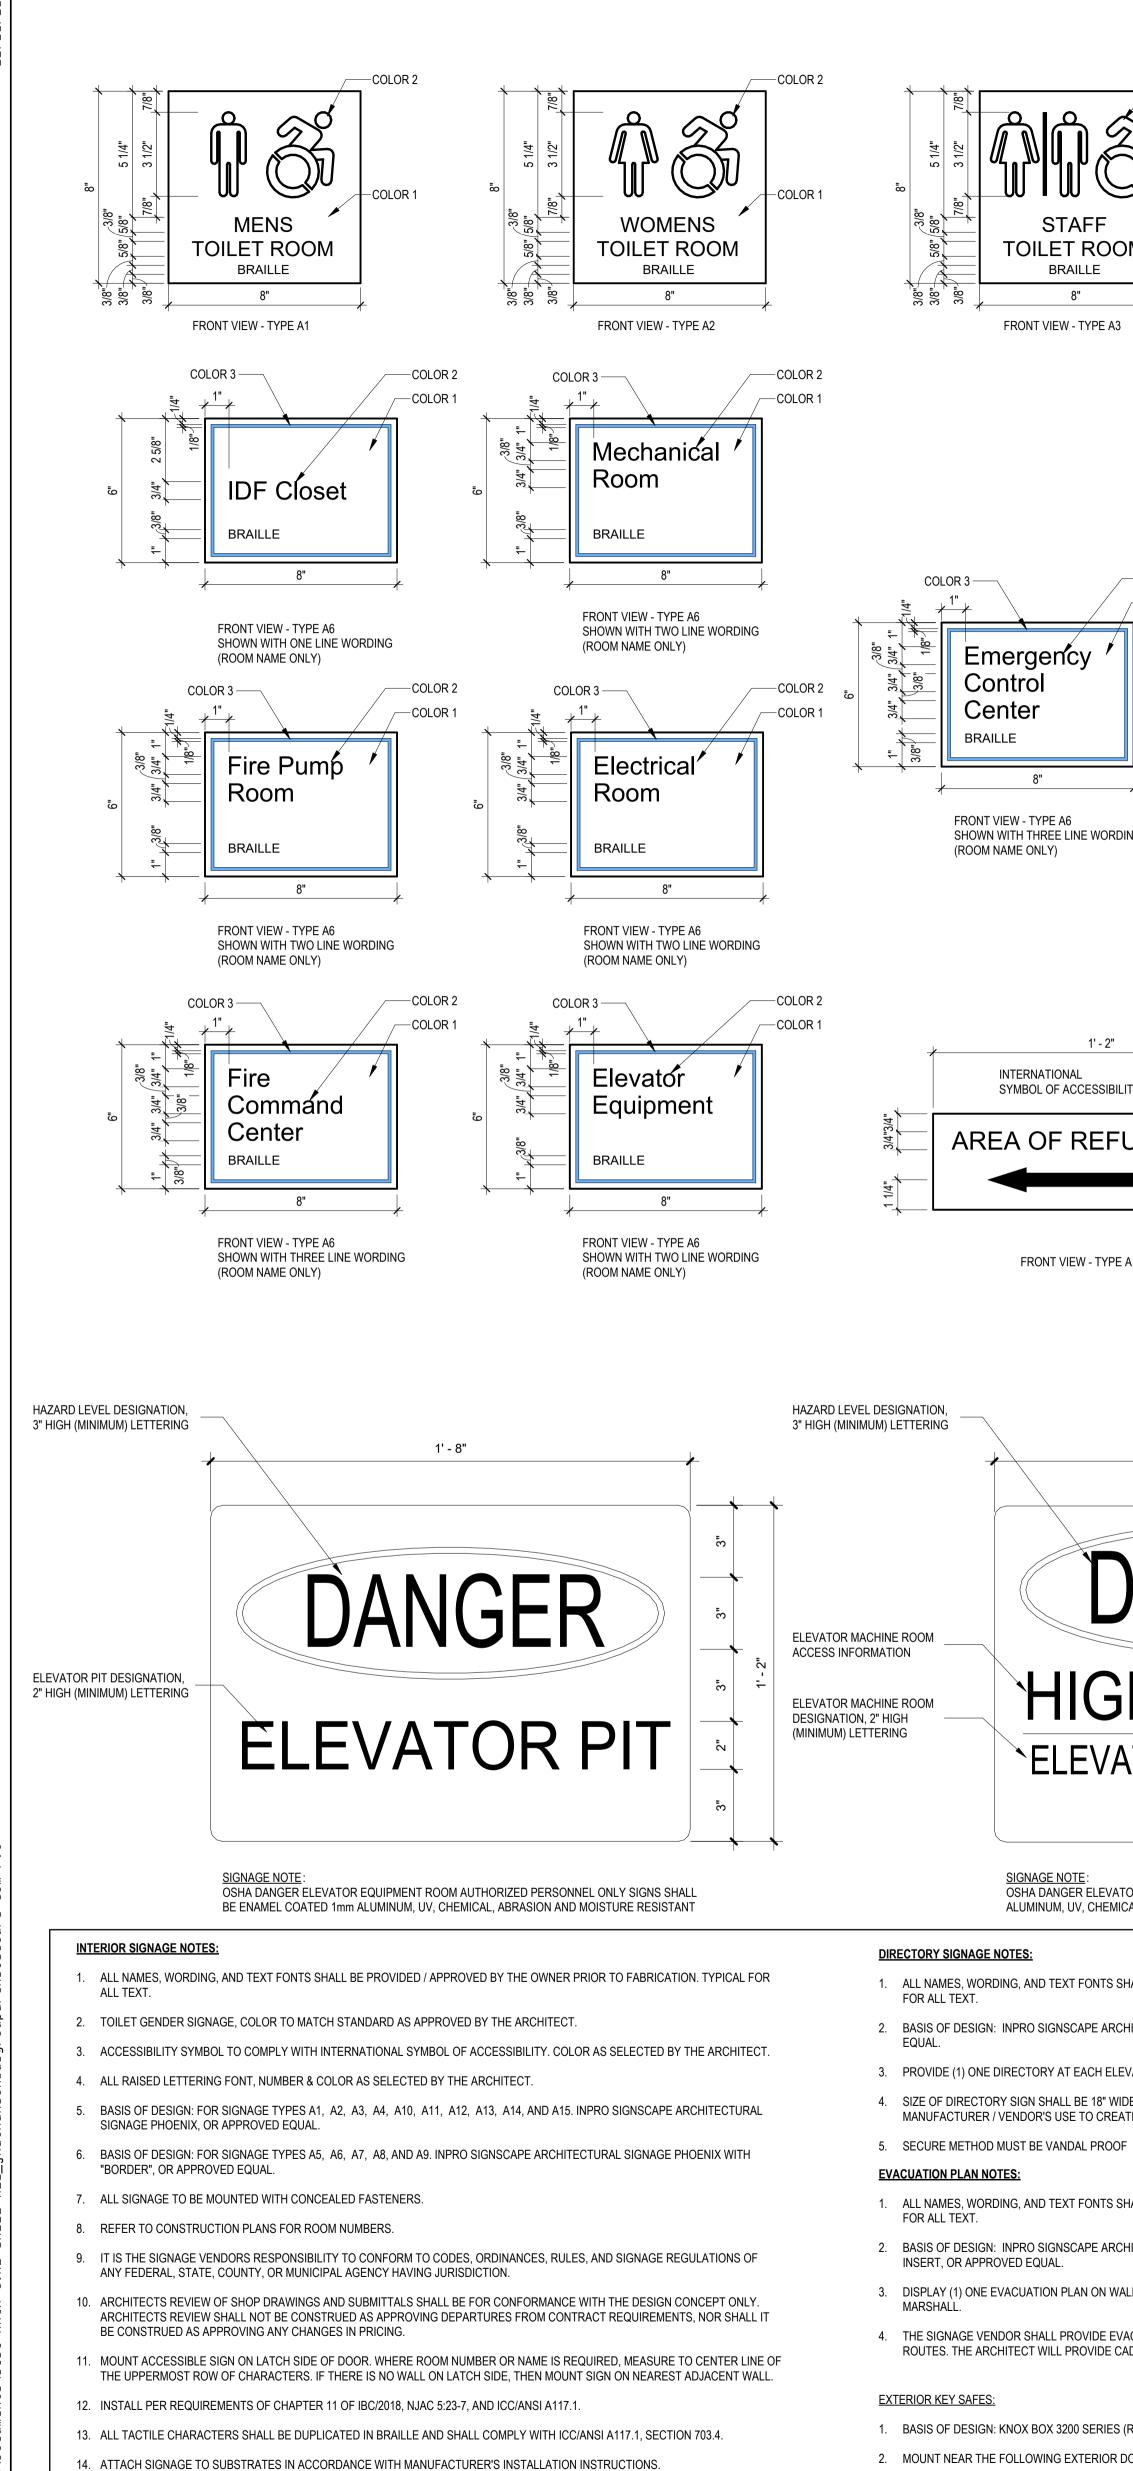
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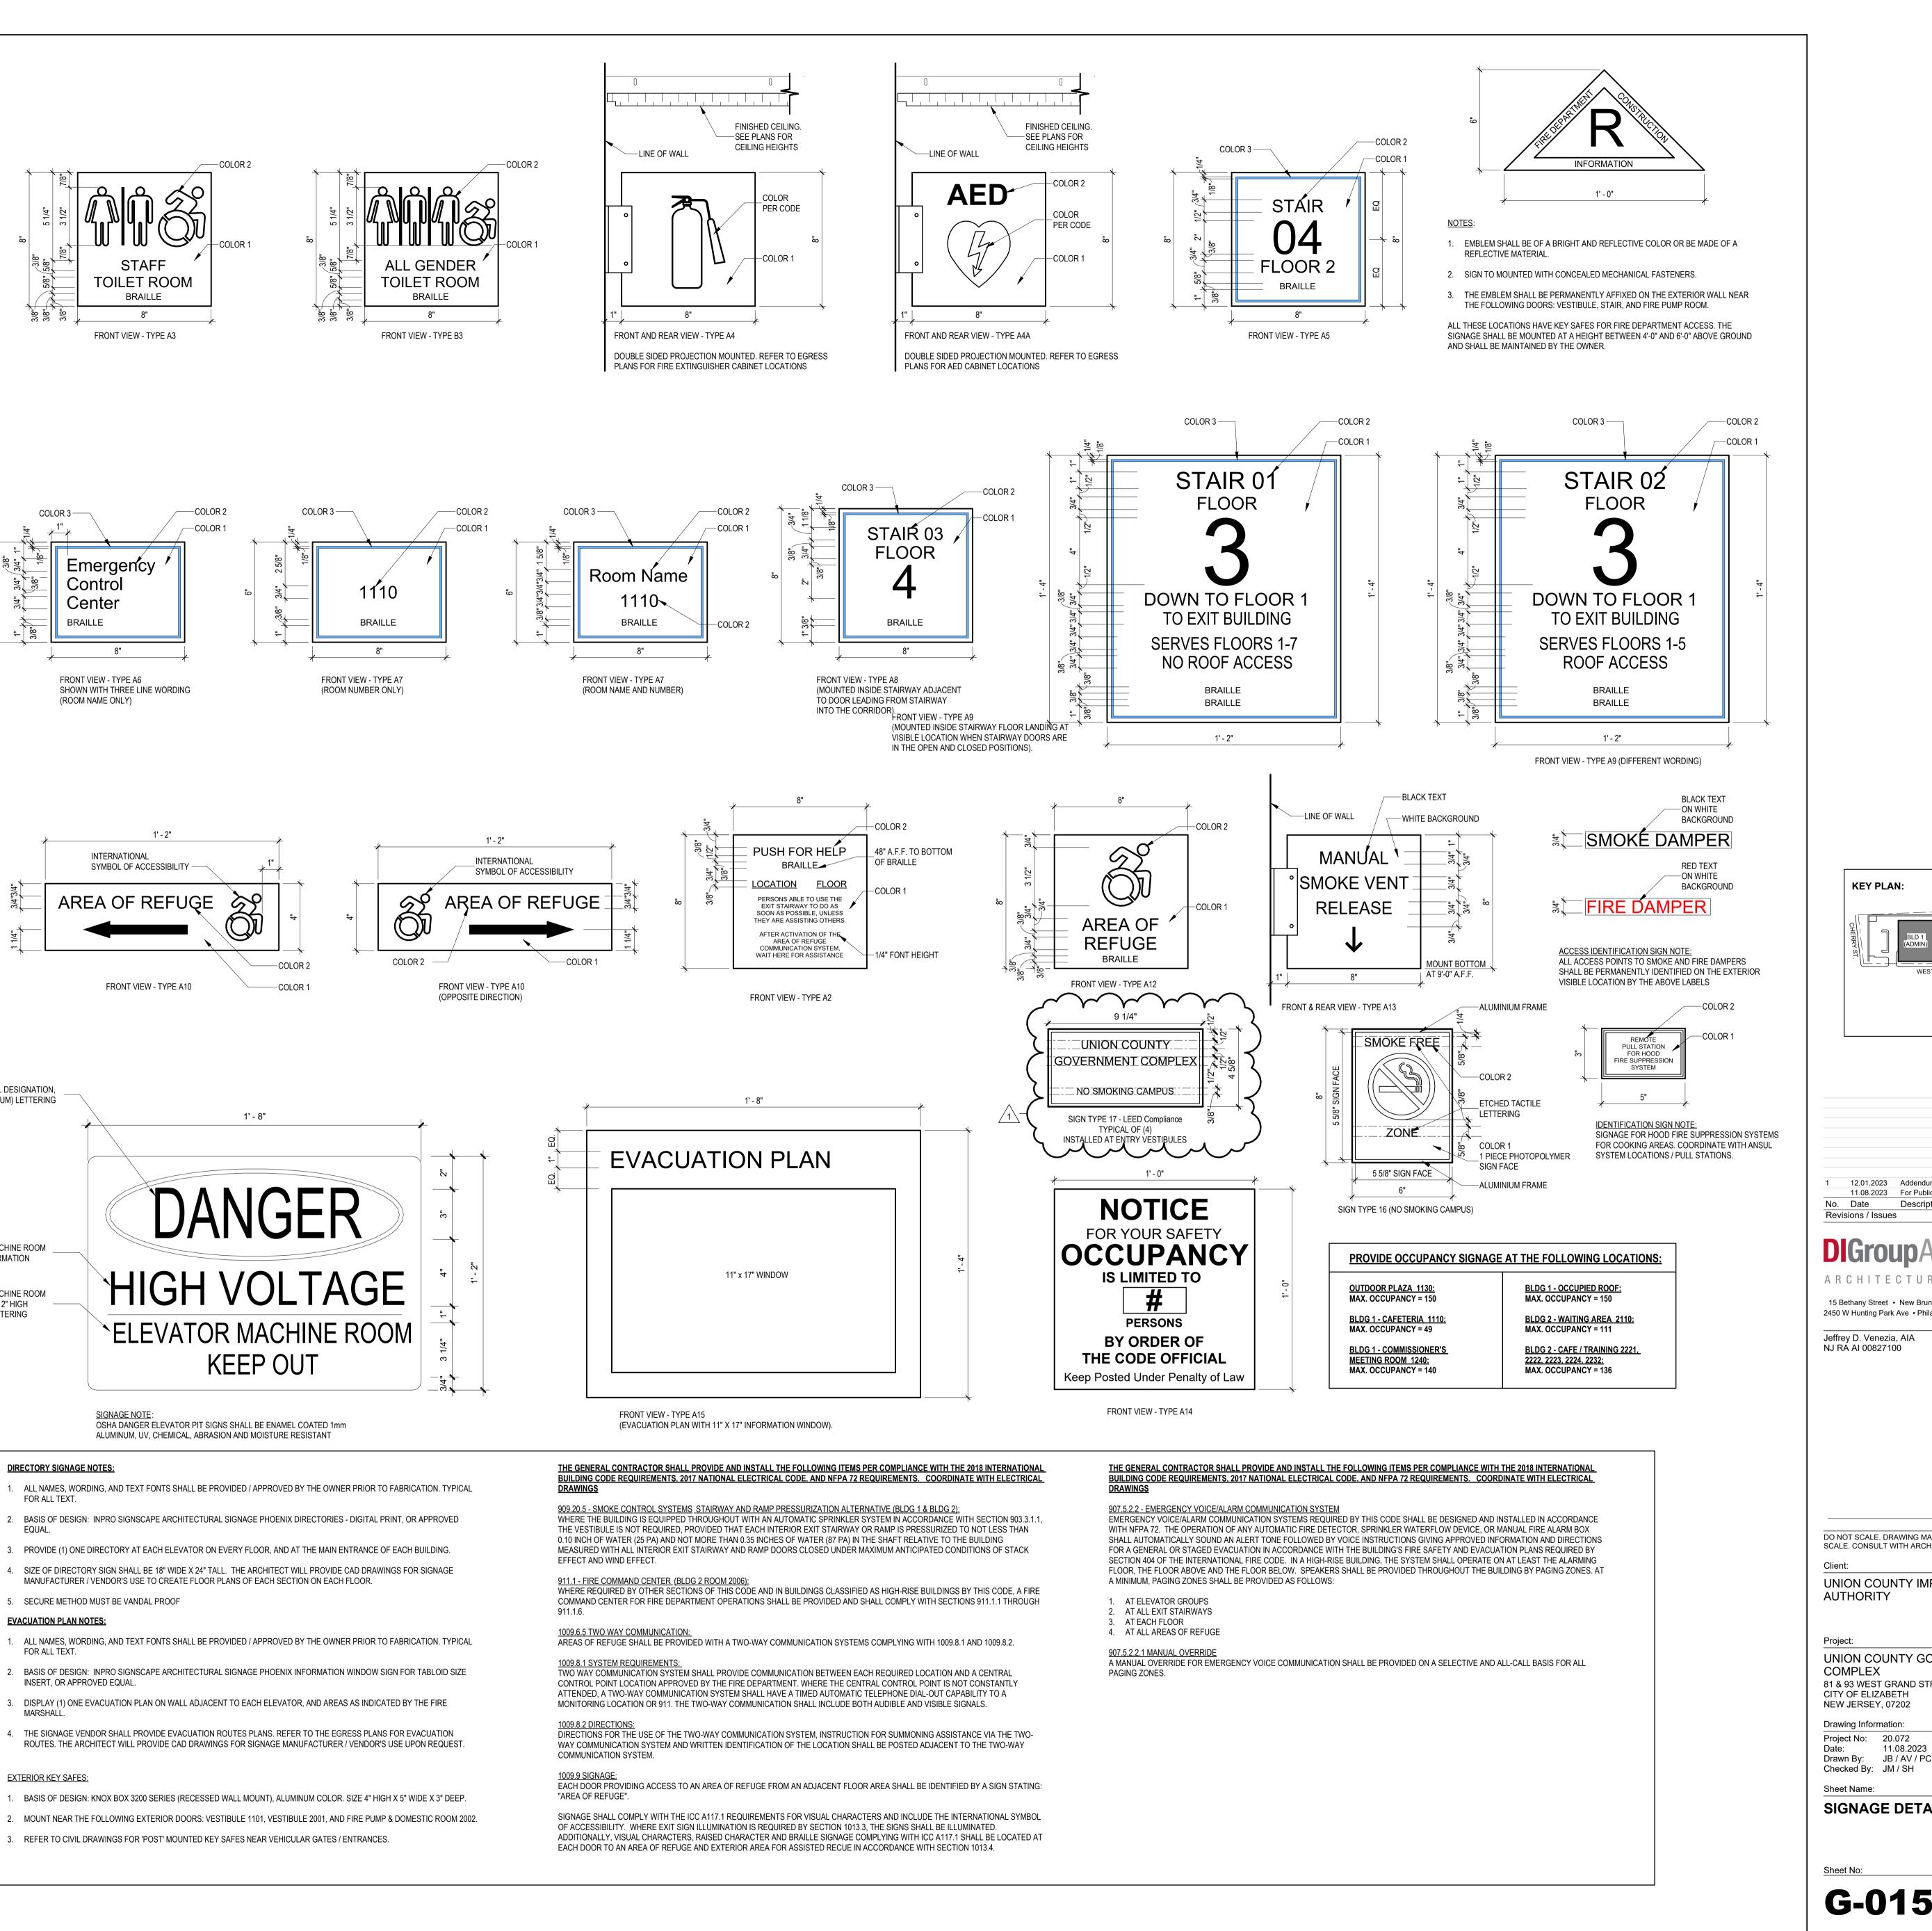




15. PROVIDE AND INSTALL SIGNAGE AT ALL LIFE SAFETY LOCATIONS INCLUDING STAIR TOWER LOCATIONS, ELEVATOR VESTIBULES, AREAS OF REFUGE, AND ANY OTHER AREAS THAT MAY BE REQUIRED BY CODE. IN ADDITION, PROVIDE "EVACUATION FLOOR PLAN" TYPE SIGNAGE AT ALL FLOORS

| SIGNAGE DETAILS

SCALE: 3" = 1'-0"



oducti	on or	other (	use of	these	drawings	or	ideas	is p	rohibit	ted.

	E. DRAWING MAY BE PRINTED AT REDUCED ILT WITH ARCHITECT FOR DIMENSIONS.
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Description



## **GENERAL NOTES:**

A. SEE DRAWINGS A-538 AND A-539 FOR ALL OUTDOOR PLAZA DETAILS


B. SEE CS-300 SERIES DRAWINGS FOR ALL SLAB EDGE PLANS

C. SEE CS-315 FOR WATERPROOFING PLANS

D. SEE SPECIFICATIONS SECTIONS 075323 FOR CONCRETE PAVER SYSTEM

E. PROVIDE "STYROFOAM HIGHLOAD" EXTRUDED POLYSTYRENE (XPS) FOAM INSULATION WITH A COMPRESSIVE STRENGTH OF 40 PSI AT GENERAL CONCREETE FLOOR SLAB INFILL. SEE SPECIFICATION SECTION 072100 THERMAL INSULATION

F. PROVIDE "STYROFOAM PLAZAMATE" EXTRUDED POLYSTYRENE (XPS) FOAM INSULATION WITH A COMPRESSIVE STRENGTH OF 60 PSI AT GARAGE AREA CONCRETE FLOOR SLAB INFILL AND FOR INSTALLATIN ABOVE WATERPROOFING MEMBRANE AT OUTDOOR PLAZA DECK, SEE SPECIFICATION SECTION 07211 THERMAL INSULATION.

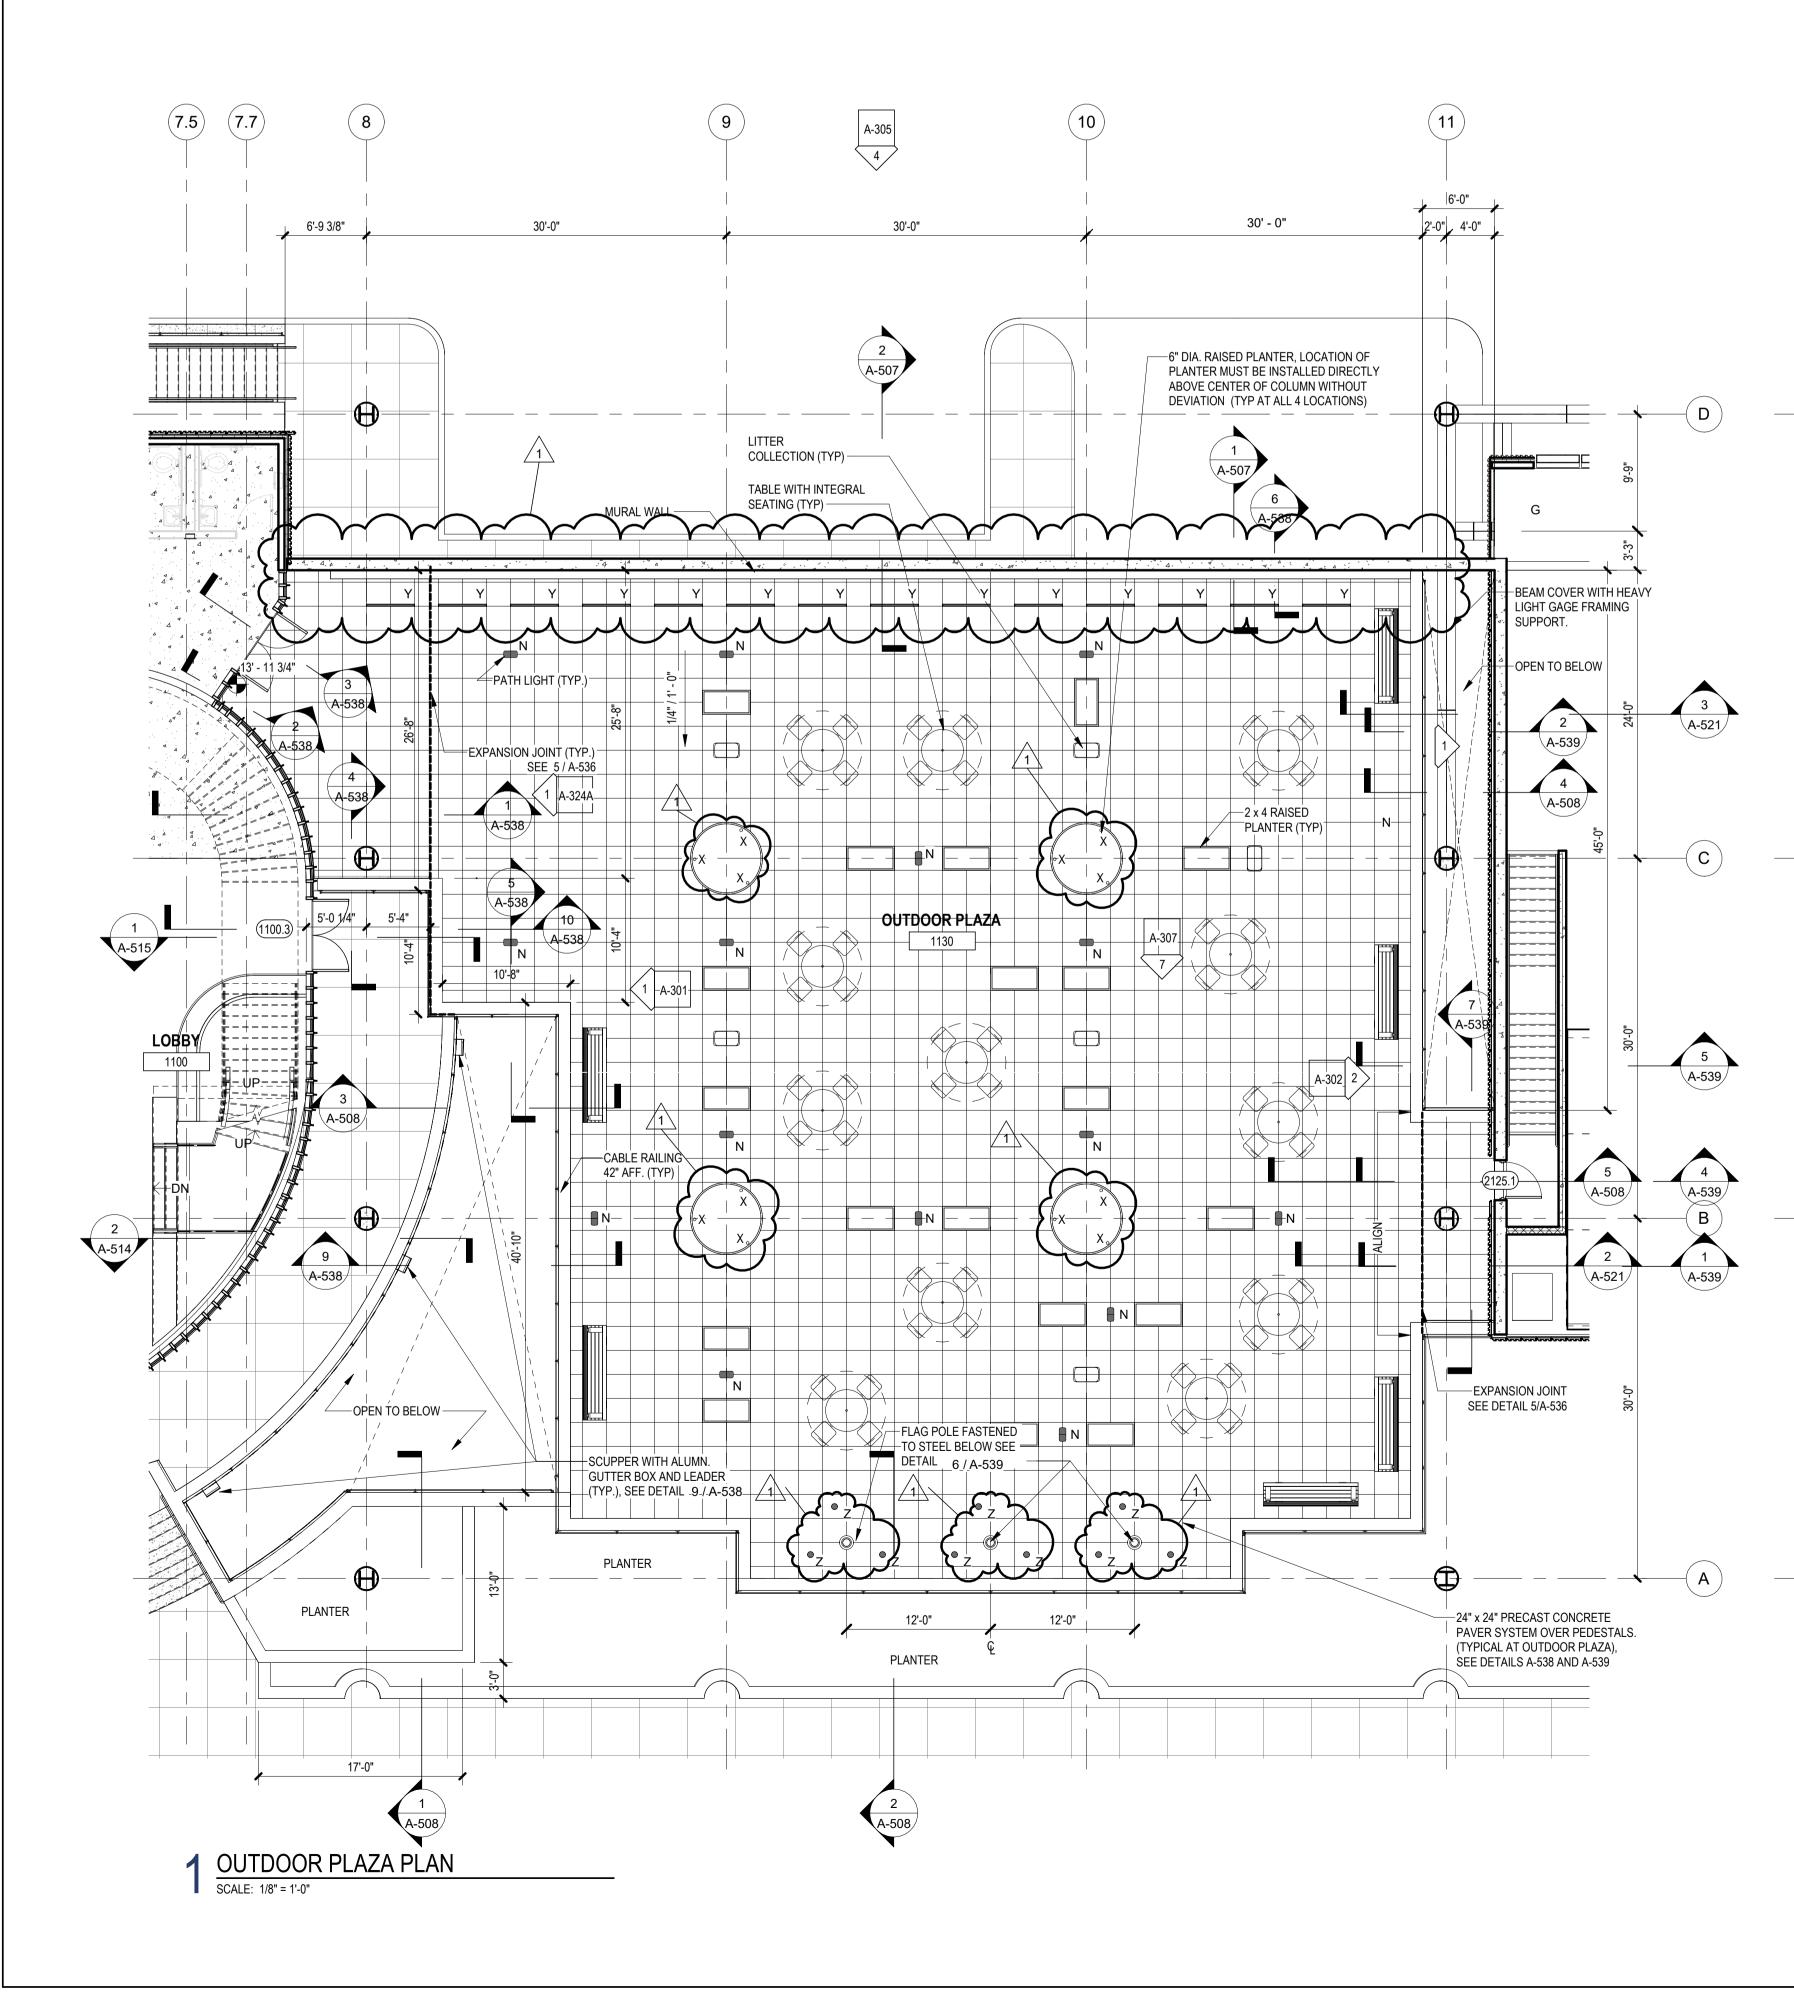

OUTDOOR FURNITURE NOTES:


BASIS OF DESIGN NOTES:

OUTDOOR FURNISHINGS BY LANDSCAPEFORMS TABLES WITH INTEGRAL SEATING: 42" "CAROUSEL" DINING BACKED - TYPICAL OF (12)

UMBRELLA: 79" X 79" "SHADE" - TYPICAL OF (12) (1 @ EA. TABLE) BENCHES: 24" X 95" 33" "STAY" BACKED WITH ARMS TYPICAL OF (6)

LITTER COLLECTION: "MULTIPLICITY" DOUBLE EMBED - TYPICAL OF (6) PATH LIGHT: "MULTIPLICITY" PATH LIGHT - TYPICAL OF (16)

OUTDOOR FURNISHINGS BY BISON INNOVATIVE PRODUCTS PLANTERS: 24" X 48" "IPE WOOD CUBE" - TYPICAL OF (21)

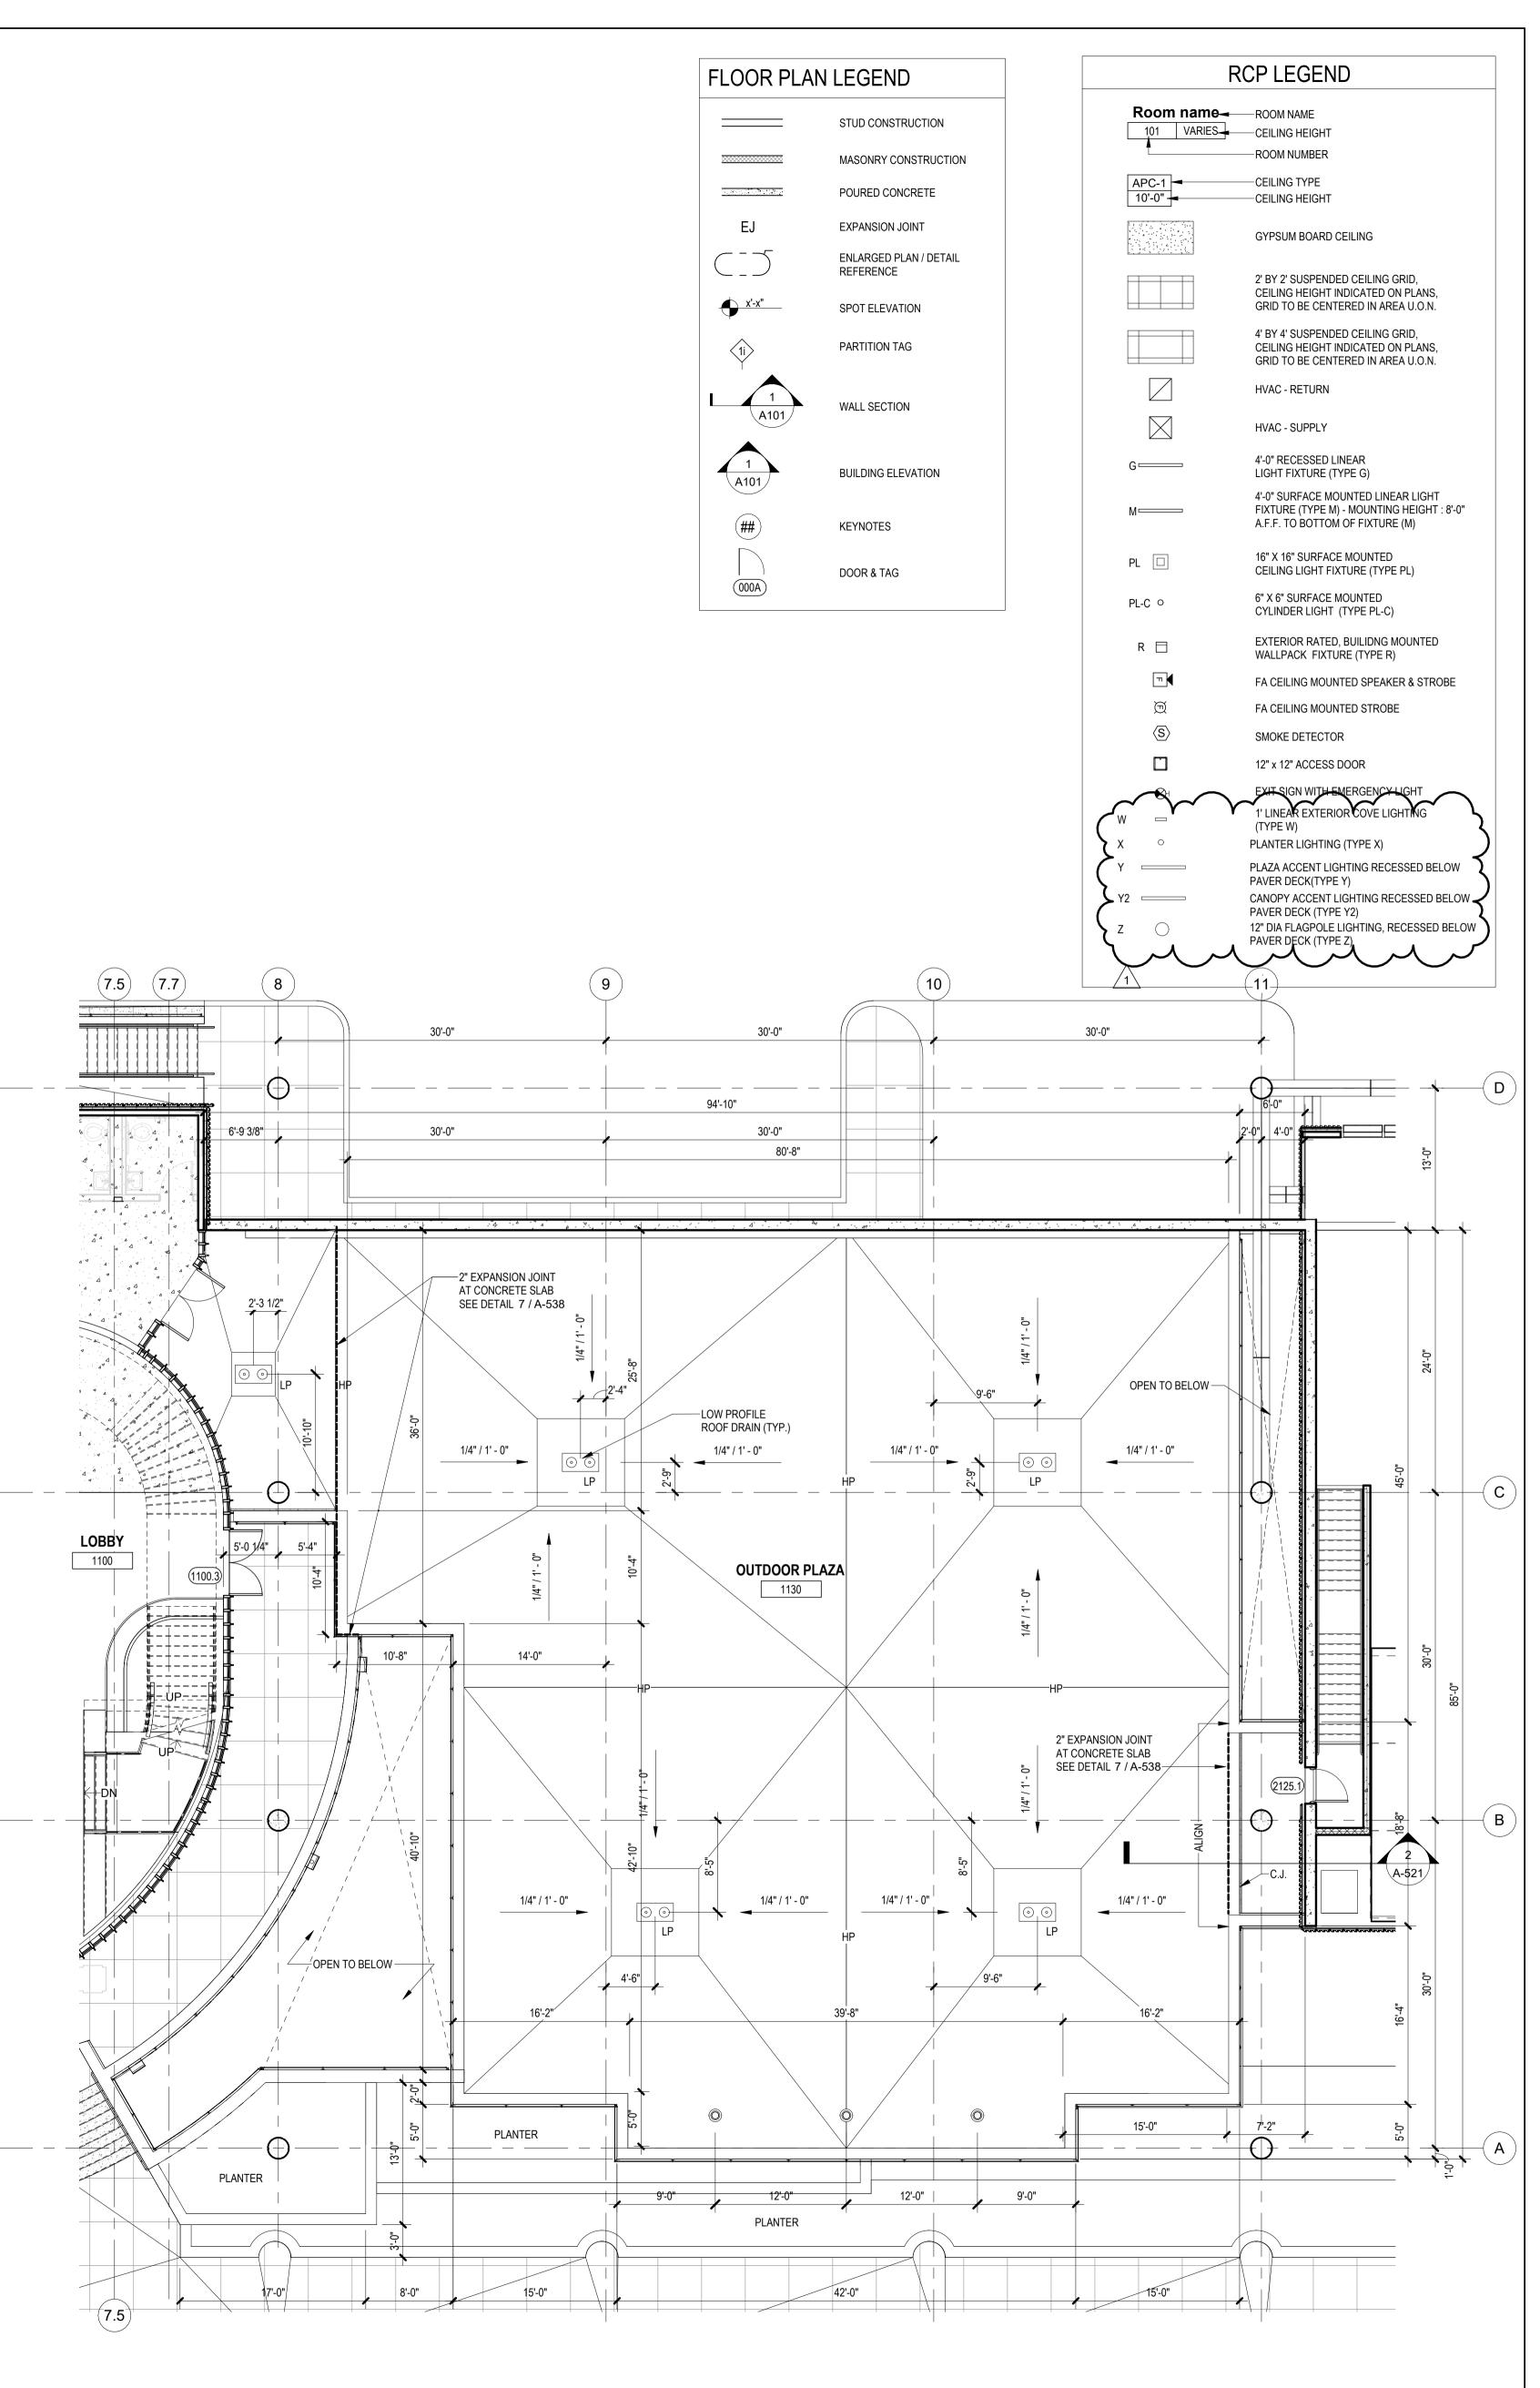

2 OUTDOOR PLAZA DRAINAGE PLAN SCALE: 1/8" = 1'-0"

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# Jeffrey D. Venezia, AIA NJ RA AI 00827100

No. Date


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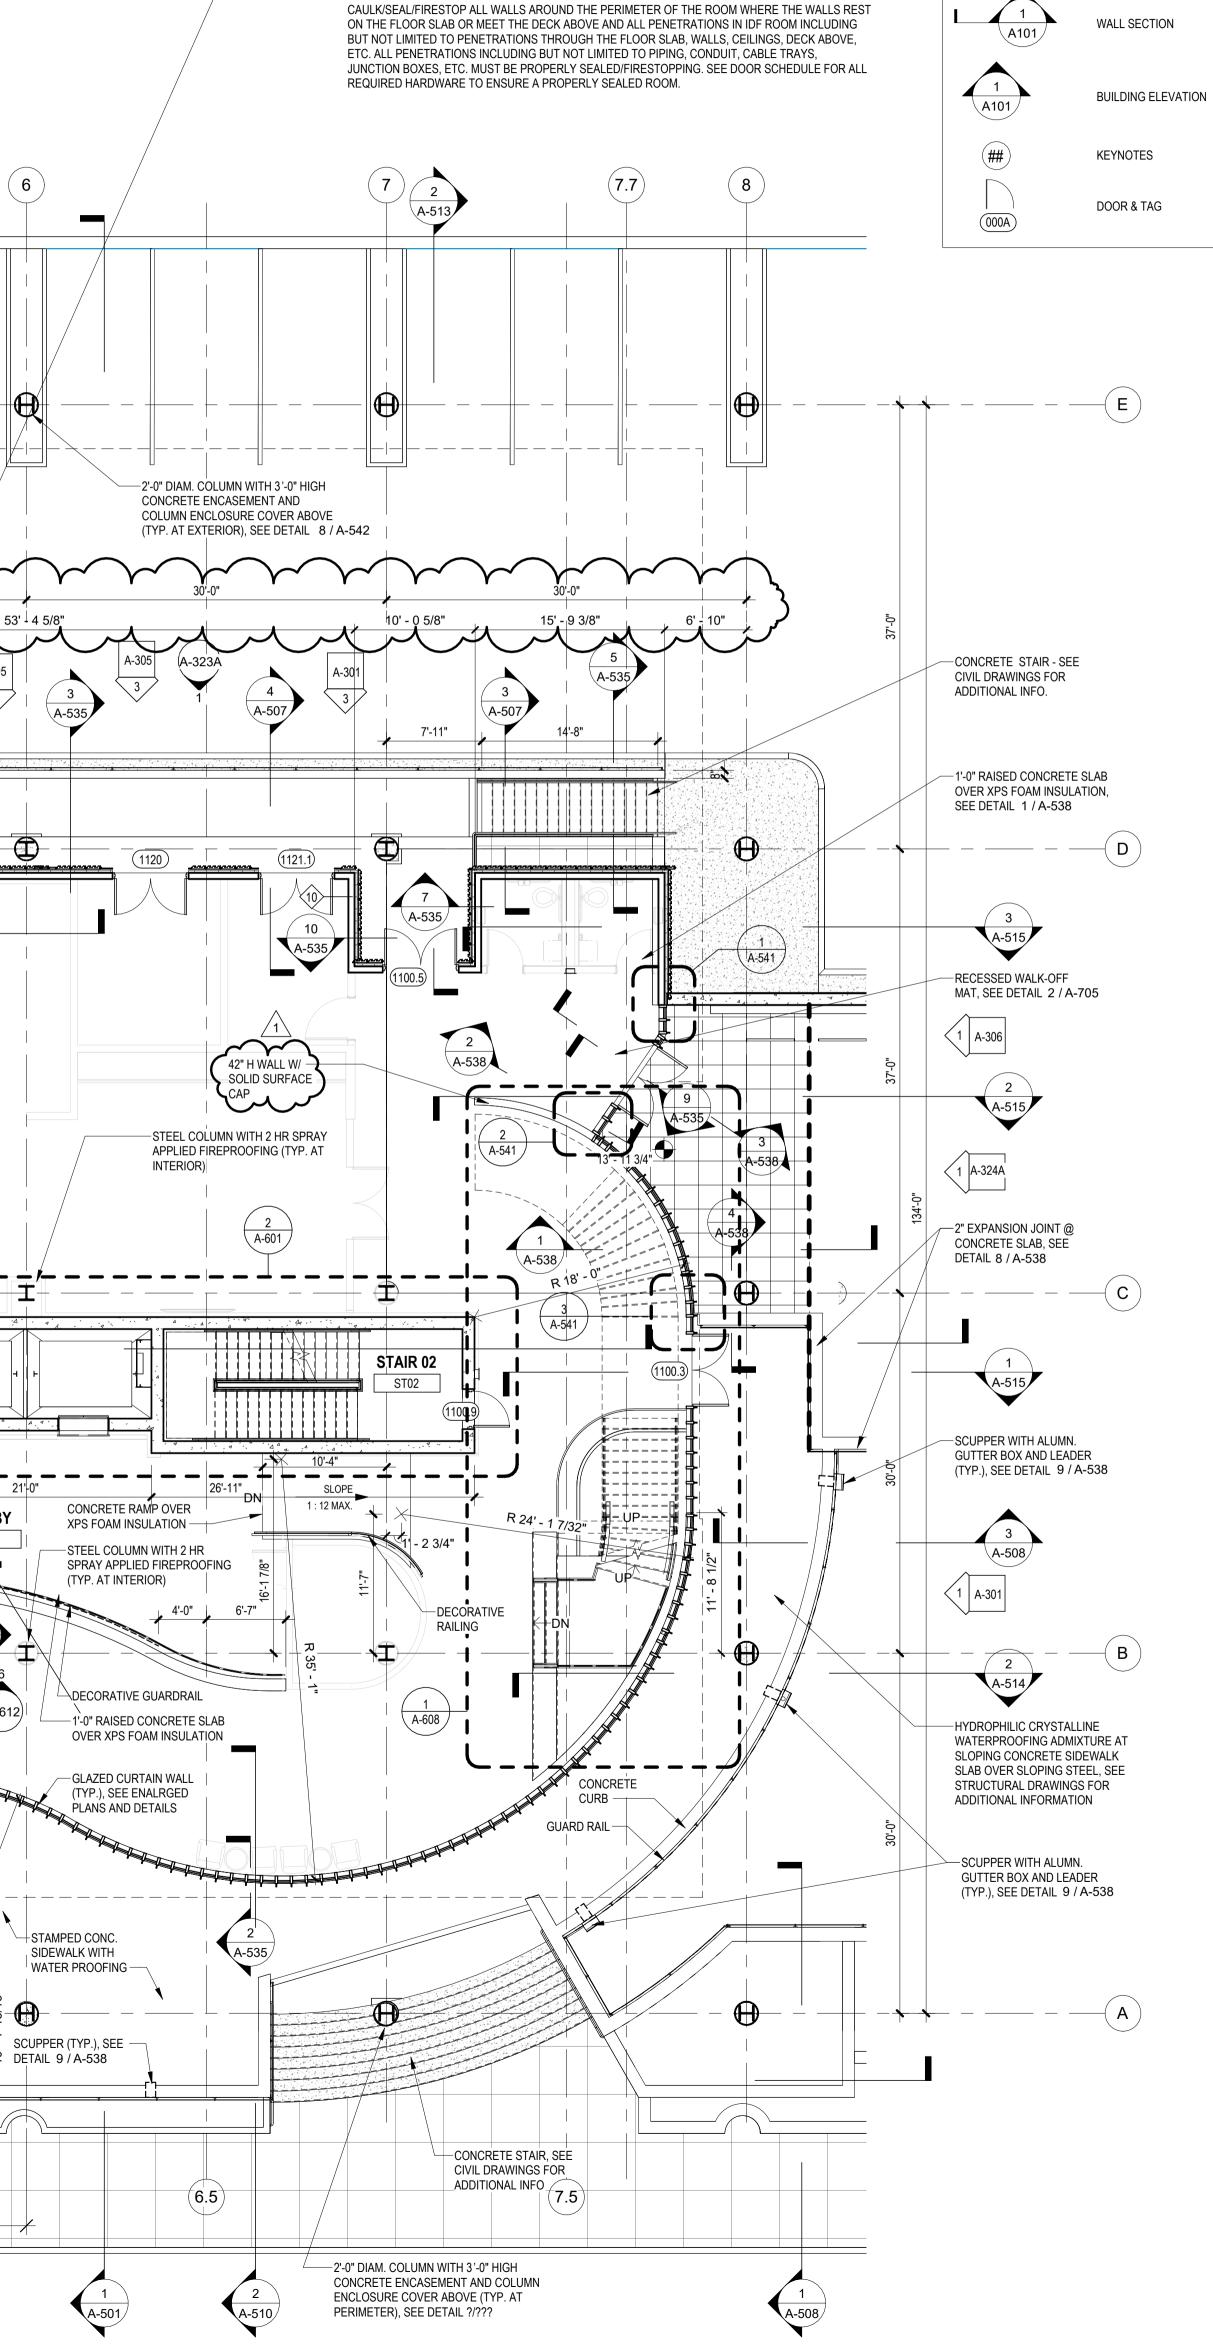
KEY PLAN: BLD 2 PLAZA (HUMAN SERV.) WEST GRAND S  $\square$ PROJECT NORTH TRUE NORTH



(4.3) (6) (4) (5.5) A-506 ∖**A-**514 A-506 A-513  $\mathbf{\Theta}$ \_\_\_\_ \_\_\_\_ \_\_\_\_ \_\_\_\_\_ \_\_\_\_\_ \_\_\_\_\_ \_\_\_\_\_ \_\_\_\_\_ LINE OF HYDROPHILIC CRYSTALLINE WATERPROOFING ADMIXTURE AT SLOPING CONCRETE SIDEWALK \_\_\_\_\_ SLAB OVER SLOPING STEEL, SEE STRUCTURAL DRAWINGS FOR ADDITIONAL INFORMATION - $\overline{1}$ -CONCRETE WALL WITH CABLE 23'-1 1/2" 5'-4 1/2" RAILING 42" A.F.F. ABOVE (TYP.), SEE DETAIL 8 / A-536 A-535 A-50 —R= 5'-0" 6 - ADA PARKING SIGN -A-507 SEE CIVIL DWGS. -AREA DRAIN -ADA DETECTABLE WARNING SURFACE-R=10'-6"— \_ .SEE CIVIL DWGS. \_ \_ \_ \_ \_ \_ \_ \_ \_ \_ \_ \_ \_ \_ \_ \_  $\Theta$  $-\mathbf{T}$ \_\_\_\_\_ -ADA DETECTABLE WARNING SURFACE- SEE PEDESTRIAN WALK CIVIL DWGS. R =8'-0" SEE CIVIL DWGS. --ADA PARKING SIGN - DECORATIVE BOLLARDS SEE CIVIL DWGS. (TYP.), SEE DETAIL \**A-535**/ COORDINATE WITH CIVIL -STAMPED CONC. DRAWINGS 2 / A-536 SIDEWALK WITH WATER PROOFING -A-302 1 A-304 1 -PARKING FIELD BOLLARD, SEE DETAIL 2/A-536 2'-0" DIAM. COLUMN WITH 3'-0" 3 HIGH CONCRETE ENCASEMENT A-512 ABOVE (TYP. AT PERIMETER), SEE DETAIL 8 / A-542 ∖**A-5**11∕ \**A-512** LOBBY 1100 FLUSH CURB (TYP.), COORDINATE WITH CIVIL DRAWINGS -\A-511 -NO TRUCKS ALLOWED, PASSENGER VEHICLES ONLY SIGN - SEE CIVIL DWGS. R= 8'-6"-R= 8'-0"— ( A-612) **A-511** -ADA DETECTABLE WARNING SURFACE--NO TRUCKS ALLOWED, PASSENGER SEE CIVIL DWGS. VEHICLES ONLY SIGN - SEE CIVIL DWGS. RECESSED WALK-OFF MAT, -4" WIDE WHITE LINE OF FLOORS -SEE DETAIL 2 / A-705 VEST. A-541 LANE LINE - SEE ABOVE TYP -R=15'-0" 1101 CIVIL DWGS. 'TURN ONLY' WORD \_\_\_\_\_ SEE CIVIL DWGS. -SIDEWALK WITH -STEEL COLUMN WITH -4'X8' RAISED WATER PROOFING -MTL. COVER AND PLANTER (TYP.) CONC. BASE - TYP. CONCRETE WALL WITH CABLE <u>5</u>-0-RAILING 42" A.F.F. ABOVE, SEE VV DETAIL SIM. SCUPPER (TYP.), SEE -F.D. 4 / A-538 DETAIL 9 / A-538 <u> г </u> ╵┌╼─┼──╼└┙┤╼── \_\_\_\_\_; \_\_\_\_↓」 ↓ PLANTER - SEE CIVIL DWGS. A-303 5.5 A-507/ A-302 (4.5) 11' - 3 13/16"  $\bigvee$ - HYDROPHILIC CRYSTALLINE WATERPROOFING ADMIXTURE AT -

A-510



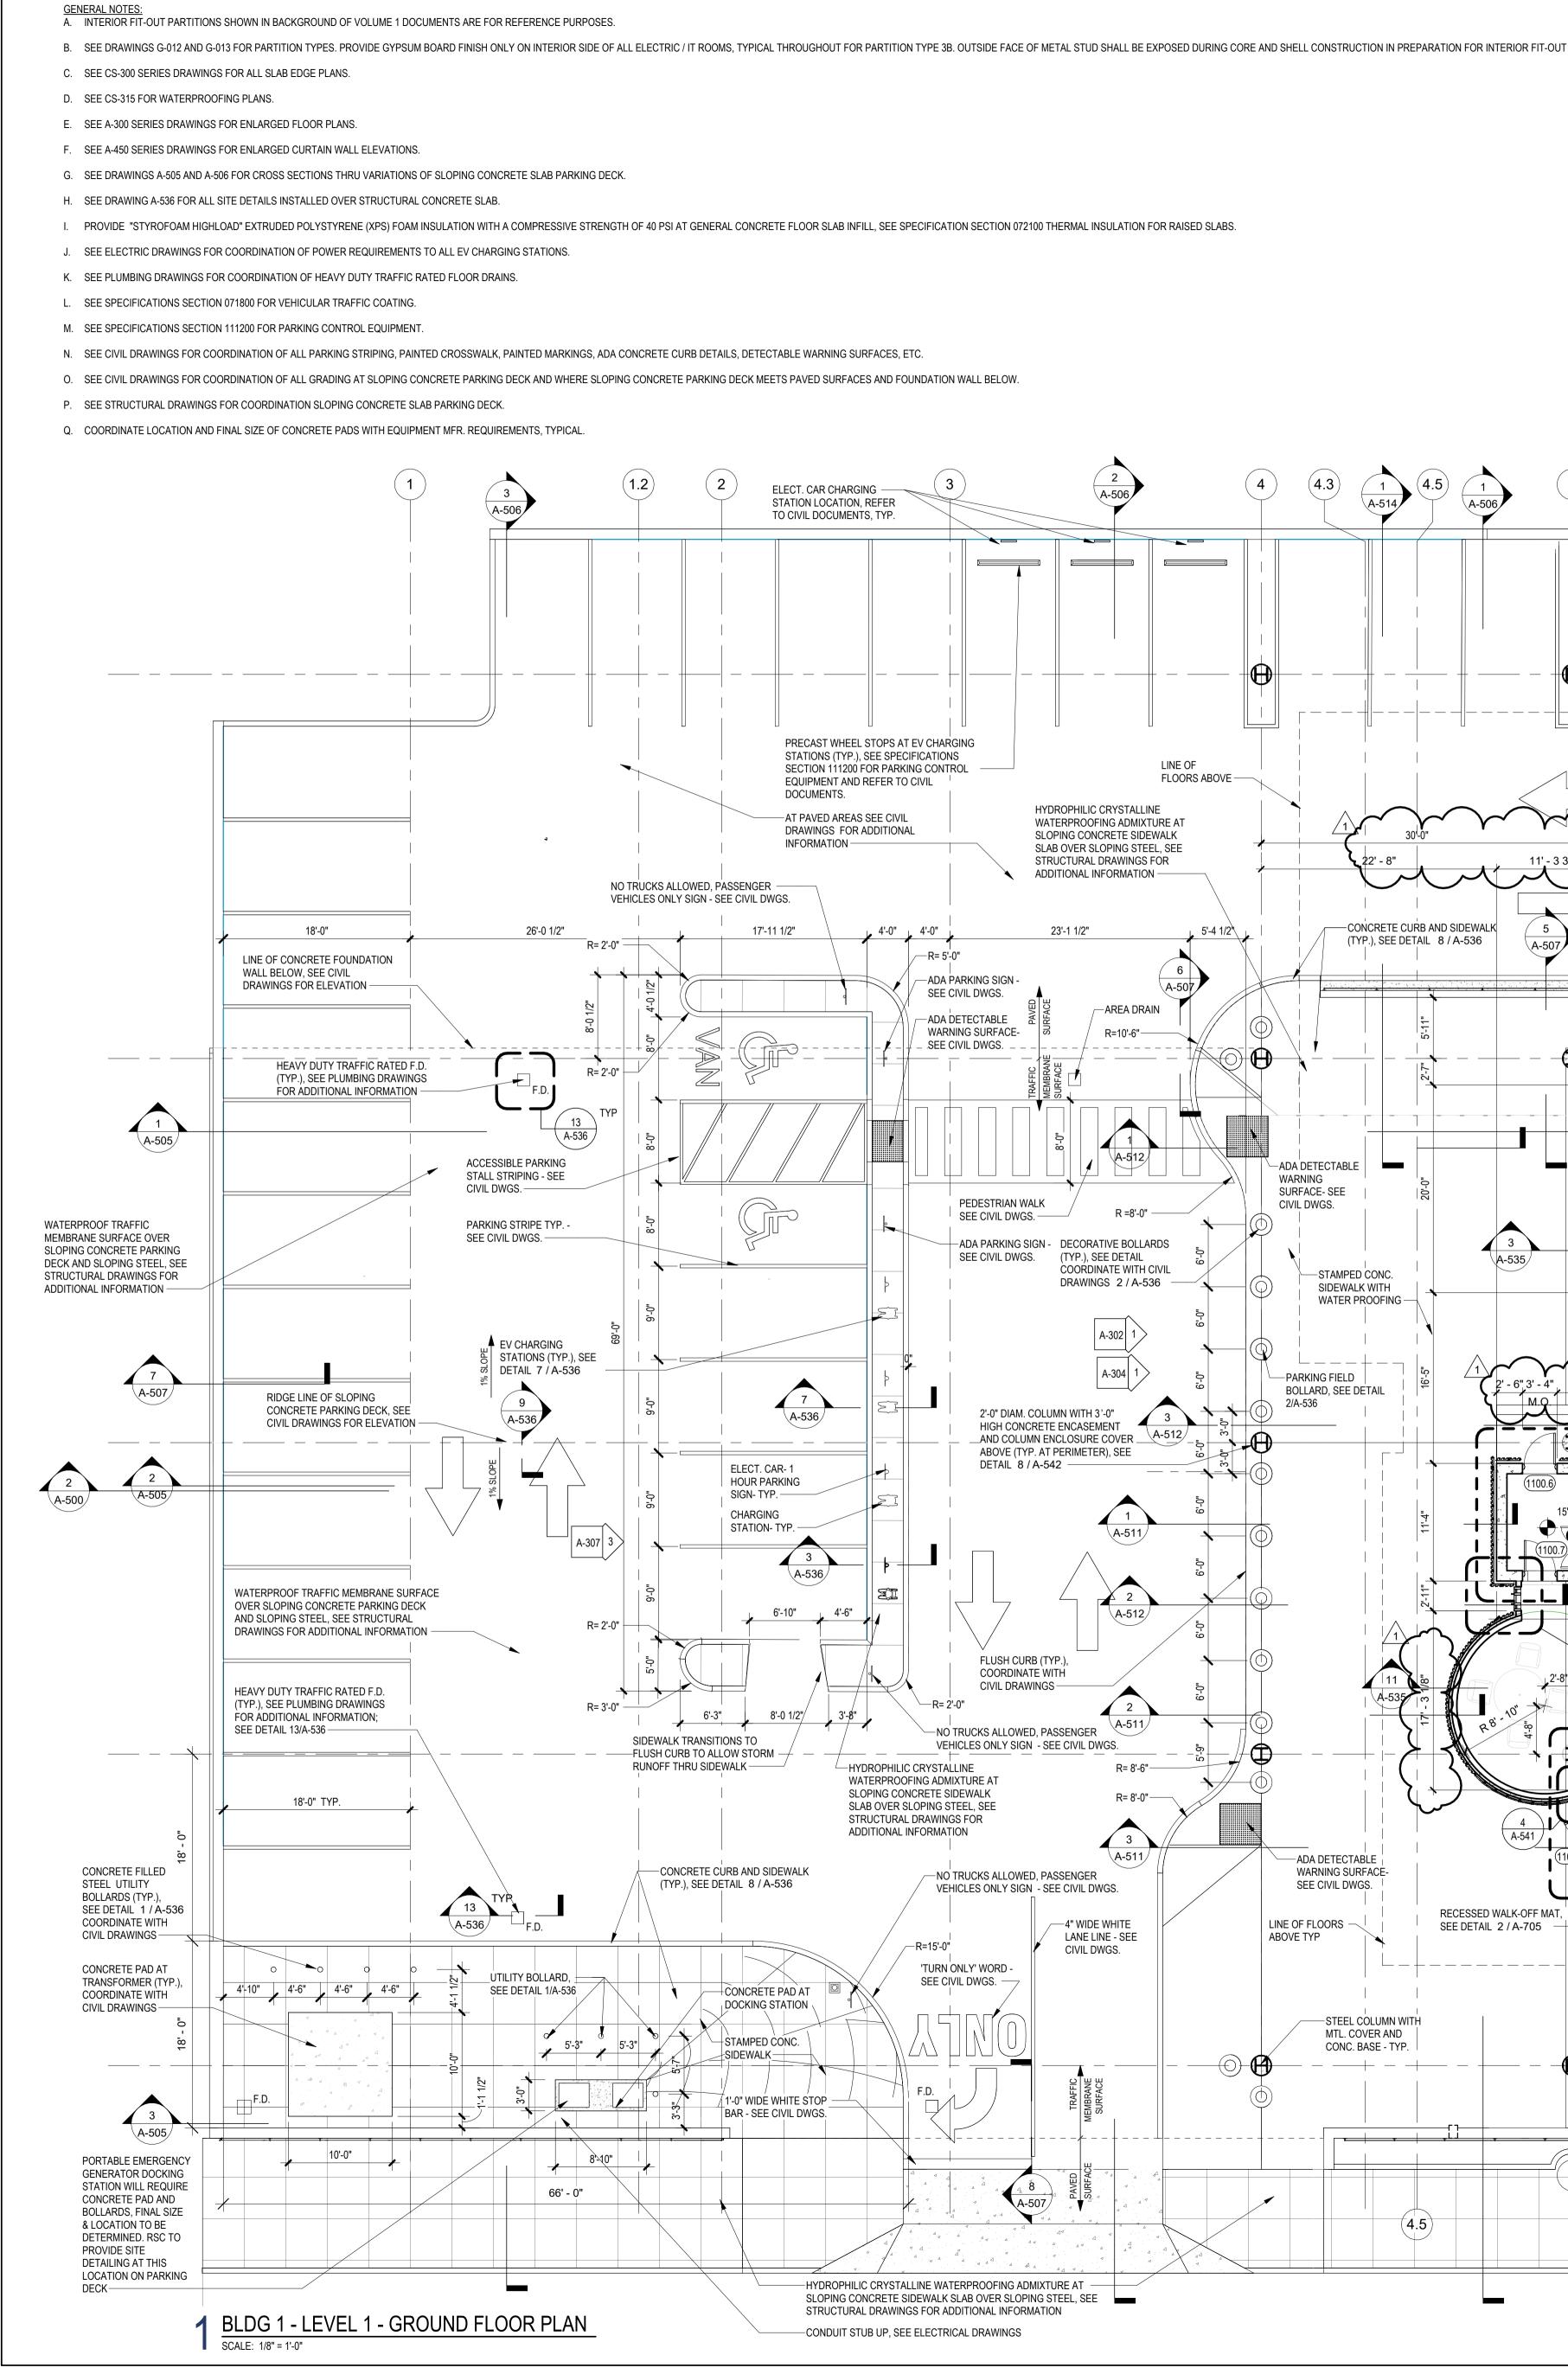

- A ROOM ENCLOSURE INTEGRITY TEST WILL BE PERFORMED IN ALL IDF ROOMS AFTER

CONTAINING THE CLEAN AGENT GAS FIRE SUPPRESSION SYSTEM. CONTRACTOR SHALL

CONSTRUCTION IS COMPLETE IN ORDER TO VERIFY THAT THE SPACE IS CAPABLE OF SUFFICIENTLY

\_\_\_\_\_

EJ

<1i>

STUD CONSTRUCTION

POURED CONCRETE

EXPANSION JOINT

REFERENCE

SPOT ELEVATION

PARTITION TAG

ENLARGED PLAN / DETAIL

MASONRY CONSTRUCTION

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### Jeffrey D. Venezia, AIA NJ RÁ AI 00827100


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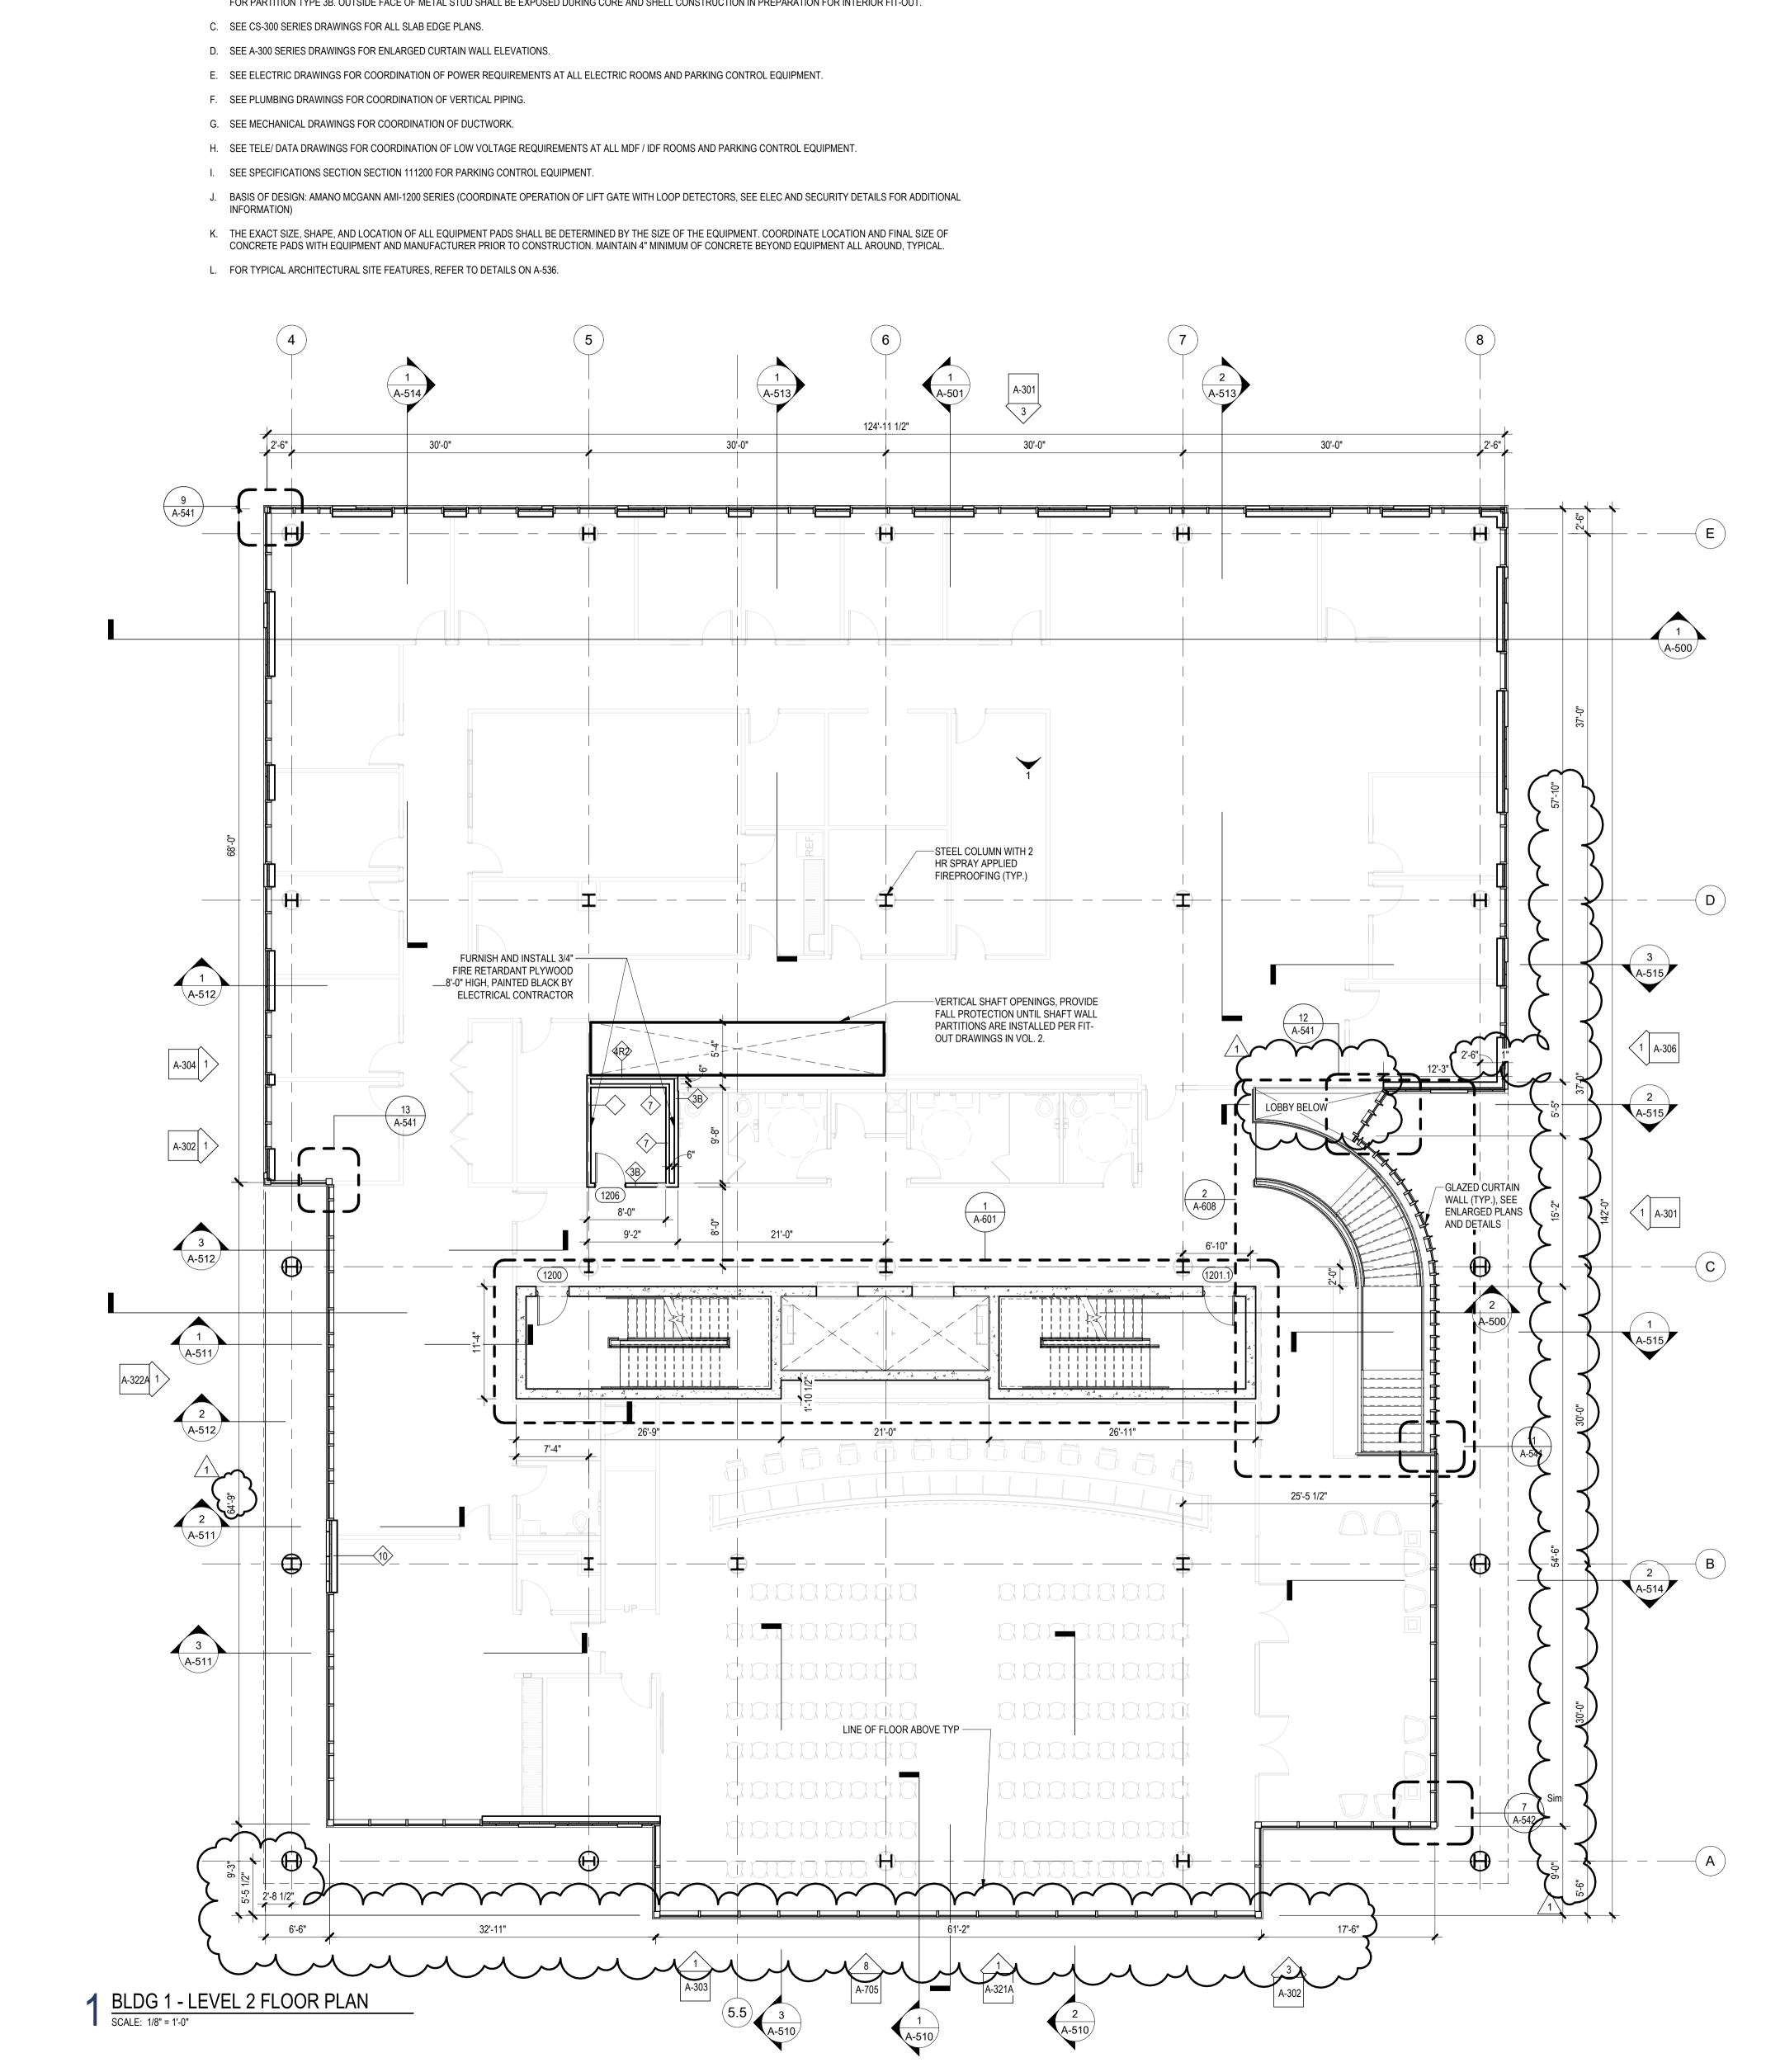
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Descriptior

12.01.2023 Addendum No. 01

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**GENERAL NOTES:** A. INTERIOR FIT-OUT PARTITIONS SHOWN IN BACKGROUND OF VOLUME 1 DOCUMENTS ARE FOR REFERENCE PURPOSES.

B. SEE DRAWINGS G-012 AND G-013 FOR PARTITION TYPES. PROVIDE GYPSUM BOARD FINISH ONLY ON INTERIOR SIDE OF ALL ELECTRIC / IT ROOMS, TYPICAL THROUGHOUT FOR PARTITION TYPE 3B. OUTSIDE FACE OF METAL STUD SHALL BE EXPOSED DURING CORE AND SHELL CONSTRUCTION IN PREPARATION FOR INTERIOR FIT-OUT.

# FLOOR PLAN LEGEND

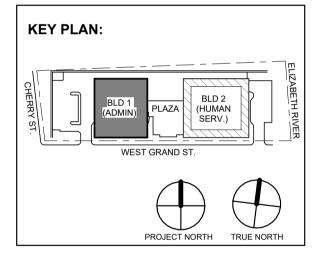

A101

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\A101

(##)

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## MASONRY CONSTRUCTION POURED CONCRETE

STUD CONSTRUCTION

EXPANSION JOINT

ENLARGED PLAN / DETAIL REFERENCE

SPOT ELEVATION

PARTITION TAG

WALL SECTION

BUILDING ELEVATION

KEYNOTES

DOOR & TAG

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# Jeffrey D. Venezia, AIA NJ RA AI 00827100

No. Date

1 12.01.2023 Addendum No. 01

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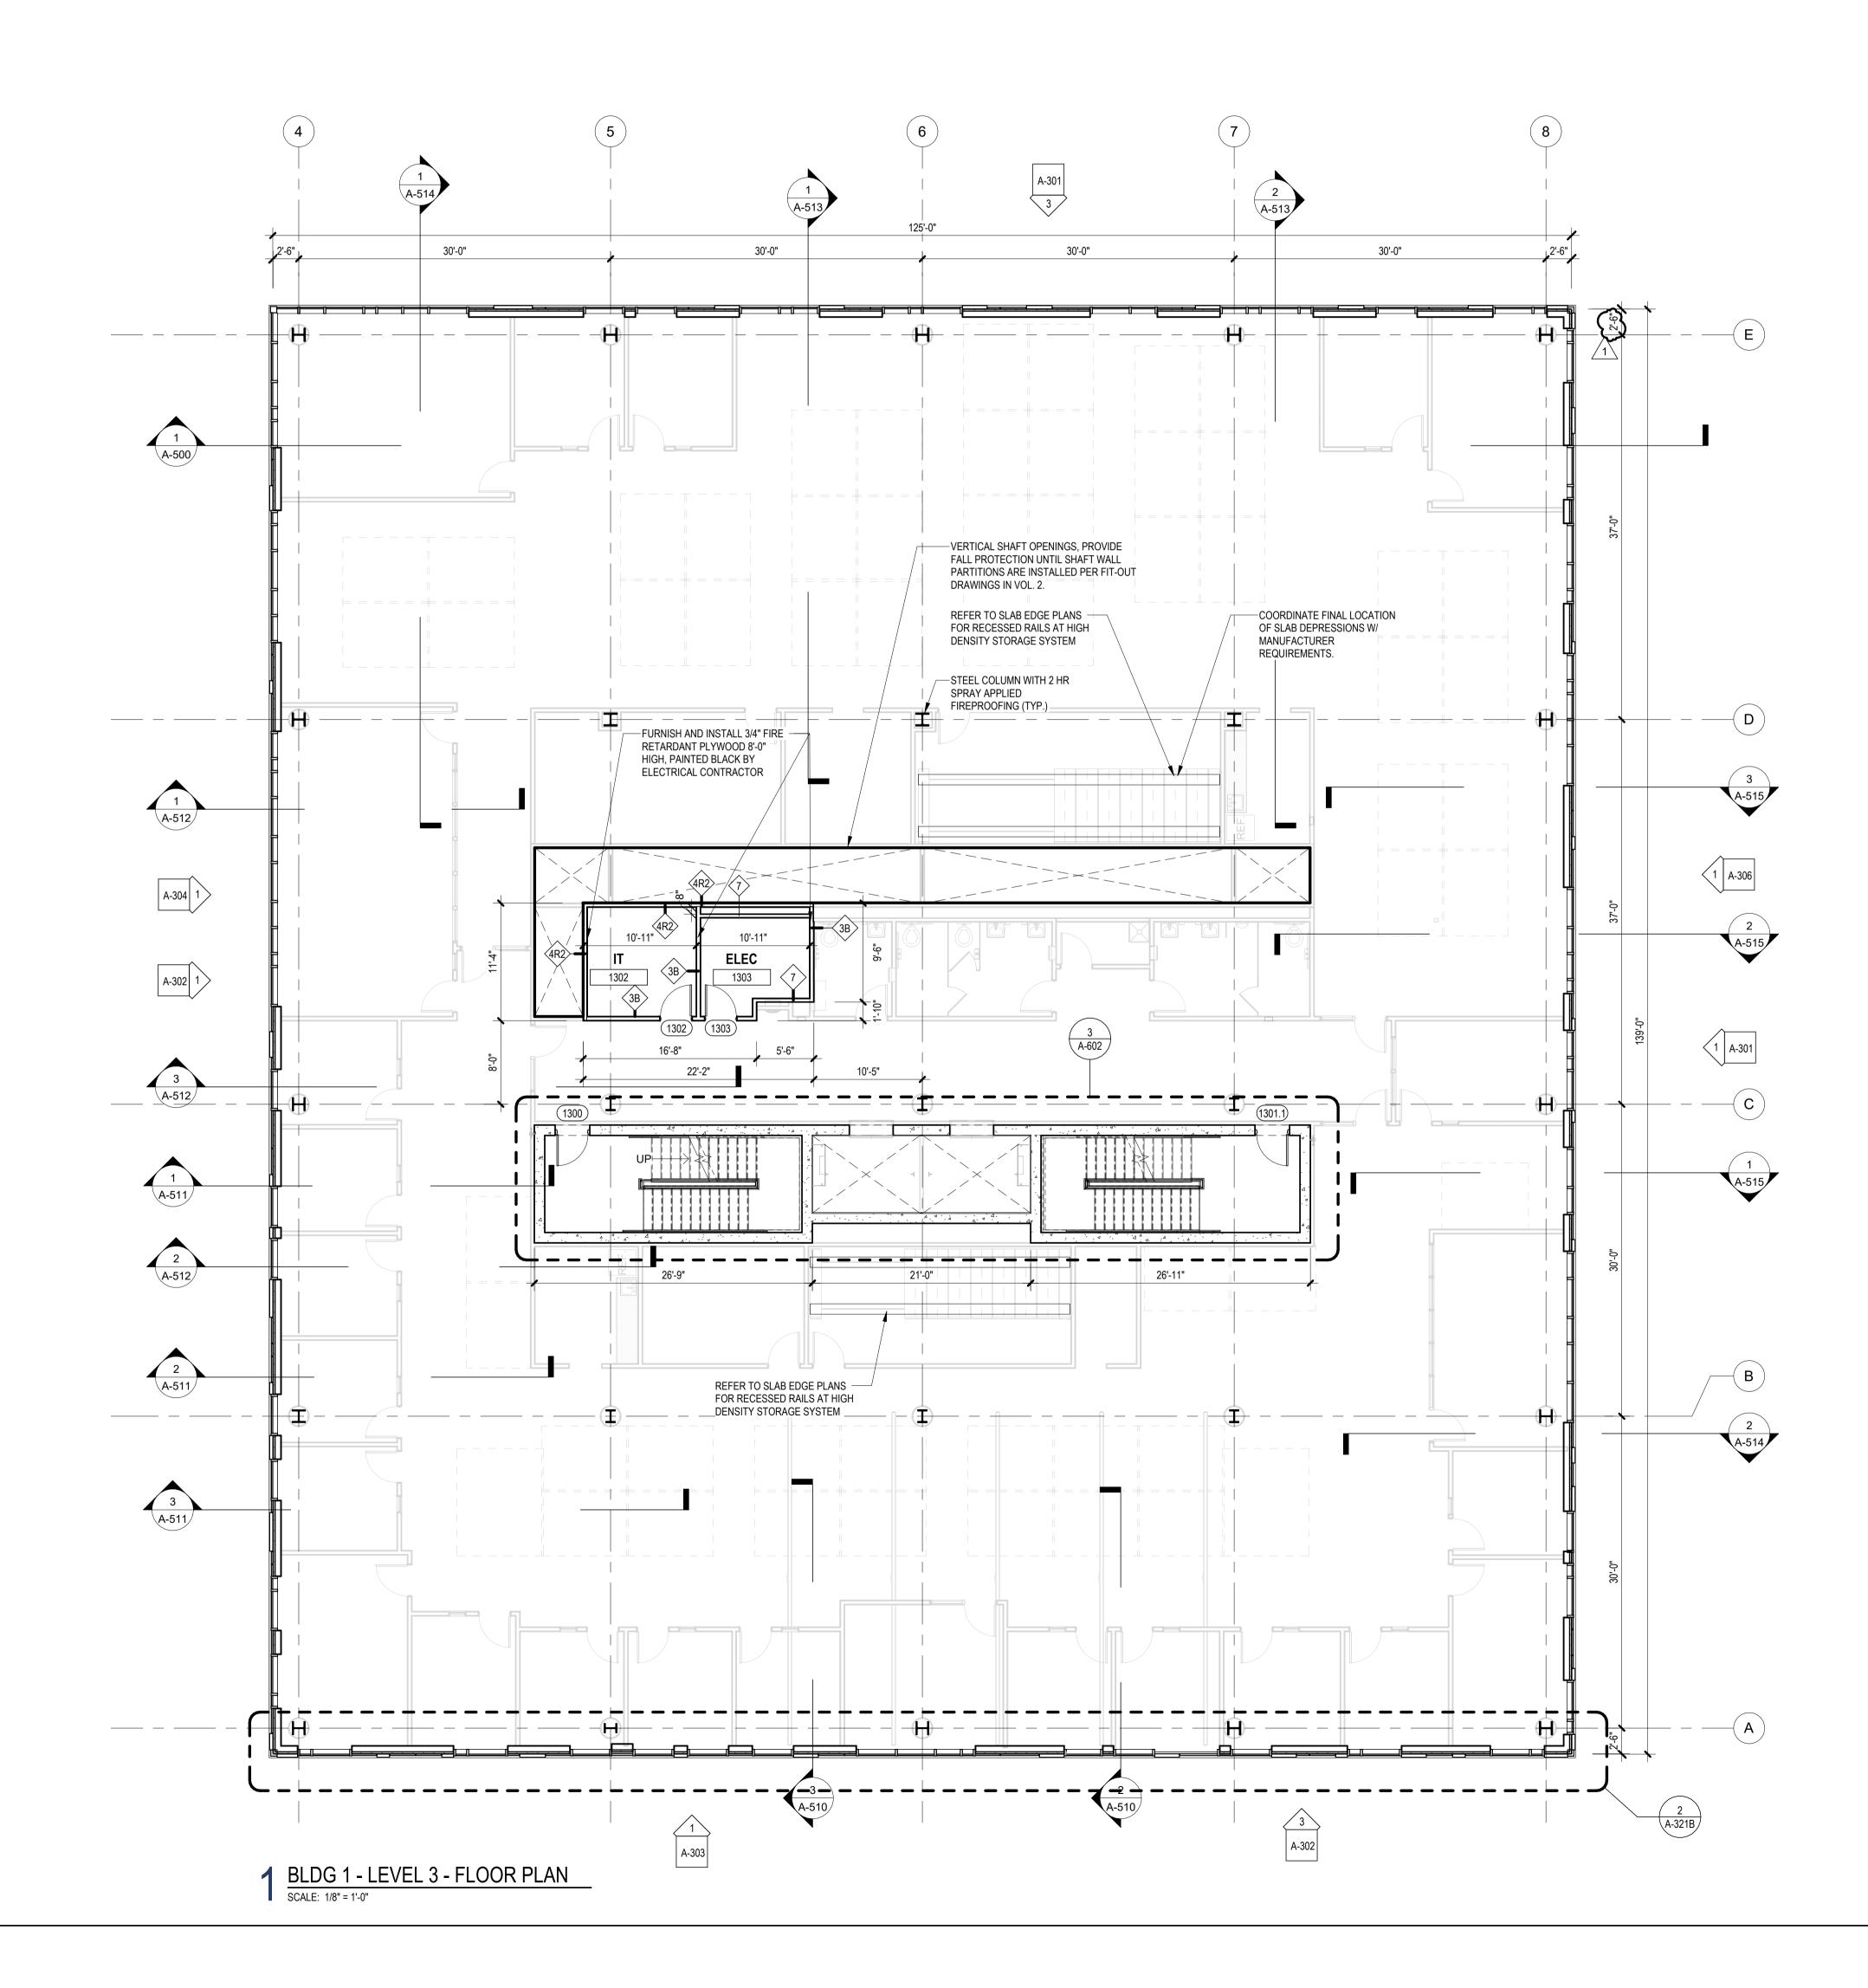
Description

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KEY PLAN: PROJECT NORTH TRUE NORTH



- A. INTERIOR FIT-OUT PARTITIONS SHOWN IN BACKGROUND OF VOLUME 1 DOCUMENTS ARE FOR REFERENCE PURPOSES.
- B. SEE DRAWINGS G-012 AND G-013 FOR PARTITION TYPES. PROVIDE GYPSUM BOARD FINISH ONLY ON INTERIOR SIDE OF ALL ELECTRIC / IT ROOMS, TYPICAL THROUGHOUT FOR PARTITION TYPE 3B. OUTSIDE FACE OF METAL STUD SHALL BE EXPOSED DURING CORE AND SHELL CONSTRUCTION IN PREPARATION FOR INTERIOR FIT-OUT. C. SEE CS-300 SERIES DRAWINGS FOR ALL SLAB EDGE PLANS.
- D. SEE A-300 SERIES DRAWINGS FOR ENLARGED CURTAIN WALL ELEVATIONS.
- E. SEE ELECTRIC DRAWINGS FOR COORDINATION OF POWER REQUIREMENTS AT ALL ELECTRIC ROOMS AND PARKING CONTROL EQUIPMENT. F. SEE PLUMBING DRAWINGS FOR COORDINATION OF VERTICAL PIPING.
- G. SEE MECHANICAL DRAWINGS FOR COORDINATION OF DUCTWORK.
- H. SEE TELE/ DATA DRAWINGS FOR COORDINATION OF LOW VOLTAGE REQUIREMENTS AT ALL MDF / IDF ROOMS AND PARKING CONTROL EQUIPMENT.
- I. SEE SPECIFICATIONS SECTION SECTION 111200 FOR PARKING CONTROL EQUIPMENT.
- J. BASIS OF DESIGN: AMANO MCGANN AMI-1200 SERIES (COORDINATE OPERATION OF LIFT GATE WITH LOOP DETECTORS, SEE ELEC AND SECURITY DETAILS FOR ADDITIONAL INFORMATION)
- K. THE EXACT SIZE, SHAPE, AND LOCATION OF ALL EQUIPMENT PADS SHALL BE DETERMINED BY THE SIZE OF THE EQUIPMENT. COORDINATE LOCATION AND FINAL SIZE OF CONCRETE PADS WITH EQUIPMENT AND MANUFACTURER PRIOR TO CONSTRUCTION. MAINTAIN 4" MINIMUM OF CONCRETE BEYOND EQUIPMENT ALL AROUND, TYPICAL.
- L. FOR TYPICAL ARCHITECTURAL SITE FEATURES, REFER TO DETAILS ON A-536.



# FLOOR PLAN LEGEND

	STUD CONSTRUCTION
	MASONRY CONSTRUCTION
	POURED CONCRETE
EJ	EXPANSION JOINT
$\subset \Box$	ENLARGED PLAN / DETAIL REFERENCE
	SPOT ELEVATION
<1i>	PARTITION TAG
1 A101	WALL SECTION
1 A101	BUILDING ELEVATION
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(000A)	DOOR & TAG

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UNION COUNTY GOVERNMENT COMPLEX 81 & 93 WEST GRAND STREET CITY OF ELIZABETH NEW JERSEY, 07202 Drawing Information: Project No: 20.072 Date: 11.08.2023
Drawn By: JB / AV / PC Checked By: JM / SH
Sheet Name:
BUILDING NO. 1 - LEVEL 3 - FLOOR PLAN
<b>CS-103</b>


# Jeffrey D. Venezia, AIA NJ RA AI 00827100

1 12.01.2023 Addendum No. 01 11.08.2023 For Public Bid No. Date Description

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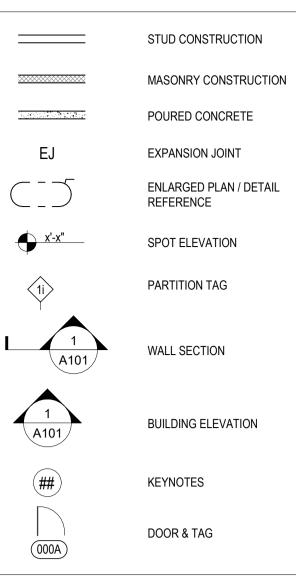
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## FLOOR PLAN LEGEND



## **GENERAL NOTES:**

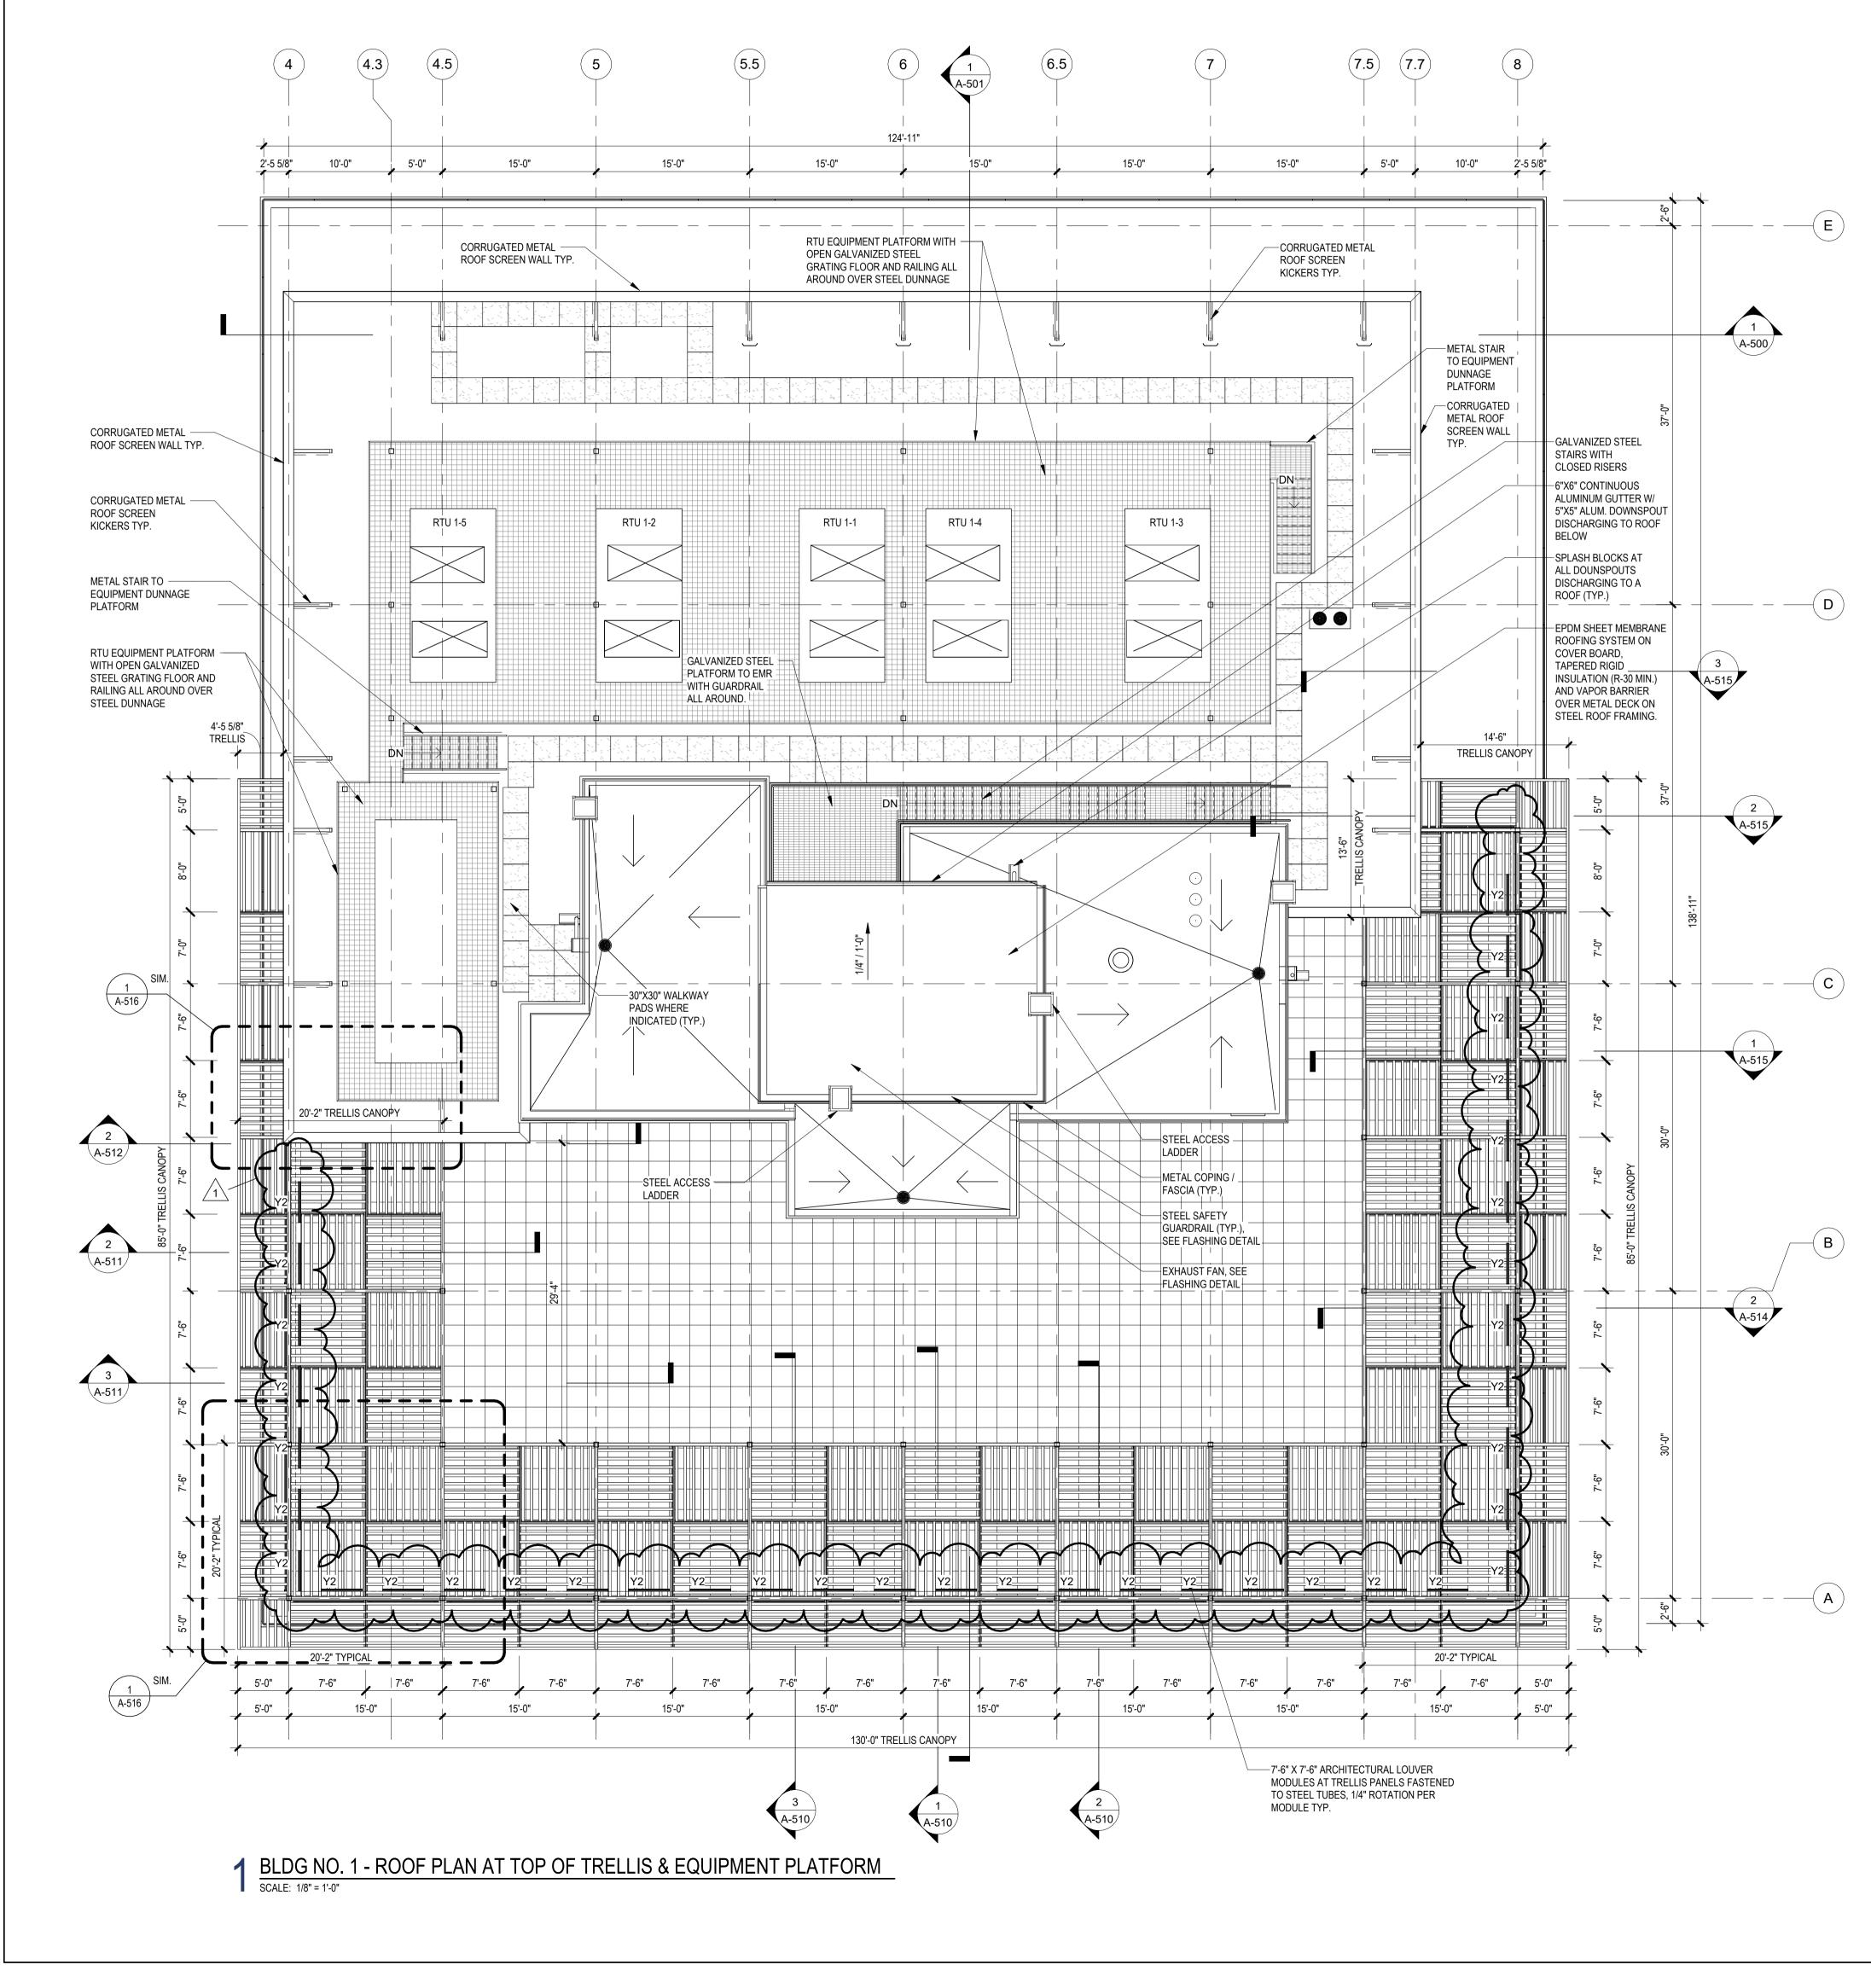- A. SIZE AND LOCATION OF ROOFTOP UNITS, CONDENSERS, PITCH POCKETS AND OTHER ELECTRICAL, MECHANICAL OR PLUMBING EQUIPMENT INDICATED ON THIS PLAN ARE APPROXIMATE. VERIFY EXACT LOCATIONS IN THE FIELD AND NOTIFY ARCHITECT OF ANY DISCREPANCIES.
- B. COORDINATE ALL ROOF EQUIPMENT SHOWN AND ROOF PENETRATIONS WITH STRUCTURAL ROOF FRAMING PLANS AND MECHANICAL DRAWINGS.
- C. ELEVATIONS SHOWN ARE TO THE TOP OF THE ROOF INSULATION FROM EL. 0'-0"
- D. ALL DIMENSIONS ARE TO COLUMN CENTERLINES (U.O.N.)
- E. ALL DIMENSIONS ARE TO CENTERLINE OF ROOF OPENINGS
- F. MECHANICAL OPENINGS ARE BASED ON SPECIFIED EQUIPMENT, VERIFY ALL OPENING SIZES WITH MECHANICAL CONTRACTOR.
- G. SEE DRAWINGS G-012 AND G-013 FOR PARTITION TYPES.
- H. SEE CS-300 SERIES DRAWINGS FOR ALL SLAB EDGE PLANS FOR SIZE OF ROOF
- OPENINGS, VERIFY EXACT SIZE WITH MECHANICAL CONTRACTOR.I. SEE A-600 SERIES DRAWINGS FOR ENLARGED FLOOR PLANS AT EGRESS STAIRS.
- J. SEE DRAWINGS A-425 AND A-426 FOR ENLARGED FLOOR PLANS AT PENTHOUSE
- AND EMR.
- K. REFER TO DRAWING A-516 AND A-525 FOR ROOF TRELLIS AND GLASS RAILING DETAILS.
- L. SEE A-550 SERIES DRAWINGS FOR ROOF DETAILS.M. THE EXACT SIZE, SHAPE, AND LOCATION OF ALL EQUIPMENT PADS SHALL BE
- DETERMINED BY THE SIZE OF THE EQUIPMENT. COORDINATE LOCATION AND FINAL SIZE OF CONCRETE PADS WITH EQUIPMENT AND MANUFACTURER PRIOR TO CONSTRUCTION. MAINTAIN 4" MINIMUM OF CONCRETE BEYOND EQUIPMENT ALL AROUND, TYPICAL.
- N. REFER TO MECHANICAL, ELECTRICAL AND PLUMBING DRAWINGS FOR ADDITIONAL INFORMATION.
- O. SEE SPECIFICATIONS SECTION 072100 FOR THERMAL INSULATION.
- P. SEE SPECIFICATIONS SECTION 075323 FOR TYPICAL EPDM MEMBRANE ROOFING AND TYPE & THICKNESS OF ROOFING INSULATION. BASIS OF DESIGN - CARLISLE SYNTEC "SURE-WHITE".
- Q. SEE SPECIFICATIONS SECTION 077100 FOR ROOF SPECIALTIES AND ACCESSORIES, PROVIDE PRESSURE TREATED WOOD BLOCKING AS REQUIRED FOR PROPER ANCHORAGE.

RCP LEGEND				
Room name	ROOM NAME CEILING HEIGHT ROOM NUMBER			
APC-1	—CEILING TYPE —CEILING HEIGHT			
$ \begin{array}{c} b_{1,2} & a_{2,3} \\ b_{1,3} & b_{1,3} $	GYPSUM BOARD CEILING			
	2' BY 2' SUSPENDED CEILING GRID, CEILING HEIGHT INDICATED ON PLANS, GRID TO BE CENTERED IN AREA U.O.N.			
	4' BY 4' SUSPENDED CEILING GRID, CEILING HEIGHT INDICATED ON PLANS, GRID TO BE CENTERED IN AREA U.O.N.			
	HVAC - RETURN			
$\square$	HVAC - SUPPLY			
G	4'-0" RECESSED LINEAR LIGHT FIXTURE (TYPE G)			
M	4'-0" SURFACE MOUNTED LINEAR LIGHT FIXTURE (TYPE M) - MOUNTING HEIGHT : 8'-0" A.F.F. TO BOTTOM OF FIXTURE (M)			
PL 🔲	16" X 16" SURFACE MOUNTED CEILING LIGHT FIXTURE (TYPE PL)			
PL-C O	6" X 6" SURFACE MOUNTED CYLINDER LIGHT (TYPE PL-C)			
R 🗖	EXTERIOR RATED, BUILIDNG MOUNTED WALLPACK FIXTURE (TYPE R)			
Т	FA CEILING MOUNTED SPEAKER & STROBE			
Ì	FA CEILING MOUNTED STROBE			
(S)	SMOKE DETECTOR			
	12" x 12" ACCESS DOOR			
	EXIT SIGN WITH EMERGENCY LIGHT			
	1' LINEĂR EXTERIOR <sup>®</sup> COVE LIGHTING			
	PLAZA ACCENT LIGHTING RECESSED BELOW PAVER DECK(TYPE Y)			
	CANOPY ACCENT LIGHTING RECESSED BELOW PAVER DECK (TYPE Y2) 12" DIA FLAGPOLE LIGHTING, RECESSED BELOW PAVER DECK (TYPE Z)			
1 mm				

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Drawing Information:
Project No: 20.072 Date: 11.08.2023
Drawn By: JB / AV / PC Checked By: JM / SH
Sheet Name:
BUILDING NO. 1 - ROOF PLAN AT TOP OF TRELLIS AND EQUIPMENT PLATFORM
Sheet No:
<b>CS-108</b>

### Jeffrey D. Venezia, AIA NJ RA AI 00827100

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1 12.01.2023 Addendum No. 01

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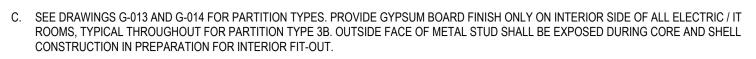
CHERRY ST. WEST GRAND ST. WEST GRAND ST. PROJECT NORTH TRUE NORTH




GENERAL NOTES:

A. INTERIOR FIT-OUT PARTITIONS SHOWN IN BACKGROUND OF CORE AND SHELL DOCUMENTS ARE FOR REFERENCE PURPOSES

B. CONTRACTOR SHALL EXCLUDE INSTALLATION OF GYPSUM BOARD FINISH ONLY ON INTERIOR SIDE OF ALL EXTERIOR PARTITIONS, TYPICAL THROUGHOUT. INSIDE FACE OF METAL STUD SHALL BE EXPOSED DURING CORE AND SHELL CONSTRUCTION IN PREPARATION FOR INTERIOR FIT-OUT.



- D. SEE CS-300 SERIES DRAWINGS FOR ALL SLAB EDGE PLANS
- E. SEE A-400 SERIES DRAWINGS FOR ENLARGED FLOOR PLANS
- F. SEE A-450 SERIES DRAWINGS FOR ENLARGED CURTAIN WALL ELEVATIONS
- G. SEE ELECTRIC DRAWINGS FOR COORDINATION OF POWER REQUIREMENTS AT ALL ELECTRIC ROOMS
- H. SEE PLUMBING DRAWINGS FOR COORDINATION OF VERTICAL PIPING
- I. SEE MECHANICAL DRAWINGS FOR COORDINATION OF DUCTWORKJ. SEE TELE/ DATA DRAWINGS FOR COORDINATION OF LOW VOLTAGE REQUIREMENTS AT ALL MDF / IDF ROOMS
- K. FOR TYPICAL ARCHITECTURAL SITE FEATURES, REFER TO DETAILS ON A-536.

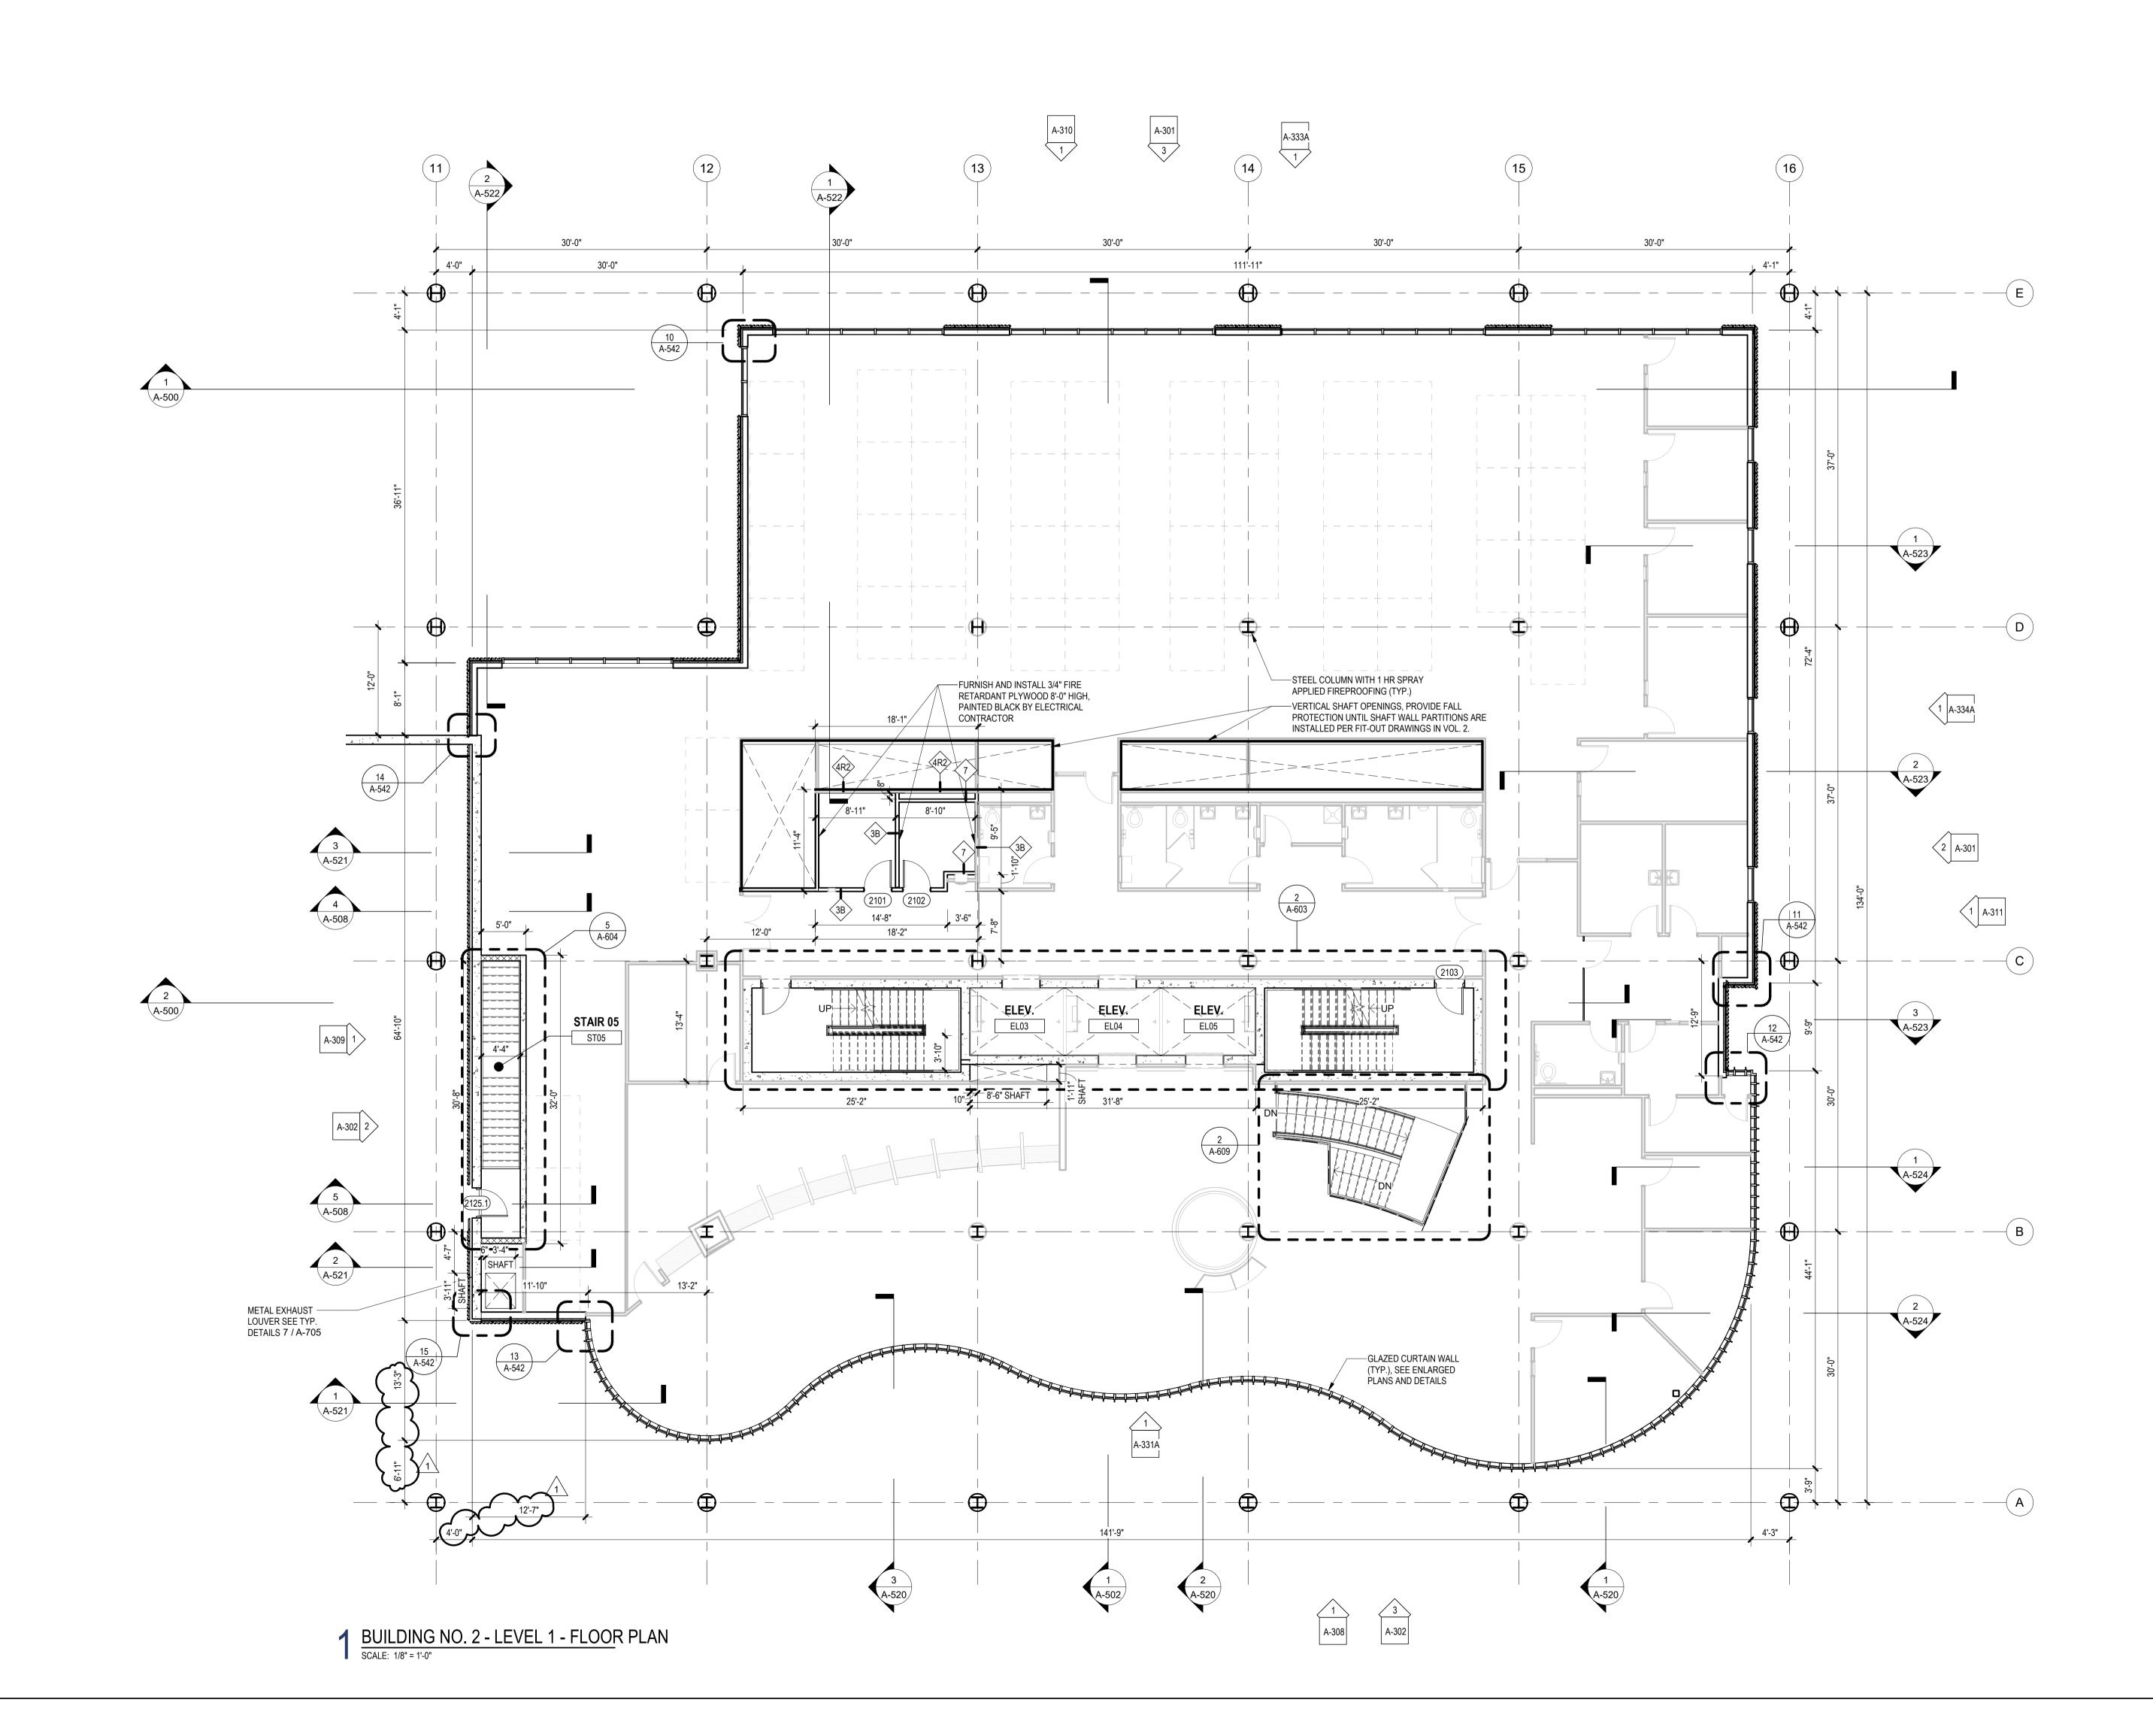



# FLOOR PLAN LEGEND

STUD CONSTRUCTION
MASONRY CONSTRUCTION
POURED CONCRETE
EXPANSION JOINT
ENLARGED PLAN / DETAIL REFERENCE
SPOT ELEVATION
PARTITION TAG
WALL SECTION
BUILDING ELEVATION
KEYNOTES
DOOR & TAG

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Drawing Information:
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Sheet Name:
BUILDING NO. 2 - LEVEL 1 - FLOOR PLAN
Sheet No:
CS-111

### Jeffrey D. Venezia, AIA NJ RA AI 00827100

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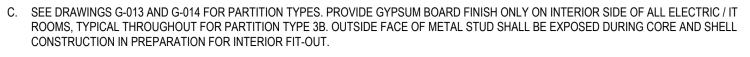
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CHERRY ST. WEST GRAND ST. WEST GRAND ST. TRUE NORTH




A. INTERIOR FIT-OUT PARTITIONS SHOWN IN BACKGROUND OF CORE AND SHELL DOCUMENTS ARE FOR REFERENCE PURPOSES


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- D. SEE CS-300 SERIES DRAWINGS FOR ALL SLAB EDGE PLANS
- E. SEE A-400 SERIES DRAWINGS FOR ENLARGED FLOOR PLANS
- F. SEE A-450 SERIES DRAWINGS FOR ENLARGED CURTAIN WALL ELEVATIONS
- G. SEE ELECTRIC DRAWINGS FOR COORDINATION OF POWER REQUIREMENTS AT ALL ELECTRIC ROOMS
- H. SEE PLUMBING DRAWINGS FOR COORDINATION OF VERTICAL PIPING
- I. SEE MECHANICAL DRAWINGS FOR COORDINATION OF DUCTWORK J. SEE TELE/ DATA DRAWINGS FOR COORDINATION OF LOW VOLTAGE REQUIREMENTS AT ALL MDF / IDF ROOMS
- K. FOR TYPICAL ARCHITECTURAL SITE FEATURES, REFER TO DETAILS ON A-536.



# FLOOR PLAN LEGEND

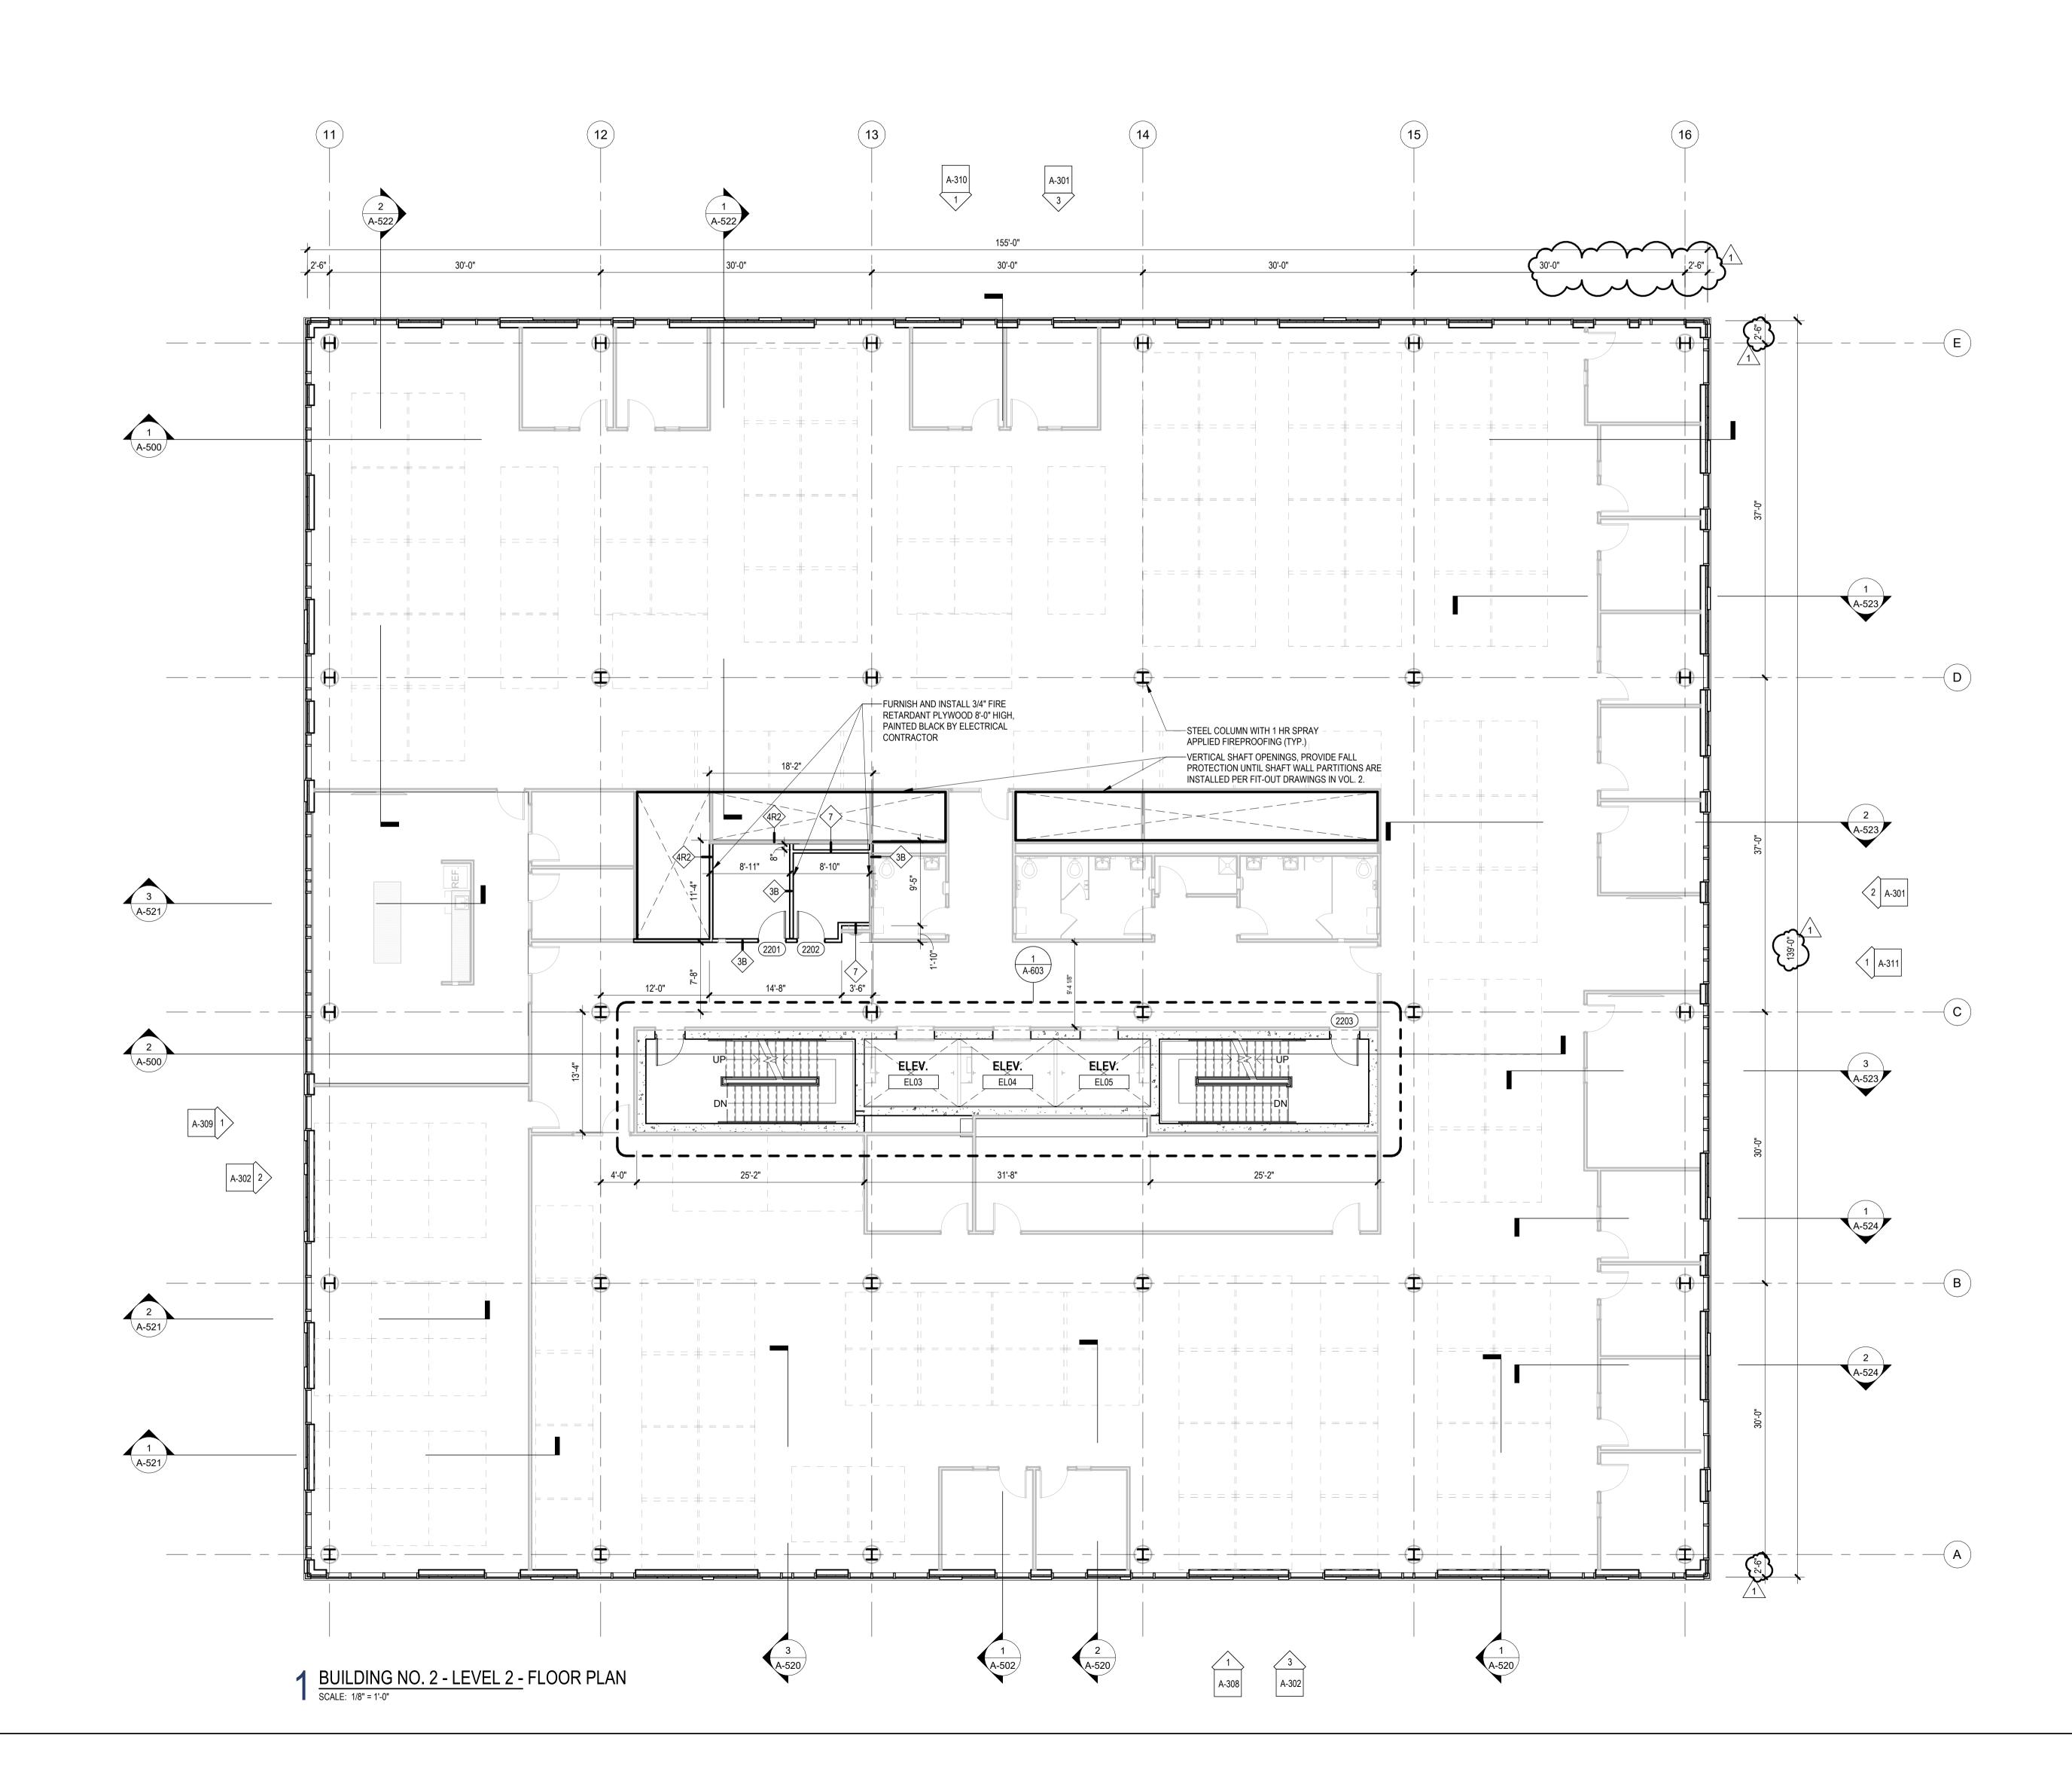

(000A)

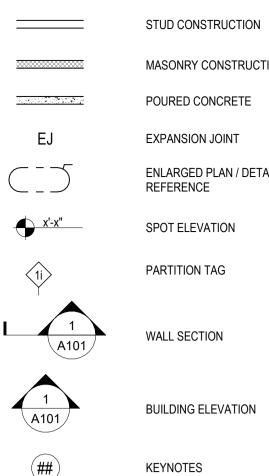MASONRY CONSTRUCTION POURED CONCRETE EXPANSION JOINT ENLARGED PLAN / DETAIL REFERENCE

SPOT ELEVATION PARTITION TAG

WALL SECTION

BUILDING ELEVATION

KEYNOTES

DOOR & TAG

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# Jeffrey D. Venezia, AIA NJ RA AI 00827100

1 12.01.2023 Addendum No. 01 11.08.2023 For Public Bid No. Date Description

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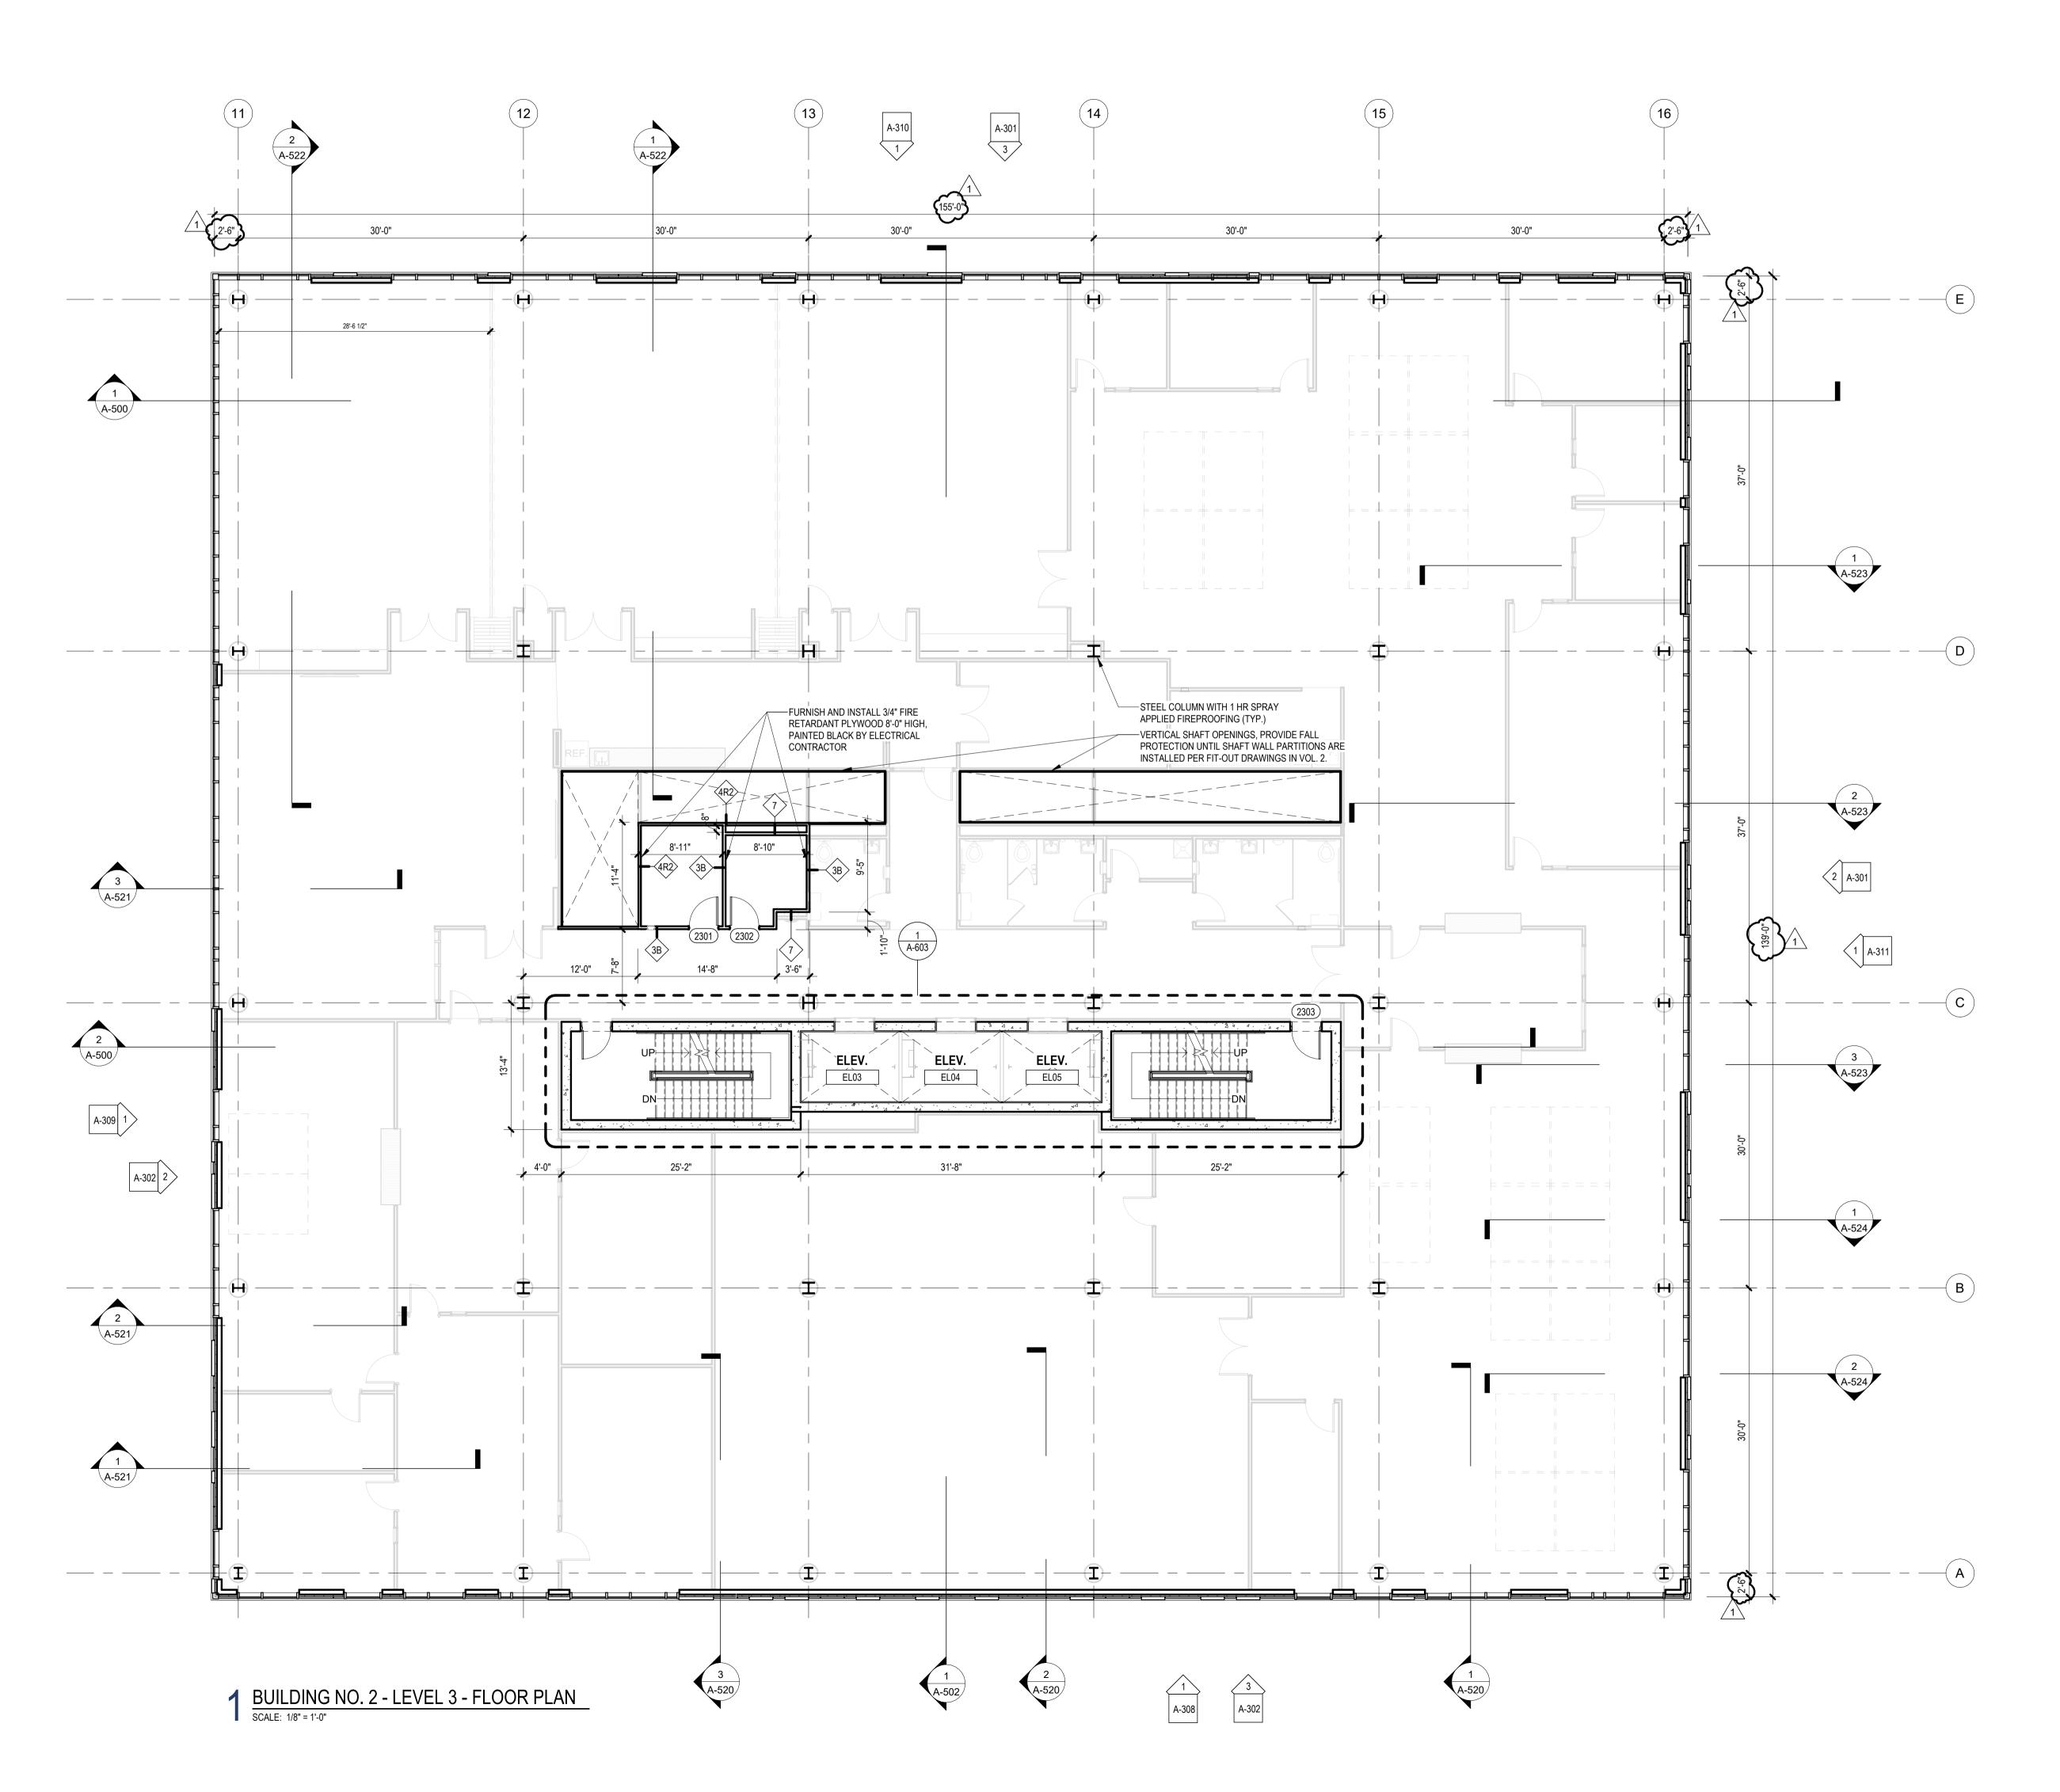
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## **GENERAL NOTES:**

A. INTERIOR FIT-OUT PARTITIONS SHOWN IN BACKGROUND OF CORE AND SHELL DOCUMENTS ARE FOR REFERENCE PURPOSES


B. CONTRACTOR SHALL EXCLUDE INSTALLATION OF GYPSUM BOARD FINISH ONLY ON INTERIOR SIDE OF ALL EXTERIOR PARTITIONS, TYPICAL THROUGHOUT. INSIDE FACE OF METAL STUD SHALL BE EXPOSED DURING CORE AND SHELL CONSTRUCTION IN PREPARATION FOR INTERIOR FIT-OUT.

- C. SEE DRAWINGS G-013 AND G-014 FOR PARTITION TYPES. PROVIDE GYPSUM BOARD FINISH ONLY ON INTERIOR SIDE OF ALL ELECTRIC / IT ROOMS, TYPICAL THROUGHOUT FOR PARTITION TYPE 3B. OUTSIDE FACE OF METAL STUD SHALL BE EXPOSED DURING CORE AND SHELL CONSTRUCTION IN PREPARATION FOR INTERIOR FIT-OUT.
- D. SEE CS-300 SERIES DRAWINGS FOR ALL SLAB EDGE PLANS
- E. SEE A-400 SERIES DRAWINGS FOR ENLARGED FLOOR PLANS
- F. SEE A-450 SERIES DRAWINGS FOR ENLARGED CURTAIN WALL ELEVATIONS
- G. SEE ELECTRIC DRAWINGS FOR COORDINATION OF POWER REQUIREMENTS AT ALL ELECTRIC ROOMSH. SEE PLUMBING DRAWINGS FOR COORDINATION OF VERTICAL PIPING
- I. SEE MECHANICAL DRAWINGS FOR COORDINATION OF DUCTWORK
- J. SEE TELE/ DATA DRAWINGS FOR COORDINATION OF LOW VOLTAGE REQUIREMENTS AT ALL MDF / IDF ROOMS
- K. FOR TYPICAL ARCHITECTURAL SITE FEATURES, REFER TO DETAILS ON A-536.





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Drawing Information	ation:
Date:	20.072 11.08.2023 JB / AV / PC JM / SH
Sheet Name:	
FLOOR F	G NO. 2 - LEVEL 3 - PLAN
Sheet No:	
CS-	113
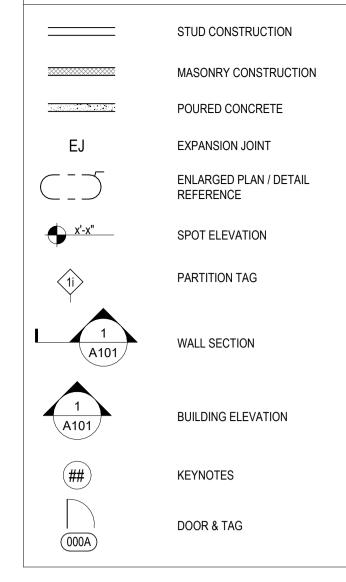
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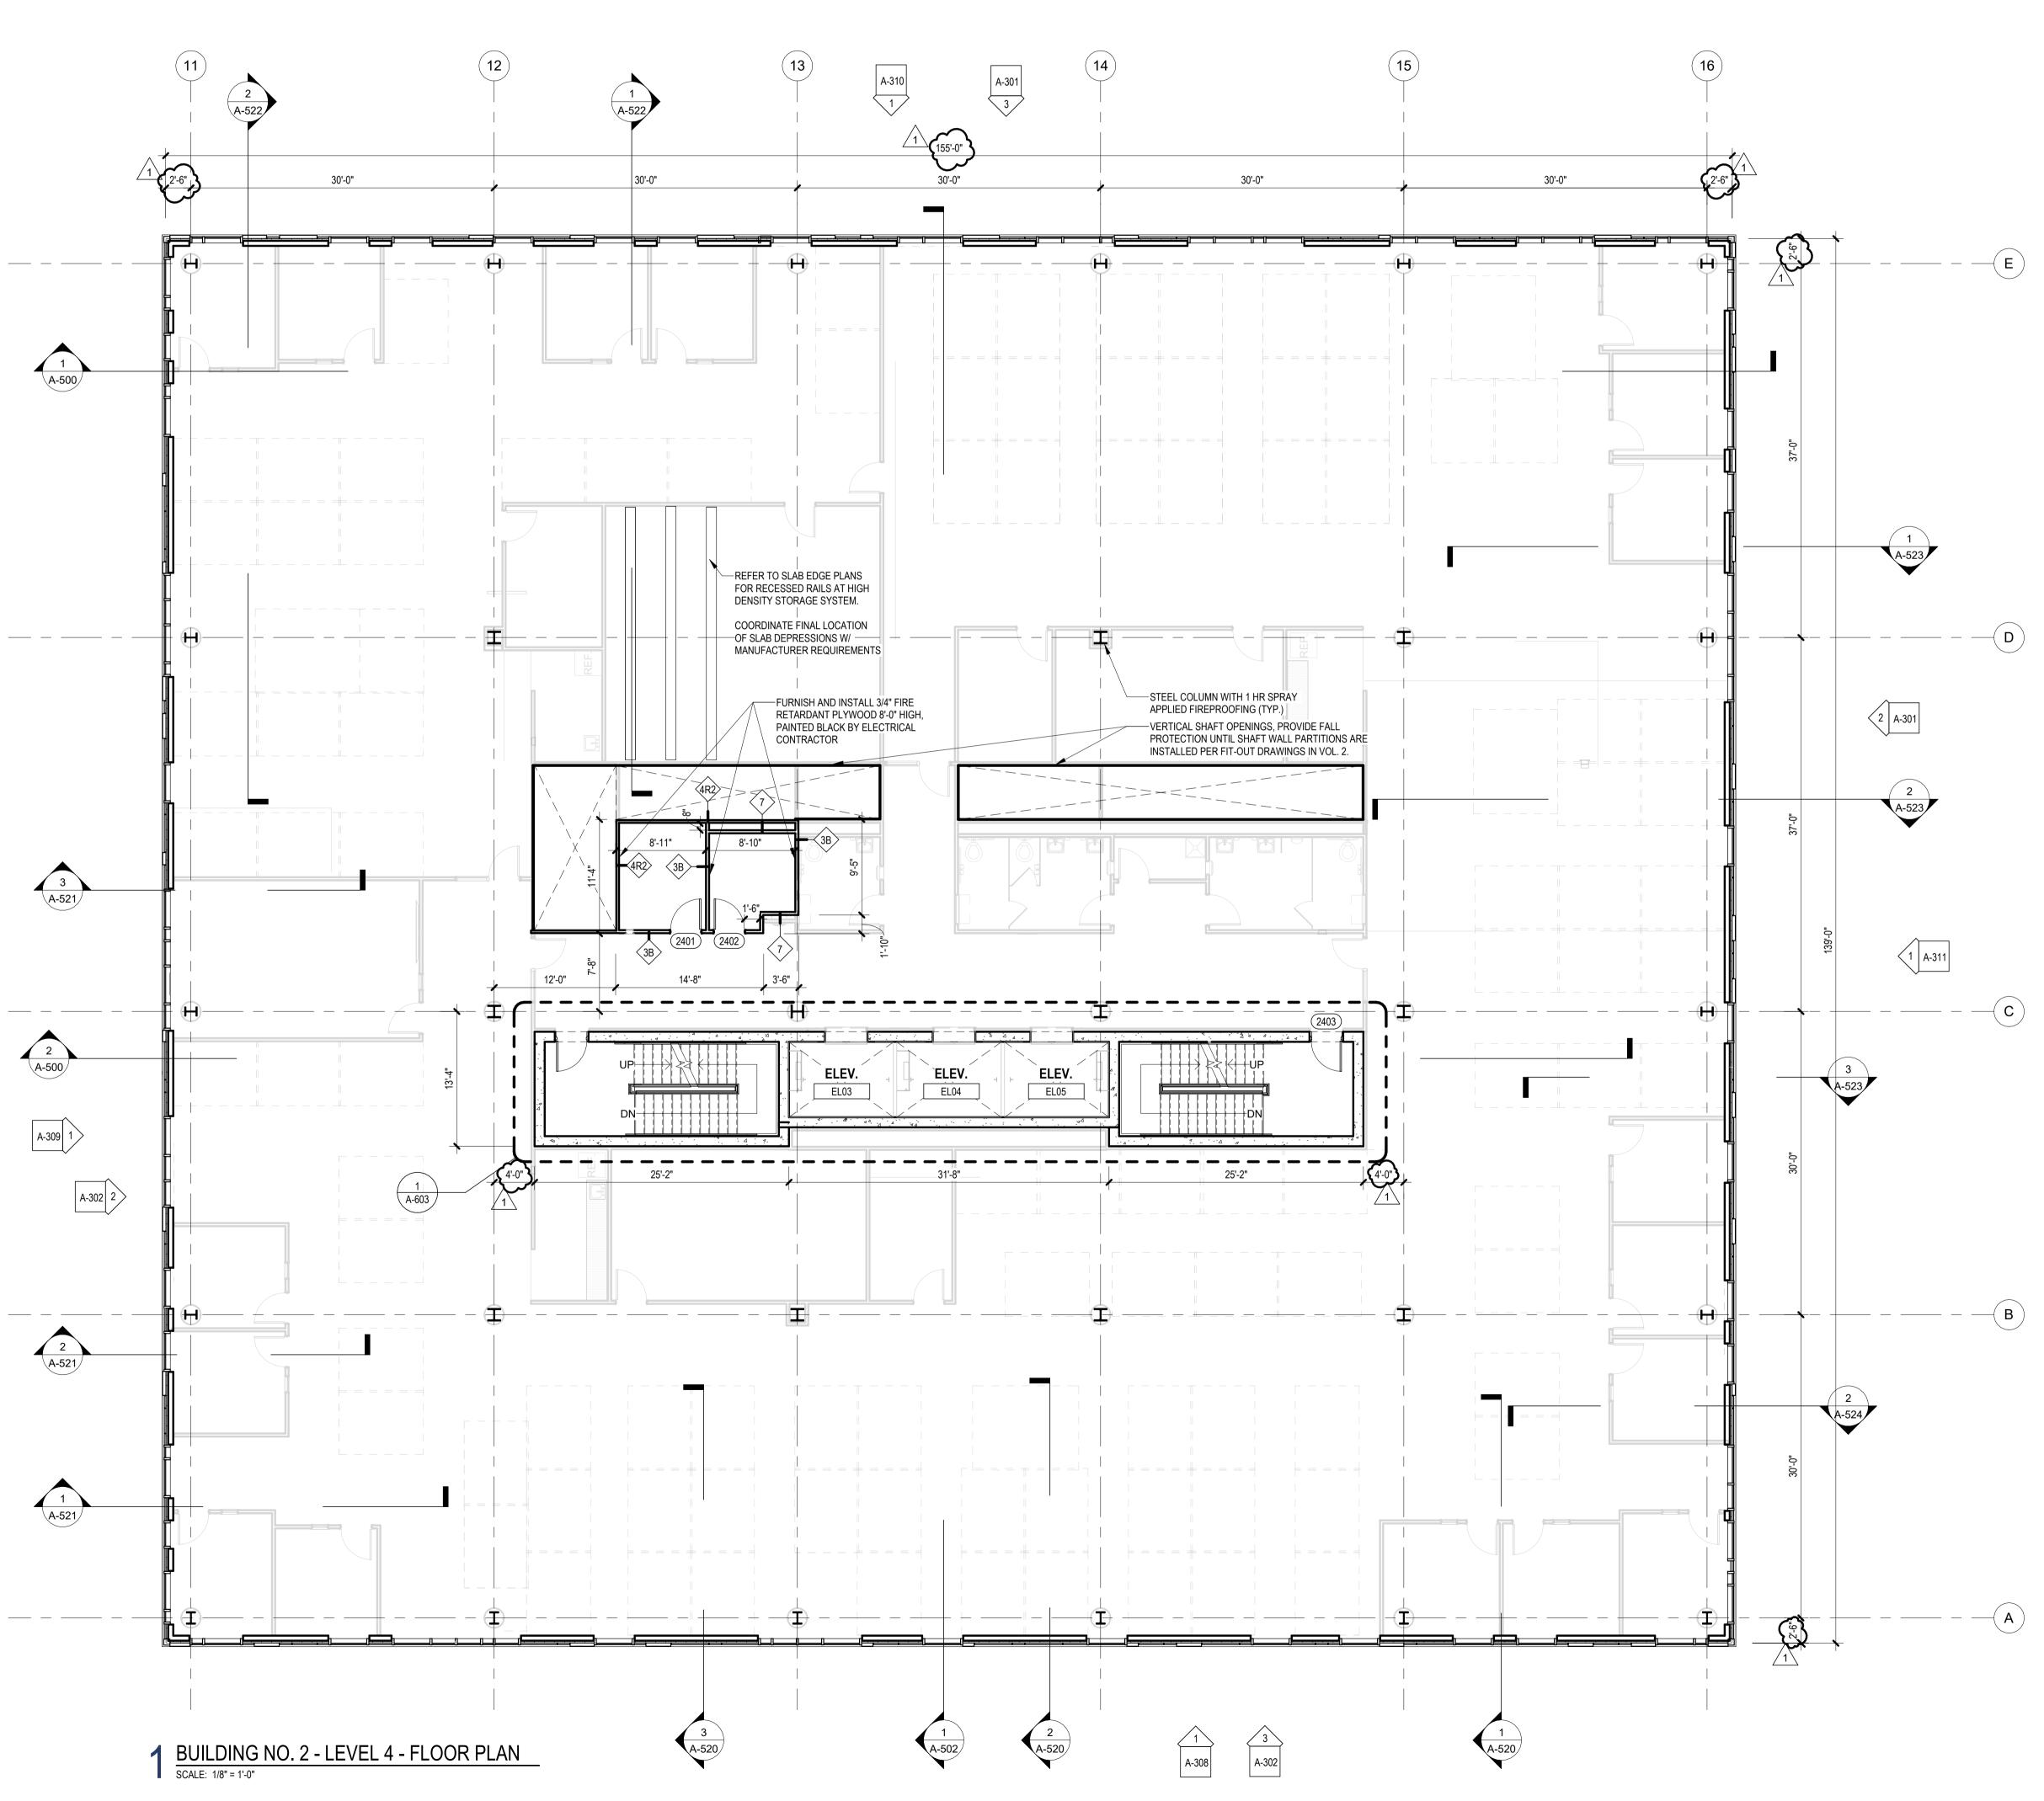
WEST GRAND ST.

## **GENERAL NOTES:**


A. INTERIOR FIT-OUT PARTITIONS SHOWN IN BACKGROUND OF CORE AND SHELL DOCUMENTS ARE FOR REFERENCE PURPOSES

B. CONTRACTOR SHALL EXCLUDE INSTALLATION OF GYPSUM BOARD FINISH ONLY ON INTERIOR SIDE OF ALL EXTERIOR PARTITIONS, TYPICAL THROUGHOUT. INSIDE FACE OF METAL STUD SHALL BE EXPOSED DURING CORE AND SHELL CONSTRUCTION IN PREPARATION FOR INTERIOR FIT-OUT.

- C. SEE DRAWINGS G-013 AND G-014 FOR PARTITION TYPES. PROVIDE GYPSUM BOARD FINISH ONLY ON INTERIOR SIDE OF ALL ELECTRIC / IT ROOMS, TYPICAL THROUGHOUT FOR PARTITION TYPE 3B. OUTSIDE FACE OF METAL STUD SHALL BE EXPOSED DURING CORE AND SHELL CONSTRUCTION IN PREPARATION FOR INTERIOR FIT-OUT.
- D. SEE CS-300 SERIES DRAWINGS FOR ALL SLAB EDGE PLANS
- E. SEE A-400 SERIES DRAWINGS FOR ENLARGED FLOOR PLANS
- F. SEE A-450 SERIES DRAWINGS FOR ENLARGED CURTAIN WALL ELEVATIONS
- G. SEE ELECTRIC DRAWINGS FOR COORDINATION OF POWER REQUIREMENTS AT ALL ELECTRIC ROOMS
- H. SEE PLUMBING DRAWINGS FOR COORDINATION OF VERTICAL PIPING
- I. SEE MECHANICAL DRAWINGS FOR COORDINATION OF DUCTWORK J. SEE TELE/ DATA DRAWINGS FOR COORDINATION OF LOW VOLTAGE REQUIREMENTS AT ALL MDF / IDF ROOMS
- K. FOR TYPICAL ARCHITECTURAL SITE FEATURES, REFER TO DETAILS ON A-536.



## FLOOR PLAN LEGEND

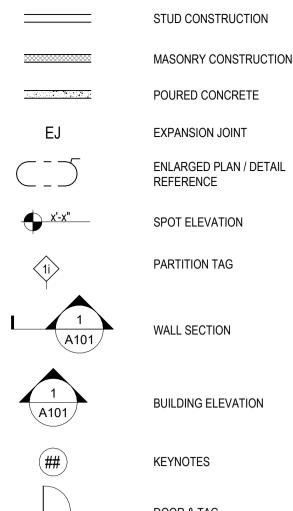

(000A)

MASONRY CONSTRUCTION POURED CONCRETE

EXPANSION JOINT

REFERENCE

DOOR & TAG

oduction or	other use of the	se drawings or	ideas is	prohibited.

OO NOT SCALE. DRAWING MAY BE PRINTED AT REDUCED SCALE. CONSULT WITH ARCHITECT FOR DIMENSIONS.
Client:
JNION COUNTY IMPROVEMENT AUTHORITY
Project:
JNION COUNTY GOVERNMENT COMPLEX 31 & 93 WEST GRAND STREET CITY OF ELIZABETH NEW JERSEY, 07202
Drawing Information:
Project No: 20.072 Date: 11.08.2023 Drawn By: JB / AV / PC Checked By: JM / SH
Sheet Name:
BUILDING NO. 2 - LEVEL 4 - FLOOR PLAN
CS-114


# Jeffrey D. Venezia, AIA NJ RA AI 00827100


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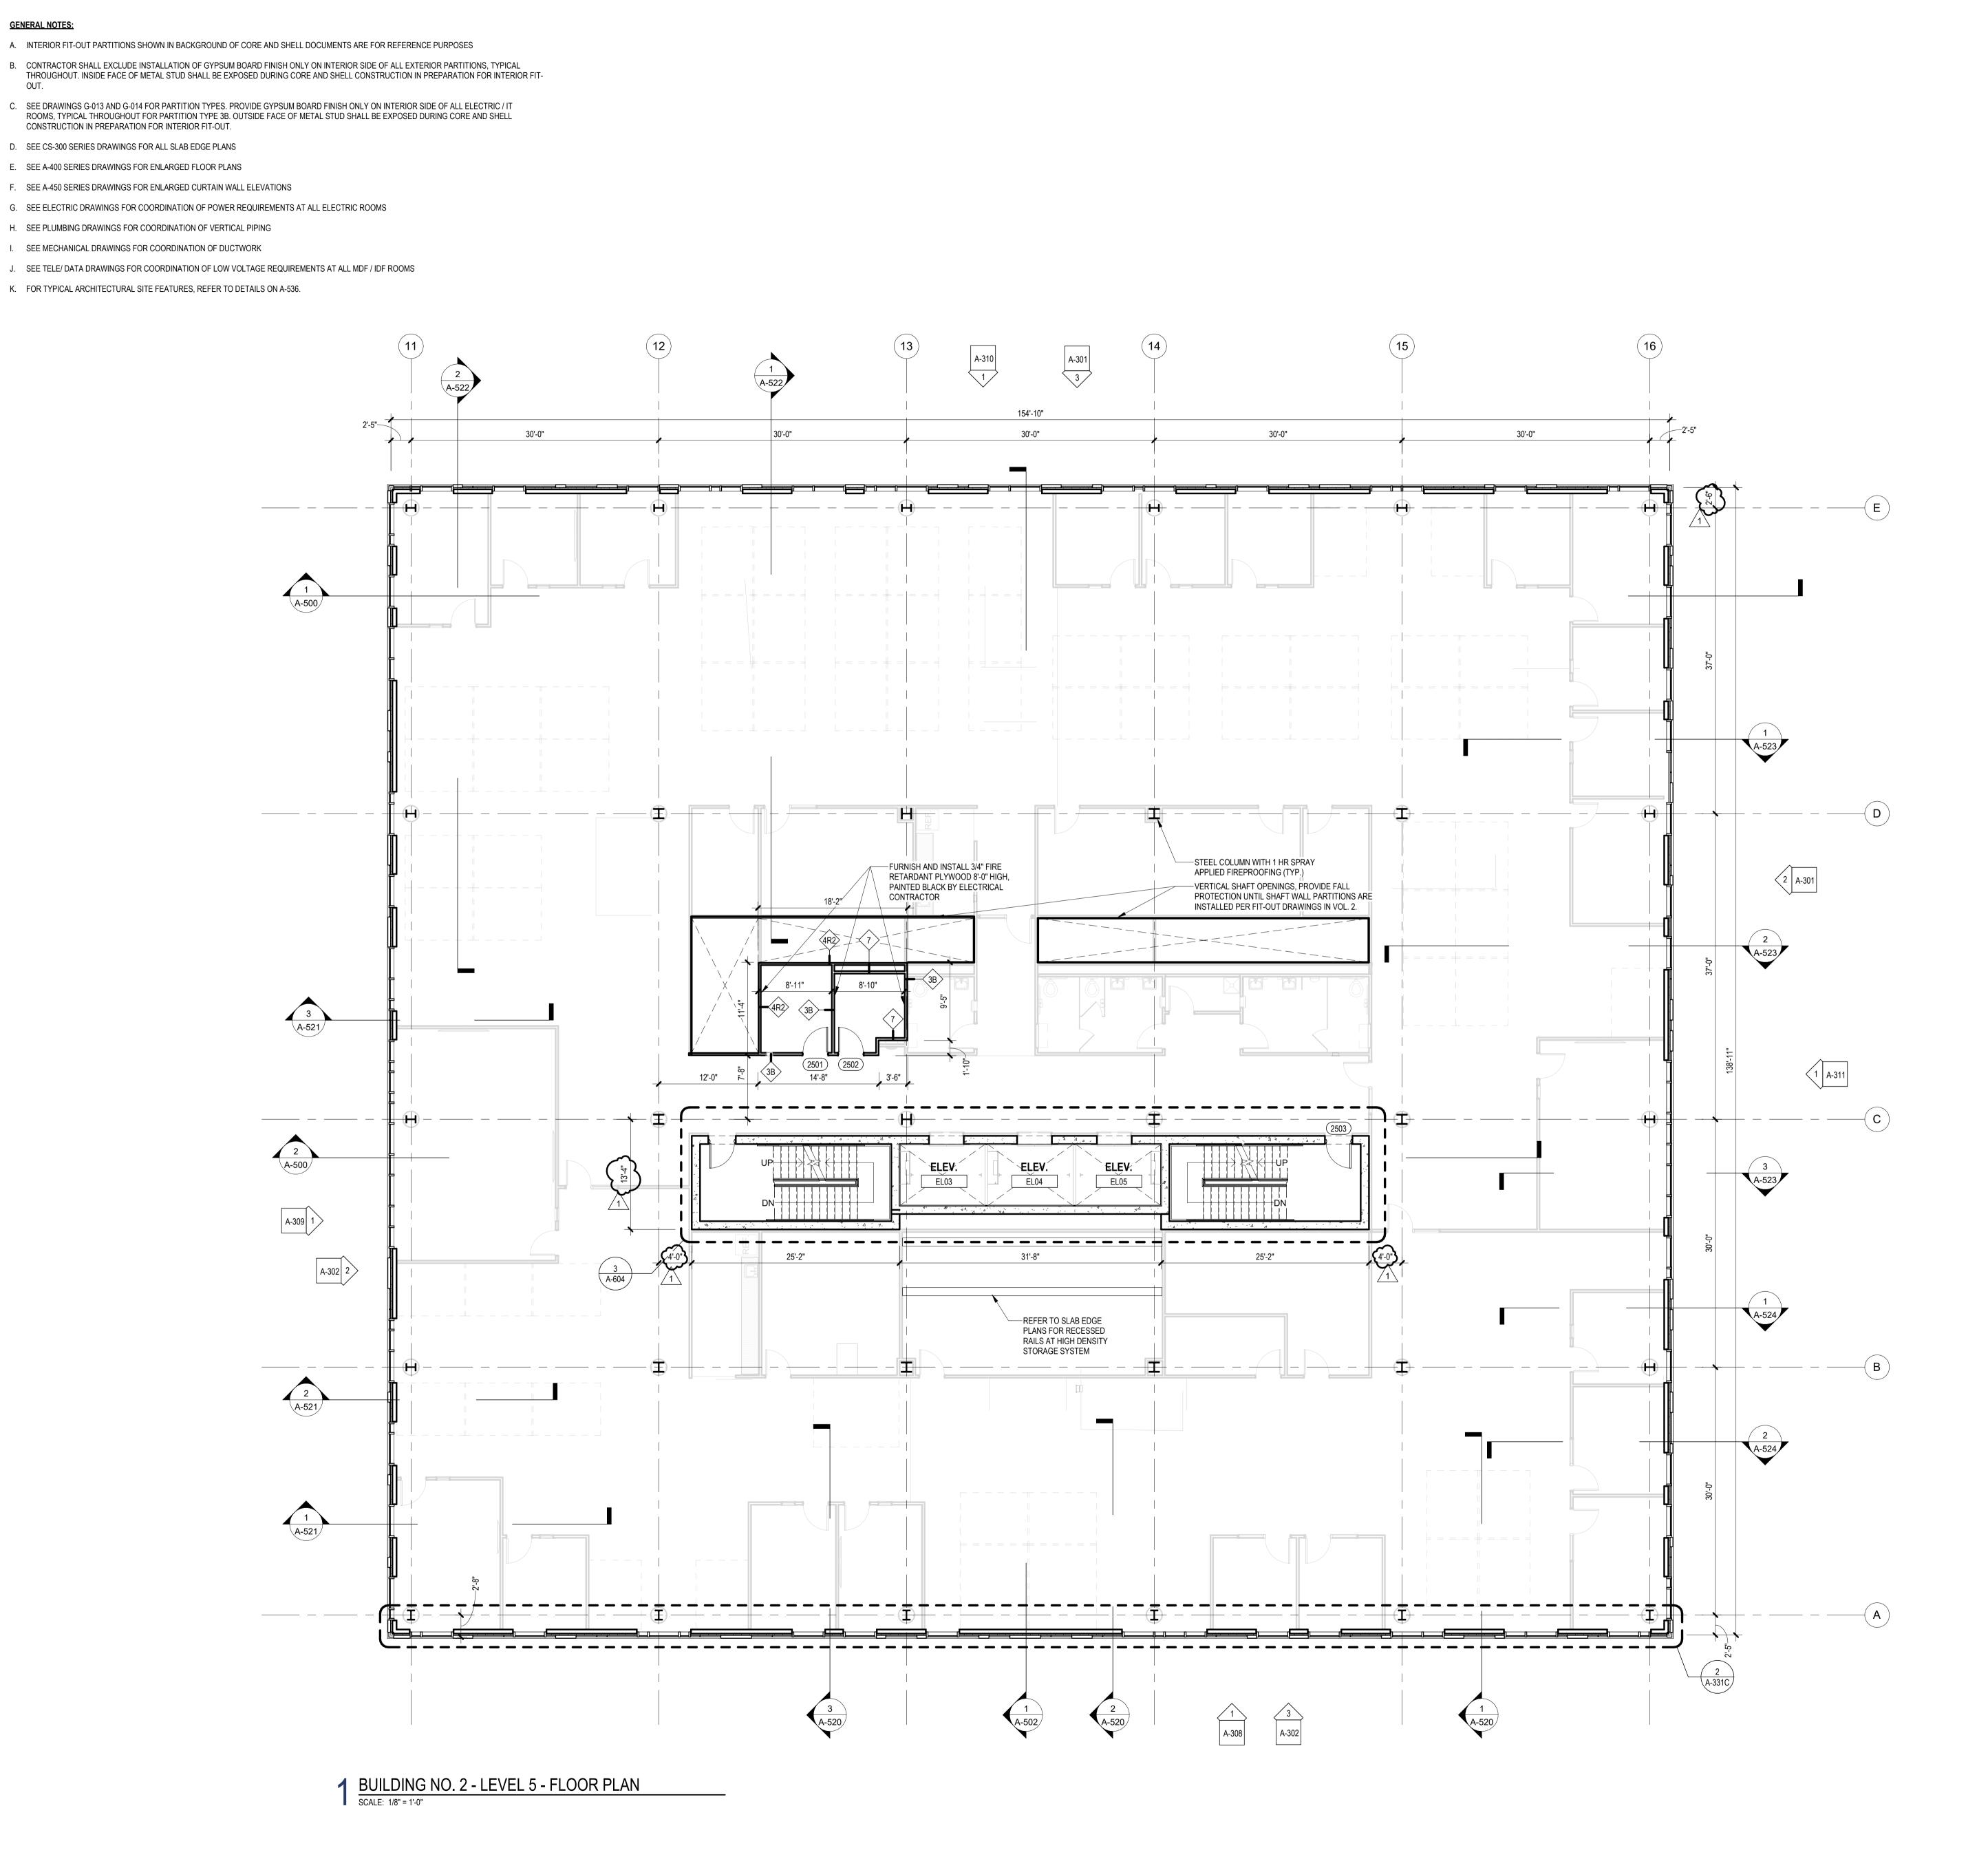
 1
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 Addendum No. 01

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 For Public Bid

No. Date Description



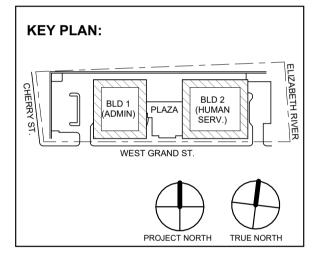

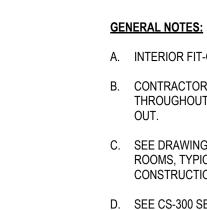

### FLOOR PLAN LEGEND \_\_\_\_\_ STUD CONSTRUCTION MASONRY CONSTRUCTION POURED CONCRETE EJ EXPANSION JOINT $\sim - - \overline{}$ ENLARGED PLAN / DETAIL REFERENCE <u>x'-x"</u> SPOT ELEVATION (1i) PARTITION TAG WALL SECTION A101 **BUILDING ELEVATION** A101 (##) KEYNOTES DOOR & TAG (000A)

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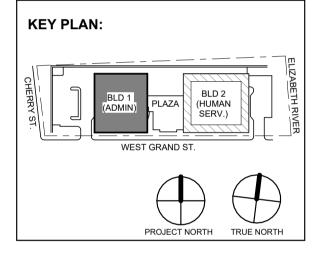
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CS-'	115

# Jeffrey D. Venezia, AIA NJ RA AI 00827100

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1 12.01.2023 Addendum No. 01 11.08.2023 For Public Bid

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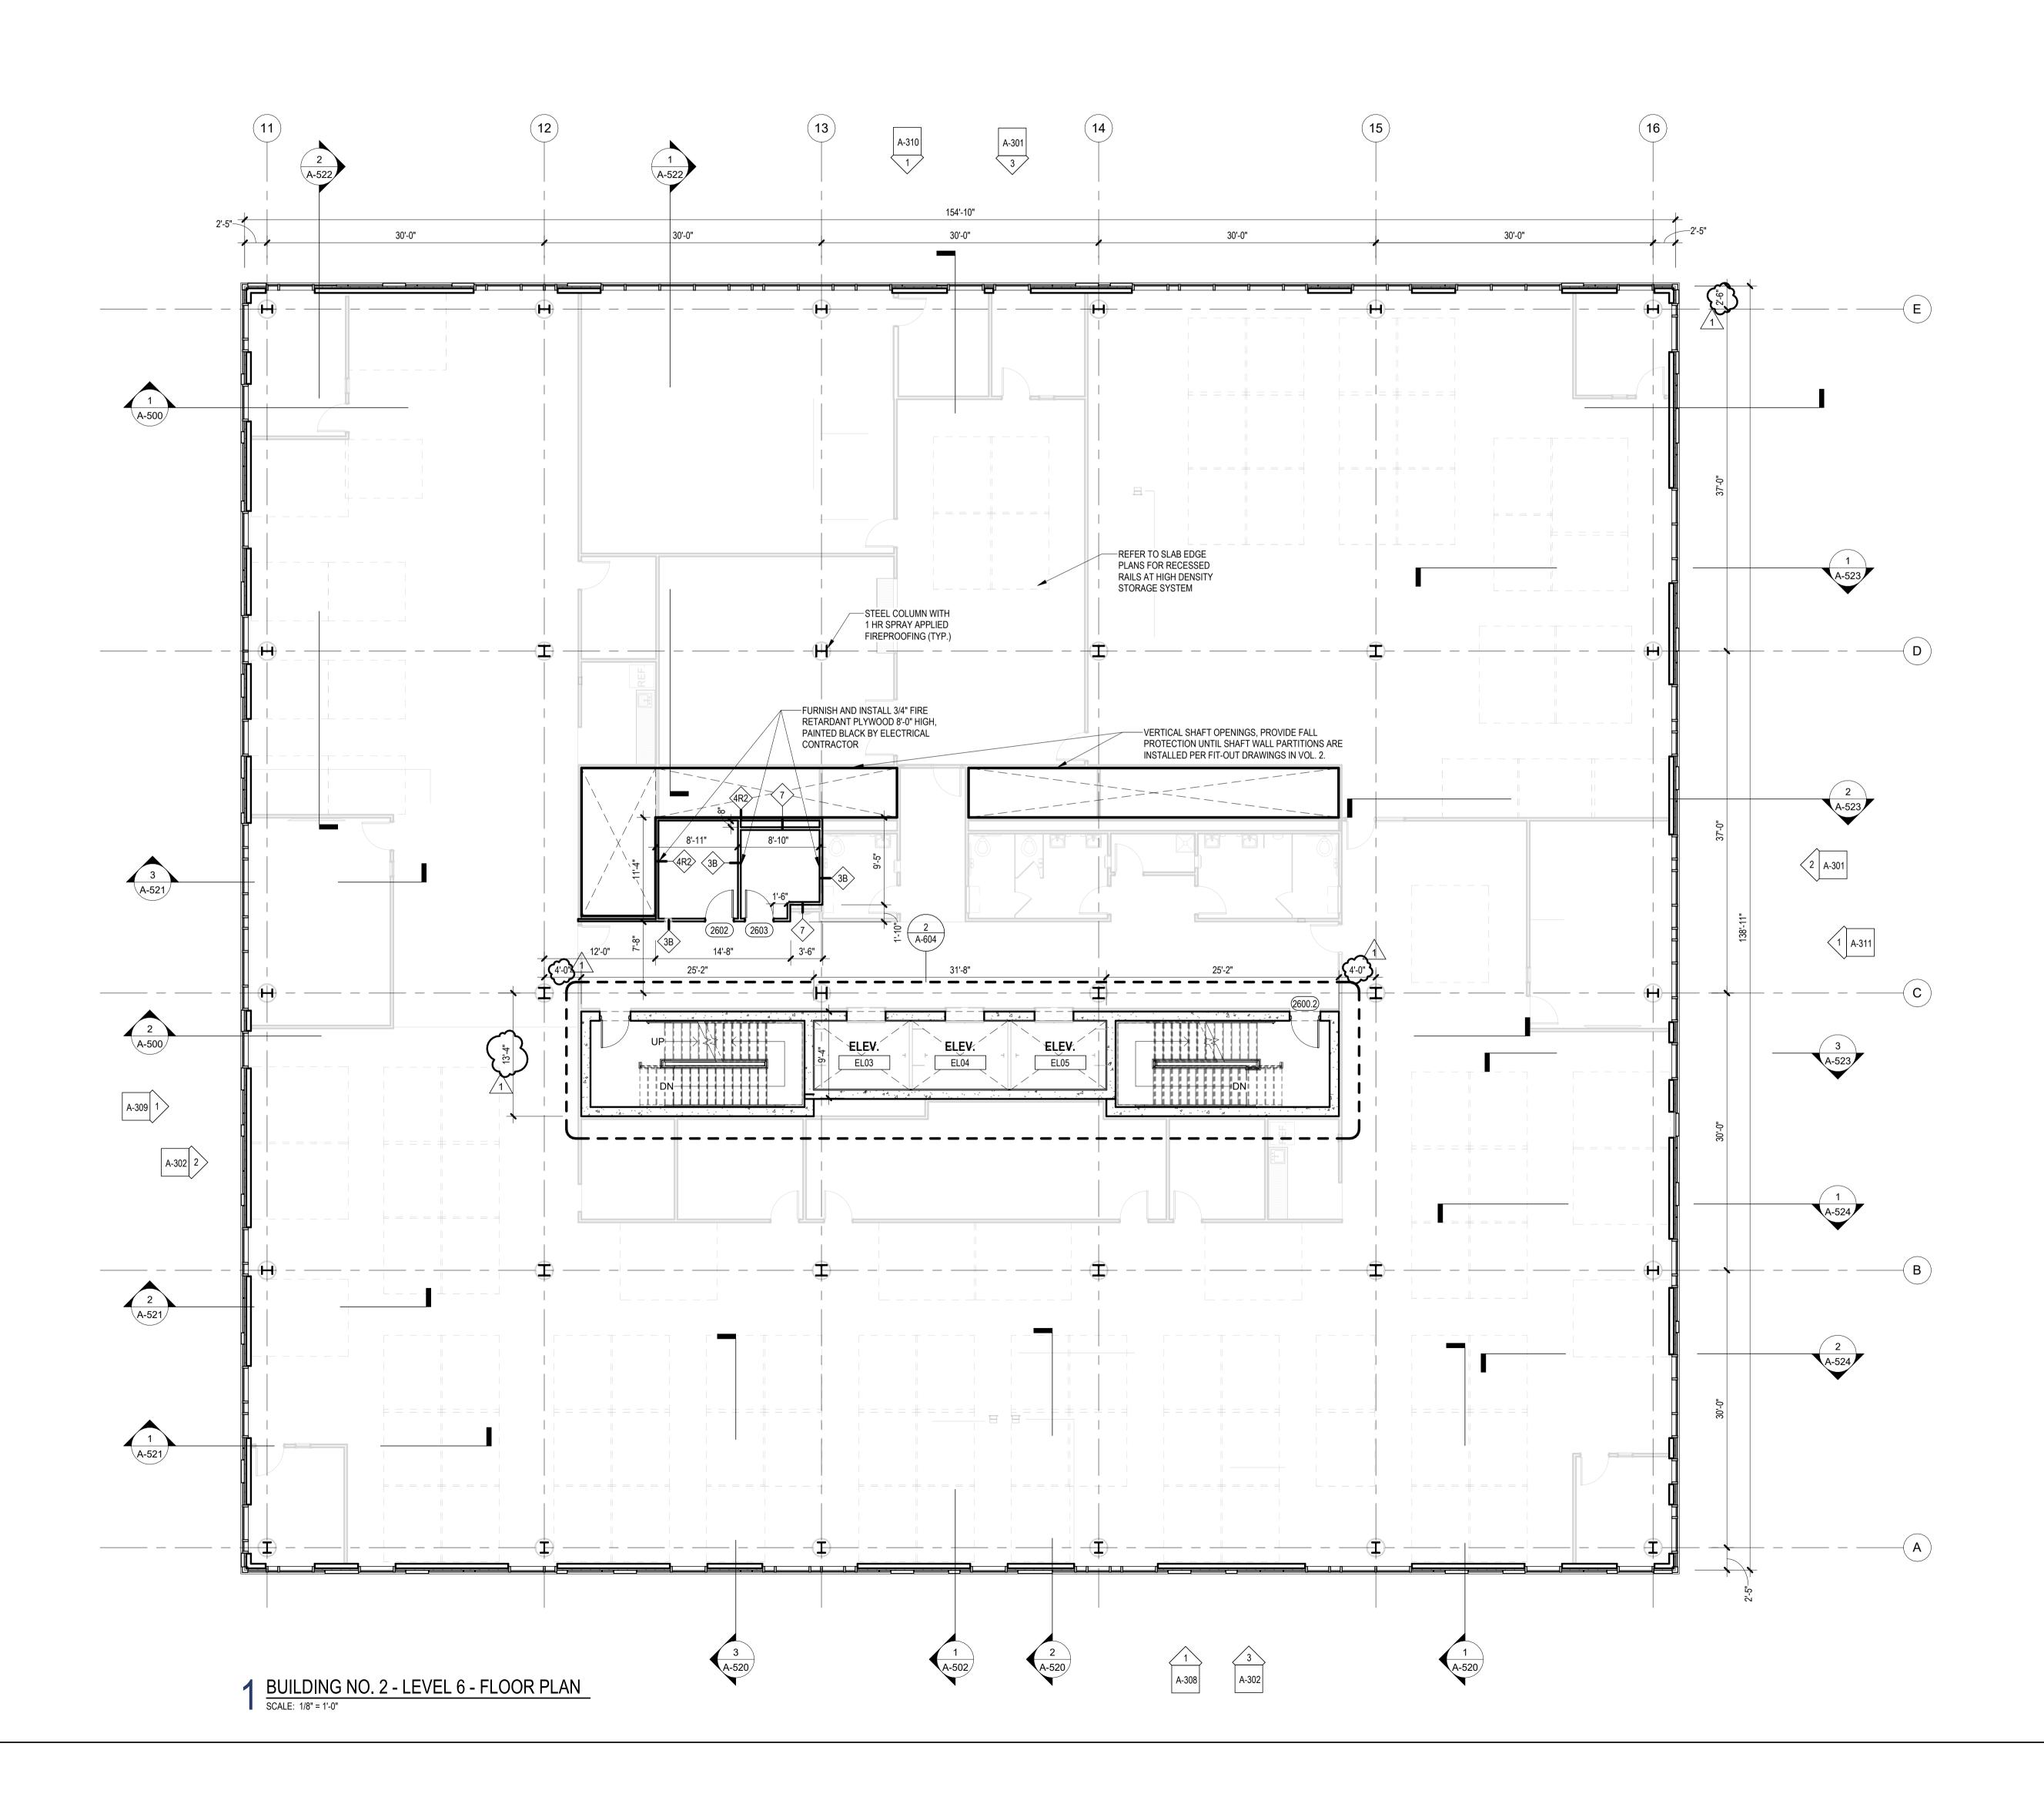


### GENERAL NOTES:

A. INTERIOR FIT-OUT PARTITIONS SHOWN IN BACKGROUND OF CORE AND SHELL DOCUMENTS ARE FOR REFERENCE PURPOSES

B. CONTRACTOR SHALL EXCLUDE INSTALLATION OF GYPSUM BOARD FINISH ONLY ON INTERIOR SIDE OF ALL EXTERIOR PARTITIONS, TYPICAL THROUGHOUT. INSIDE FACE OF METAL STUD SHALL BE EXPOSED DURING CORE AND SHELL CONSTRUCTION IN PREPARATION FOR INTERIOR FIT-OUT.

- C. SEE DRAWINGS G-013 AND G-014 FOR PARTITION TYPES. PROVIDE GYPSUM BOARD FINISH ONLY ON INTERIOR SIDE OF ALL ELECTRIC / IT ROOMS, TYPICAL THROUGHOUT FOR PARTITION TYPE 3B. OUTSIDE FACE OF METAL STUD SHALL BE EXPOSED DURING CORE AND SHELL CONSTRUCTION IN PREPARATION FOR INTERIOR FIT-OUT.
- D. SEE CS-300 SERIES DRAWINGS FOR ALL SLAB EDGE PLANS
- E. SEE A-400 SERIES DRAWINGS FOR ENLARGED FLOOR PLANS
- F. SEE A-450 SERIES DRAWINGS FOR ENLARGED CURTAIN WALL ELEVATIONS
- G. SEE ELECTRIC DRAWINGS FOR COORDINATION OF POWER REQUIREMENTS AT ALL ELECTRIC ROOMSH. SEE PLUMBING DRAWINGS FOR COORDINATION OF VERTICAL PIPING
- I. SEE MECHANICAL DRAWINGS FOR COORDINATION OF DUCTWORK
- J. SEE TELE/ DATA DRAWINGS FOR COORDINATION OF LOW VOLTAGE REQUIREMENTS AT ALL MDF / IDF ROOMS
- K. FOR TYPICAL ARCHITECTURAL SITE FEATURES, REFER TO DETAILS ON A-536.



# FLOOR PLAN LEGEND

	STUD CONSTRUCTION
	MASONRY CONSTRUCTION
	POURED CONCRETE
EJ	EXPANSION JOINT
$\Box$	ENLARGED PLAN / DETAIL REFERENCE
<b>• • • • • • • • • •</b>	SPOT ELEVATION
< <u>1i</u>	PARTITION TAG
1 A101	WALL SECTION
1 A101	BUILDING ELEVATION
(##)	KEYNOTES
(000A)	DOOR & TAG

oduction or	other use of the	se drawings or	ideas is	prohibited.

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Drawing Information:	
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BUILDING NO. 2 - LEVE	L 6 -
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<b>CS-116</b>	

### Jeffrey D. Venezia, AIA NJ RA AI 00827100

No. Date


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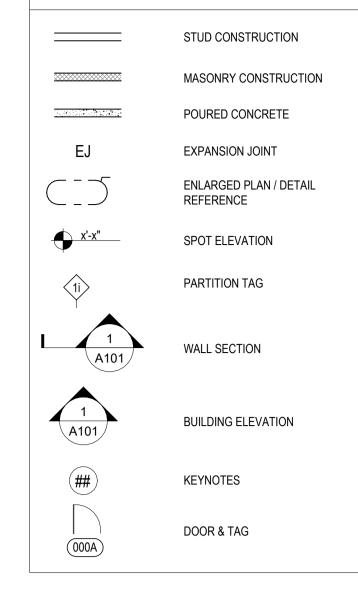
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PROJECT NORTH TRUE NORTH




## FLOOR PLAN LEGEND



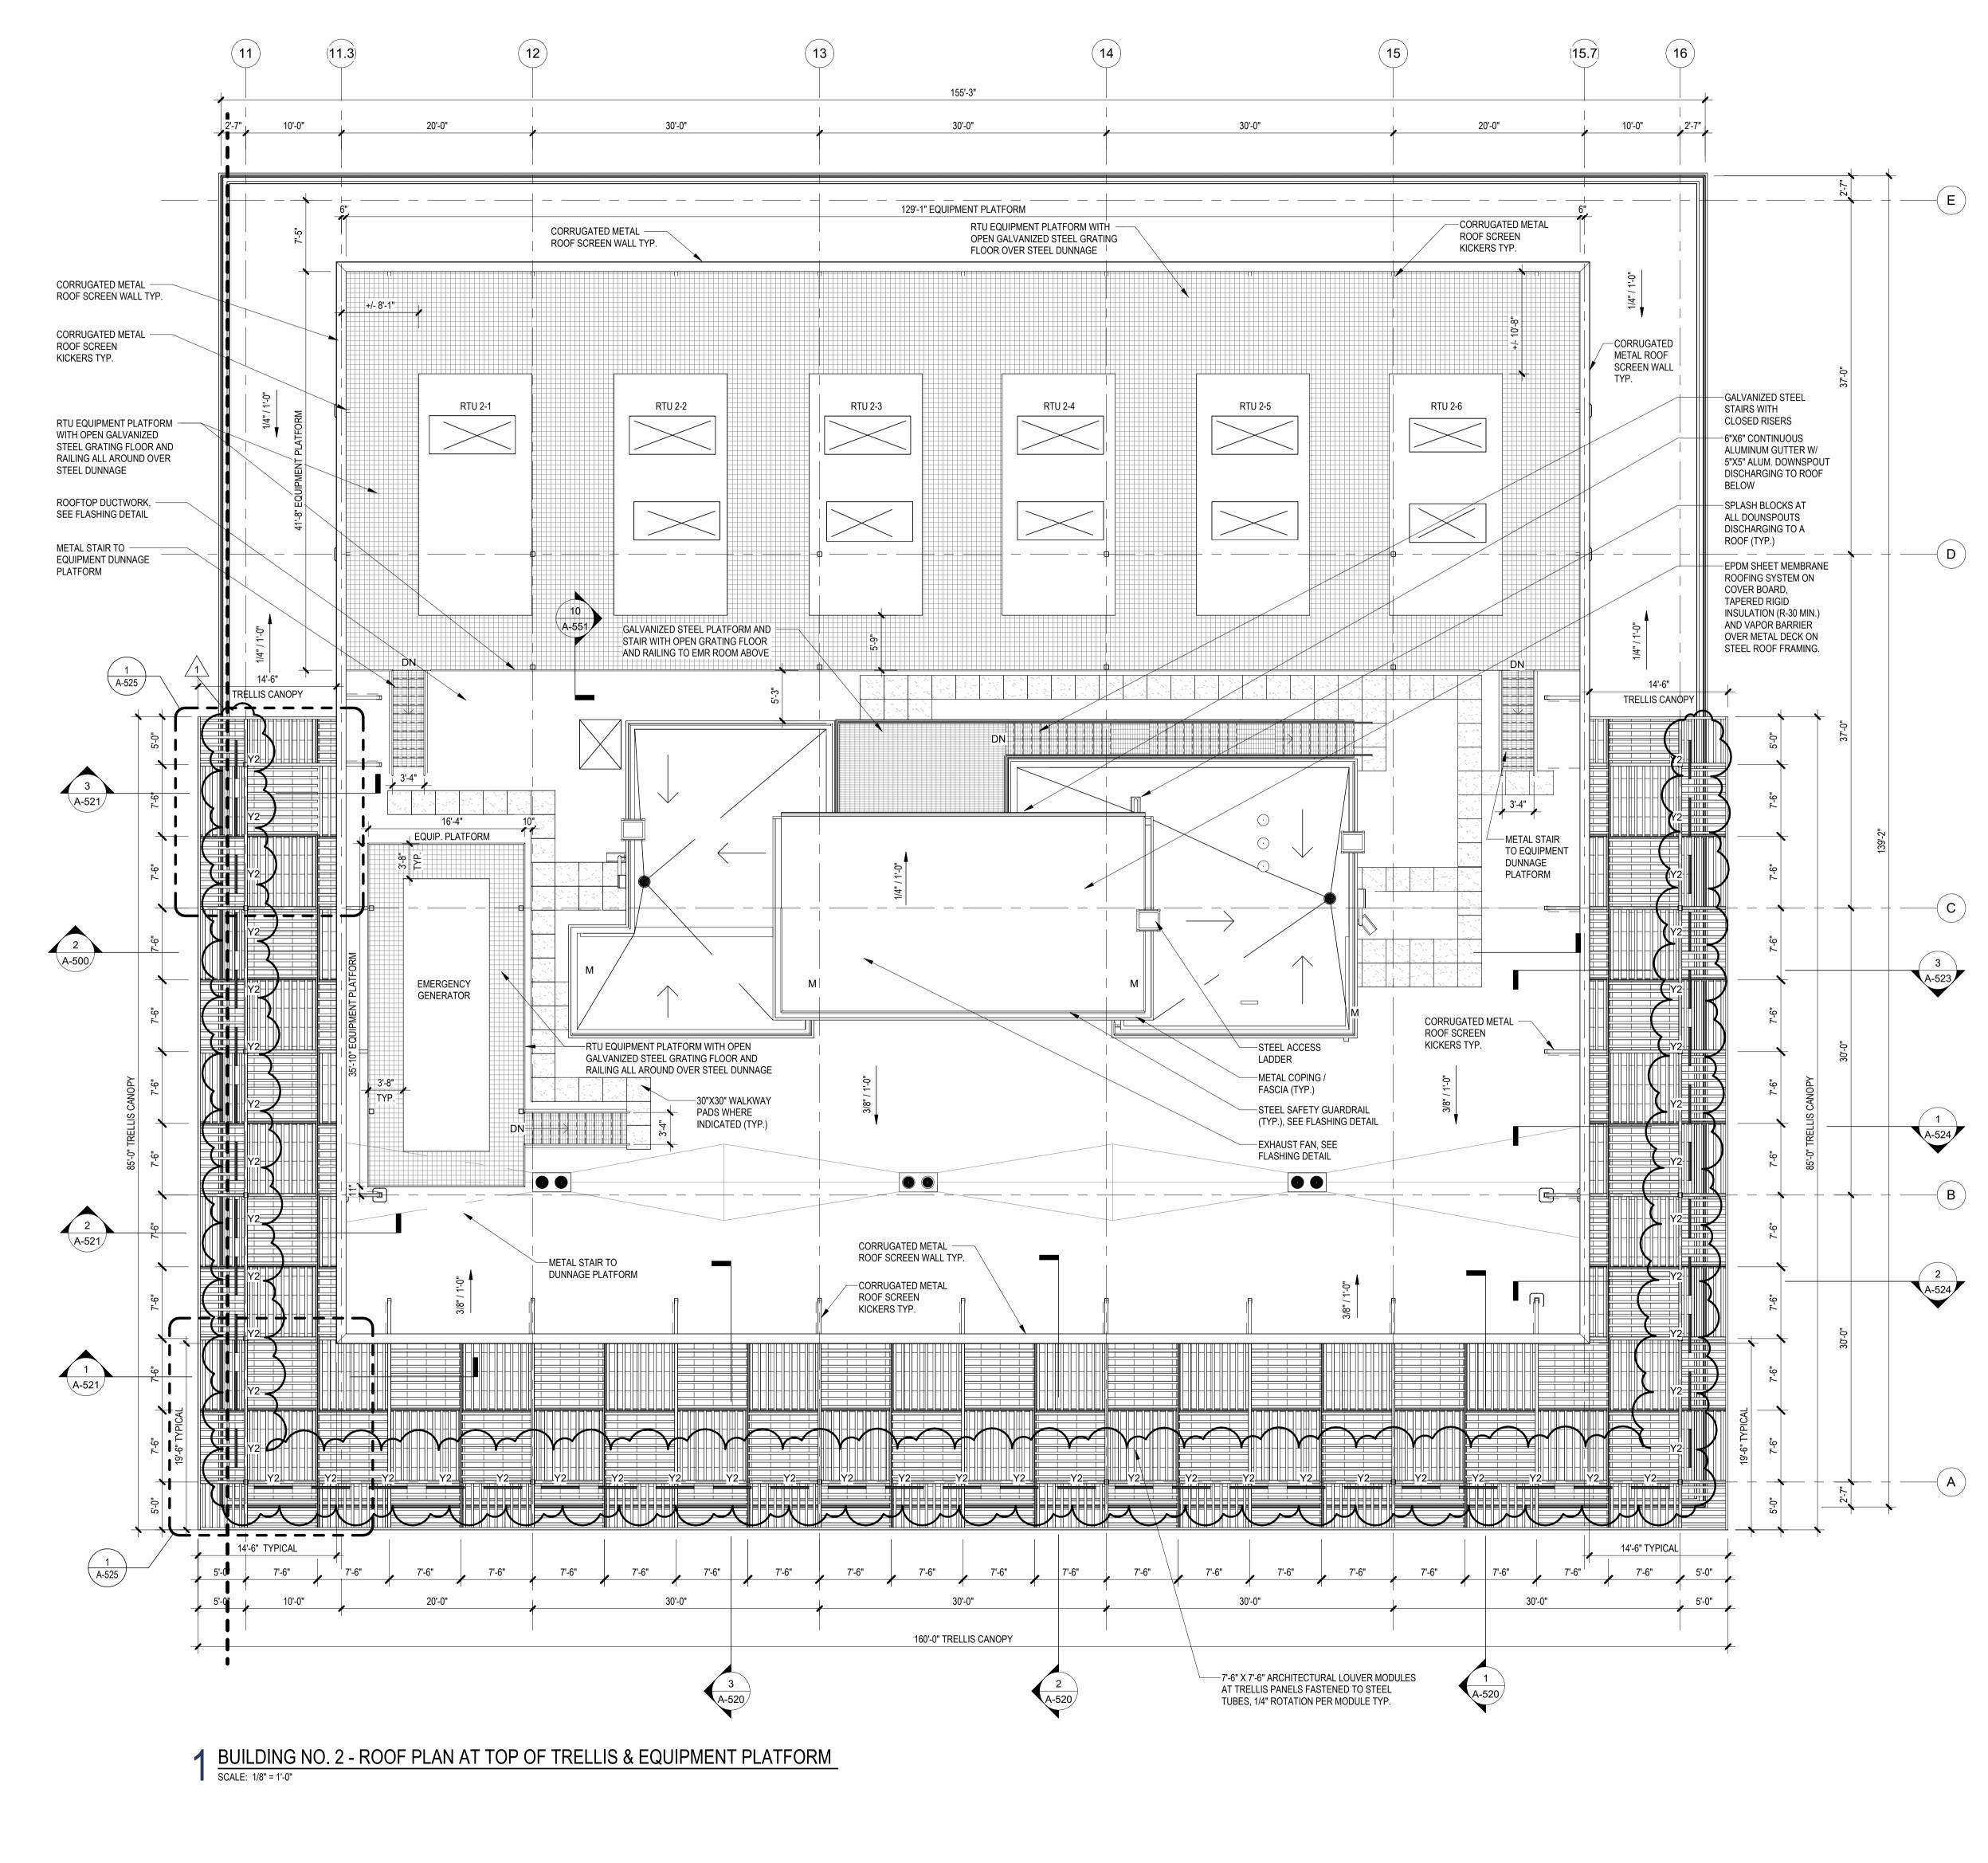

- A. SIZE AND LOCATION OF ROOFTOP UNITS, CONDENSERS, PITCH POCKETS AND OTHER ELECTRICAL, MECHANICAL OR PLUMBING EQUIPMENT INDICATED ON THIS PLAN ARE APPROXIMATE. VERIFY EXACT LOCATIONS IN THE FIELD AND NOTIFY ARCHITECT OF ANY DISCREPANCIES.
- B. COORDINATE ALL ROOF EQUIPMENT SHOWN AND ROOF PENETRATIONS WITH STRUCTURAL ROOF FRAMING PLANS AND MECHANICAL DRAWINGS.
- C. ELEVATIONS SHOWN ARE TO THE TOP OF THE ROOF INSULATION FROM EL. 0'-0"
- D. ALL DIMENSIONS ARE TO COLUMN CENTERLINES (U.O.N.)
- E. ALL DIMENSIONS ARE TO CENTERLINE OF ROOF OPENINGS
- F. MECHANICAL OPENINGS ARE BASED ON SPECIFIED EQUIPMENT, VERIFY ALL OPENING SIZES WITH MECHANICAL CONTRACTOR.
- G. SEE DRAWINGS G-012 AND G-013 FOR PARTITION TYPES.
- H. SEE CS-300 SERIES DRAWINGS FOR ALL SLAB EDGE PLANS FOR SIZE OF ROOF OPENINGS, VERIFY EXACT SIZE WITH MECHANICAL CONTRACTOR.
- I. SEE A-600 SERIES DRAWINGS FOR ENLARGED FLOOR PLANS AT EGRESS STAIRS. J. SEE DRAWINGS A-425 AND A-426 FOR ENLARGED FLOOR PLANS AT PENTHOUSE
- AND EMR.
- K. REFER TO DRAWING A-516 AND A-525 FOR ROOF TRELLIS AND GLASS RAILING DETAILS.
- L. SEE A-550 SERIES DRAWINGS FOR ROOF DETAILS.
- M. THE EXACT SIZE, SHAPE, AND LOCATION OF ALL EQUIPMENT PADS SHALL BE DETERMINED BY THE SIZE OF THE EQUIPMENT. COORDINATE LOCATION AND FINAL SIZE OF CONCRETE PADS WITH EQUIPMENT AND MANUFACTURER PRIOR TO CONSTRUCTION. MAINTAIN 4" MINIMUM OF CONCRETE BEYOND EQUIPMENT ALL AROUND, TYPICAL.
- N. REFER TO MECHANICAL, ELECTRICAL AND PLUMBING DRAWINGS FOR ADDITIONAL INFORMATION.
- O. SEE SPECIFICATIONS SECTION 072100 FOR THERMAL INSULATION.
- P. SEE SPECIFICATIONS SECTION 075323 FOR TYPICAL EPDM MEMBRANE ROOFING AND TYPE & THICKNESS OF ROOFING INSULATION. BASIS OF DESIGN - CARLISLE SYNTEC "SURE-WHITE".
- Q. SEE SPECIFICATIONS SECTION 077100 FOR ROOF SPECIALTIES AND ACCESSORIES, PROVIDE PRESSURE TREATED WOOD BLOCKING AS REQUIRED FOR PROPER ANCHORAGE.

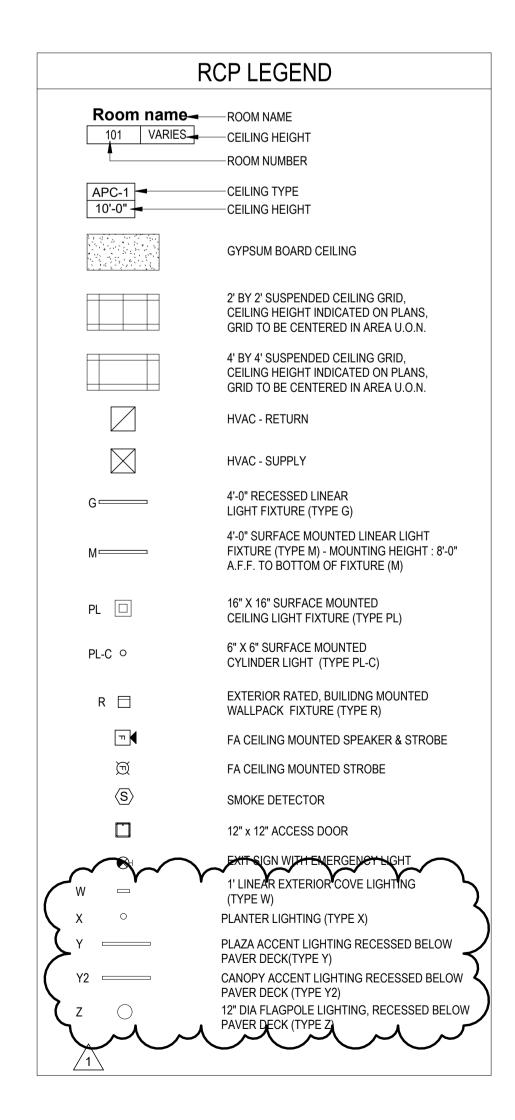

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TOP OF	IG NO. 2 - ROOF PLAN AT TRELLIS AND IENT PLATFORM
CS	-118

### Jeffrey D. Venezia, AIA NJ RÅ AI 00827100

No. Date


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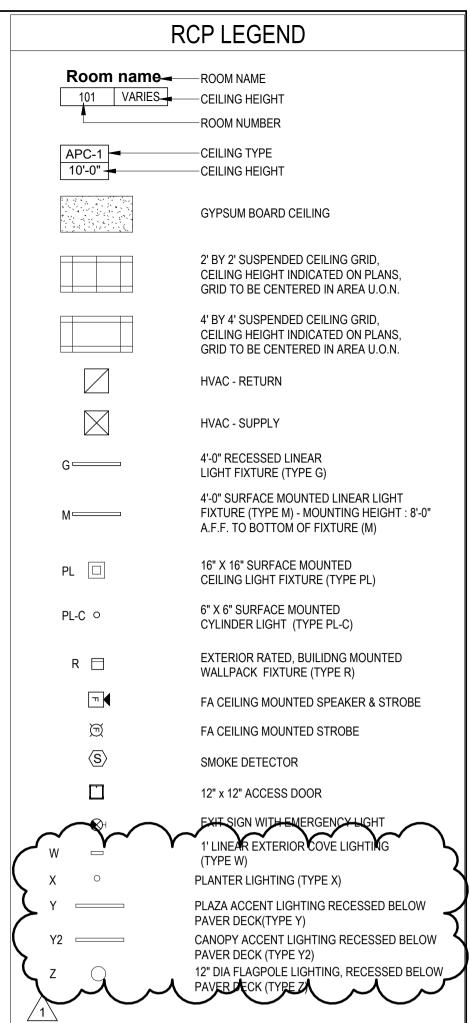
12.01.2023 Addendum No. 01

11.08.2023 For Public Bid

Description

WEST GRAND S PROJECT NORTH TRUE NORTH



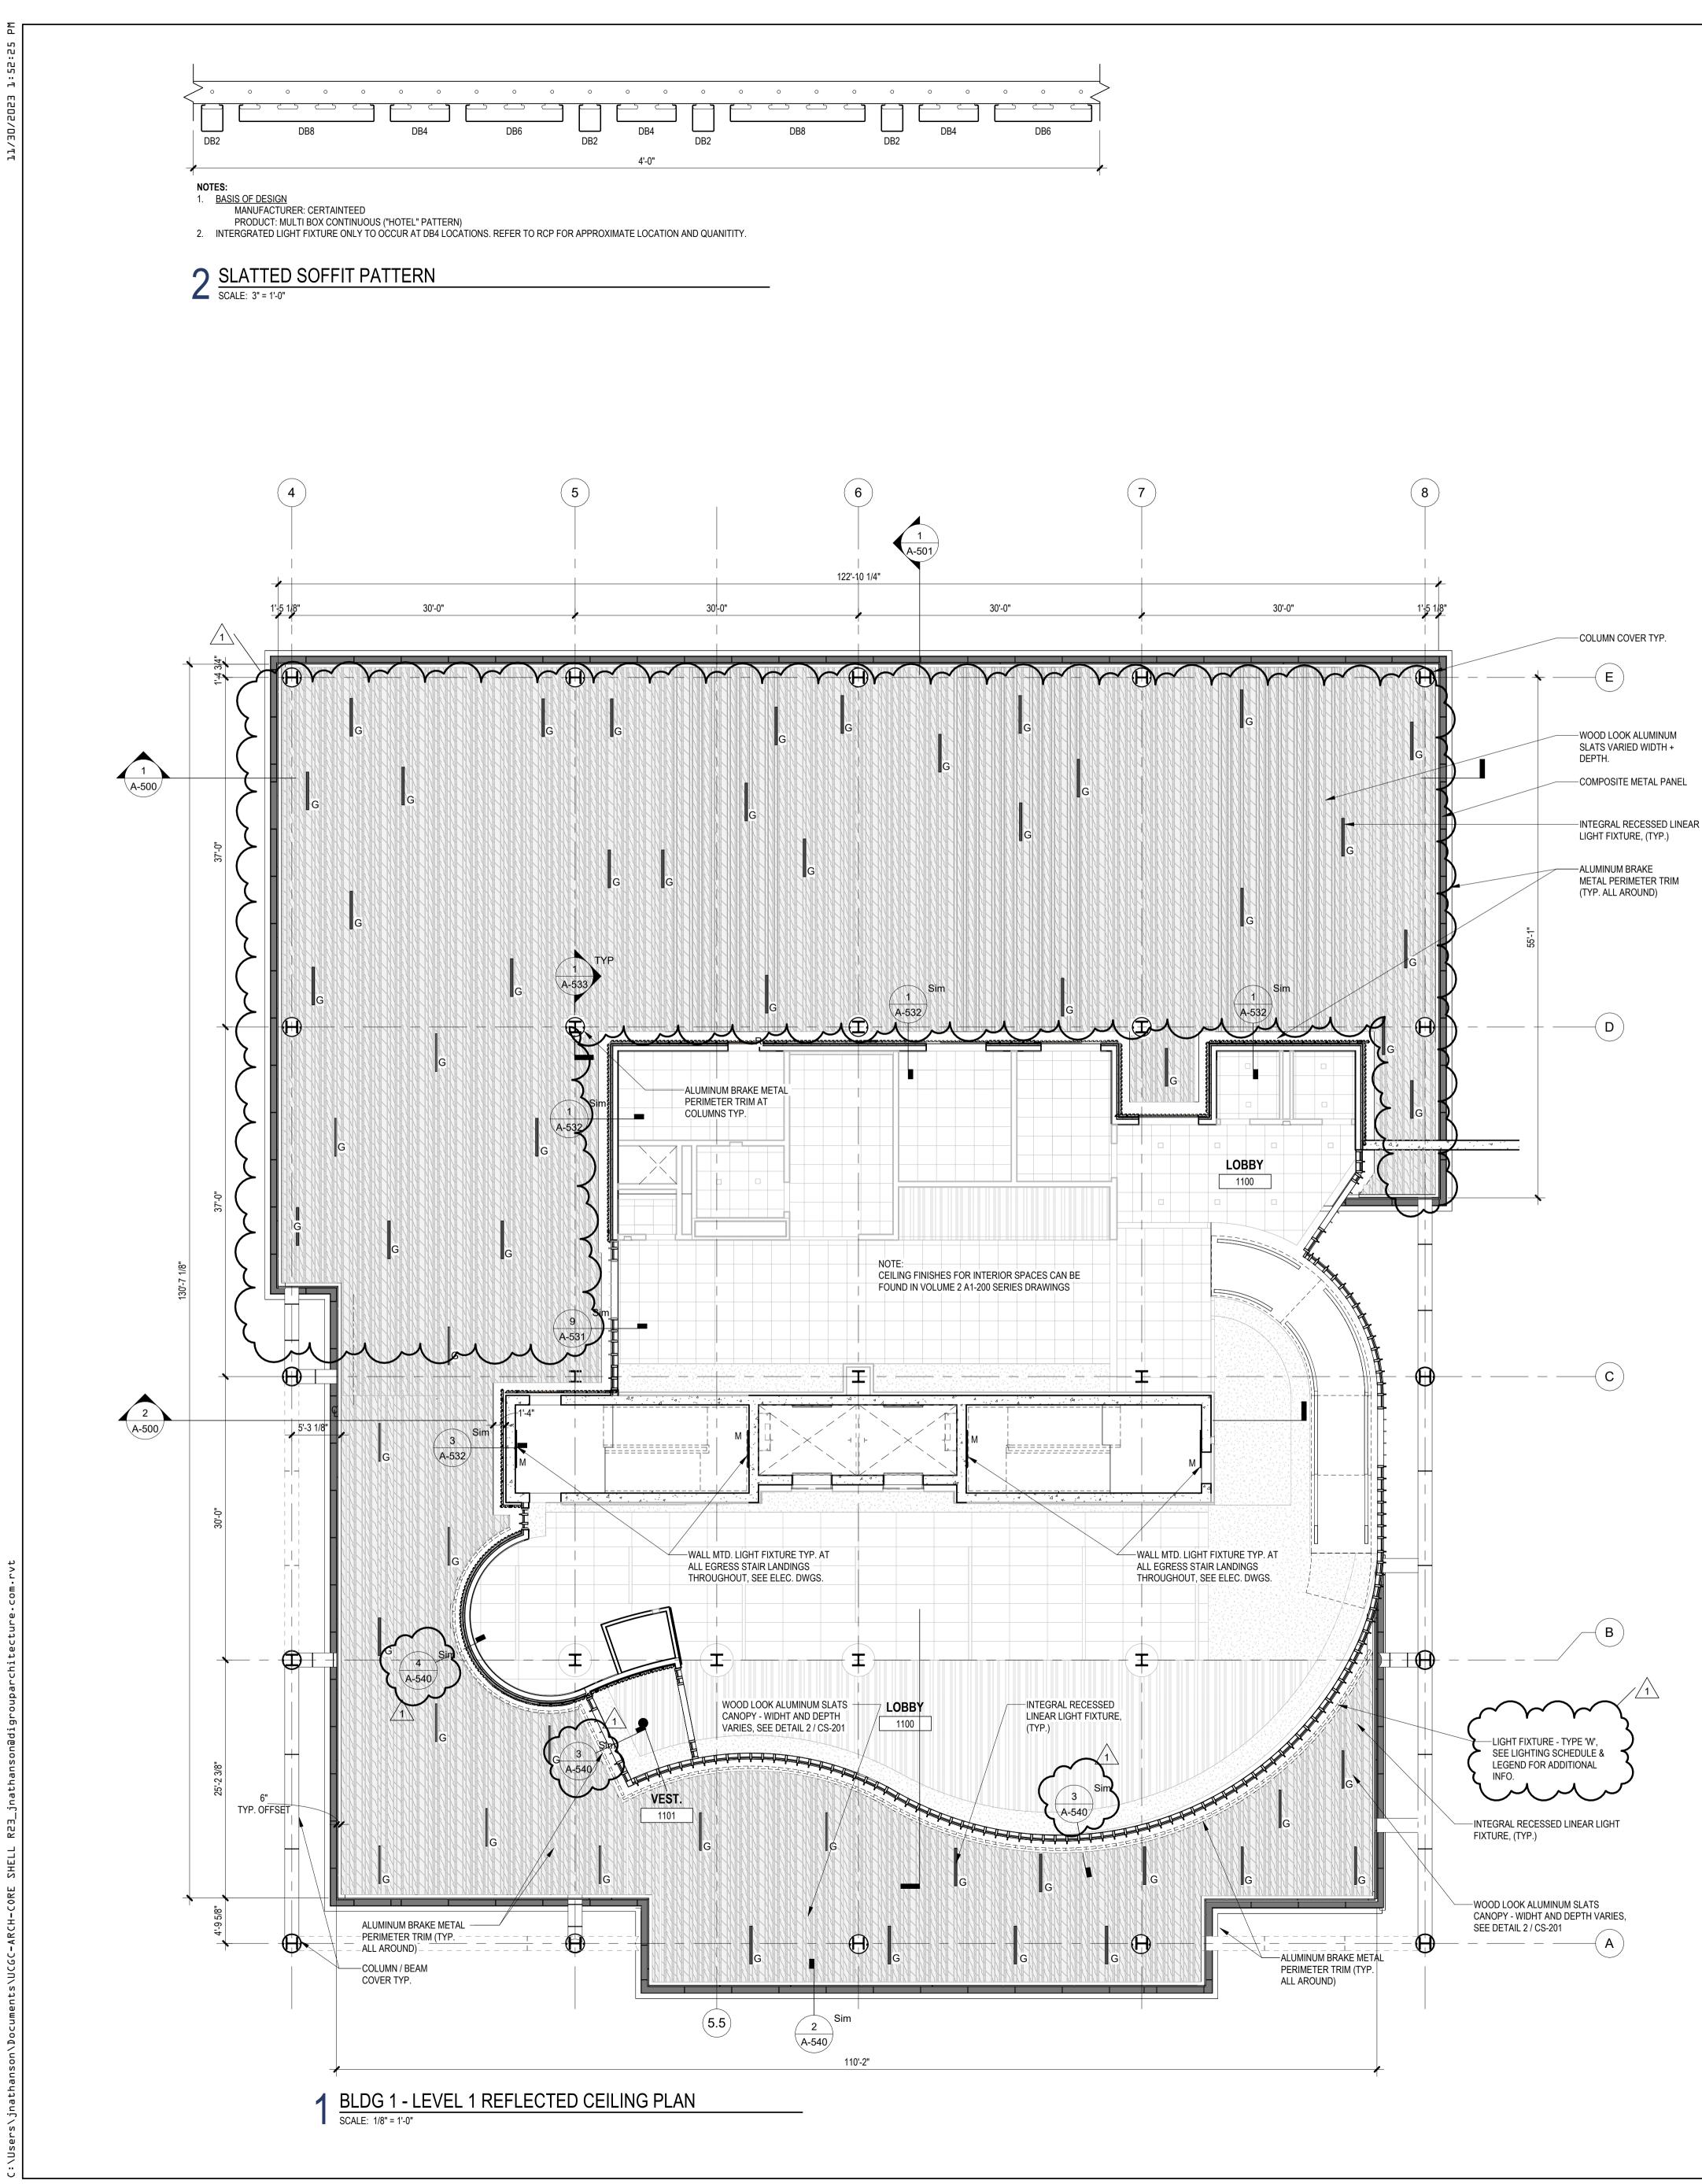

## REFLECTED CEILING PLAN NOTES:

- A. BORDERS AT LAY-IN ACOUSTICAL CEILING PANELS SHALL BE CUT TO MATCH FACTORY EDGE PROFILE. NO EXPOSED FASTENERS SHALL BE PERMITTED INCLUDING POP RIVETS AND TAPPETS.
- B. HEIGHT OF CEILINGS SHALL BE MEASURED FROM TOP OF SLAB TO FINISH FACE OF GWB OR FACE OF CEILING GRID AS INDICATED ON THE REFLECTED CEILING PLAN, UON.
- C. ALL LIGHT FIXTURES ARE TO BE INSTALLED IN ACCORDANCE WITH THE ARCHITECTURAL REFLECTED CEILING PLAN. ARCHITECT TO REVIEW CEILING LAYOUT INCLUDING BULKHEADS AND GRID PRIOR TO INSTALLATION.
- D. LIGHT FIXTURES TYPES SHOWN ON ARCHITECTURAL REFLECTED CEILING PLANS ARE NOTED FOR QUANTITIES AND LOCATIONS ONLY. SEE ELECTRICAL DRAWINGS FOR ADDITIONAL INFORMATION REGARDING SPECIFICATIONS, SWITCHING, EXIT LIGHTS, EMERGENCY LIGHTING, LIFE SAFETY EQUIPMENT AND CIRCUITING.
- E. MECHANICAL INFORMATION SHOWN ON THIS PLAN IS FOR REFERENCE ONLY, SEE MECHANICAL DRAWINGS FOR DIFFUSER LOCATIONS AND FOR ADDITIONAL INFORMATION REGARDING ALL HVAC EQUIPMENT INCLUDING HVAC REGISTERS, GRILLS, ETC.
- F. DIMENSIONED LIGHT FIXTURES ARE FROM FINISHED FACE OF PARTITIONS TO CENTERLINE OF FIXTURE TO CENTERLINE OF FIXTURE. ANY DISCREPANCIES WITH LOCATION OF LIGHT FIXTURES, SWITCHES, THERMOSTATS, OR DIFFUSERS BETWEEN ARCHITECTURAL AND ENGINEERING DRAWINGS SHALL BE CLARIFIED WITH THE ARCHITECT PRIOR TO INSTALLATION.
- G. THE CONTRACTOR SHALL SUBMIT COORDINATION DRAWINGS THAT INCORPORATES ALL TRADES AS REQUIRED BY THE SPECIFICATIONS.
- H. LIGHT FIXTURES, DIFFUSERS, GRILLES AND ALL OTHER SYSTEM DEVICES SHALL BE LOCATED CENTERED ON CEILING TILES, U.O.N.
- I. ALL ACOUSTICAL TILE CEILINGS SHALL BE CENTERED WITHIN EACH ROOM U.O.N.
- J. ALL FLUSH MOUNTED LIGHT FIXTURES MOUNTED WITHIN A GYPSUM BOARD CEILING SHALL BE FITTED WITH FLUSH TRIM.
- K. WHERE DUCTWORK, CONDUIT, AND PIPING MUST CROSS OPEN CEILINGS, ALL WORK SHALL BE EXECUTED TO PRESENT A NEAT AND MINIMAL APPEARANCE:
- L. ALL EXPOSED WORK SHALL RUN PARALLEL OR PERPENDICULAR TO STRUCTURE, WITH 90 DEGREE BENDS.
- M. LOCATE WORK SO AS TO MINIMIZE EXTENT EXPOSED. LOCATE WORK AS CLOSE AS POSSIBLE TO ADJACENT WALLS OR CEILINGS PLANES.
- N. PROVIDE ADDITIONAL STRUT SUPPORT SYSTEM TO SUPPORT FIXTURES WHERE LIGHT FIXTURES ARE NOT MOUNTED BELOW STRUCTURAL MEMBERS-DO NOT MOUNT TO ROOF DECK, TYP.
- O. WHERE EXPOSED STRUCTURE IS INDICATED, ALL EXPOSED ROOF DECK, STRUCTURAL STEEL, CONCRETE BEAMS & DECK, PIPES, DUCTS, CONDUITS, ETC. SHALL BE PAINTED TO MATCH CEILING COLOR; SEE FINISH SCHEDULE.
- P. DOWNLIGHTS SHALL BE SYMMETRICALLY CENTERED IN ACOUSTICAL CEILING TILE AND GYPSUM BOARD CEILINGS U.O.N.
- Q. PROVIDE SOFFIT TRANSITIONS BETWEEN ACT CEILINGS AND GYPSUM BOARD CEILINGS REFER TO A-220 SERIES DRAWINGS IN VOLUME 2
- R. FURNISH AN INSTALL ACCESS DOORS IN GYP. BD. CEILINGS AS REQUIRED TO PROVIDE ACCESS TO ABOVE-CEILINGS VAV BOXES, DAMPERS, VALVES, EQUIPMENT, ETC. SEE MEP DRAWINGS FOR LOCATIONS AND SPECIFICATIONS.
- S. ALL GYP. BD. CEILINGS IN WET AREAS SUCH AS TOILET ROOMS, BATHROOMS, AND JANITORS CLOSETS SHALL RECEIVE MOISTURE AND MOLD RESISTANT GYP. BD. AS PER SPECIFICATIONS.
- T. SEE SPECIFICATIONS FOR ADDITIONAL INFORMATION REGARDING CEILING TYPES.
- U. SEE SHEET A-220 FOR TYPICAL CEILING DETAILS, U.O.N.
- V. SEE SPECIFICATIONS SECTION 111200 FOR PARKING CONTROL EQUIPMENT.
- W. SEE SPECIFICATIONS SECTION 072119 FOR FOAMED-IN-PLACE INSULATION.
- X. SEE SPECIFICATIONS SECTION 078100 FOR SPRAYED FIRE-RESISTIVE MATERIALS.

## **EXTERIOR FINISH NOTES:**

### COLUMN / BEAM COVER BASIS OF DESIGN

- MANUFACTURER: CENTRIA PRODUCT: COLUMN COVERS SERIES 3000
- WOOD LOOK ALUMINUM SLATS VARIED WIDTH + DEPTH BASIS OF DESIGN

MANUFACTURER: CERTAINTEED PRODUCT: MULTI BOX CONTINOUS REFER TO DETAIL 2 / CS-201 FOR ADDITIONAL INFORMATION

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Project:
UNION COUNTY GOVERNMENT COMPLEX 81 & 93 WEST GRAND STREET CITY OF ELIZABETH NEW JERSEY, 07202
Drawing Information:
Project No: 20.072 Date: 11.08.2023 Drawn By: JB / AV / PC Checked By: JM / SH
Sheet Name:
BUILDING NO. 1 - LEVEL 1 - GROUND FLOOR REFLECTED SOFFIT PLAN
CS-201

### Jeffrey D. Venezia, AIA NJ RA AI 00827100

No. Date

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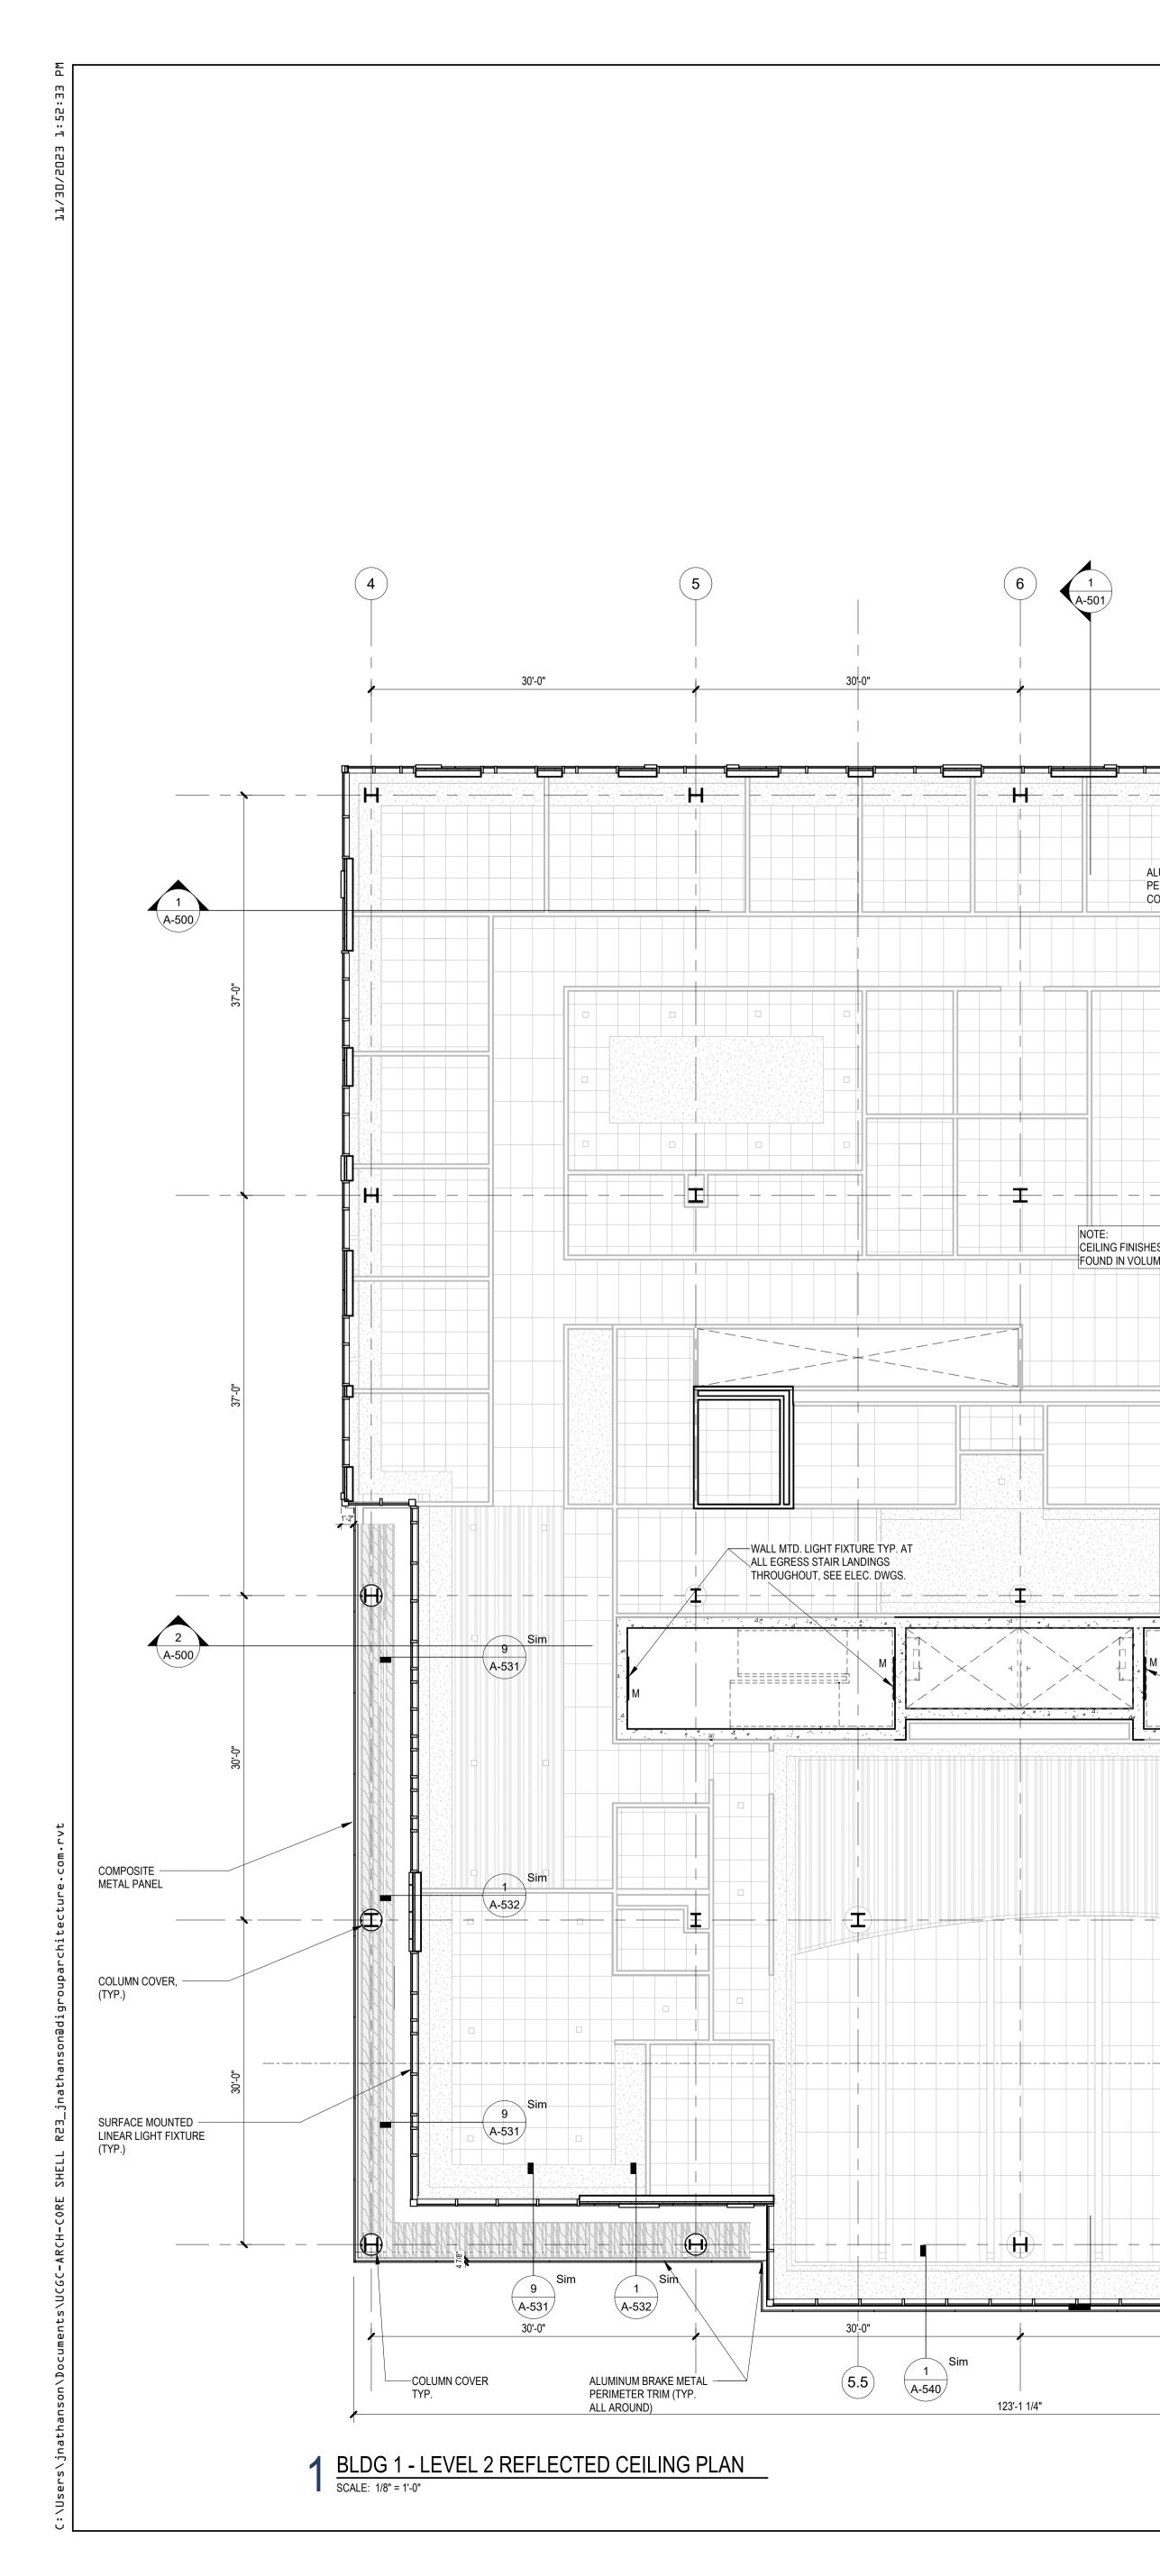
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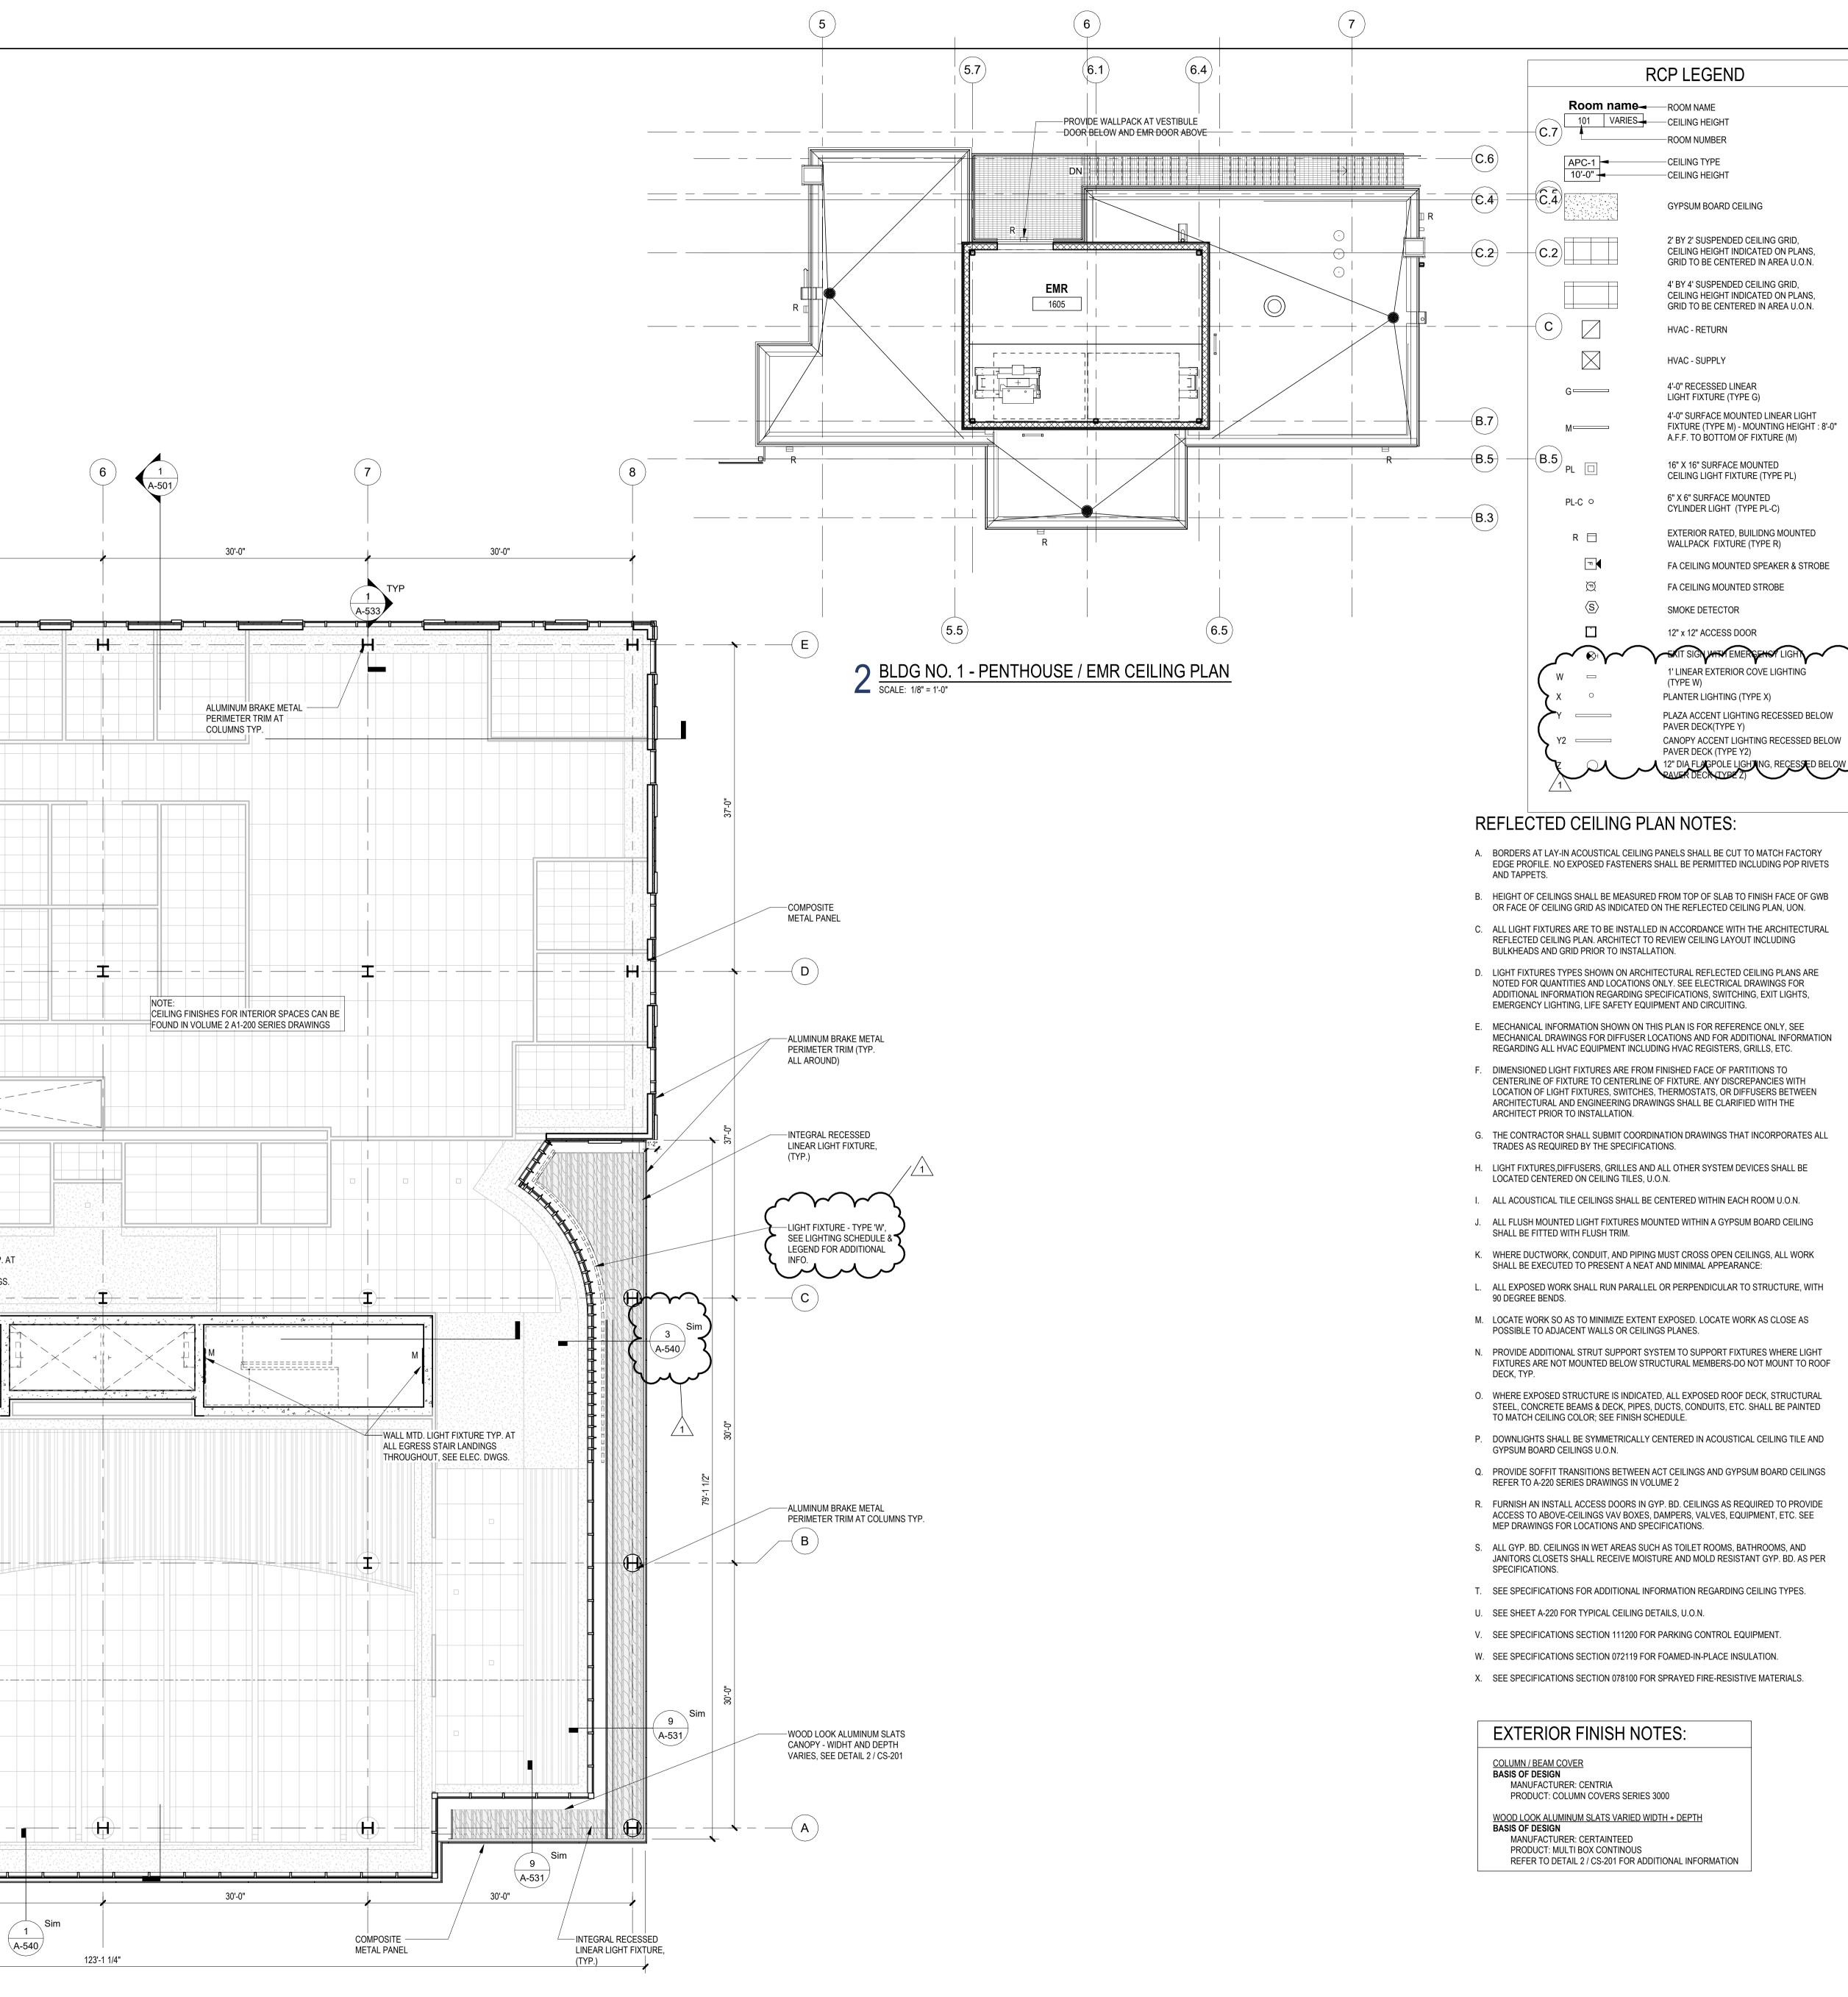
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- EDGE PROFILE. NO EXPOSED FASTENERS SHALL BE PERMITTED INCLUDING POP RIVETS
- C. ALL LIGHT FIXTURES ARE TO BE INSTALLED IN ACCORDANCE WITH THE ARCHITECTURAL
- MECHANICAL DRAWINGS FOR DIFFUSER LOCATIONS AND FOR ADDITIONAL INFORMATION
- G. THE CONTRACTOR SHALL SUBMIT COORDINATION DRAWINGS THAT INCORPORATES ALL

- FIXTURES ARE NOT MOUNTED BELOW STRUCTURAL MEMBERS-DO NOT MOUNT TO ROOF
- O. WHERE EXPOSED STRUCTURE IS INDICATED, ALL EXPOSED ROOF DECK, STRUCTURAL STEEL, CONCRETE BEAMS & DECK, PIPES, DUCTS, CONDUITS, ETC. SHALL BE PAINTED

- ACCESS TO ABOVE-CEILINGS VAV BOXES, DAMPERS, VALVES, EQUIPMENT, ETC. SEE
- JANITORS CLOSETS SHALL RECEIVE MOISTURE AND MOLD RESISTANT GYP. BD. AS PER

oduct	tion or	other	use of	these	drawing	s or	ideas	is p	orohib	ited.

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Sheet No:	
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### Jeffrey D. Venezia, AIA NJ RÅ AI 00827100

No. Date


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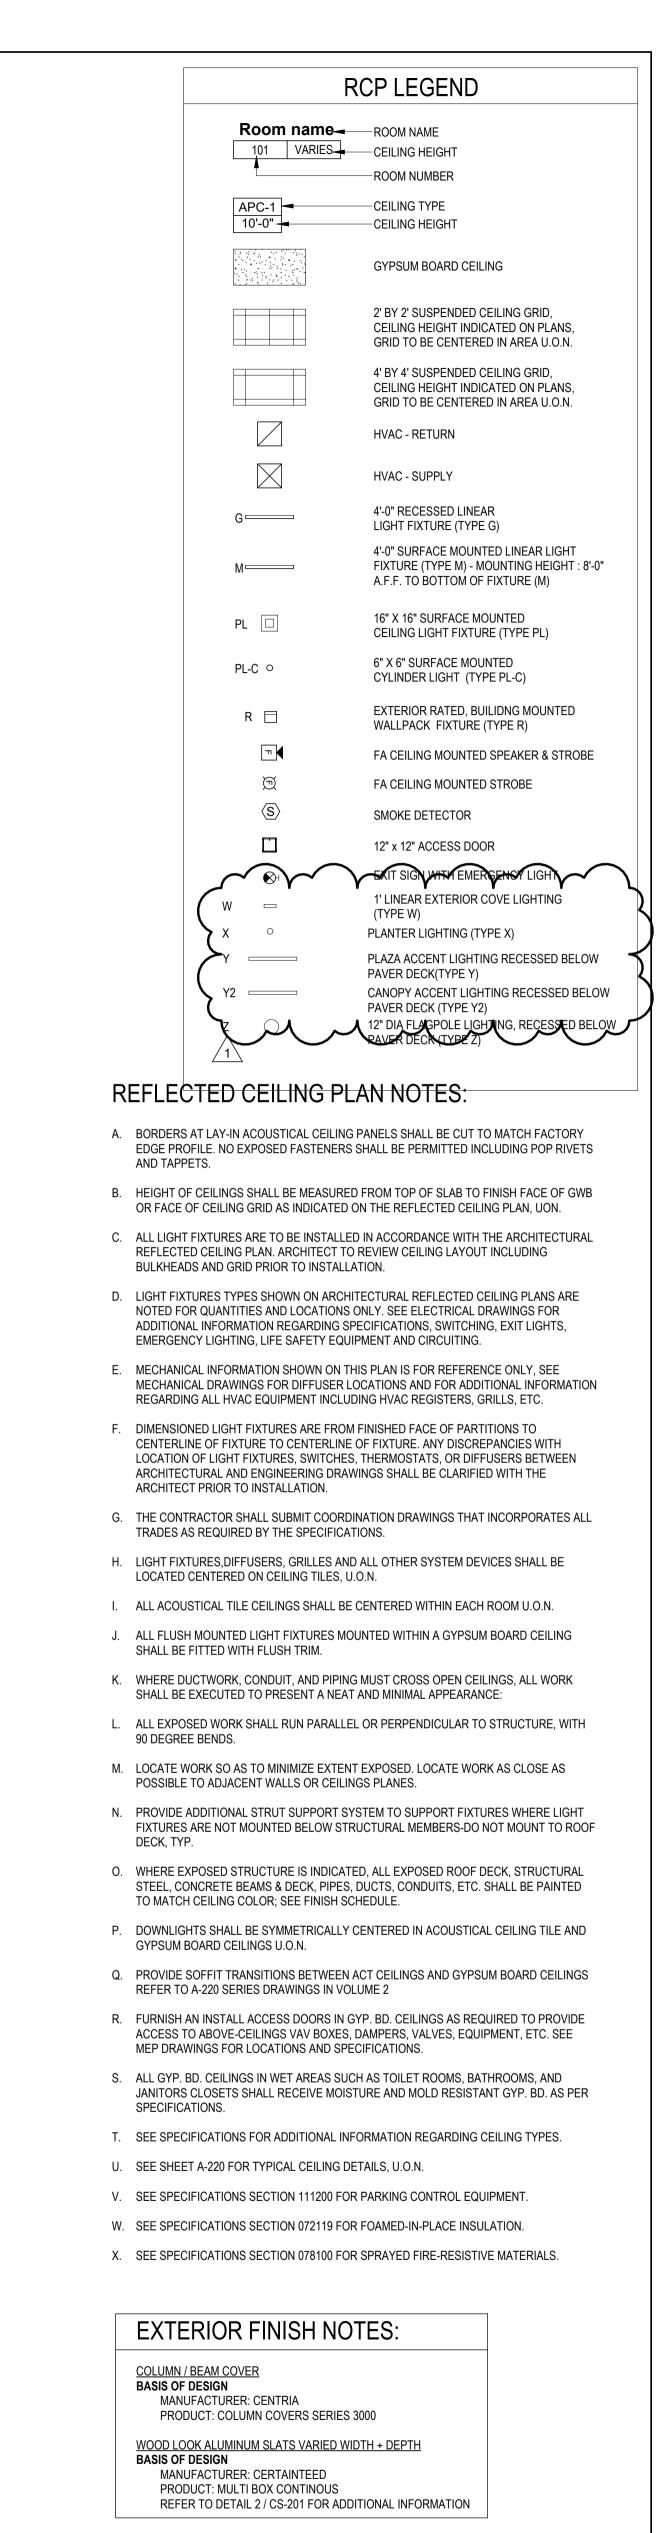
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UNION COUNTY IMPROVEMENT AUTHORITY
Project:
UNION COUNTY GOVERNMENT COMPLEX 81 & 93 WEST GRAND STREET CITY OF ELIZABETH NEW JERSEY, 07202
Drawing Information:
Project No: 20.072 Date: 11.08.2023 Drawn By: JB / AV / PC Checked By: JM / SH
Sheet Name:
BUILDING NO. 2 - LEVEL 0 - GROUND FLOOR REFLECTED SOFFIT PLAN
<b>CS-210</b>

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### Jeffrey D. Venezia, AIA NJ RÅ AI 00827100


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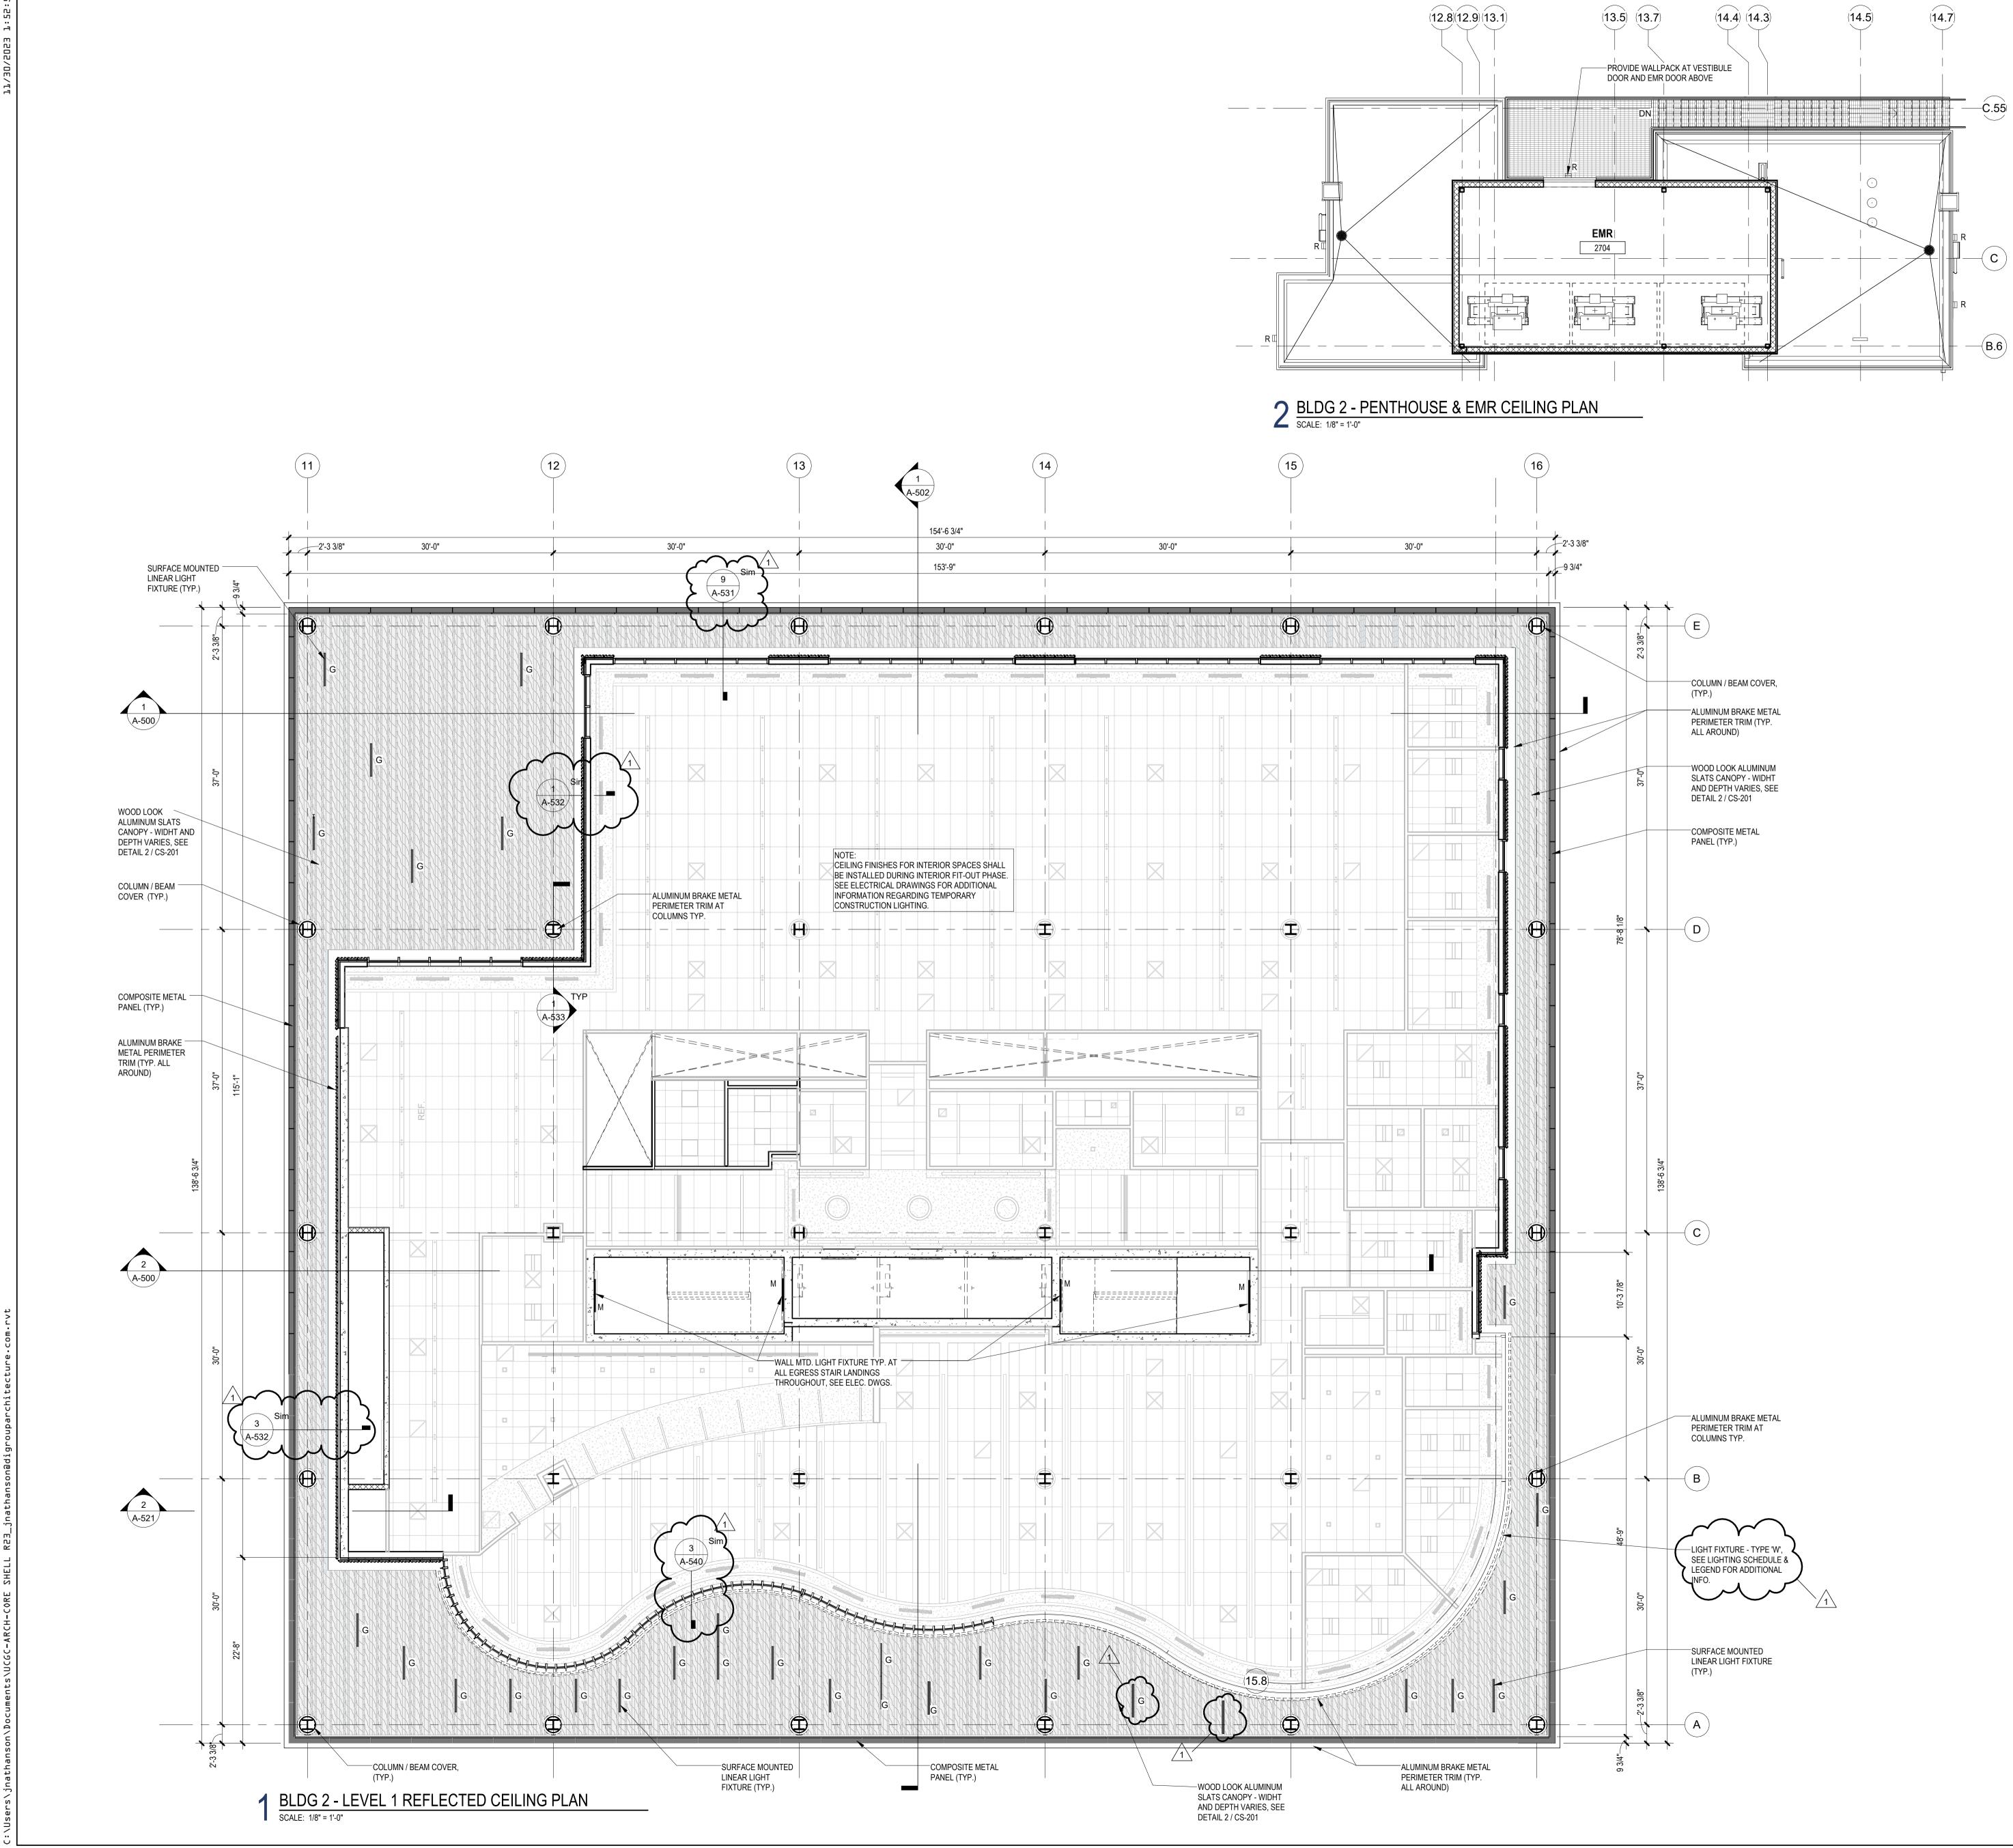
**Revisions / Issues** 

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Description



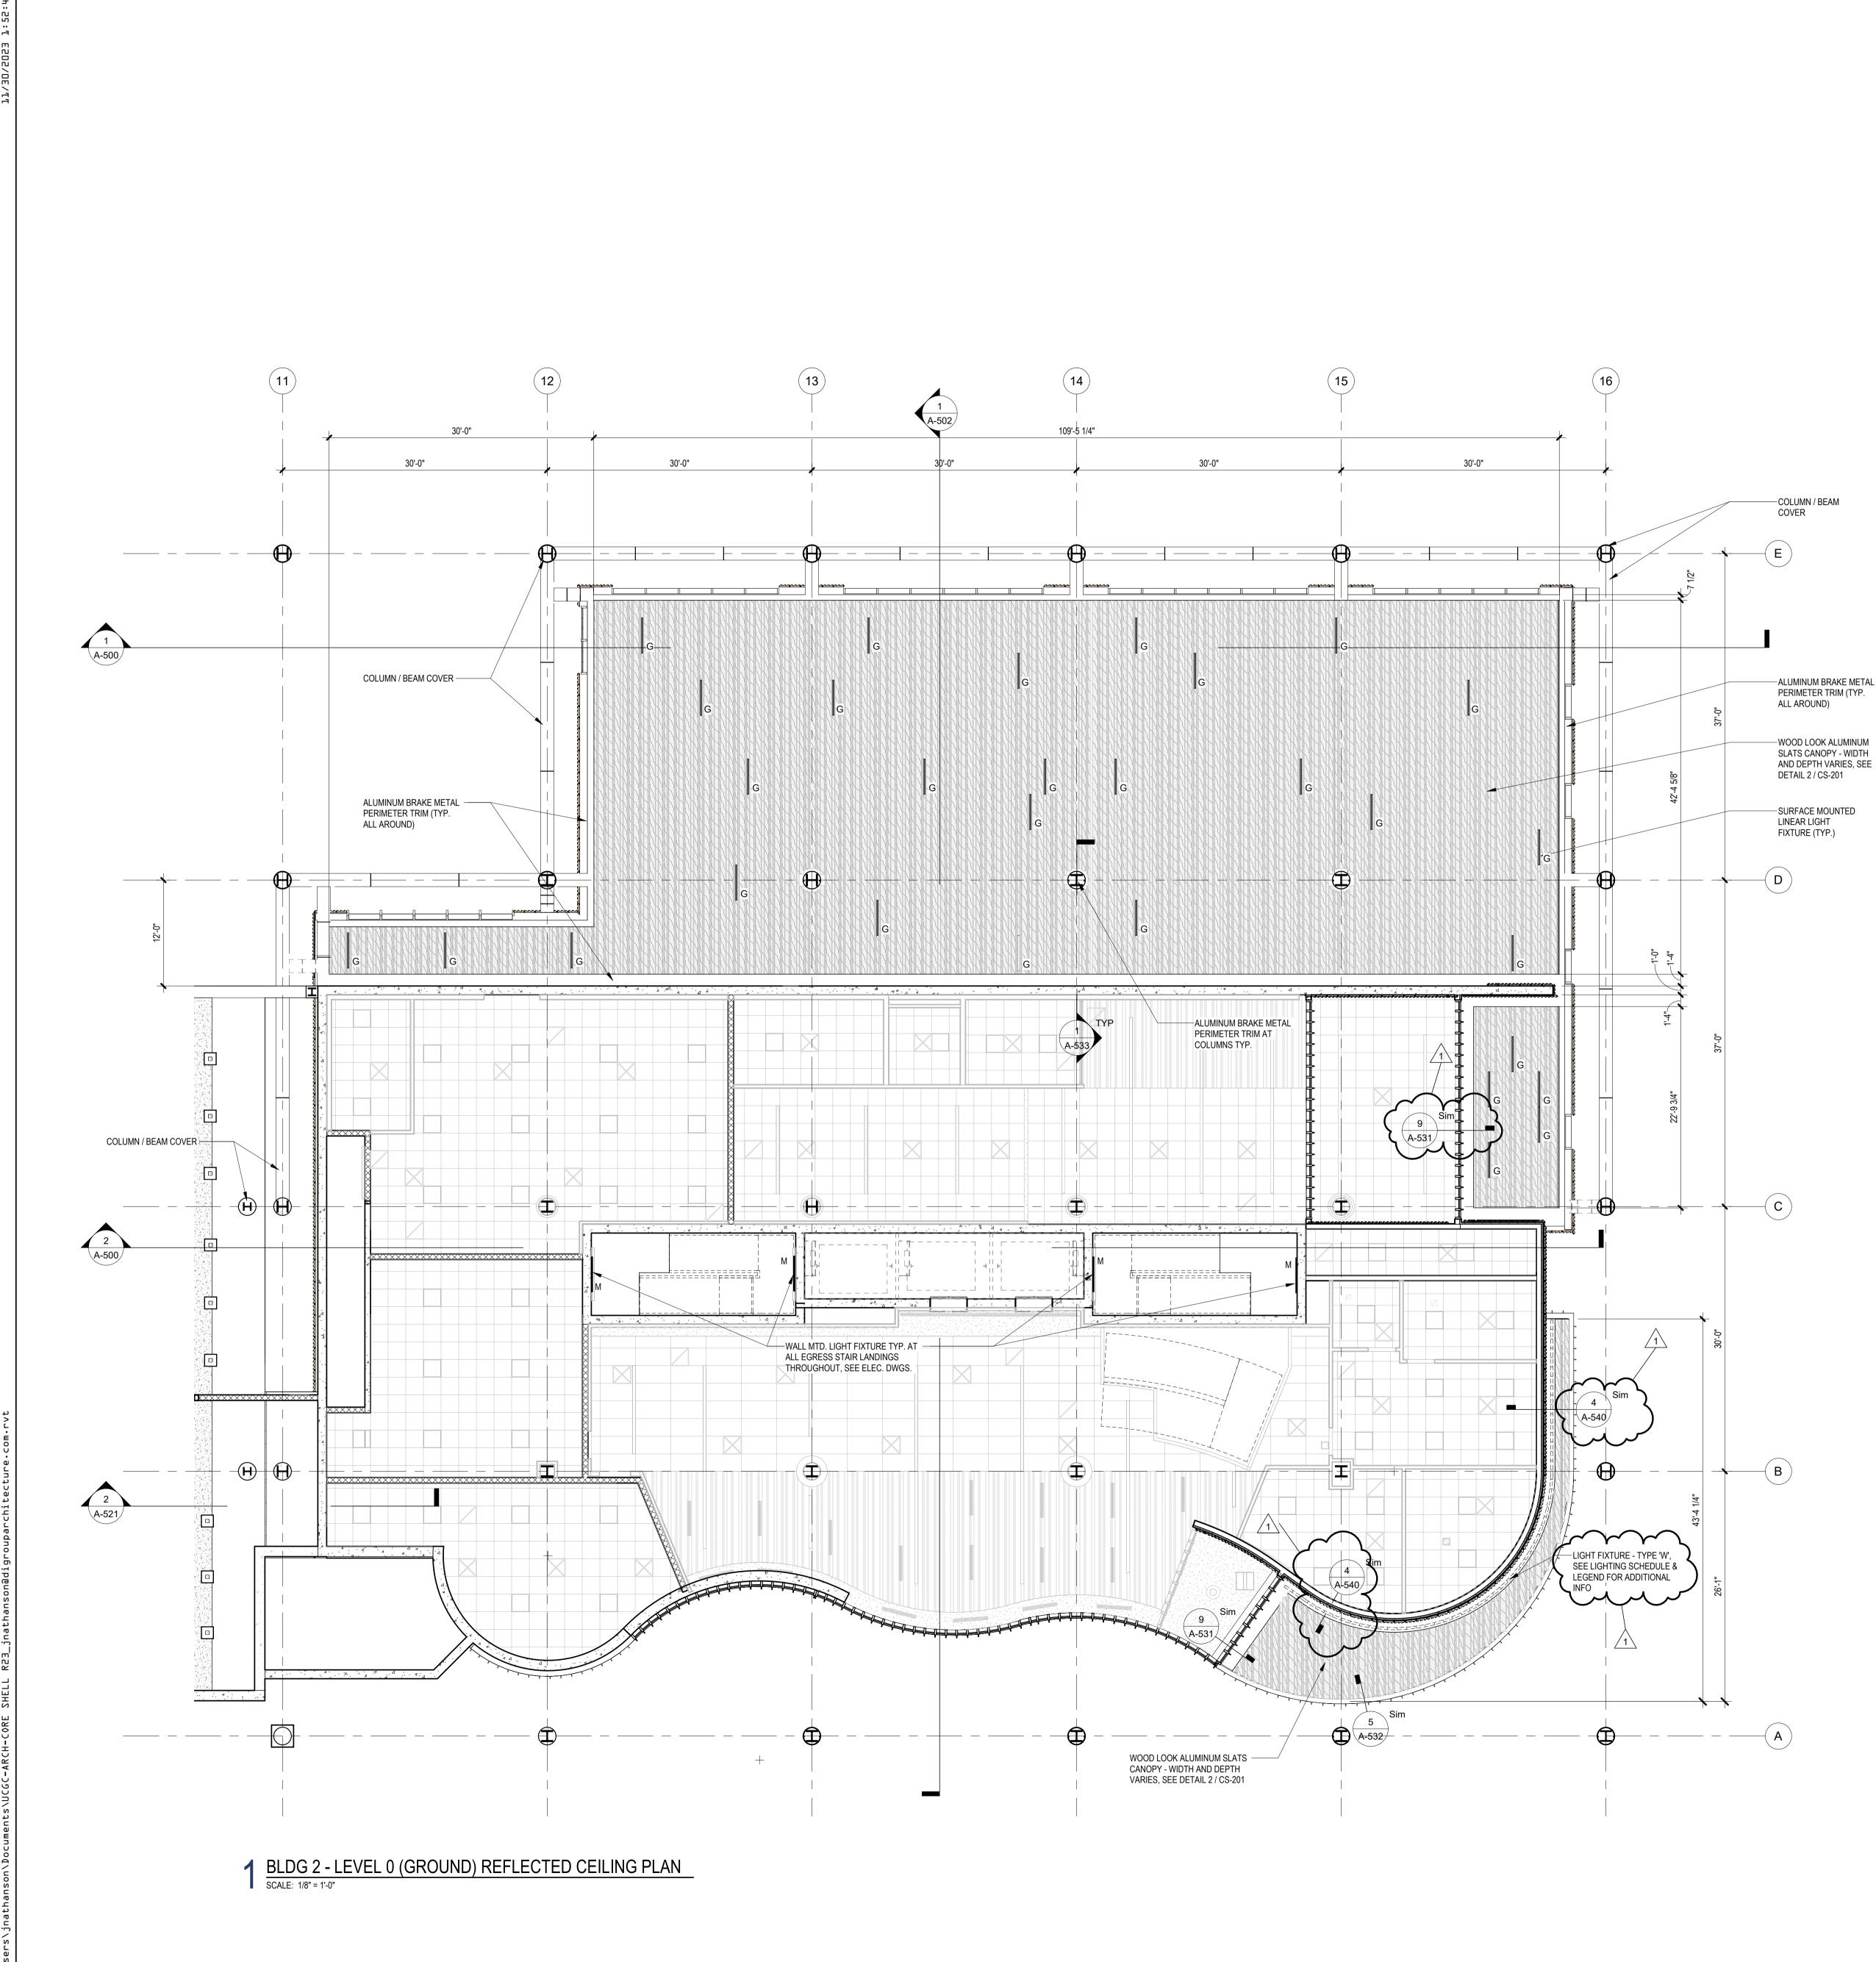

RCP LEGEND				
Room name	-ROOM NAME -CEILING HEIGHT -ROOM NUMBER			
APC-1 10'-0"	-CEILING TYPE -CEILING HEIGHT			
	GYPSUM BOARD CEILING			
	2' BY 2' SUSPENDED CEILING GRID, CEILING HEIGHT INDICATED ON PLANS, GRID TO BE CENTERED IN AREA U.O.N.			
	4' BY 4' SUSPENDED CEILING GRID, CEILING HEIGHT INDICATED ON PLANS, GRID TO BE CENTERED IN AREA U.O.N.			
	HVAC - RETURN			
$\square$	HVAC - SUPPLY			
G	4'-0" RECESSED LINEAR LIGHT FIXTURE (TYPE G)			
M	4'-0" SURFACE MOUNTED LINEAR LIGHT FIXTURE (TYPE M) - MOUNTING HEIGHT : 8'-0" A.F.F. TO BOTTOM OF FIXTURE (M)			
PL	16" X 16" SURFACE MOUNTED CEILING LIGHT FIXTURE (TYPE PL)			
PL-C o	6" X 6" SURFACE MOUNTED CYLINDER LIGHT (TYPE PL-C)			
R 🗖	EXTERIOR RATED, BUILIDNG MOUNTED WALLPACK FIXTURE (TYPE R)			
Т	FA CEILING MOUNTED SPEAKER & STROBE			
Ì	FA CEILING MOUNTED STROBE			
$\langle S \rangle$	SMOKE DETECTOR			
	12" x 12" ACCESS DOOR			
€ V V	EXIT SIGN WITH EMERGENCY LIGHT			
$\sum_{m}$	1' LINEAR EXTERIOR COVE LIGHTING (TYPE W)			
×°	PLANTER LIGHTING (TYPE X)			
	PLAZA ACCENT LIGHTING RECESSED BELOW PAVER DECK(TYPE Y)			
	CANOPY ACCENT LIGHTING RECESSED BELOW PAVER DECK (TYPE Y2) 2" DIA LAGP OLE LIGHTING RECESSED BELOW			
	PAVER DECK (TYPE Z)			
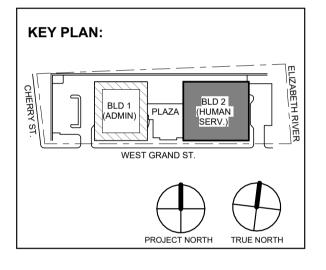
## REFLECTED CEILING PLAN NOTES:

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- E. MECHANICAL INFORMATION SHOWN ON THIS PLAN IS FOR REFERENCE ONLY, SEE MECHANICAL DRAWINGS FOR DIFFUSER LOCATIONS AND FOR ADDITIONAL INFORMATION REGARDING ALL HVAC EQUIPMENT INCLUDING HVAC REGISTERS, GRILLS, ETC.
- F. DIMENSIONED LIGHT FIXTURES ARE FROM FINISHED FACE OF PARTITIONS TO CENTERLINE OF FIXTURE TO CENTERLINE OF FIXTURE. ANY DISCREPANCIES WITH LOCATION OF LIGHT FIXTURES, SWITCHES, THERMOSTATS, OR DIFFUSERS BETWEEN ARCHITECTURAL AND ENGINEERING DRAWINGS SHALL BE CLARIFIED WITH THE ARCHITECT PRIOR TO INSTALLATION.
- G. THE CONTRACTOR SHALL SUBMIT COORDINATION DRAWINGS THAT INCORPORATES ALL TRADES AS REQUIRED BY THE SPECIFICATIONS.
- H. LIGHT FIXTURES, DIFFUSERS, GRILLES AND ALL OTHER SYSTEM DEVICES SHALL BE LOCATED CENTERED ON CEILING TILES, U.O.N.
- I. ALL ACOUSTICAL TILE CEILINGS SHALL BE CENTERED WITHIN EACH ROOM U.O.N.
- J. ALL FLUSH MOUNTED LIGHT FIXTURES MOUNTED WITHIN A GYPSUM BOARD CEILING SHALL BE FITTED WITH FLUSH TRIM.
- K. WHERE DUCTWORK, CONDUIT, AND PIPING MUST CROSS OPEN CEILINGS, ALL WORK SHALL BE EXECUTED TO PRESENT A NEAT AND MINIMAL APPEARANCE:
- L. ALL EXPOSED WORK SHALL RUN PARALLEL OR PERPENDICULAR TO STRUCTURE, WITH 90 DEGREE BENDS.
- M. LOCATE WORK SO AS TO MINIMIZE EXTENT EXPOSED. LOCATE WORK AS CLOSE AS POSSIBLE TO ADJACENT WALLS OR CEILINGS PLANES.
- N. PROVIDE ADDITIONAL STRUT SUPPORT SYSTEM TO SUPPORT FIXTURES WHERE LIGHT FIXTURES ARE NOT MOUNTED BELOW STRUCTURAL MEMBERS-DO NOT MOUNT TO ROOF DECK, TYP.
- O. WHERE EXPOSED STRUCTURE IS INDICATED, ALL EXPOSED ROOF DECK, STRUCTURAL STEEL, CONCRETE BEAMS & DECK, PIPES, DUCTS, CONDUITS, ETC. SHALL BE PAINTED TO MATCH CEILING COLOR; SEE FINISH SCHEDULE. P. DOWNLIGHTS SHALL BE SYMMETRICALLY CENTERED IN ACOUSTICAL CEILING TILE AND
- GYPSUM BOARD CEILINGS U.O.N. Q. PROVIDE SOFFIT TRANSITIONS BETWEEN ACT CEILINGS AND GYPSUM BOARD CEILINGS
- REFER TO A-220 SERIES DRAWINGS IN VOLUME 2 R. FURNISH AN INSTALL ACCESS DOORS IN GYP. BD. CEILINGS AS REQUIRED TO PROVIDE ACCESS TO ABOVE-CEILINGS VAV BOXES, DAMPERS, VALVES, EQUIPMENT, ETC. SEE MEP DRAWINGS FOR LOCATIONS AND SPECIFICATIONS.
- S. ALL GYP. BD. CEILINGS IN WET AREAS SUCH AS TOILET ROOMS, BATHROOMS, AND JANITORS CLOSETS SHALL RECEIVE MOISTURE AND MOLD RESISTANT GYP. BD. AS PER SPECIFICATIONS.
- T. SEE SPECIFICATIONS FOR ADDITIONAL INFORMATION REGARDING CEILING TYPES.
- U. SEE SHEET A-220 FOR TYPICAL CEILING DETAILS, U.O.N.
- V. SEE SPECIFICATIONS SECTION 111200 FOR PARKING CONTROL EQUIPMENT.
- W. SEE SPECIFICATIONS SECTION 072119 FOR FOAMED-IN-PLACE INSULATION. X. SEE SPECIFICATIONS SECTION 078100 FOR SPRAYED FIRE-RESISTIVE MATERIALS.

EXTERIOR FINISH NOTES:
COLUMN / BEAM COVER BASIS OF DESIGN MANUFACTURER: CENTRIA PRODUCT: COLUMN COVERS SERIES 3000

- WOOD LOOK ALUMINUM SLATS VARIED WIDTH + DEPTH BASIS OF DESIGN
- MANUFACTURER: CERTAINTEED
- PRODUCT: MULTI BOX CONTINOUS REFER TO DETAIL 2 / CS-201 FOR ADDITIONAL INFORMATION

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UNION COUNTY IMPROVEMENT AUTHORITY
Project:
UNION COUNTY GOVERNMENT COMPLEX
81 & 93 WEST GRAND STREET CITY OF ELIZABETH NEW JERSEY, 07202
Drawing Information:
Project No:         20.072           Date:         11.08.2023           Drawn By:         JB / AV / PC           Checked By:         JM / SH
Sheet Name:
BUILDING NO. 2 - LEVEL 1 - REFLECTED CEILING PLAN
Sheet No:
CS-211

### Jeffrey D. Venezia, AIA NJ RÅ AI 00827100


No. Date


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Description


12.01.2023 Addendum No. 01

11.08.2023 For Public Bid



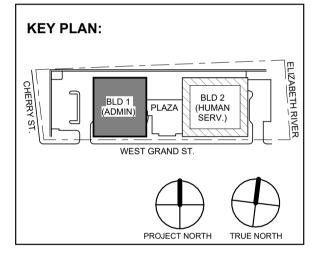

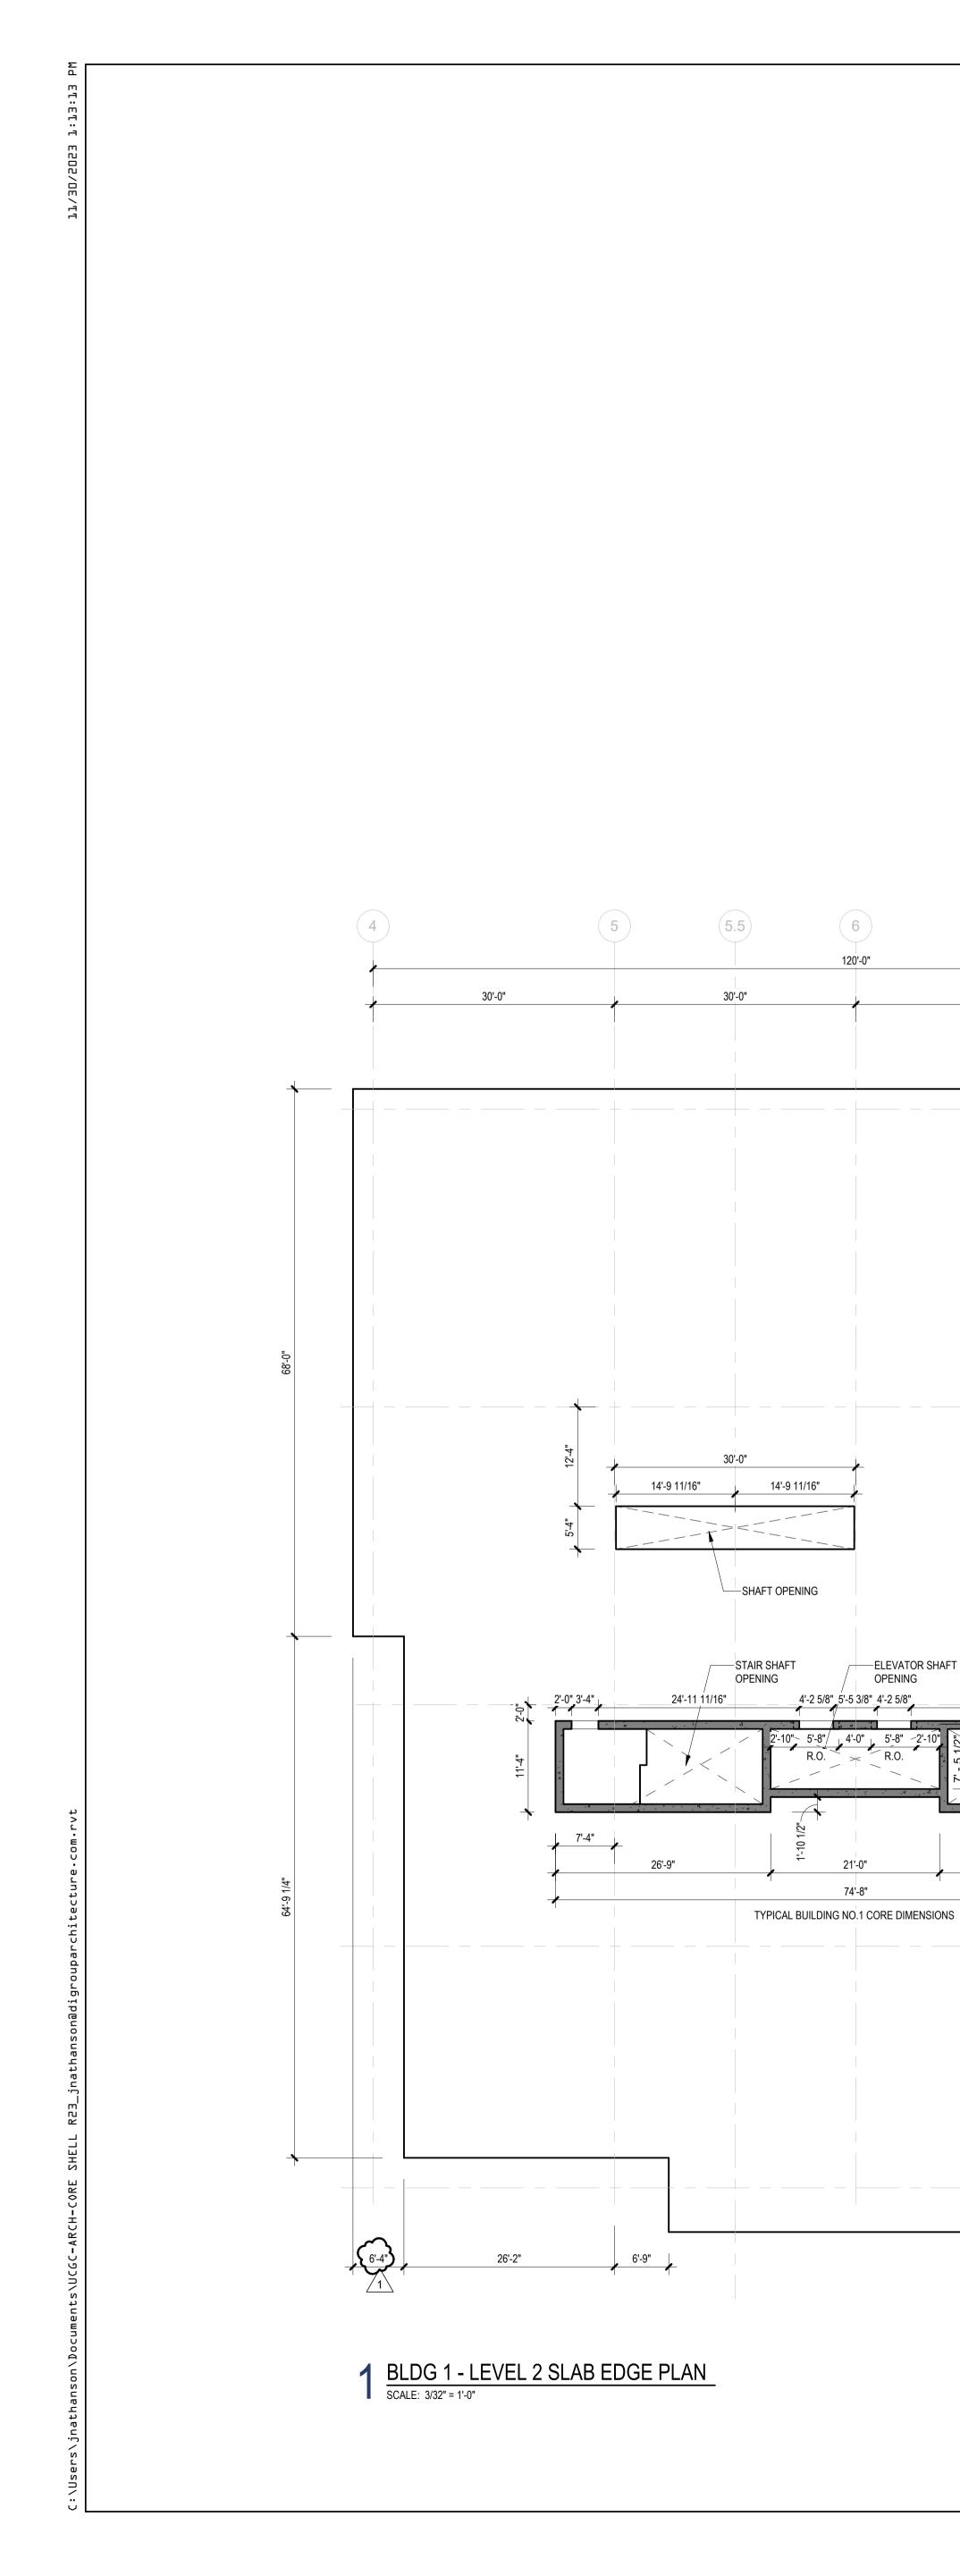30'-0"

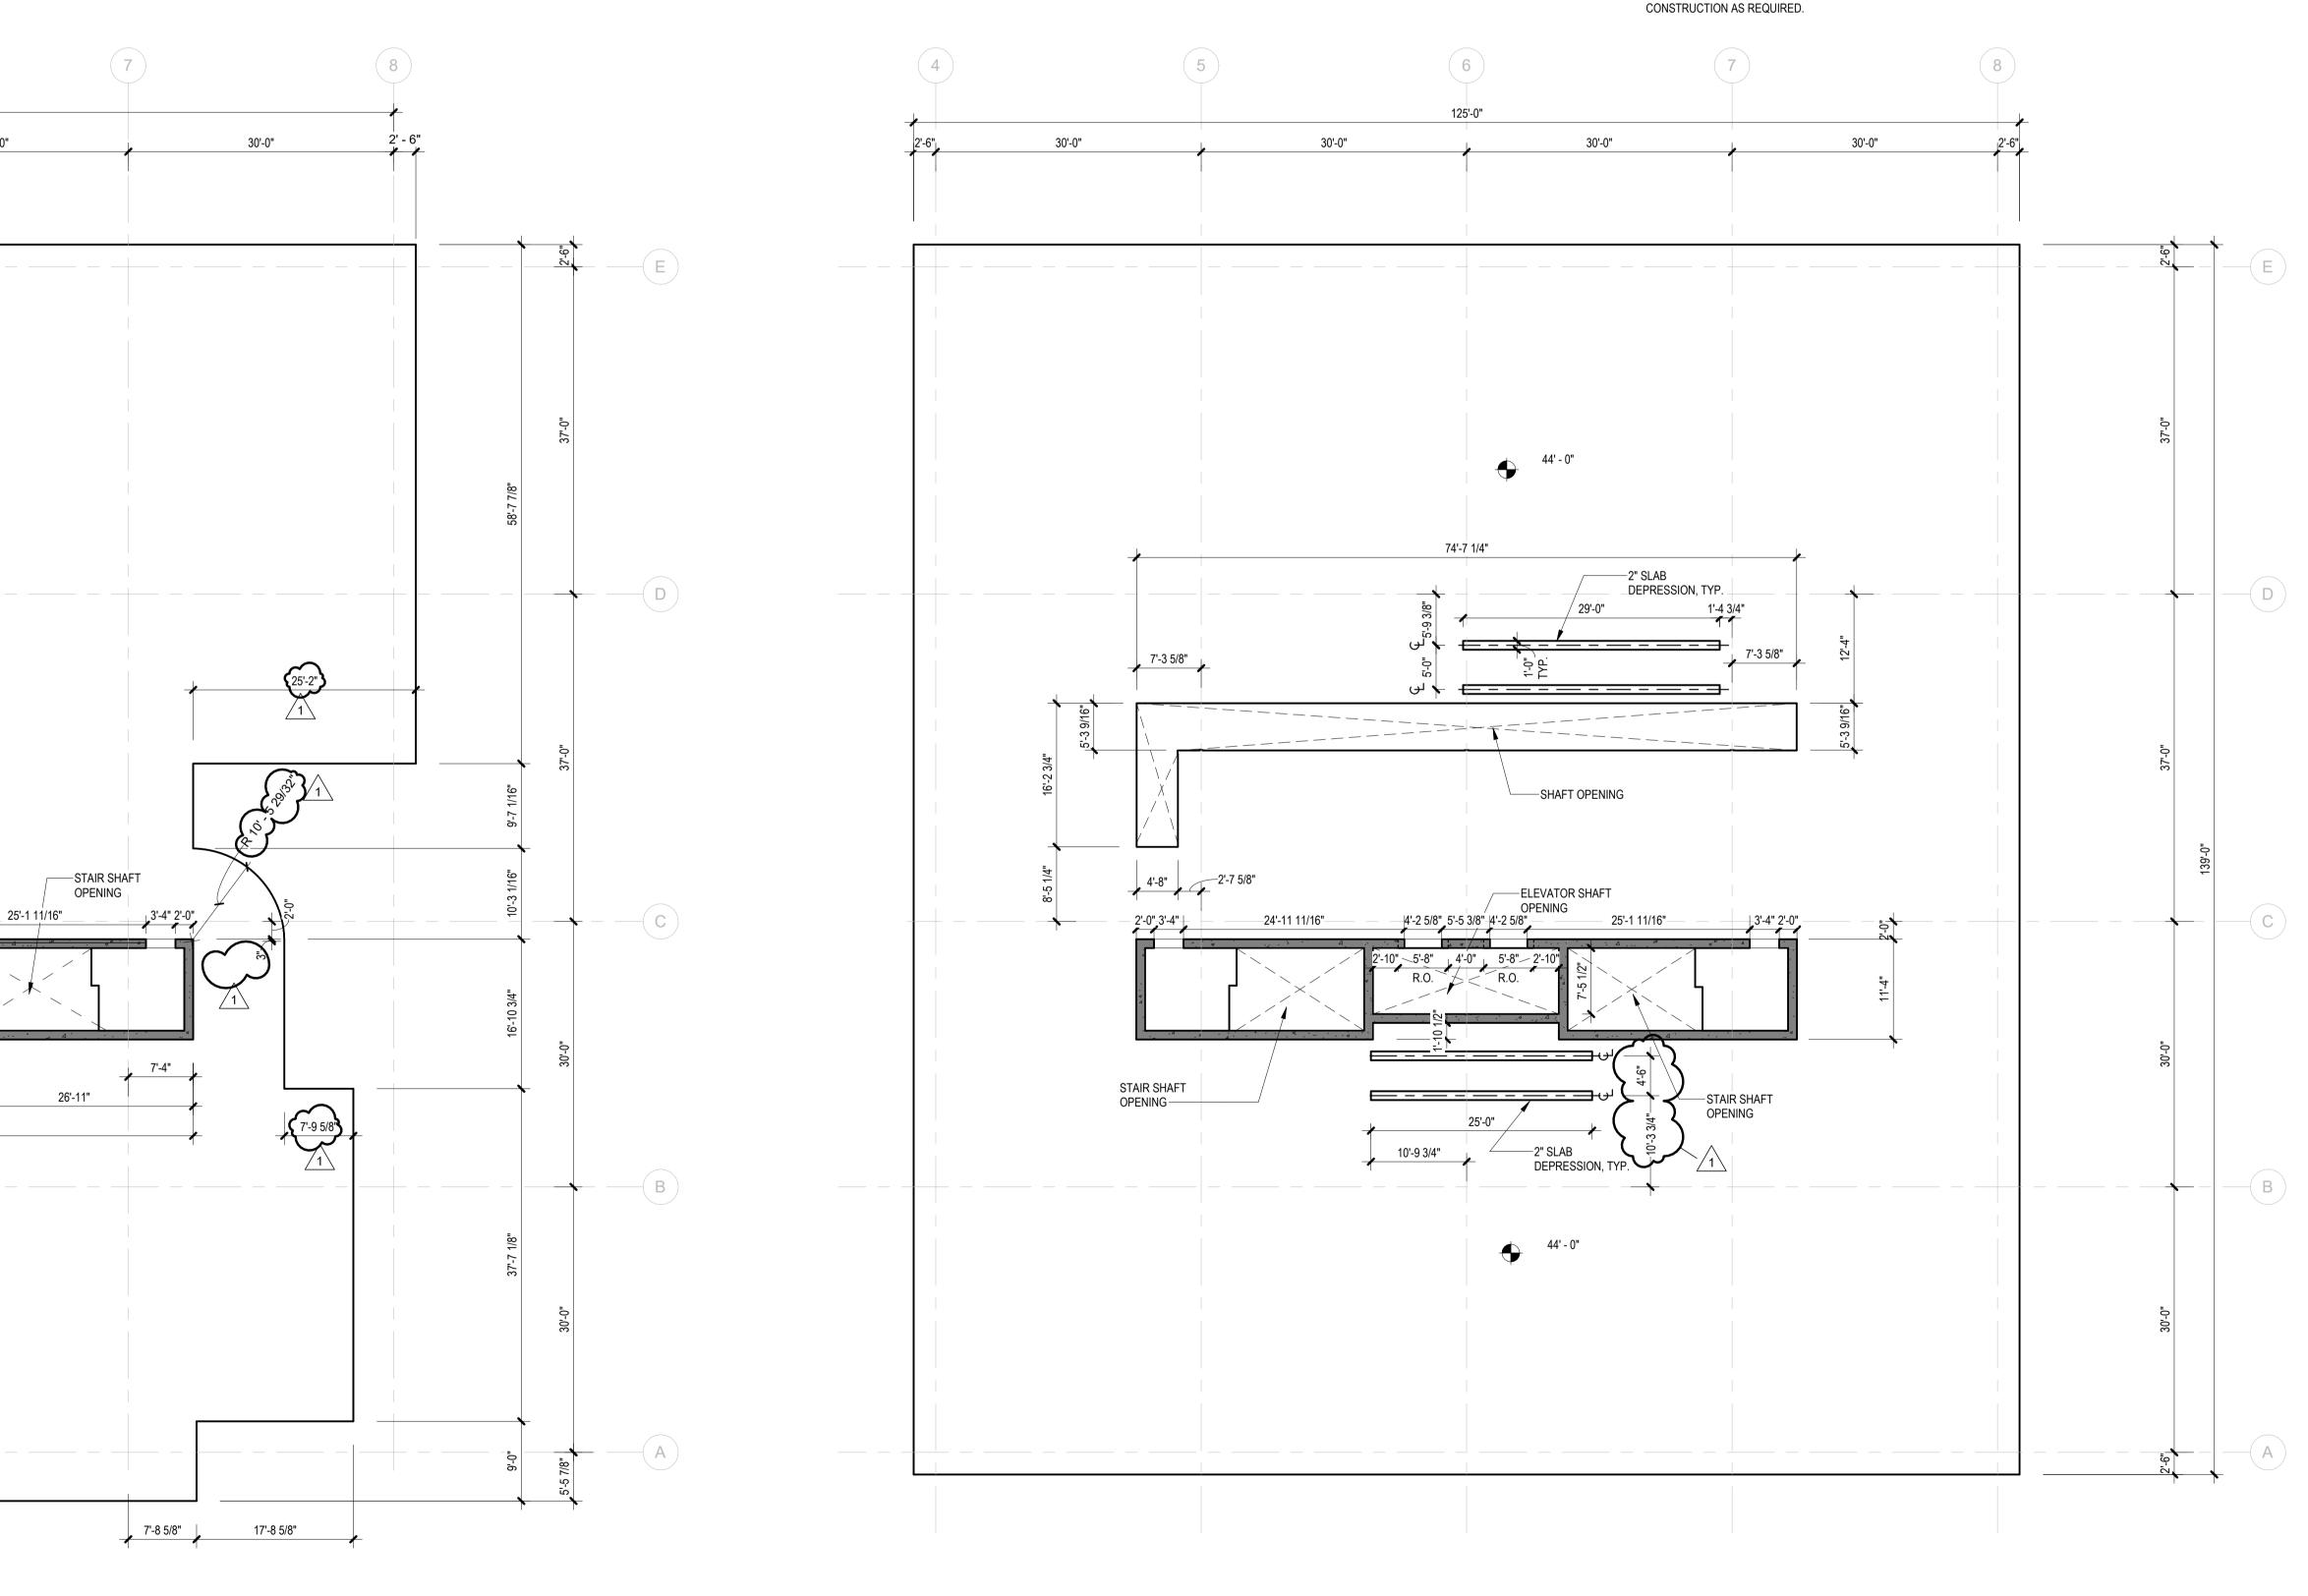

2 BLDG 1 - LEVEL 3 SLAB EDGE PLAN SCALE: 3/32" = 1'-0"


## **GENERAL NOTES:**

- A. SEE DRAWINGS A-505 AND A-506 FOR CROSS SECTIONS THRU VARIATIONS OF SLOPING CONCRETE SLAB PARKING DECK.
- B. SEE DRAWING A-536 FOR ALL SITE DETAILS INSTALLED OVER STRUCTURAL CONCRETE SLAB.
- C. PROVIDE "STYROFOAM HIGHLOAD" EXTRUDED POLYSTYRENE (XPS) FOAM INSULATION WITH A COMPRESSIVE STRENGTH OF 40 PSI AT GENERAL CONCRETE FLOOR SLAB INFILL, SEE SPECIFICATION SECTION 072100 THERMAL INSULATION FOR RAISED SLABS.
- D. PROVIDE "STYROFOAM PLAZAMATE" EXTRUDED POLYSTYRENE (XPS) FOAM INSULATION WITH A COMPRESSIVE STRENGTH OF 60 PSI AT GARAGE AREA CONCRETE FLOOR SLAB INFILL AND FOR INSTALLATIN ABOVE WATERPROOFING MEMBRANE AT OUTDOOR PLAZA DECK, SEE SPECIFICATION SECTION 07211 THERMAL INSULATION
- E. SEE ELECTRIC AND PLUMBING DRAWINGS FOR COORDINATION OF 4" THICK CONCRETE PAD LOCATIONS BELOW EQUIPMENT (SWITCHGEAR, BOILERS, ETC.) COORDINATE FINAL LOCATION OF EQUIPMENT AND SIZE OF CONCRETE PADS WITH MANUFACTURER PRIOR TO CONSTRUCTION, MAINTAIN 4" MINIMUM OF CONCRETE BEYOND EQUIPMENT ALL AROUND.
- F. SEE ELECTRIC DRAWINGS FOR COORDINATION OF POWER REQUIREMENTS AT ALL ELECTRIC ROOMS AND VERTICAL RISER LOCATIONS.
- G. SEE PLUMBING DRAWINGS FOR COORDINATION OF VERTICAL PIPING.
- H. SEE MECHANICAL DRAWINGS FOR COORDINATION OF DUCTWO RK OPENINGS.I. SEE TELE/ DATA DRAWINGS FOR COORDINATION OF LOW VOLTAGE
- REQUIREMENTS AT ALL MDF / IDF ROOMS AND VERTICAL IT RISER LOCATIONS
- J. SEE SPECIFICATIONS SECTION 071800 FOR VEHICULAR TRAFFIC COATING.
- K. SEE CIVIL DRAWINGS FOR COORDINATION OF ALL GRADING AT SLOPING CONCRETE PARKING DECK AND WHERE SLOPING CONCRETE PARKING DECK MEETS PAVED SURFACES AND FOUNDATION WALL BELOW. SEE CIVIL DRAWINGS FOR COORDINATION OF ALL GRADING AT SLOPING SIDEWALK AND FLAT BUILDING SLAB.
- L. SEE STRUCTURAL DRAWINGS FOR COORDINATION OF SLOPING CONCRETE SLAB PARKING DECK.
- M. COORDINATE LOCATION OF 1" THERMAL BREAK OVER STEEL BEAM BELOW AND UNDER CURTAIN WALL ABOVE WITH STRUCTURAL

DRAWINGS.

N. CONTRACTOR SHALL EXCLUDE INSTALLATION OF SHAFT PARTITIONS, TYPICAL THROUGHOUT. SHAFT OPENING SHALL BE EXPOSED DURING CORE AND SHELL CONSTRUCTION IN PREPARATION FOR INTERIOR FIT-OUT, PROVIDE FALL PROTECTION FOR THE DURATION OF



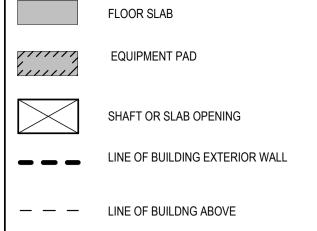

FLOOR ELEVATION DESIGNATION

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Drawing Inform	nation:	
Project No: Date: Drawn By: Checked By:	20.072 11.08.2023 JB / AV / PC JM / SH	
Sheet Name:		
BUILDIN PLANS	IG NO. 1	SLAB EDGE
Sheet No:		

## Jeffrey D. Venezia, AIA NJ RA AI 00827100

Client:

Project:

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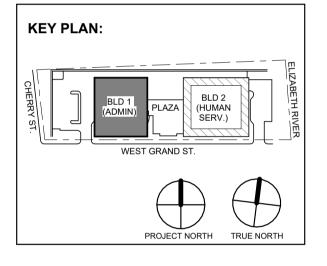
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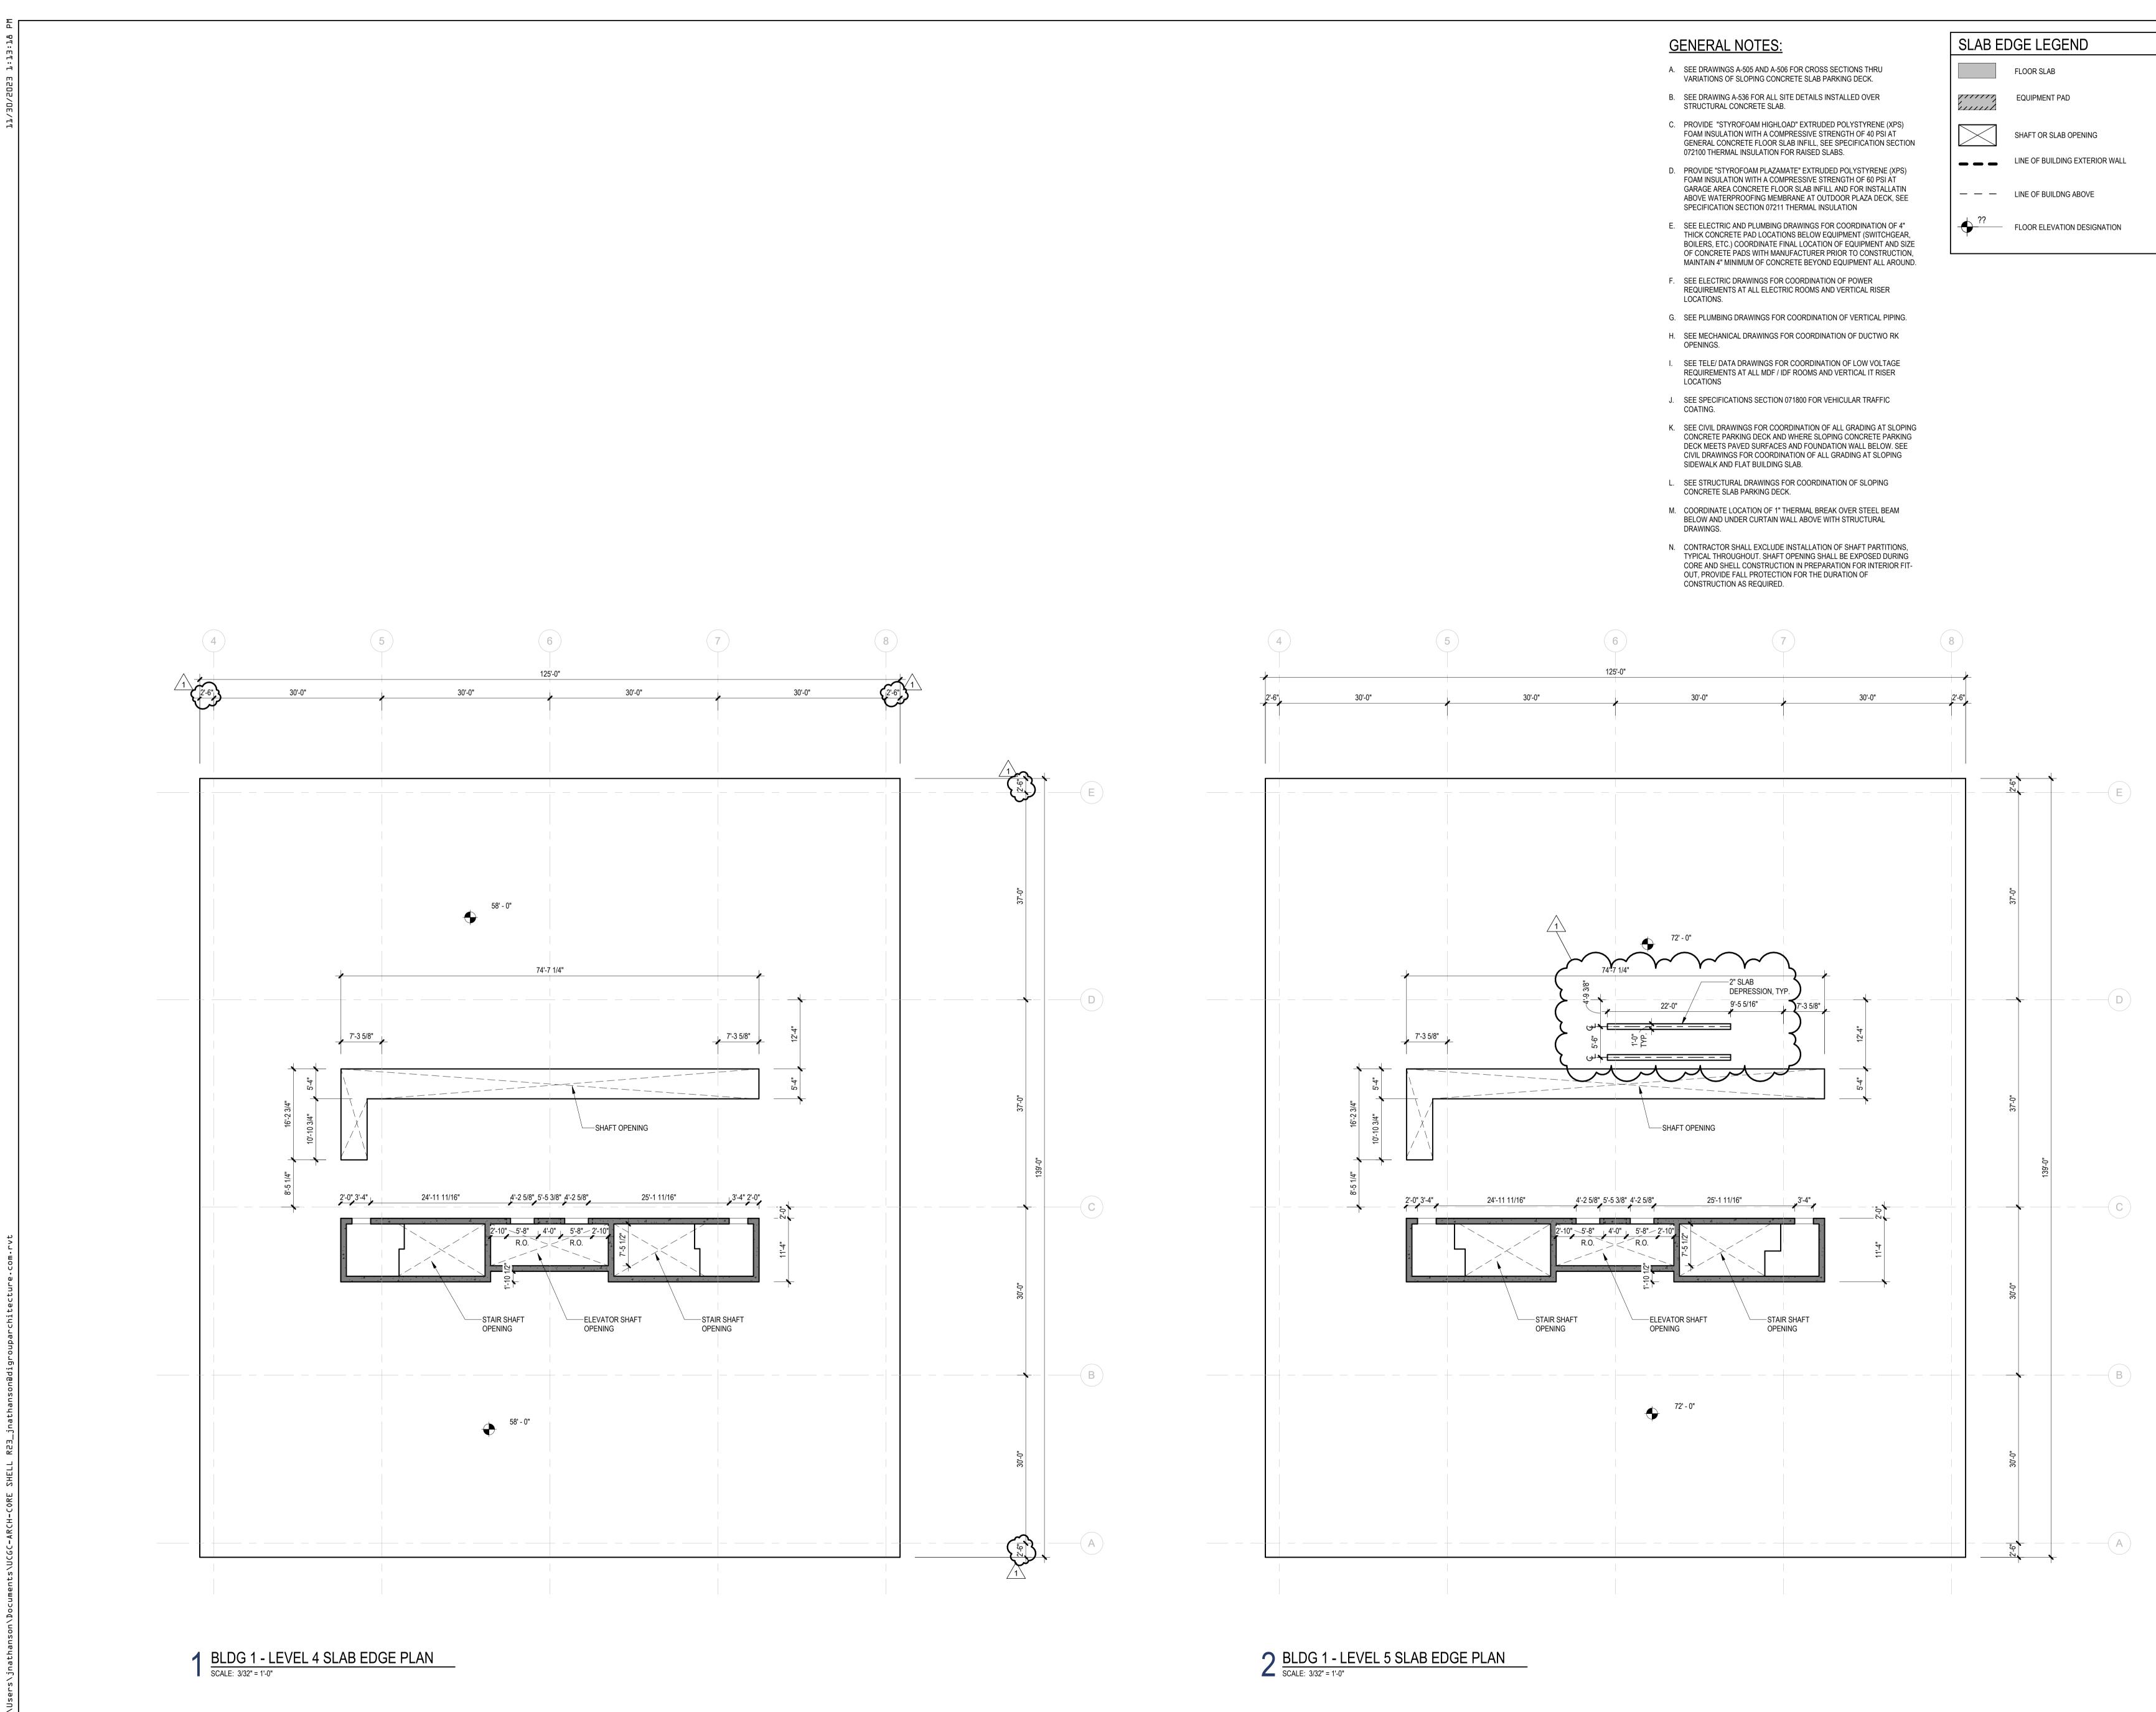
81 & 93 WEST GRAND STREET CITY OF ELIZABETH NEW JERSEY, 07202

 1
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 Date
 Description





SLAB EDGE LEGEND				
	FLOOR SLAB			
	EQUIPMENT PAD			
	SHAFT OR SLAB OPENING			
	LINE OF BUILDING EXTERIOR WALL			
	LINE OF BUILDNG ABOVE			
<del>• ??</del>	FLOOR ELEVATION DESIGNATION			

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Drawing Inform	mation:
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Sheet Name:	
BUILDIN PLANS	IG NO. 1 SLAB EDGE
	IG NO. 1 SLAB EDGE

Client: UNION COUNTY IMPROVEMENT AUTHORITY

UNION COUNTY GOVERNMENT COMPLEX


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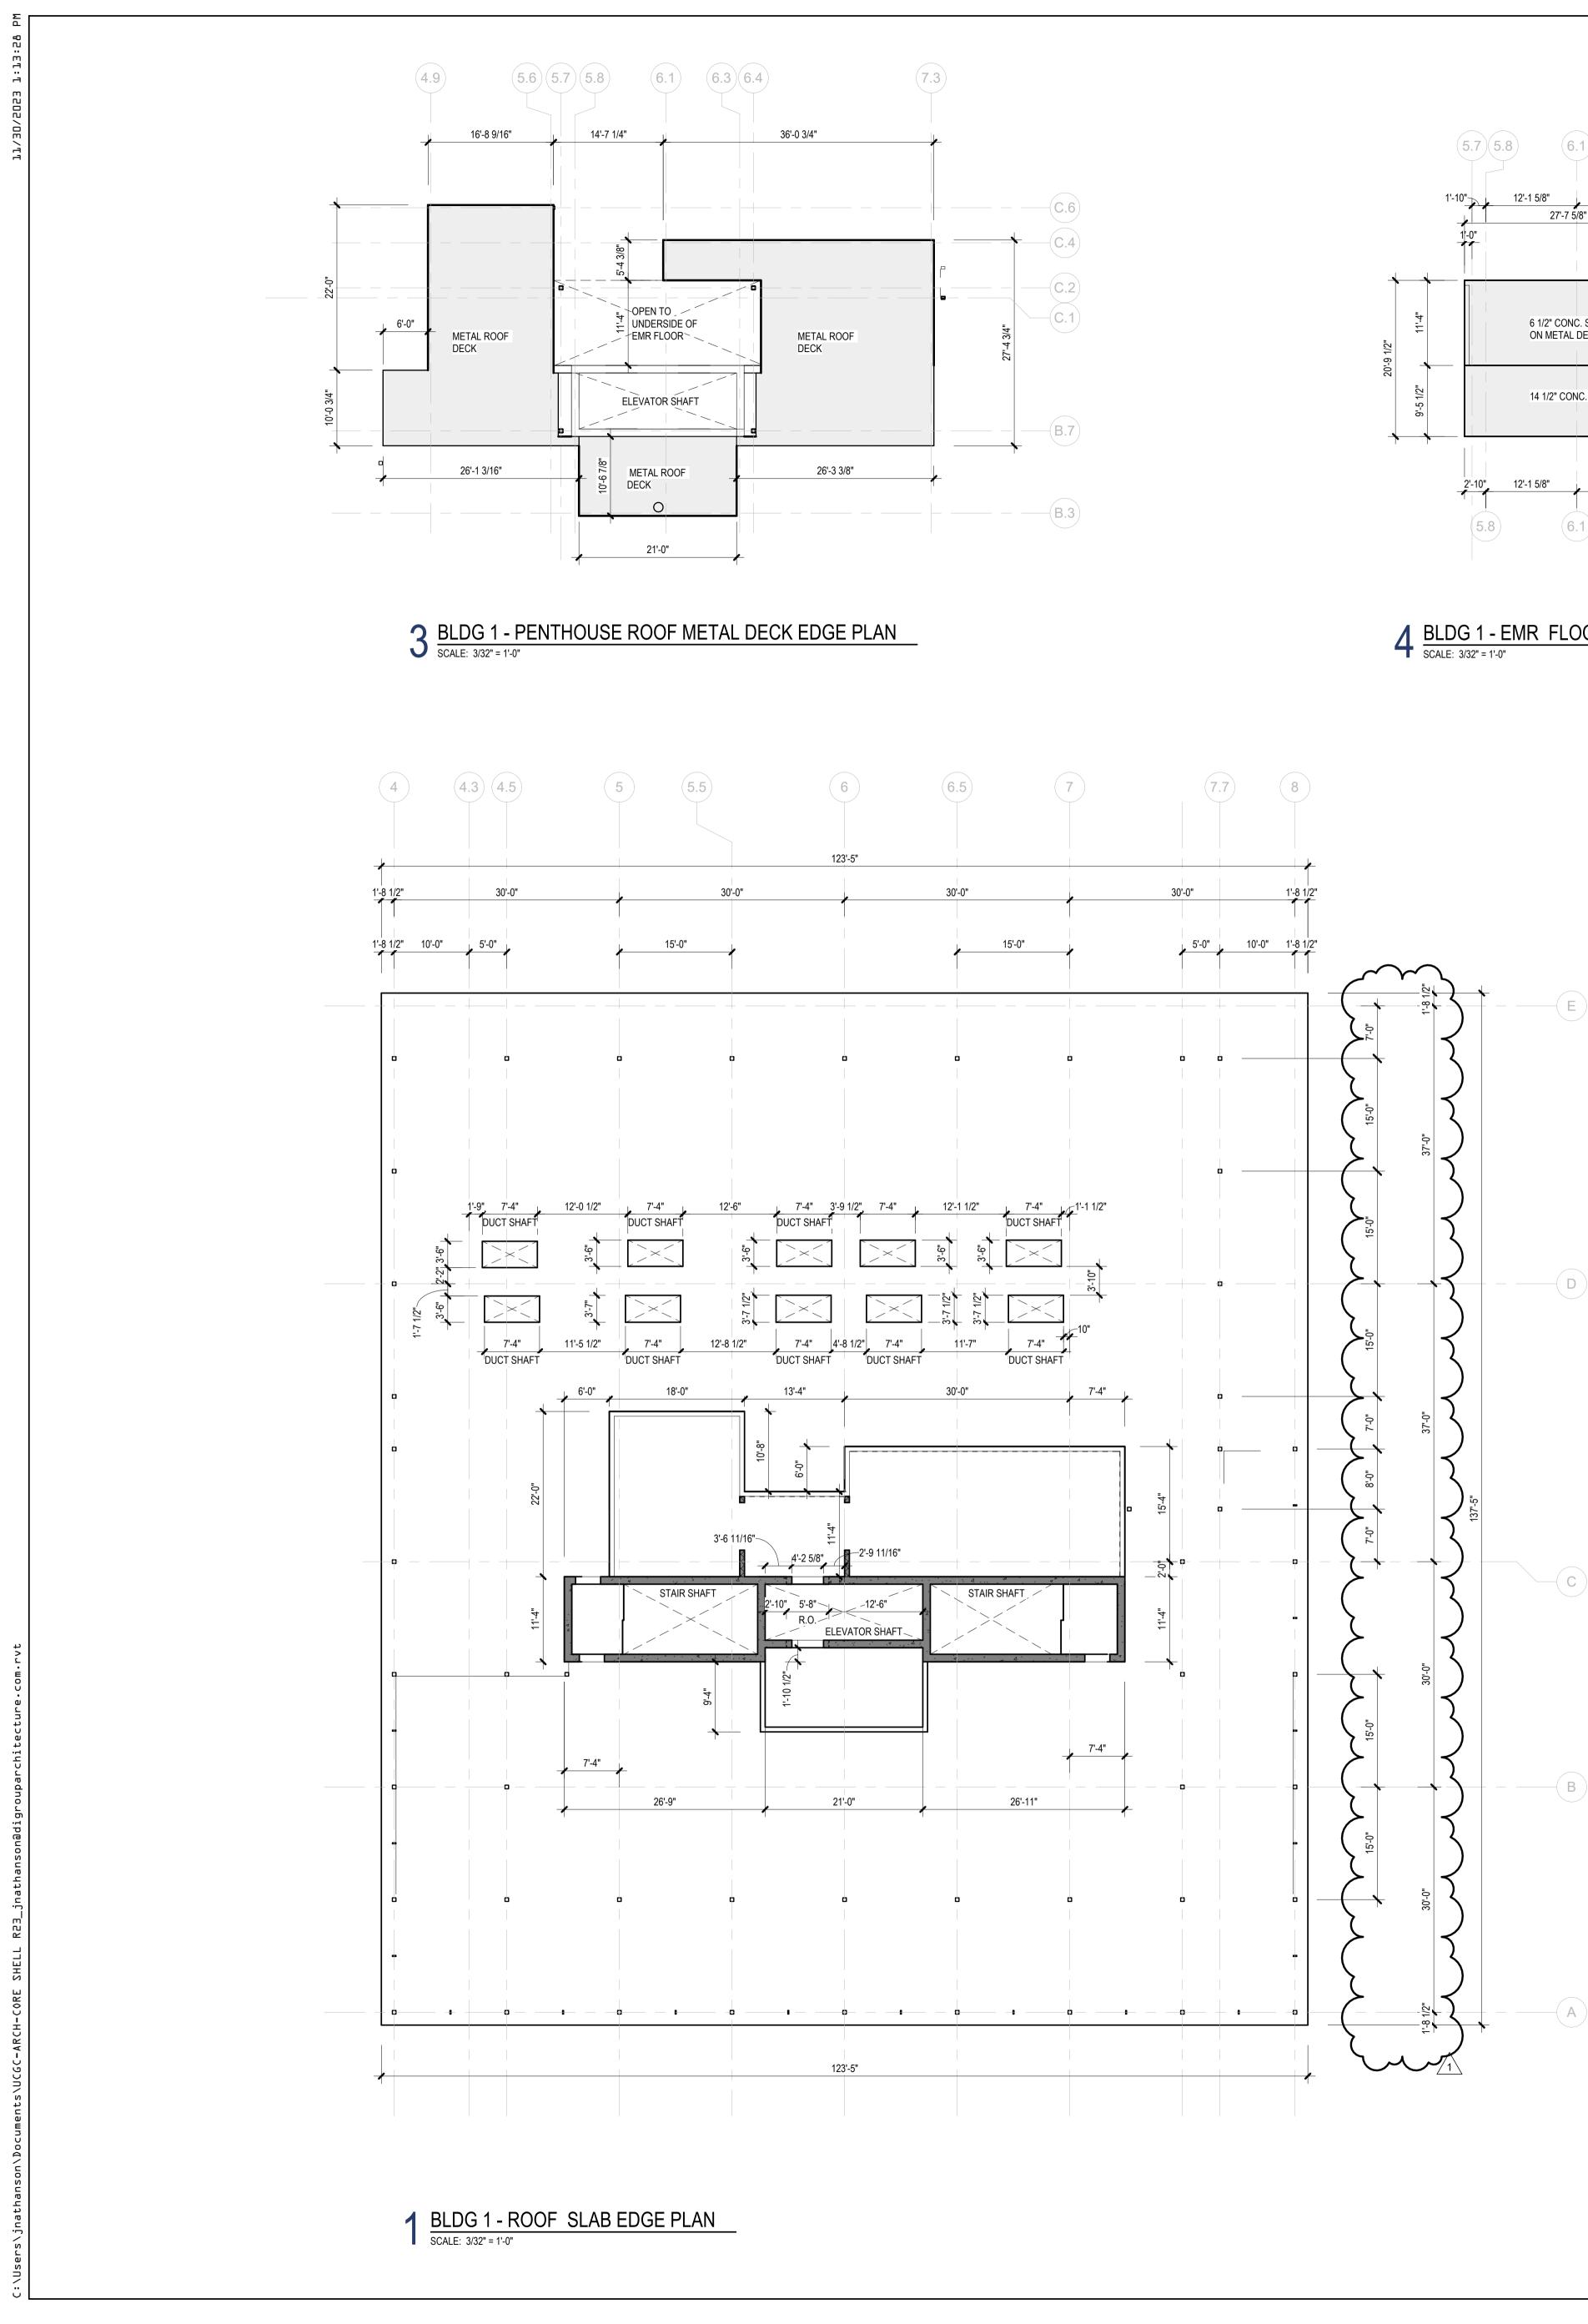
## Jeffrey D. Venezia, AIA NJ RA AI 00827100


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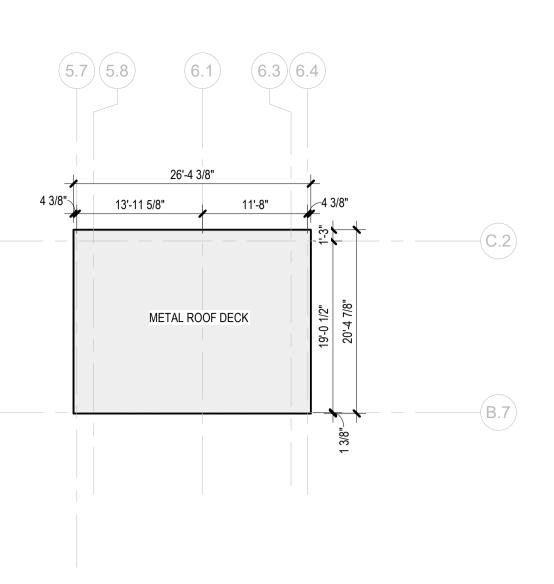
1 12.01.2023 Addendum No. 01 11.08.2023 For Public Bid No. Date Description Revisions / Issues






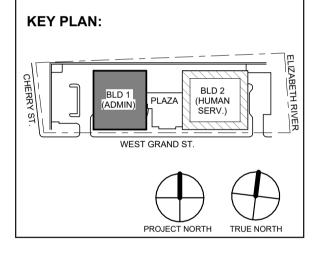

# 4 BLDG 1 - EMR FLOOR SLAB EDGE PLAN SCALE: 3/32" = 1'-0"

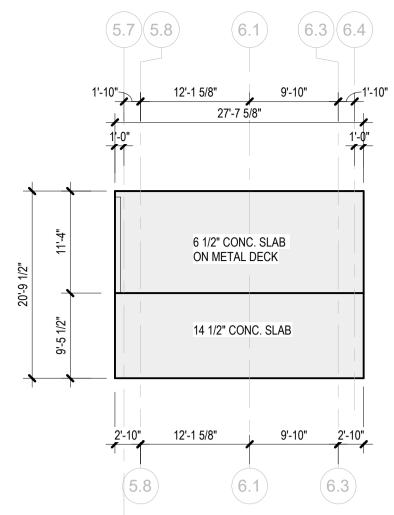


# 5 BLDG 1 - EMR - ROOF METAL DECK EDGE PLAN SCALE: 3/32" = 1'-0"

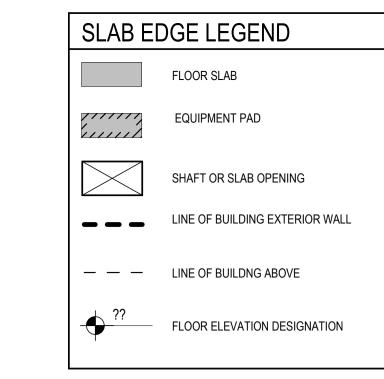

### **GENERAL NOTES:**

- A. SEE DRAWINGS A-505 AND A-506 FOR CROSS SECTIONS THRU VARIATIONS OF SLOPING CONCRETE SLAB PARKING DECK.
- B. SEE DRAWING A-536 FOR ALL SITE DETAILS INSTALLED OVER STRUCTURAL CONCRETE SLAB.
- C. PROVIDE "STYROFOAM HIGHLOAD" EXTRUDED POLYSTYRENE (XPS) FOAM INSULATION WITH A COMPRESSIVE STRENGTH OF 40 PSI AT GENERAL CONCRETE FLOOR SLAB INFILL, SEE SPECIFICATION SECTION 072100 THERMAL INSULATION FOR RAISED SLABS.
- D. PROVIDE "STYROFOAM PLAZAMATE" EXTRUDED POLYSTYRENE (XPS) FOAM INSULATION WITH A COMPRESSIVE STRENGTH OF 60 PSI AT GARAGE AREA CONCRETE FLOOR SLAB INFILL AND FOR INSTALLATIN ABOVE WATERPROOFING MEMBRANE AT OUTDOOR PLAZA DECK, SEE SPECIFICATION SECTION 07211 THERMAL INSULATION
- E. SEE ELECTRIC AND PLUMBING DRAWINGS FOR COORDINATION OF 4" THICK CONCRETE PAD LOCATIONS BELOW EQUIPMENT (SWITCHGEAR, BOILERS, ETC.) COORDINATE FINAL LOCATION OF EQUIPMENT AND SIZE OF CONCRETE PADS WITH MANUFACTURER PRIOR TO CONSTRUCTION, MAINTAIN 4" MINIMUM OF CONCRETE BEYOND EQUIPMENT ALL AROUND.
- F. SEE ELECTRIC DRAWINGS FOR COORDINATION OF POWER REQUIREMENTS AT ALL ELECTRIC ROOMS AND VERTICAL RISER LOCATIONS.
- G. SEE PLUMBING DRAWINGS FOR COORDINATION OF VERTICAL PIPING. H. SEE MECHANICAL DRAWINGS FOR COORDINATION OF DUCTWO RK OPENINGS.
- I. SEE TELE/ DATA DRAWINGS FOR COORDINATION OF LOW VOLTAGE REQUIREMENTS AT ALL MDF / IDF ROOMS AND VERTICAL IT RISER LOCATIONS
- J. SEE SPECIFICATIONS SECTION 071800 FOR VEHICULAR TRAFFIC COATING.
- K. SEE CIVIL DRAWINGS FOR COORDINATION OF ALL GRADING AT SLOPING CONCRETE PARKING DECK AND WHERE SLOPING CONCRETE PARKING DECK MEETS PAVED SURFACES AND FOUNDATION WALL BELOW. SEE CIVIL DRAWINGS FOR COORDINATION OF ALL GRADING AT SLOPING SIDEWALK AND FLAT BUILDING SLAB.
- L. SEE STRUCTURAL DRAWINGS FOR COORDINATION OF SLOPING CONCRETE SLAB PARKING DECK.
- M. COORDINATE LOCATION OF 1" THERMAL BREAK OVER STEEL BEAM BELOW AND UNDER CURTAIN WALL ABOVE WITH STRUCTURAL DRAWINGS.
- N. CONTRACTOR SHALL EXCLUDE INSTALLATION OF SHAFT PARTITIONS, TYPICAL THROUGHOUT. SHAFT OPENING SHALL BE EXPOSED DURING CORE AND SHELL CONSTRUCTION IN PREPARATION FOR INTERIOR FIT-OUT, PROVIDE FALL PROTECTION FOR THE DURATION OF CONSTRUCTION AS REQUIRED.

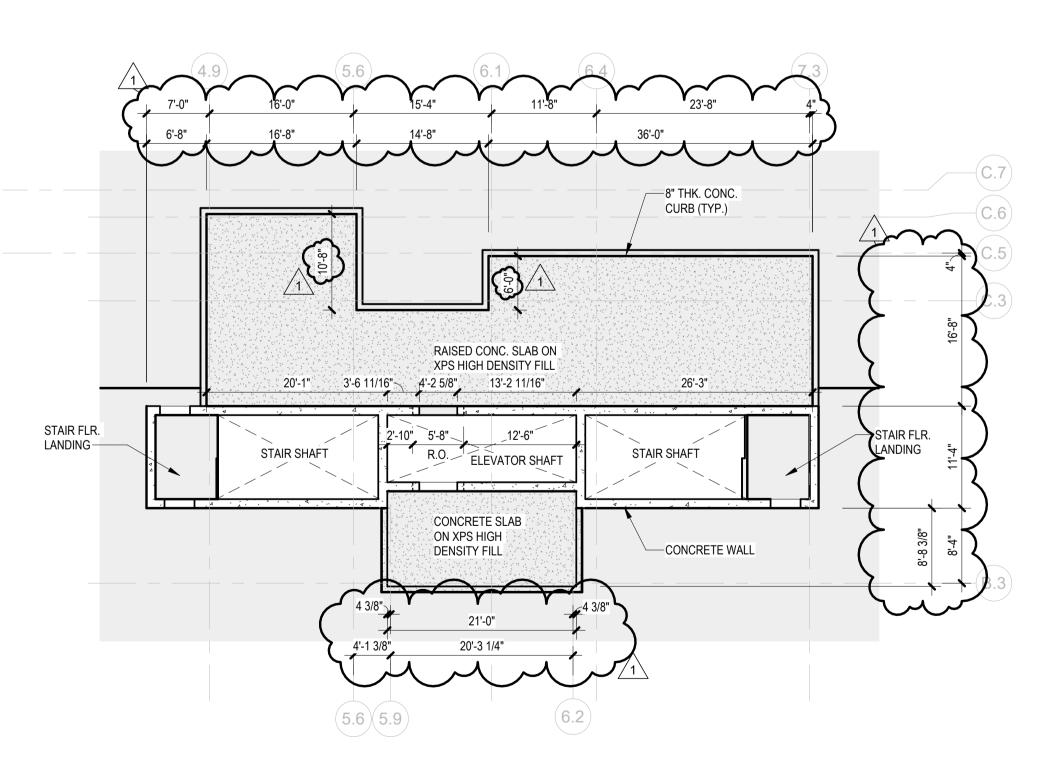

2 BLDG 1 - PENTHOUSE FLOOR SLAB EDGE PLAN SCALE: 3/32" = 1'-0"

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COMPLEX	
•••	T GRAND STREET
CITY OF ELIZ	
NEW JERSEN	7, 07202
Drawing Inform	nation:
Project No:	20.072
	11.08.2023
Drawn By:	JB / AV / PC
Checked By:	JM / SH
Sheet Name:	
BUILDIN	IG NO. 1 SLAB EDGE
	IG NO. 1 SLAB EDGE
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Client: UNION COUNTY IMPROVEMENT AUTHORITY


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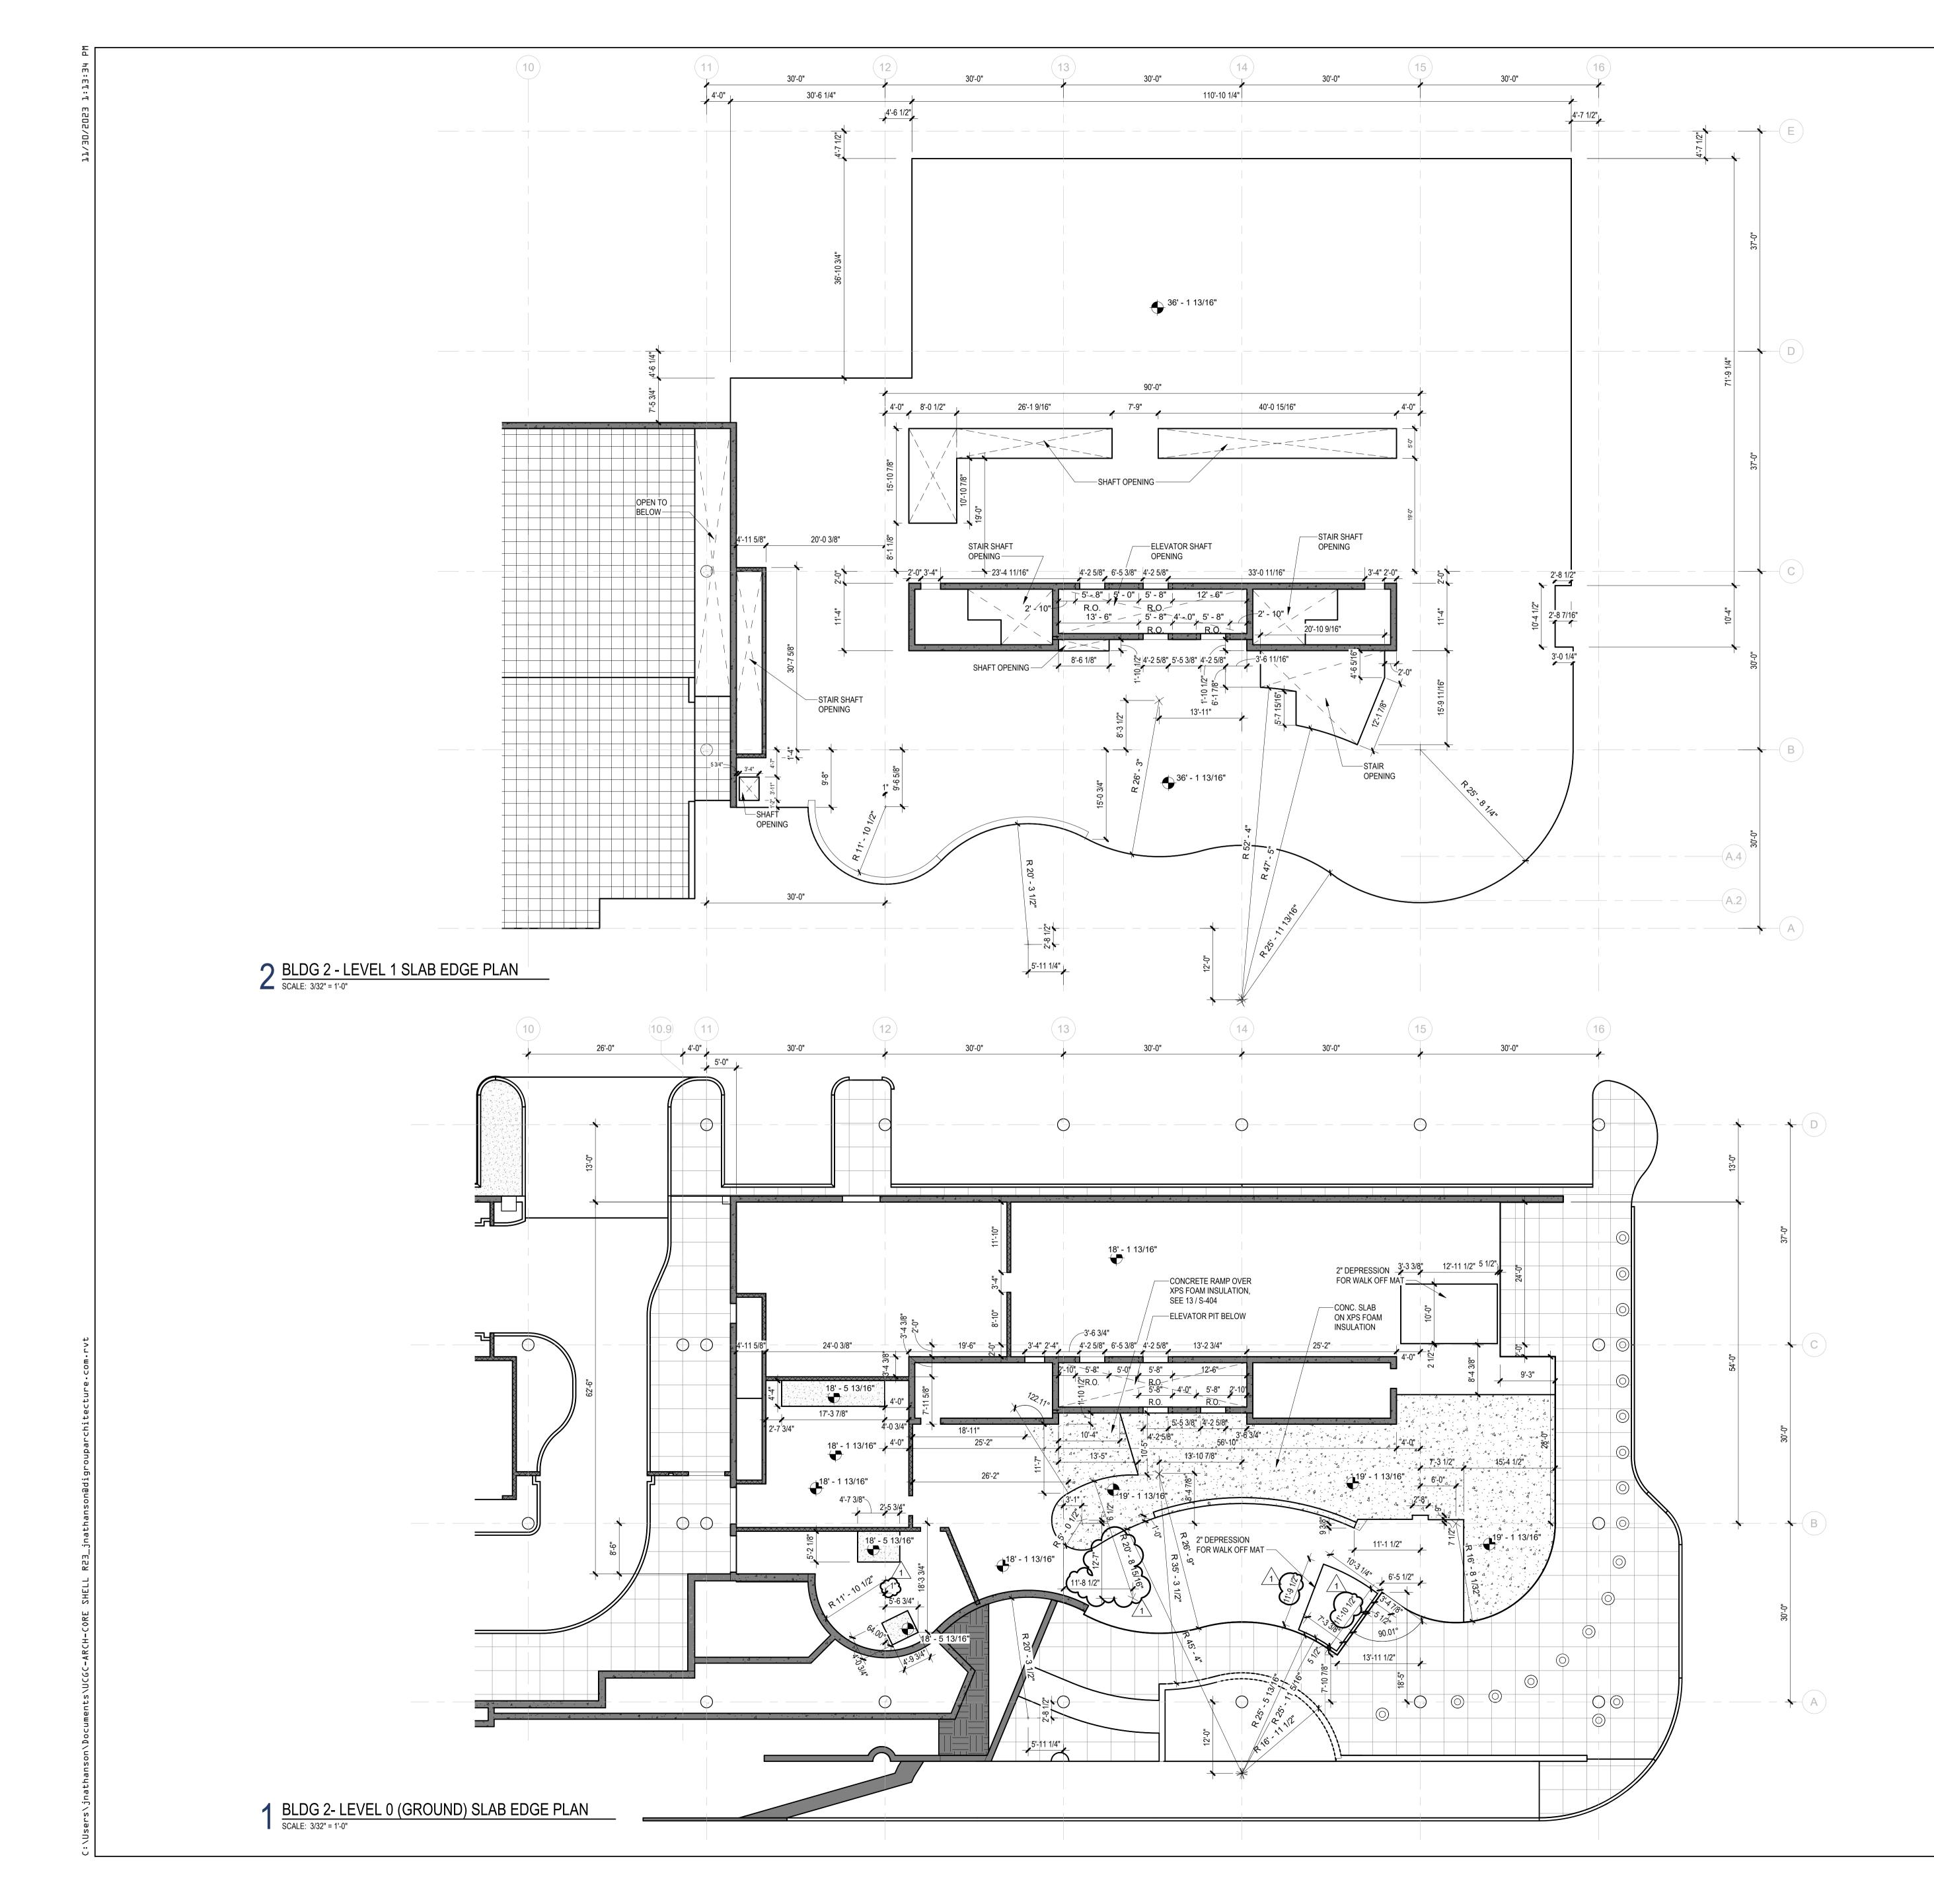
### Jeffrey D. Venezia, AIA NJ RÁ AI 00827100

Project:

**DIGroup**Arch ARCHITECTURE FOR CHANGE 15 Bethany Street • New Brunswick, NJ 08901 • T: 732.249.6242 2450 W Hunting Park Ave • Philadelphia, PA 19122 • T: 215.634.3400

1 12.01.2023 Addendum No. 01 11.08.2023 For Public Bid No. Date Description **Revisions / Issues** 



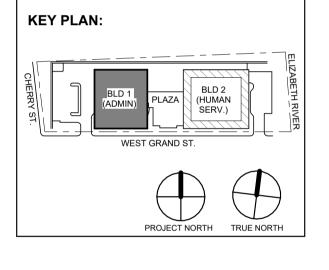

SLAB EDGE LEGEND				
	FLOOR SLAB			
	EQUIPMENT PAD			
	SHAFT OR SLAB OPENING			
	LINE OF BUILDING EXTERIOR WALL			
	LINE OF BUILDNG ABOVE			
• <u>??</u>	FLOOR ELEVATION DESIGNATION			

### GENERAL NOTES:

- A. SEE DRAWINGS A-505 AND A-506 FOR CROSS SECTIONS THRU VARIATIONS OF SLOPING CONCRETE SLAB PARKING DECK.
- B. SEE DRAWING A-536 FOR ALL SITE DETAILS INSTALLED OVER STRUCTURAL CONCRETE SLAB.
- C. PROVIDE "STYROFOAM HIGHLOAD" EXTRUDED POLYSTYRENE (XPS) FOAM INSULATION WITH A COMPRESSIVE STRENGTH OF 40 PSI AT GENERAL CONCRETE FLOOR SLAB INFILL, SEE SPECIFICATION SECTION 072100 THERMAL INSULATION FOR RAISED SLABS.
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- E. SEE ELECTRIC AND PLUMBING DRAWINGS FOR COORDINATION OF 4" THICK CONCRETE PAD LOCATIONS BELOW EQUIPMENT (SWITCHGEAR, BOILERS, ETC.) COORDINATE FINAL LOCATION OF EQUIPMENT AND SIZE OF CONCRETE PADS WITH MANUFACTURER PRIOR TO CONSTRUCTION, MAINTAIN 4" MINIMUM OF CONCRETE BEYOND EQUIPMENT ALL AROUND.
- F. SEE ELECTRIC DRAWINGS FOR COORDINATION OF POWER REQUIREMENTS AT ALL ELECTRIC ROOMS AND VERTICAL RISER LOCATIONS.
- G. SEE PLUMBING DRAWINGS FOR COORDINATION OF VERTICAL PIPING.H. SEE MECHANICAL DRAWINGS FOR COORDINATION OF DUCTWO RK OPENINGS.
- I. SEE TELE/ DATA DRAWINGS FOR COORDINATION OF LOW VOLTAGE REQUIREMENTS AT ALL MDF / IDF ROOMS AND VERTICAL IT RISER LOCATIONS
- J. SEE SPECIFICATIONS SECTION 071800 FOR VEHICULAR TRAFFIC COATING.
- K. SEE CIVIL DRAWINGS FOR COORDINATION OF ALL GRADING AT SLOPING CONCRETE PARKING DECK AND WHERE SLOPING CONCRETE PARKING DECK MEETS PAVED SURFACES AND FOUNDATION WALL BELOW. SEE CIVIL DRAWINGS FOR COORDINATION OF ALL GRADING AT SLOPING SIDEWALK AND FLAT BUILDING SLAB.
- L. SEE STRUCTURAL DRAWINGS FOR COORDINATION OF SLOPING CONCRETE SLAB PARKING DECK.
- M. COORDINATE LOCATION OF 1" THERMAL BREAK OVER STEEL BEAM BELOW AND UNDER CURTAIN WALL ABOVE WITH STRUCTURAL DRAWINGS.
- N. CONTRACTOR SHALL EXCLUDE INSTALLATION OF SHAFT PARTITIONS, TYPICAL THROUGHOUT. SHAFT OPENING SHALL BE EXPOSED DURING CORE AND SHELL CONSTRUCTION IN PREPARATION FOR INTERIOR FIT-OUT, PROVIDE FALL PROTECTION FOR THE DURATION OF CONSTRUCTION AS REQUIRED.

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Project:
UNION COUNTY GOVERNMENT COMPLEX 81 & 93 WEST GRAND STREET CITY OF ELIZABETH NEW JERSEY, 07202
Drawing Information:Project No:20.072Date:11.08.2023Drawn By:JB / AV / PCChecked By:JM / SH
Sheet Name:
BUILDING NO. 2 SLAB EDGE PLANS
Sheet No:
CS-311

### Jeffrey D. Venezia, AIA NJ RA AI 00827100


Revisions / Issues


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Drawing Information: Project No: 20.072 Date: 11.08.2023 Drawn By: JB / AV / PC Checked By: JM / SH
Sheet Name:
OVERALL EXTERIOR ELEVATIONS
A-301


## Jeffrey D. Venezia, AIA NJ RA AI 00827100

1 12.01.2023 Addendum No. 01

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KEY PLAN: PROJECT NORTH TRUE NORTH

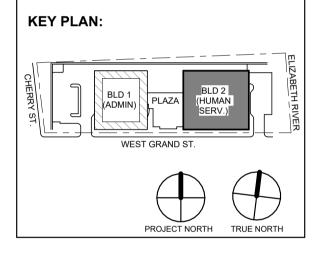
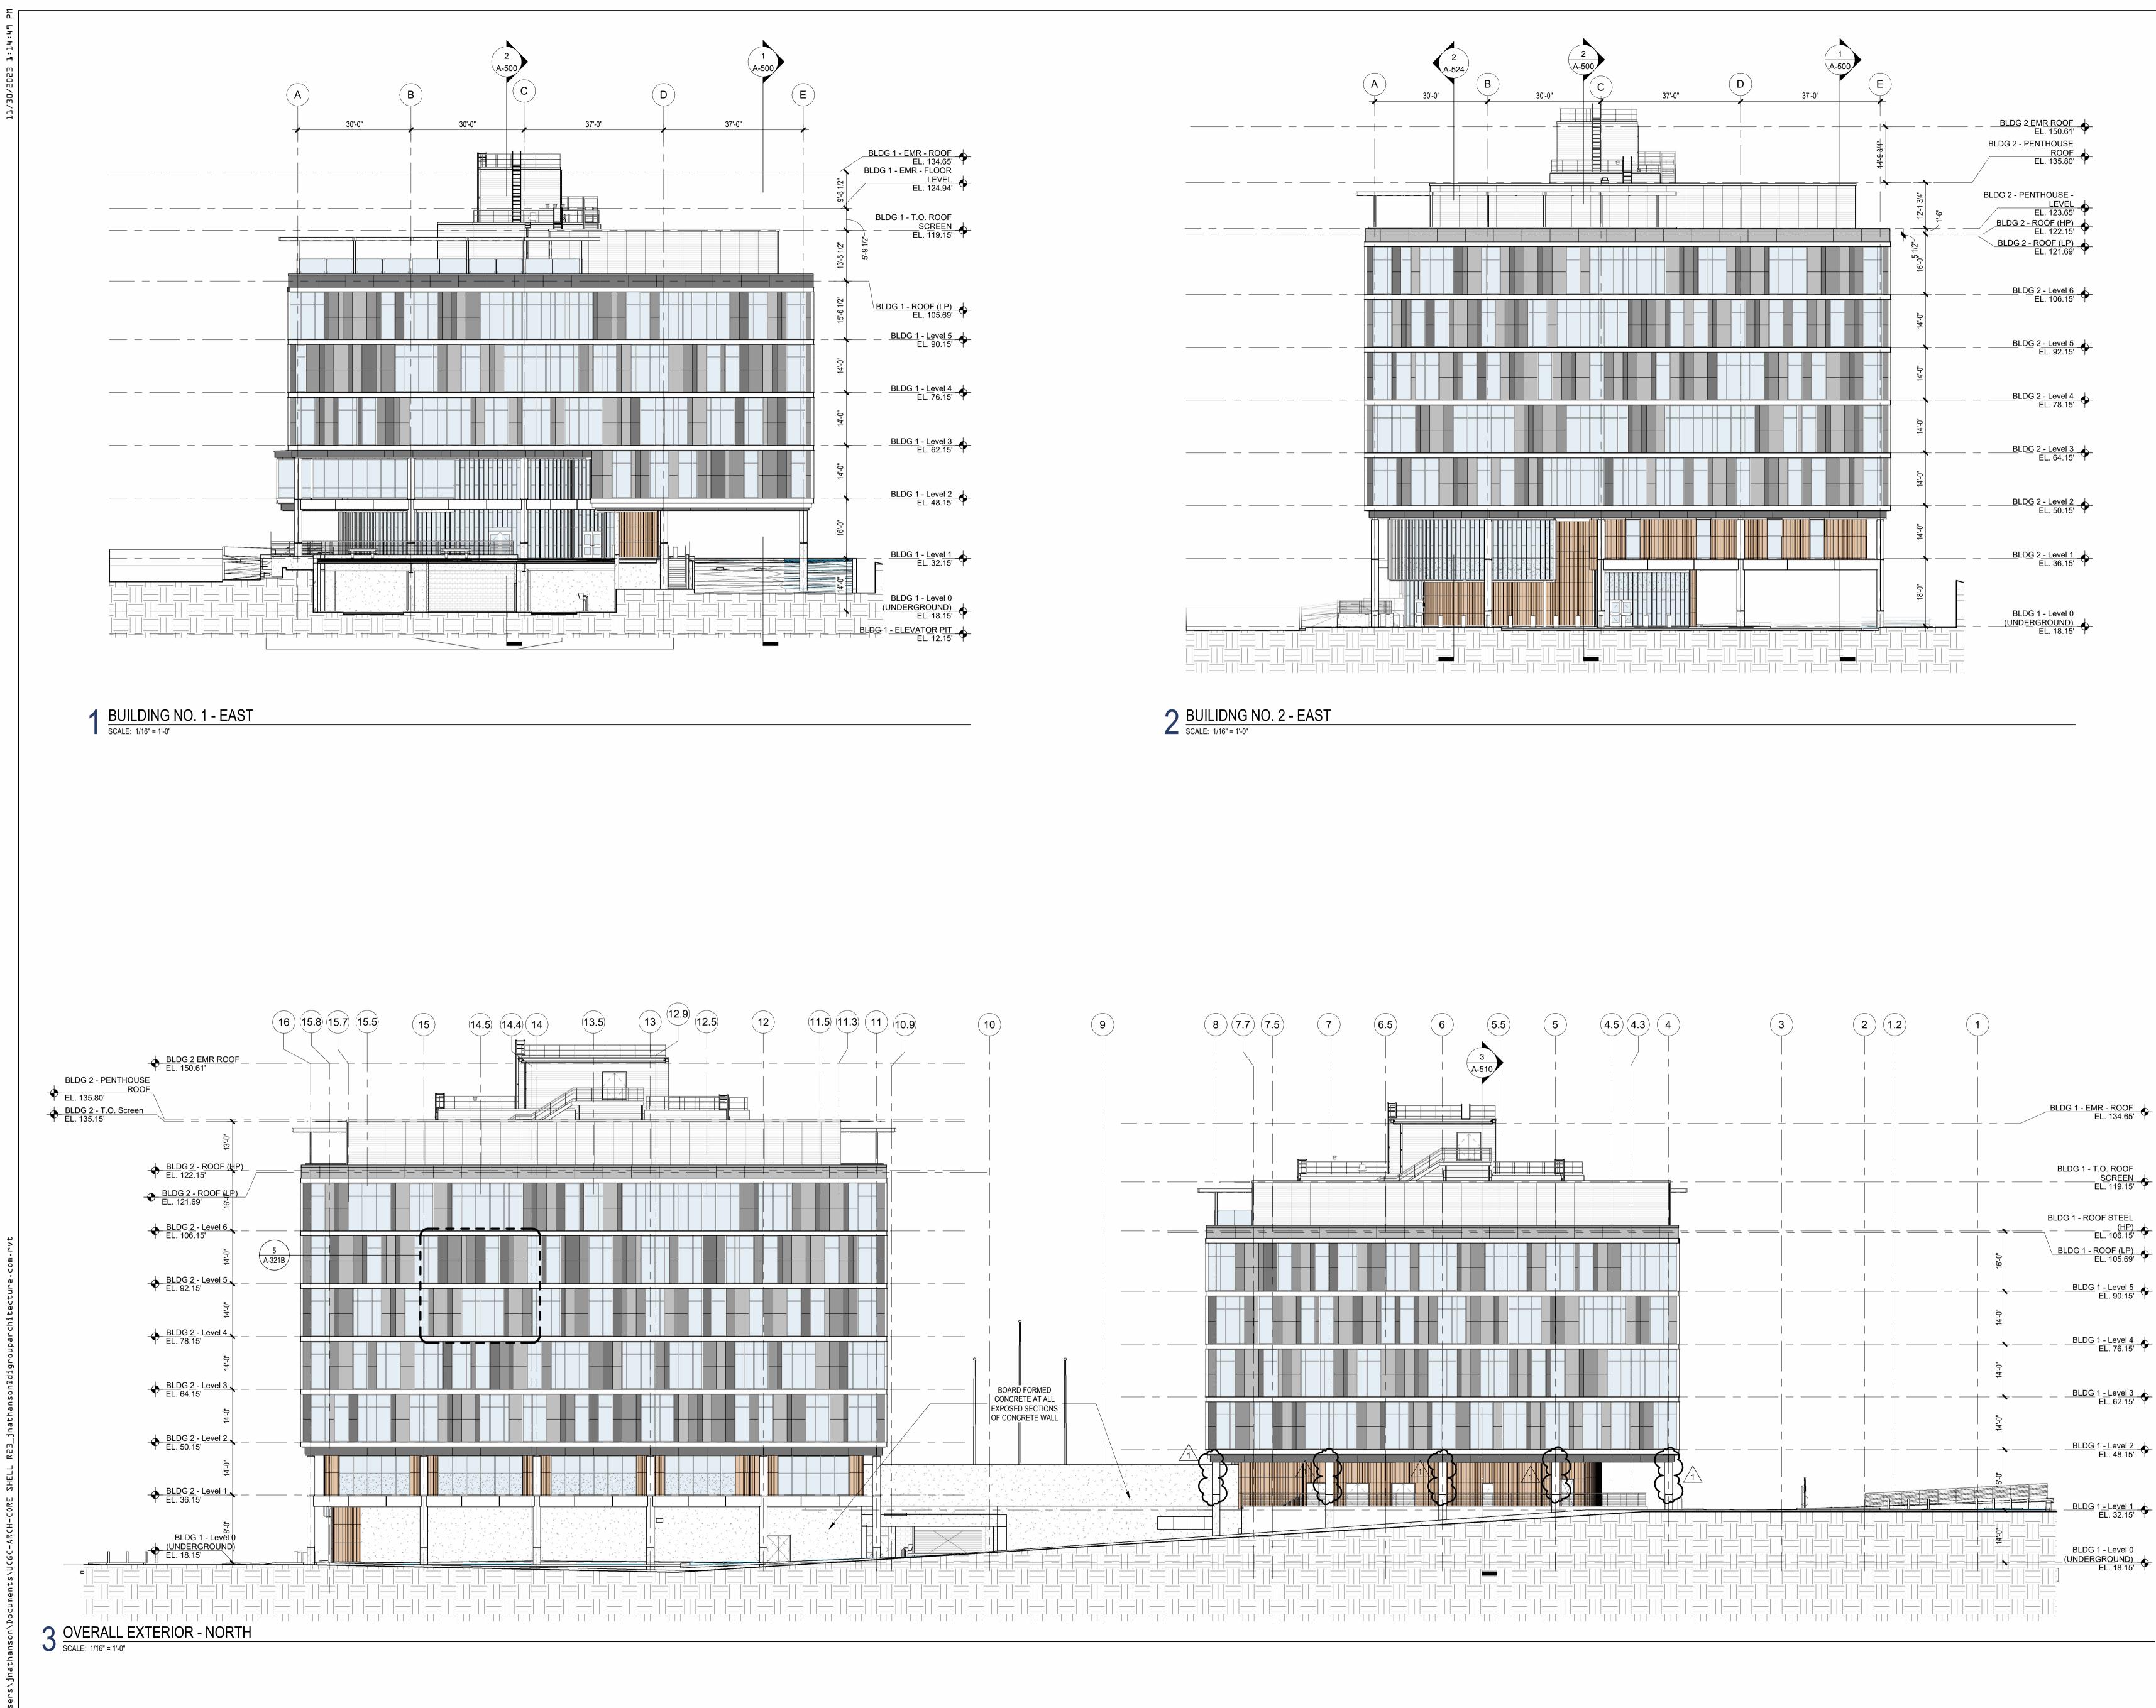
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Client:
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Project:
UNION COUNTY GOVERNMENT COMPLEX 81 & 93 WEST GRAND STREET CITY OF ELIZABETH NEW JERSEY, 07202
Drawing Information:
Project No: 20.072 Date: 11.08.2023 Drawn By: JB / AV / PC Checked By: JM / SH
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OVERALL EXTERIOR ELEVATIONS
Sheet No:
A-302
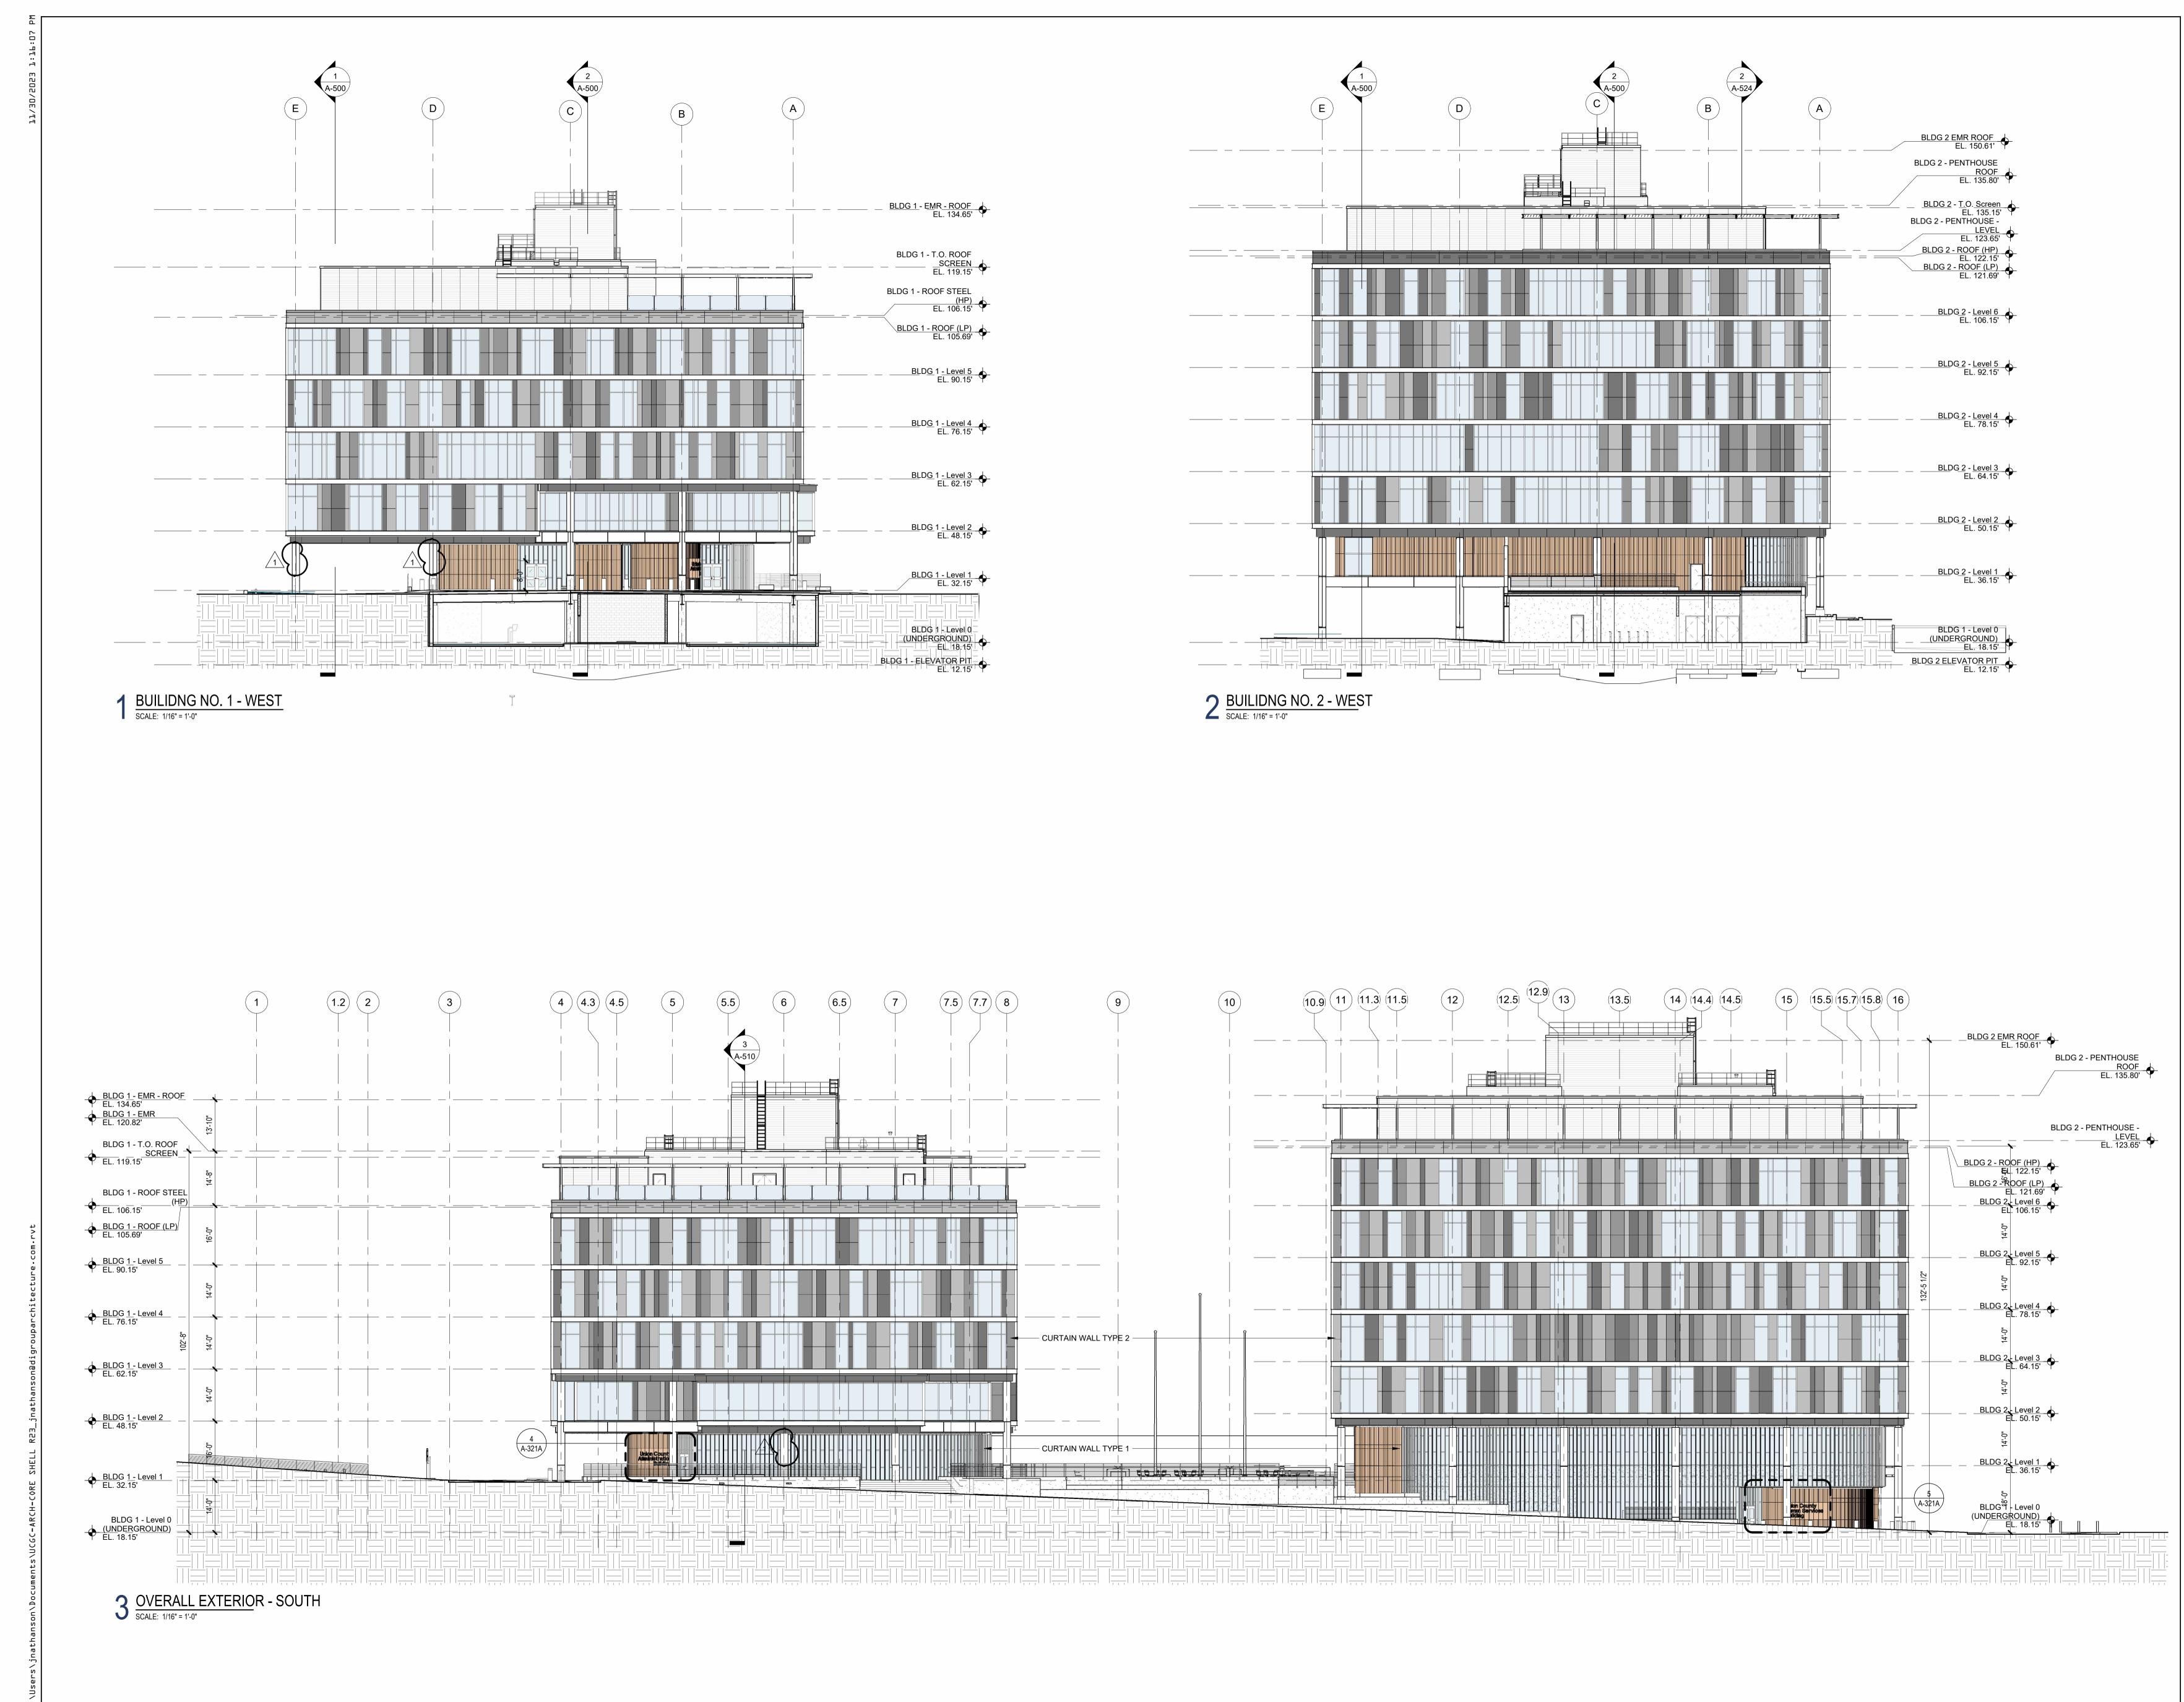
### Jeffrey D. Venezia, AIA NJ RÁ AI 00827100


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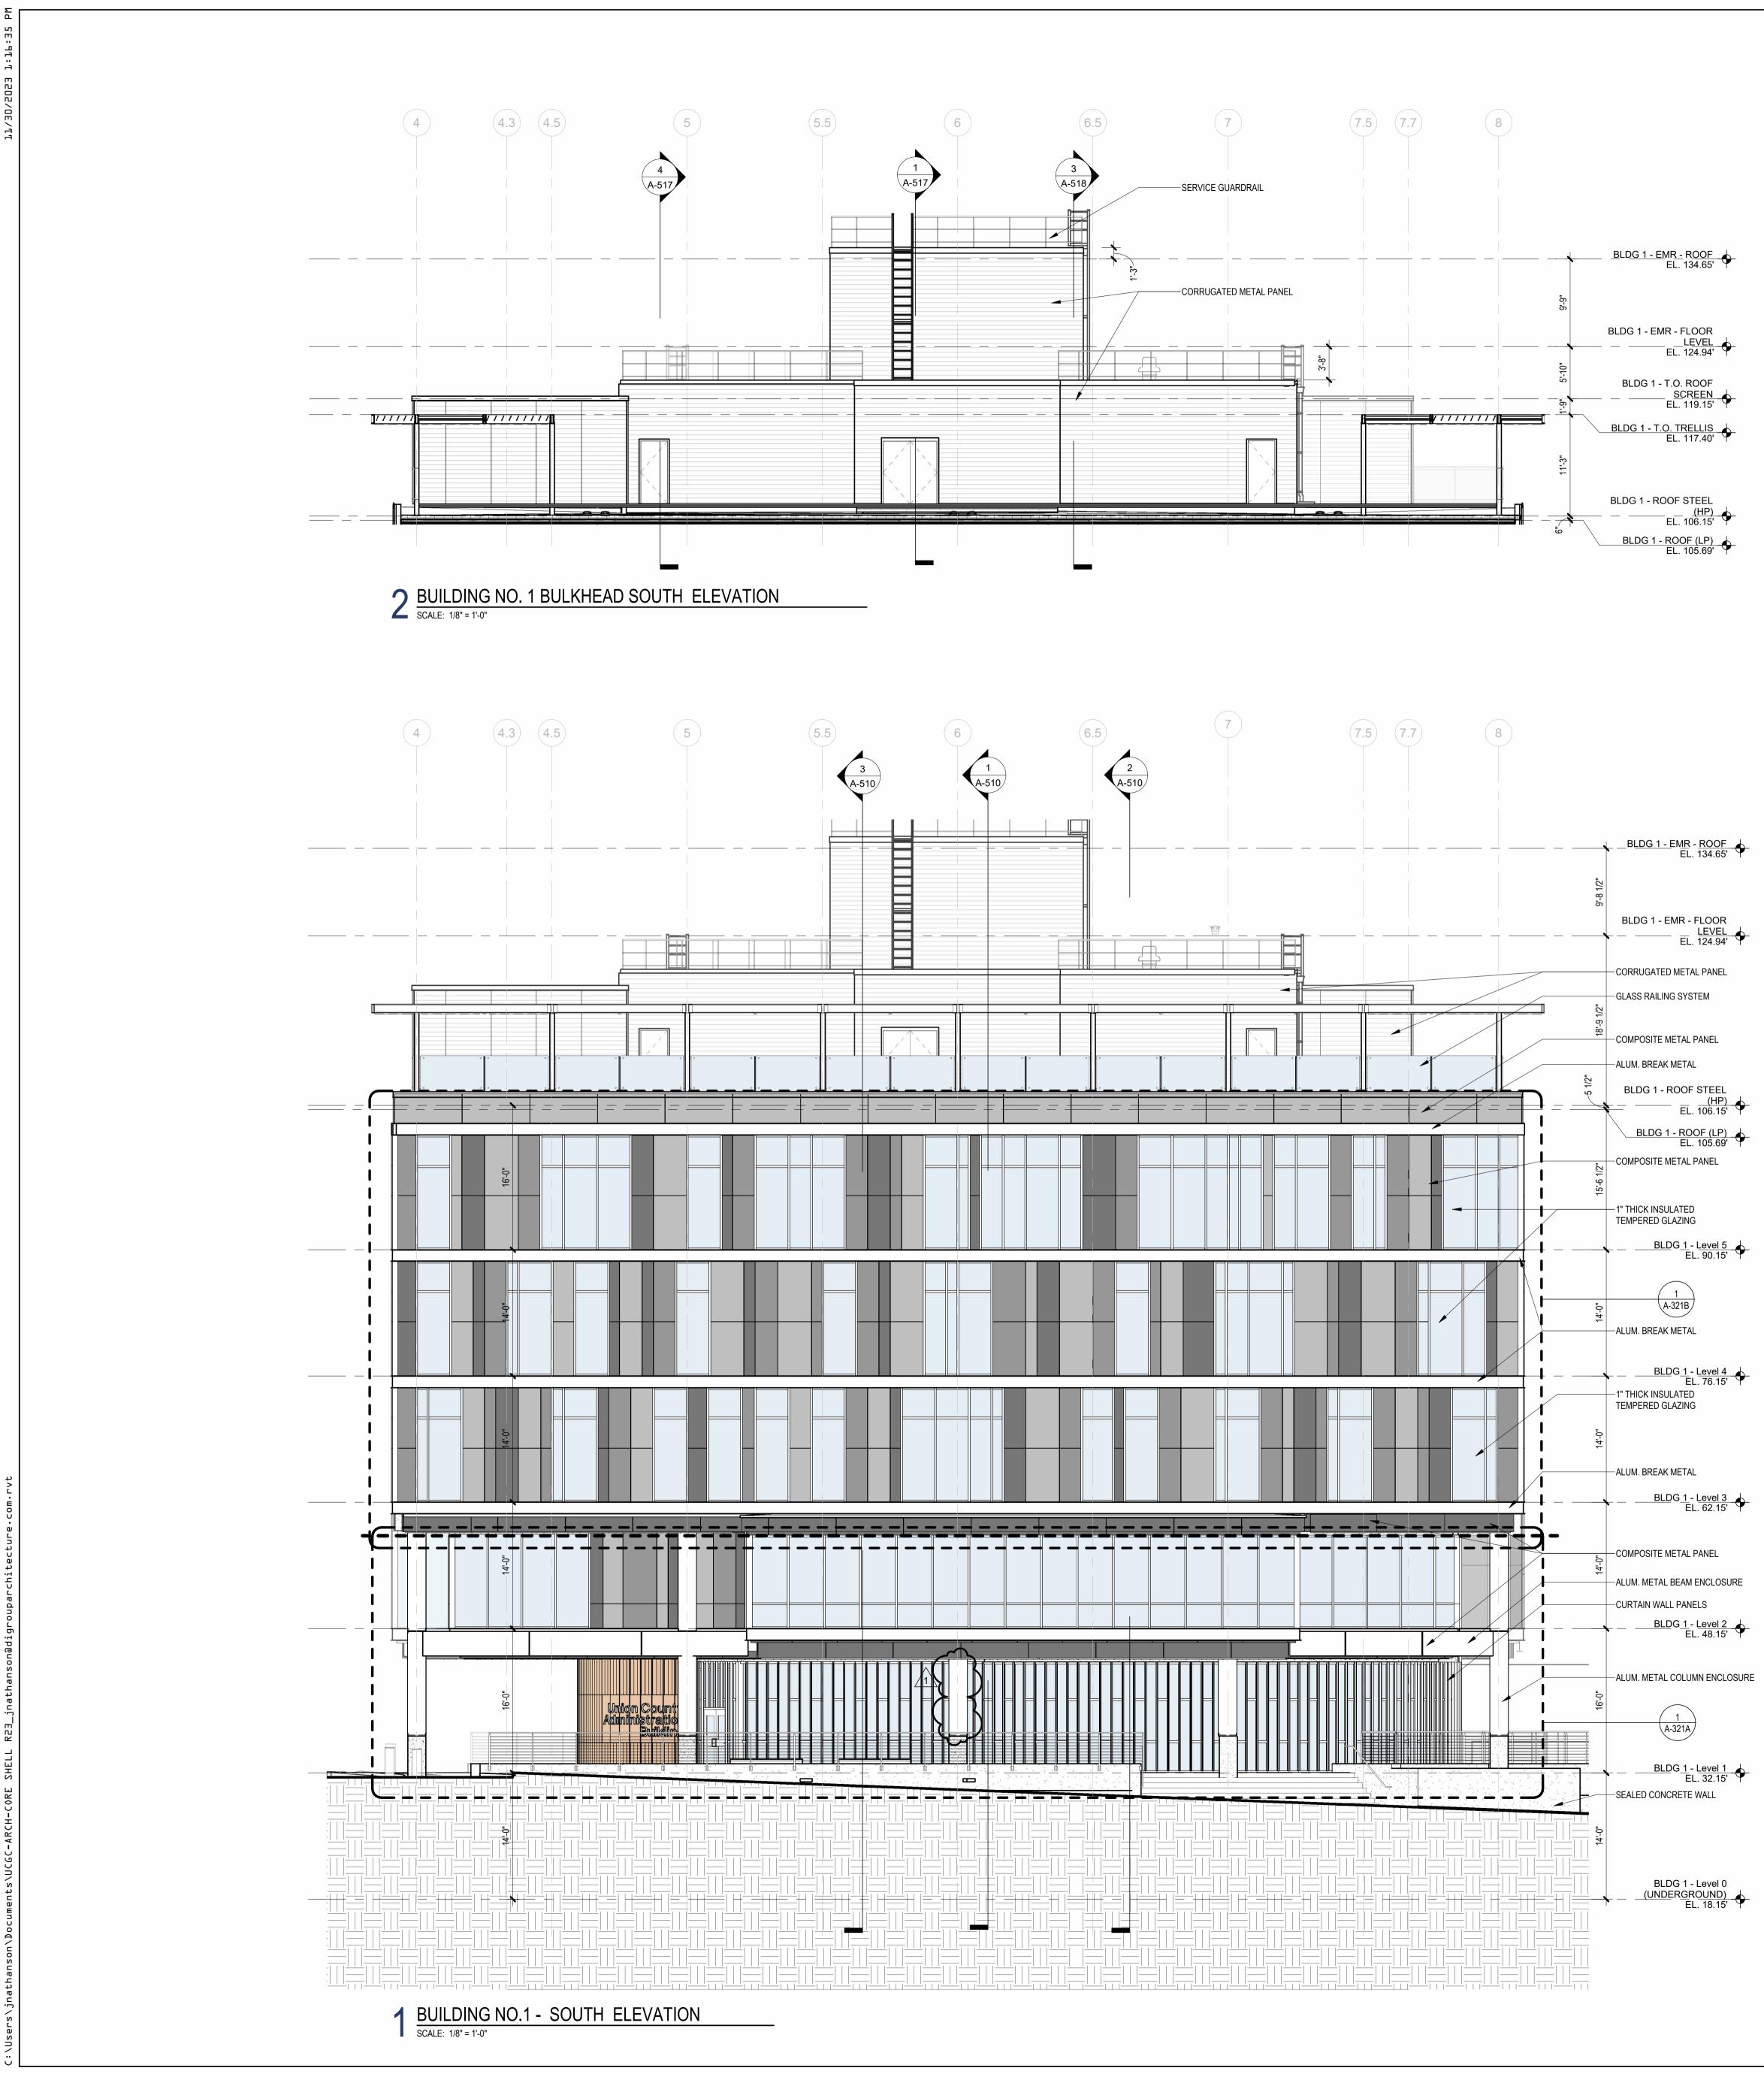
Revisions / Issues **DIGroup**Architecture ARCHITECTURE FOR CHANGE 15 Bethany Street • New Brunswick, NJ 08901 • T: 732.249.6242 2450 W Hunting Park Ave • Philadelphia, PA 19122 • T: 215.634.3400

12.01.2023 Addendum No. 01

11.08.2023 For Public Bid

Description



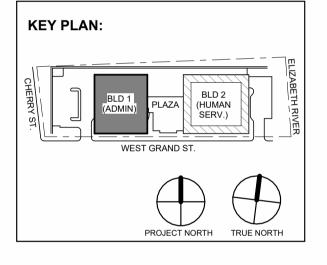

МАТ	ERIAL	
	GL-1	1" THICK CLEAR INSULATED TEMPERED GLAZING
	GL-3	1" THICK CERAMIC FRIT SPANDREL GLAZING
	GL-4	1" THICK INSULATED TEMPERED ACID ETCHED FROSTED GLAZING
	GL-5	1" THICK CLEAR INSULATED TEMPERED TRIPLE GLAZING W/ CUSTOM SEAL
	CMP-1	COMPOSITE METAL PANEL WITH COLOR NO. 1
	CMP-2	COMPOSITE METAL PANEL WITH COLOR NO. 2
	CMP-3	COMPOSITE METAL PANEL WITH COLOR NO. 3
	TCP-4	TERRACOTTA WALL SYSTEM FLAT
	TCP-4A	TERRACOTTA WALL SYSTEM FLUTED
	CMP-5	CORRUGATED METAL PANEL
	CMP-6	CORRUGATED METAL PANEL W/ PERFORATIONS
	CW-1	SEALED CONCRETE WALL WITH BOARD TEXTURE FINISH

### NOTES

1. REFER TO A-450 SERIES DRAWINGS FOR ADDITIONAL CURTAIN WALL DETAILS AND ENLARGED CURTAIN WALL ELEVATIONS.

2. CURTAIN WALL TYPE 1 VERTICAL MULLIONS TO RECEIVE MULLION COVER. REFER TO DETAIL 10/A-450.

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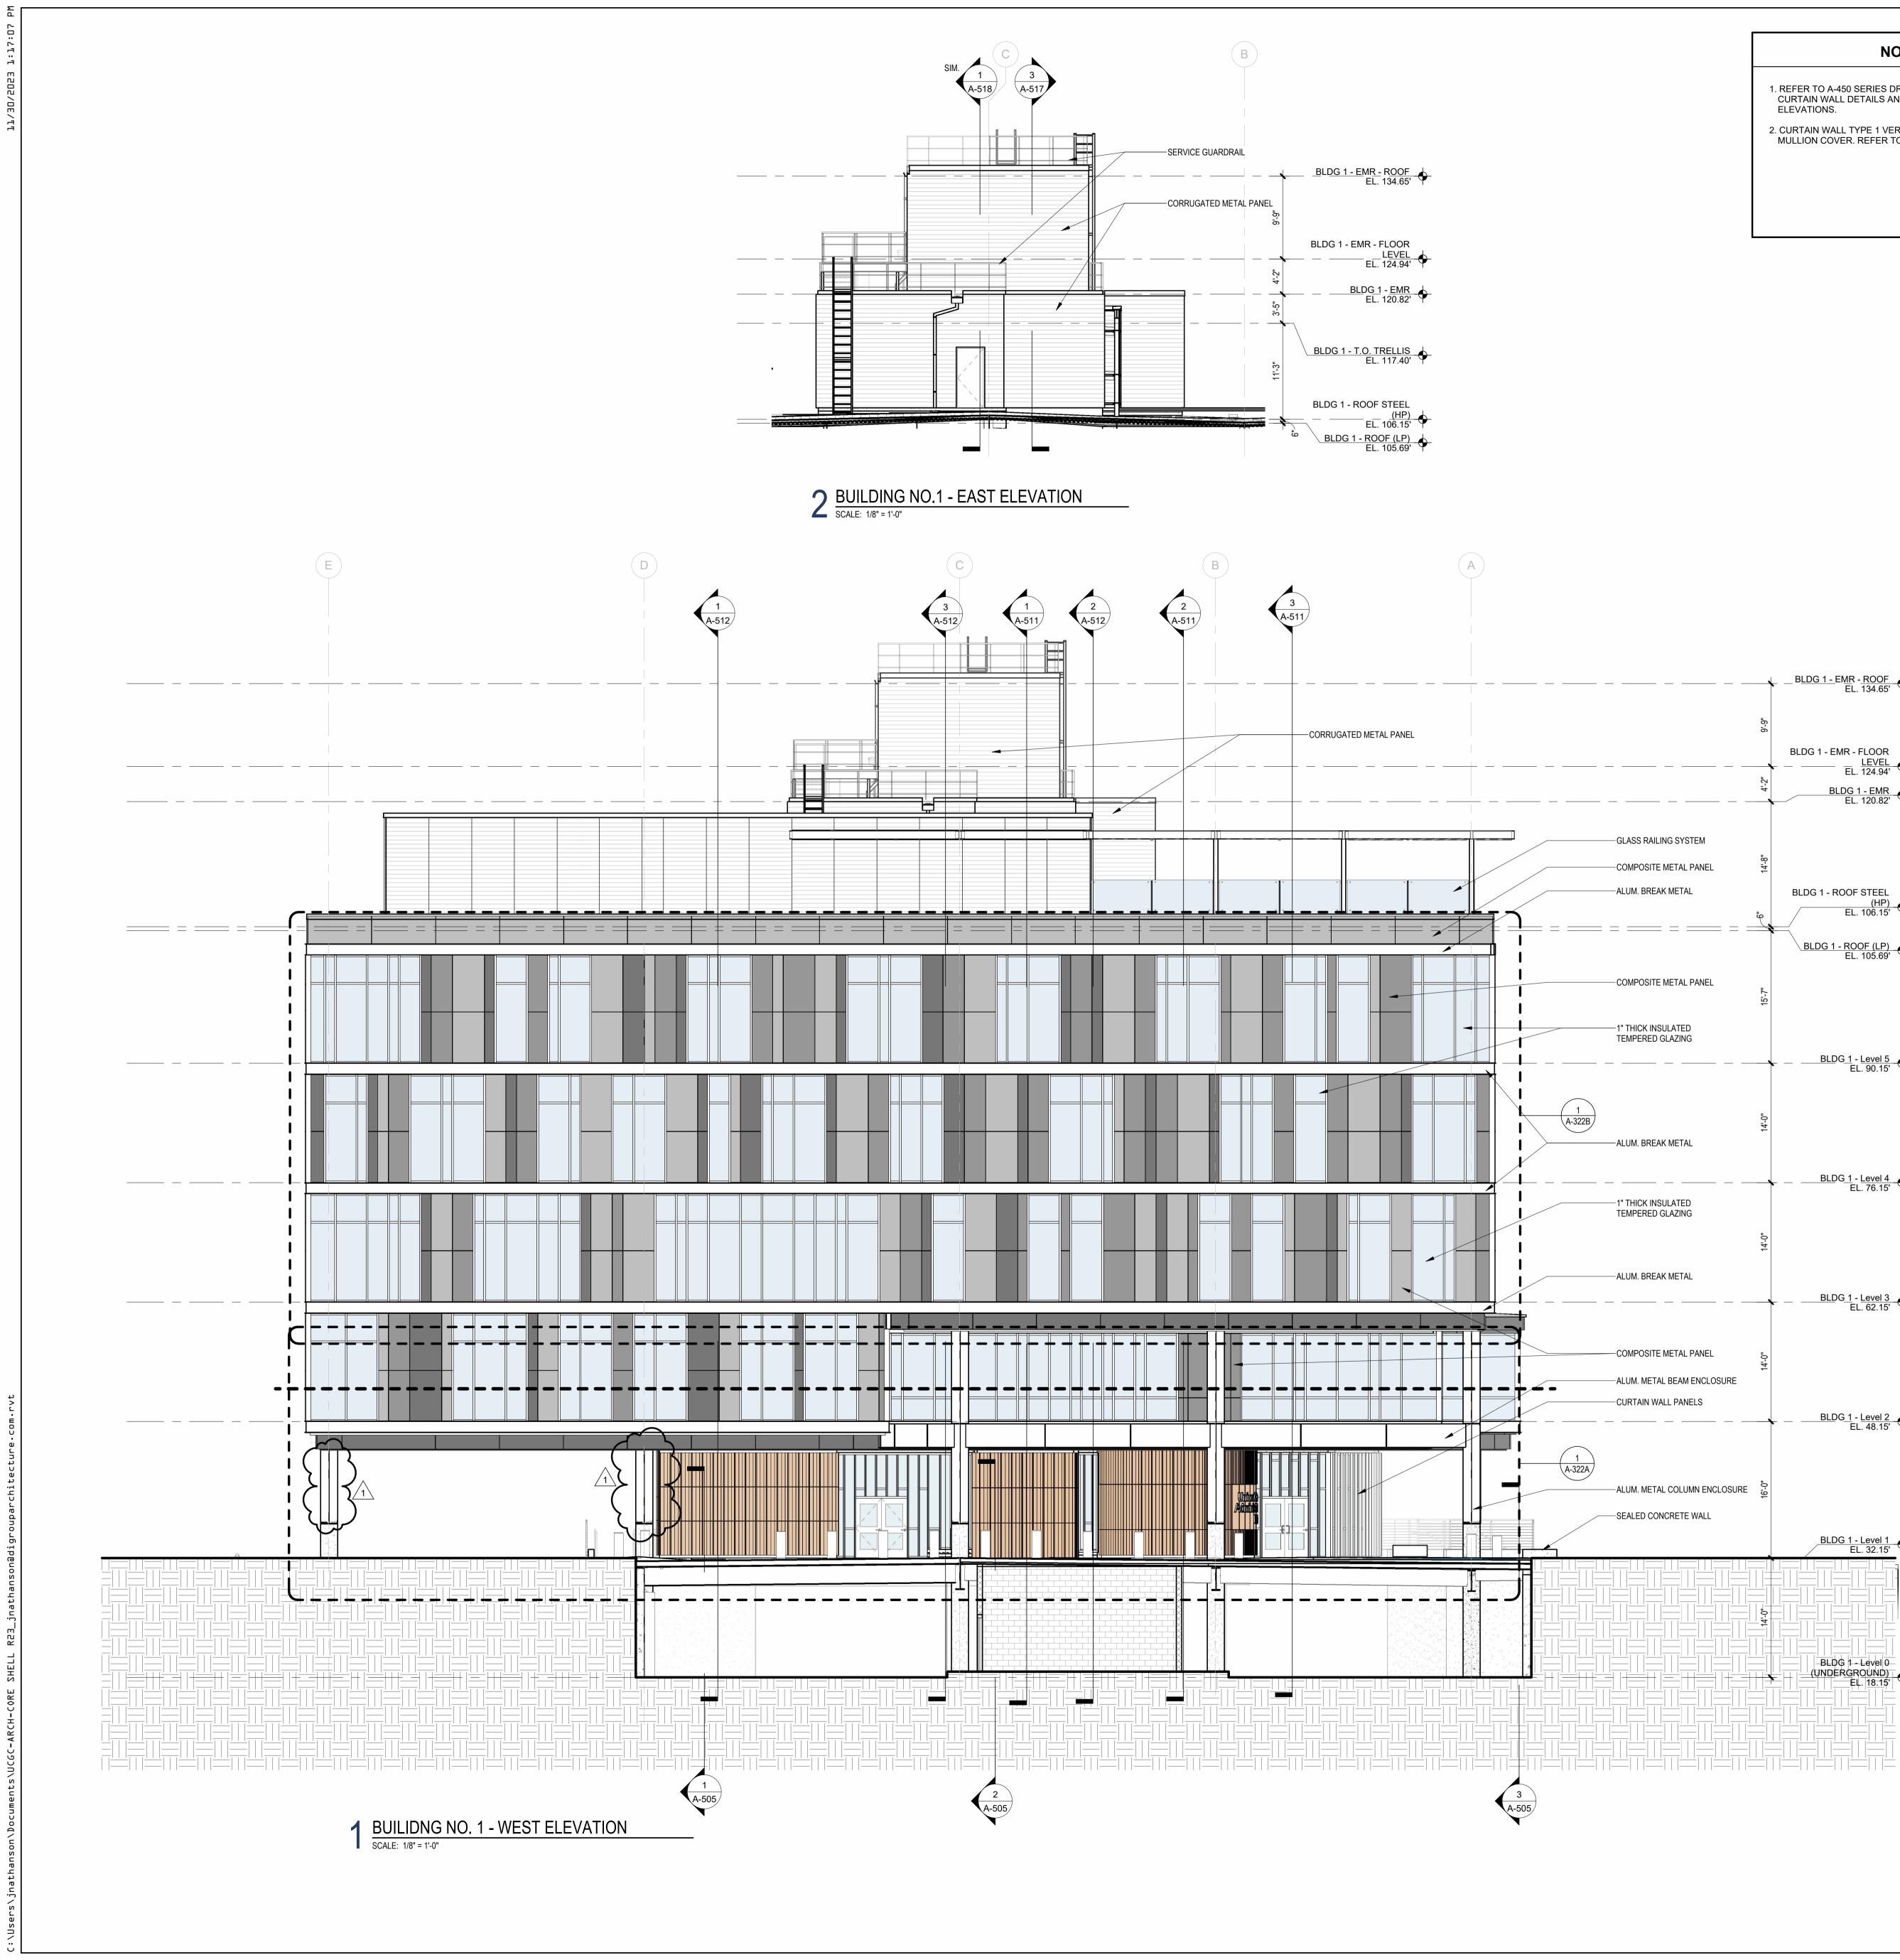
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## Jeffrey D. Venezia, AIA NJ RA AI 00827100

1 12.01.2023 Addendum No. 01 11.08.2023 For Public Bid

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BLD 2 (HUMAN SERV.) PROJECT NORTH TRUE NORTH



- 1. REFER TO A-450 SERIES DRAWINGS FOR ADDITIONAL CURTAIN WALL DETAILS AND ENLARGED CURTAIN WALL ELEVATIONS.
- 2. CURTAIN WALL TYPE 1 VERTICAL MULLIONS TO RECEIVE MULLION COVER. REFER TO DETAIL 10/A-450.

MAT	ERIAL	LEGEND
	GL-1	1" THICK CLEAR INSULATED TEMPERED GLAZING
	GL-3	1" THICK CERAMIC FRIT SPANDREL GLAZING
	GL-4	1" THICK INSULATED TEMPERED ACID ETCHED FROSTED GLAZING
	GL-5	1" THICK CLEAR INSULATED TEMPERED TRIPLE GLAZING W/ CUSTOM SEAL
	CMP-1	COMPOSITE METAL PANEL WITH COLOR NO. 1
	CMP-2	COMPOSITE METAL PANEL WITH COLOR NO. 2
	CMP-3	COMPOSITE METAL PANEL WITH COLOR NO. 3
	TCP-4	TERRACOTTA WALL SYSTEM FLAT
	TCP-4A	TERRACOTTA WALL SYSTEM FLUTED
	CMP-5	CORRUGATED METAL PANEL
	CMP-6	CORRUGATED METAL PANEL W/ PERFORATIONS
	CW-1	SEALED CONCRETE WALL WITH BOARD TEXTURE FINISH

	BLDG 1 - EMR - <u>ROOF</u> EL. 134.65'
້ດ- ດ	
	BLDG 1 - EMR - FLOOR <u>LEVEL</u> EL. 124.94'
4-2"	BLDG 1 - EMR EL. 120.82'
ASS RAILING SYSTEM	
MPOSITE METAL PANEL 🔤	
JM. BREAK METAL	BLDG 1 - ROOF STEEL
	(HP) EL. 106.15'
	BLDG 1 - ROOF (LP)
	EL. 105.69'
MPOSITE METAL PANEL 투 도	
HICK INSULATED IPERED GLAZING	
	EL. 90.15'
14-0"	
JM. BREAK METAL	
	EL. 76.15'
HICK INSULATED IPERED GLAZING	
14"-0"	
JM. BREAK METAL	
	EL. 62.15
MPOSITE METAL PANEL 50 خ	
JM. METAL BEAM ENCLOSURE	
RTAIN WALL PANELS	BLDG 1 - Level 2
	EL. 48.15'
JM. METAL COLUMN ENCLOSURE မှ	
aled concrete wall	
	BLDG 1 - Level 1 🔺
	BLDG 1 - Level 1 EL. 32.15'

=           = =	
==   = =   ==    ==   =	=       =       =         =           =         =         =         =             =           =             =             =             =                 =             =               =               =                 =

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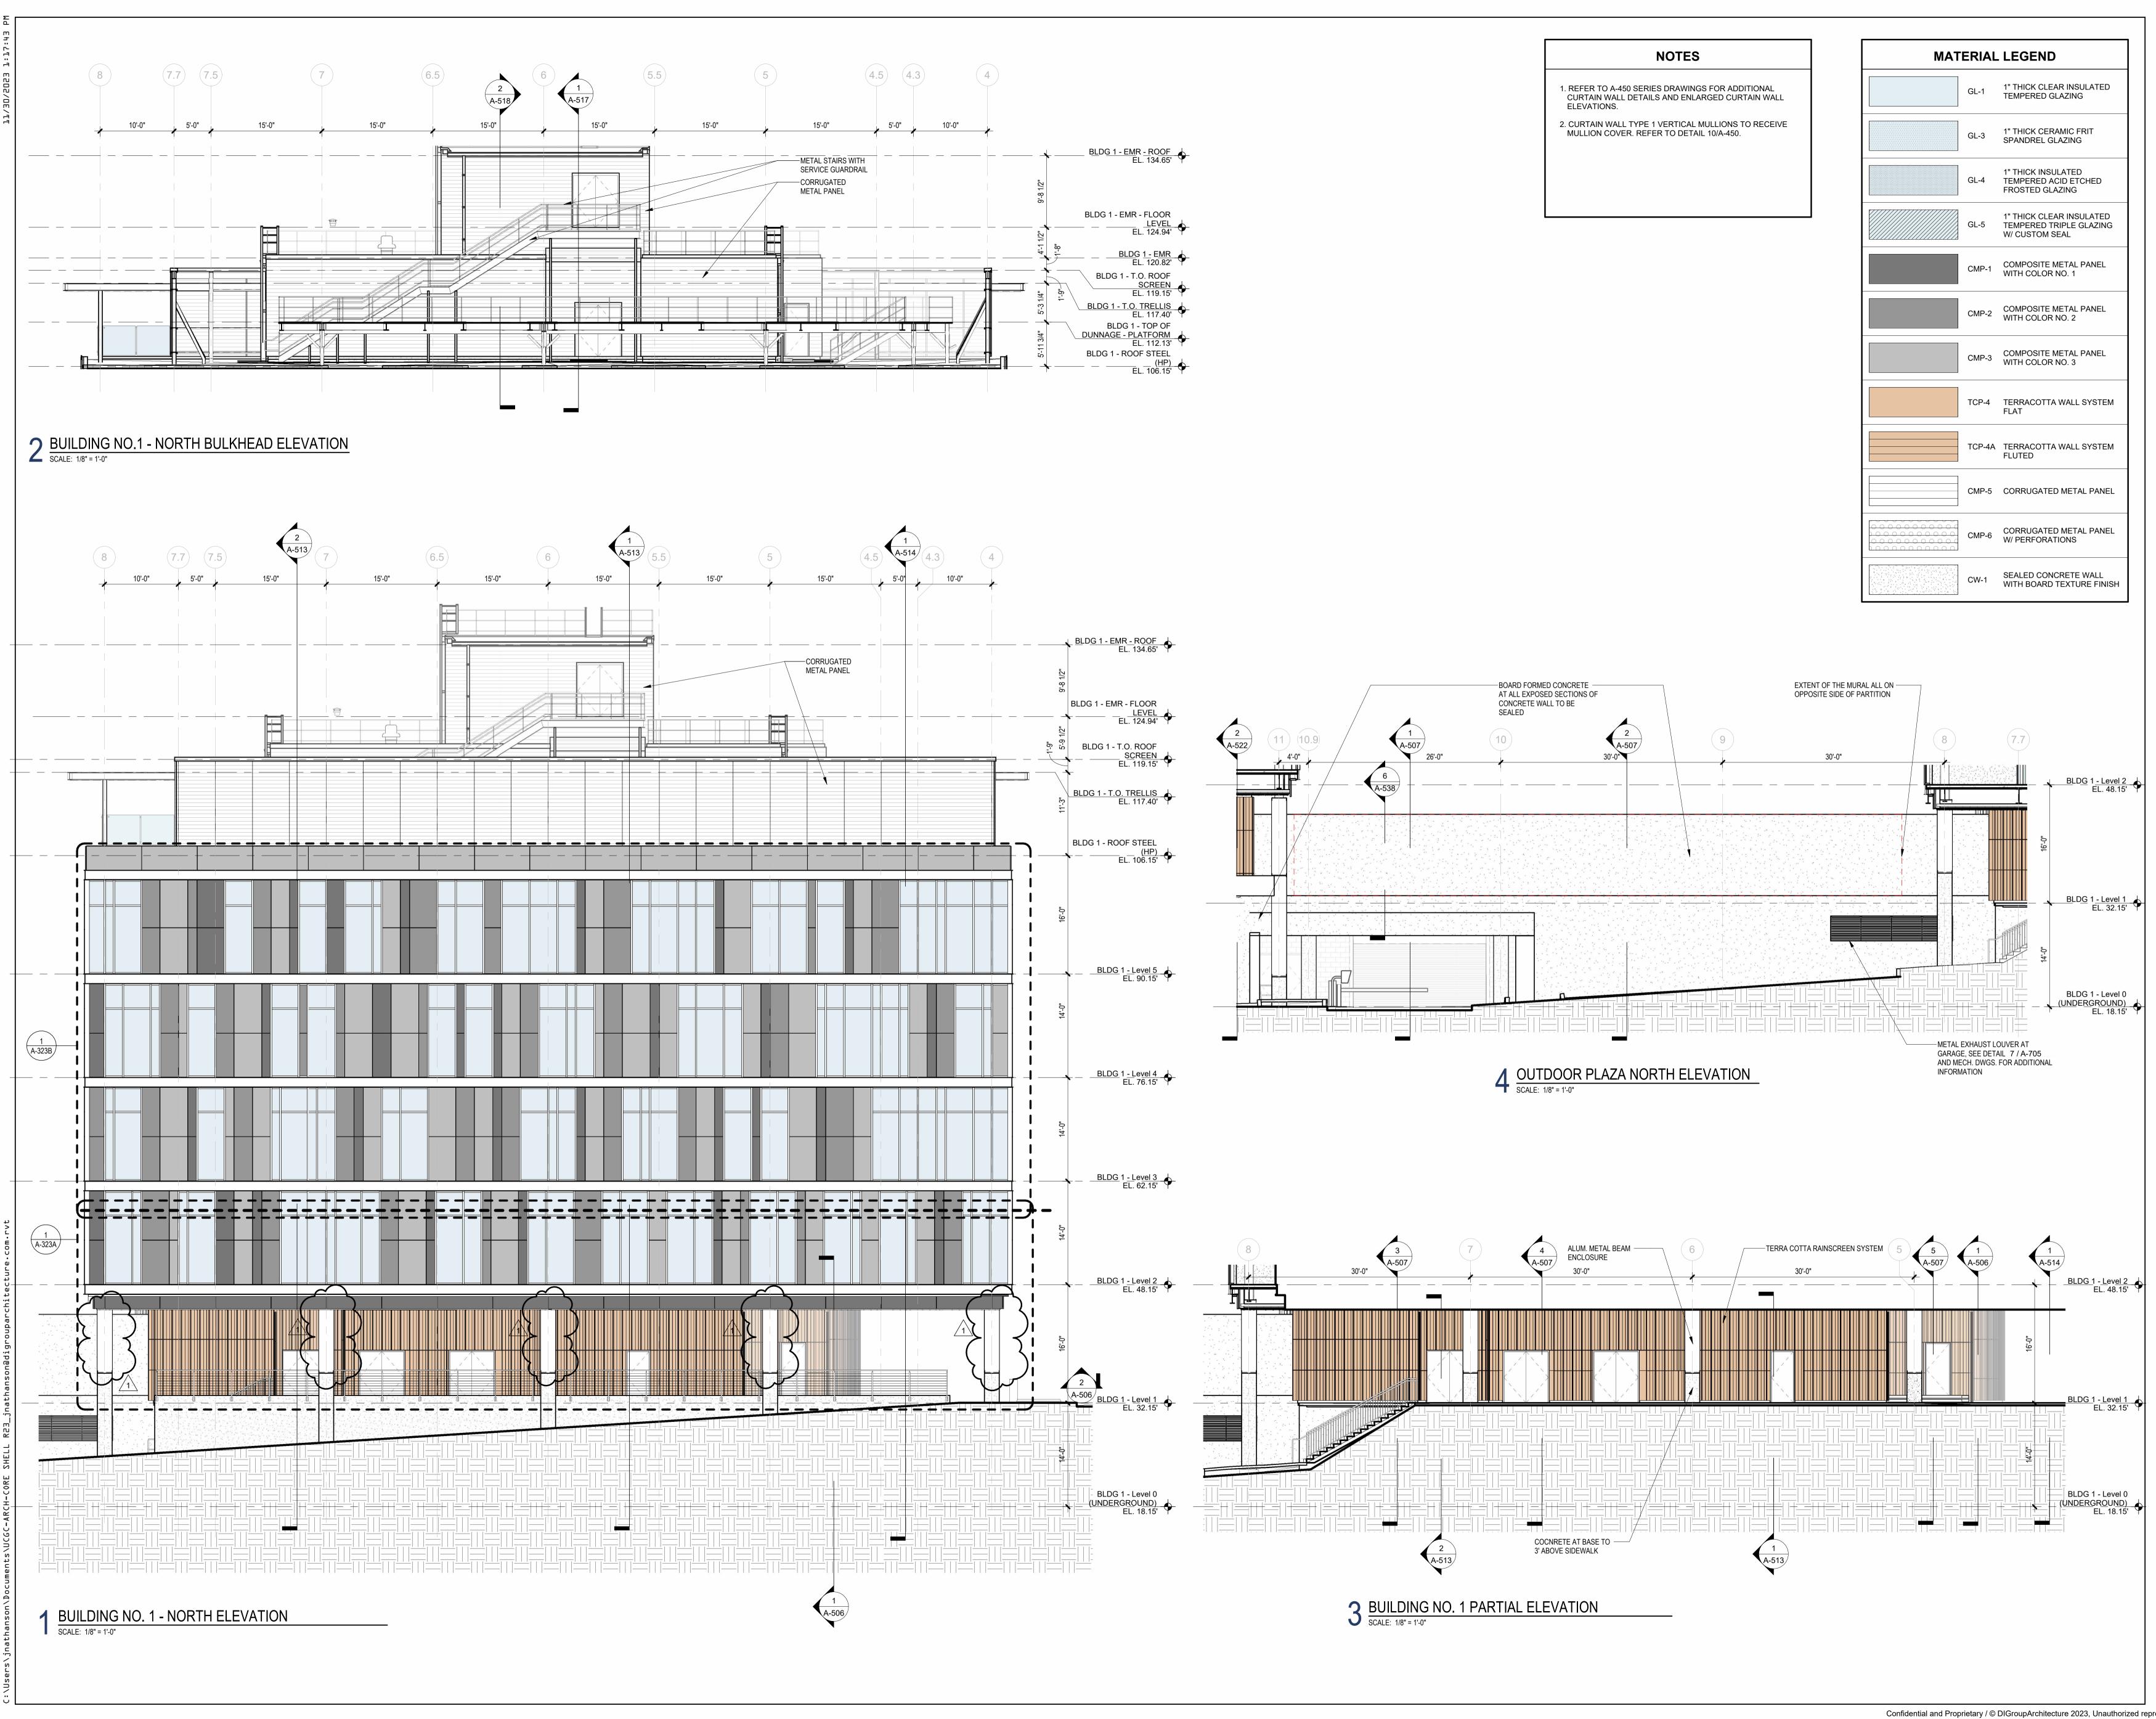
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Project:
UNION COUNTY GOVERNMENT COMPLEX B1 & 93 WEST GRAND STREET CITY OF ELIZABETH NEW JERSEY, 07202
Drawing Information:
Project No: 20.072 Date: 11.08.2023 Drawn By: JB / AV / PC Checked By: JM / SH
Sheet Name:
BUILDING NO. 1 - WEST ELEVATIONS
Δ-304


## Jeffrey D. Venezia, AIA NJ RA AI 00827100

1 12.01.2023 Addendum No. 01 11.08.2023 For Public Bid

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BLD 2 (HUMAN SERV.) WEST GRAND ST PROJECT NORTH TRUE NORTH



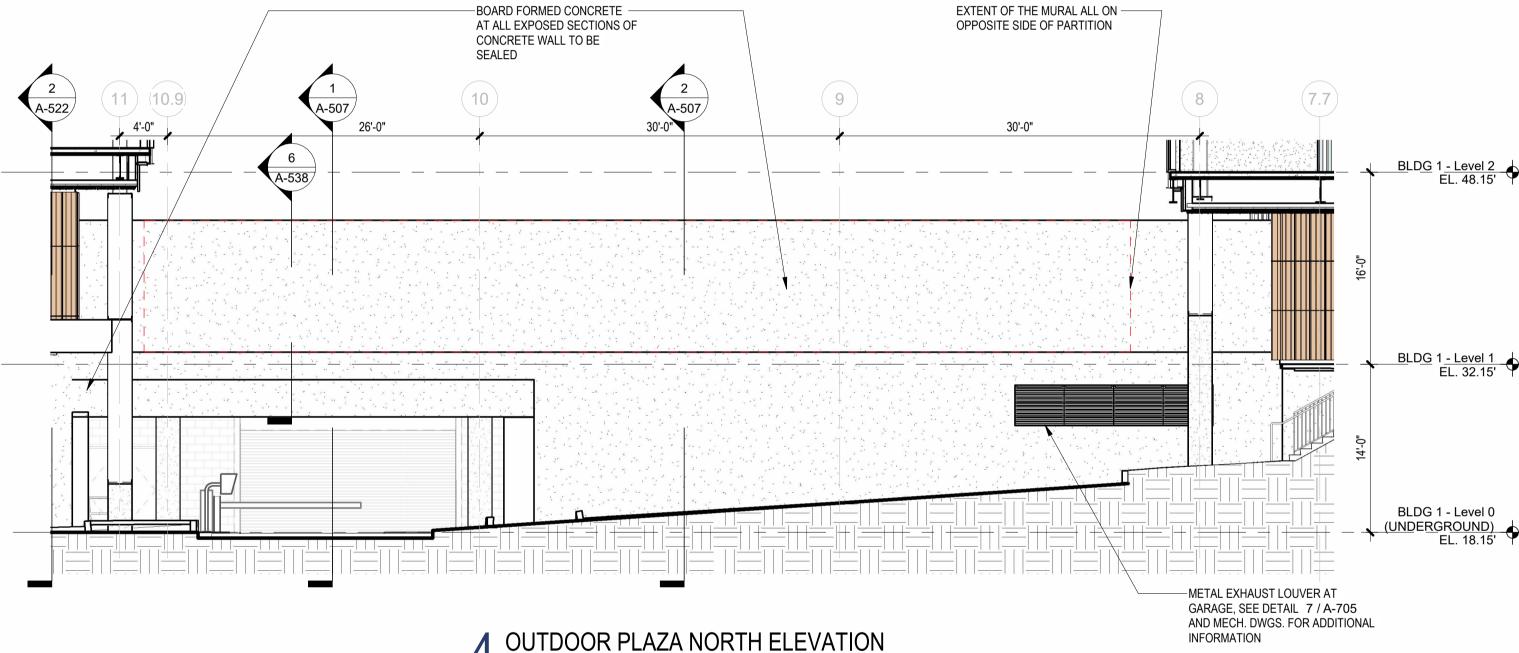

МАТ	ERIAL	LEGEND
	GL-1	1" THICK CLEAR INSULATED TEMPERED GLAZING
	GL-3	1" THICK CERAMIC FRIT SPANDREL GLAZING
	GL-4	1" THICK INSULATED TEMPERED ACID ETCHED FROSTED GLAZING
	GL-5	1" THICK CLEAR INSULATED TEMPERED TRIPLE GLAZING W/ CUSTOM SEAL
	CMP-1	COMPOSITE METAL PANEL WITH COLOR NO. 1
	CMP-2	COMPOSITE METAL PANEL WITH COLOR NO. 2
	CMP-3	COMPOSITE METAL PANEL WITH COLOR NO. 3
	TCP-4	TERRACOTTA WALL SYSTEM FLAT
	TCP-4A	TERRACOTTA WALL SYSTEM FLUTED
	CMP-5	CORRUGATED METAL PANEL
	CMP-6	CORRUGATED METAL PANEL W/ PERFORATIONS
	CW-1	SEALED CONCRETE WALL WITH BOARD TEXTURE FINISH



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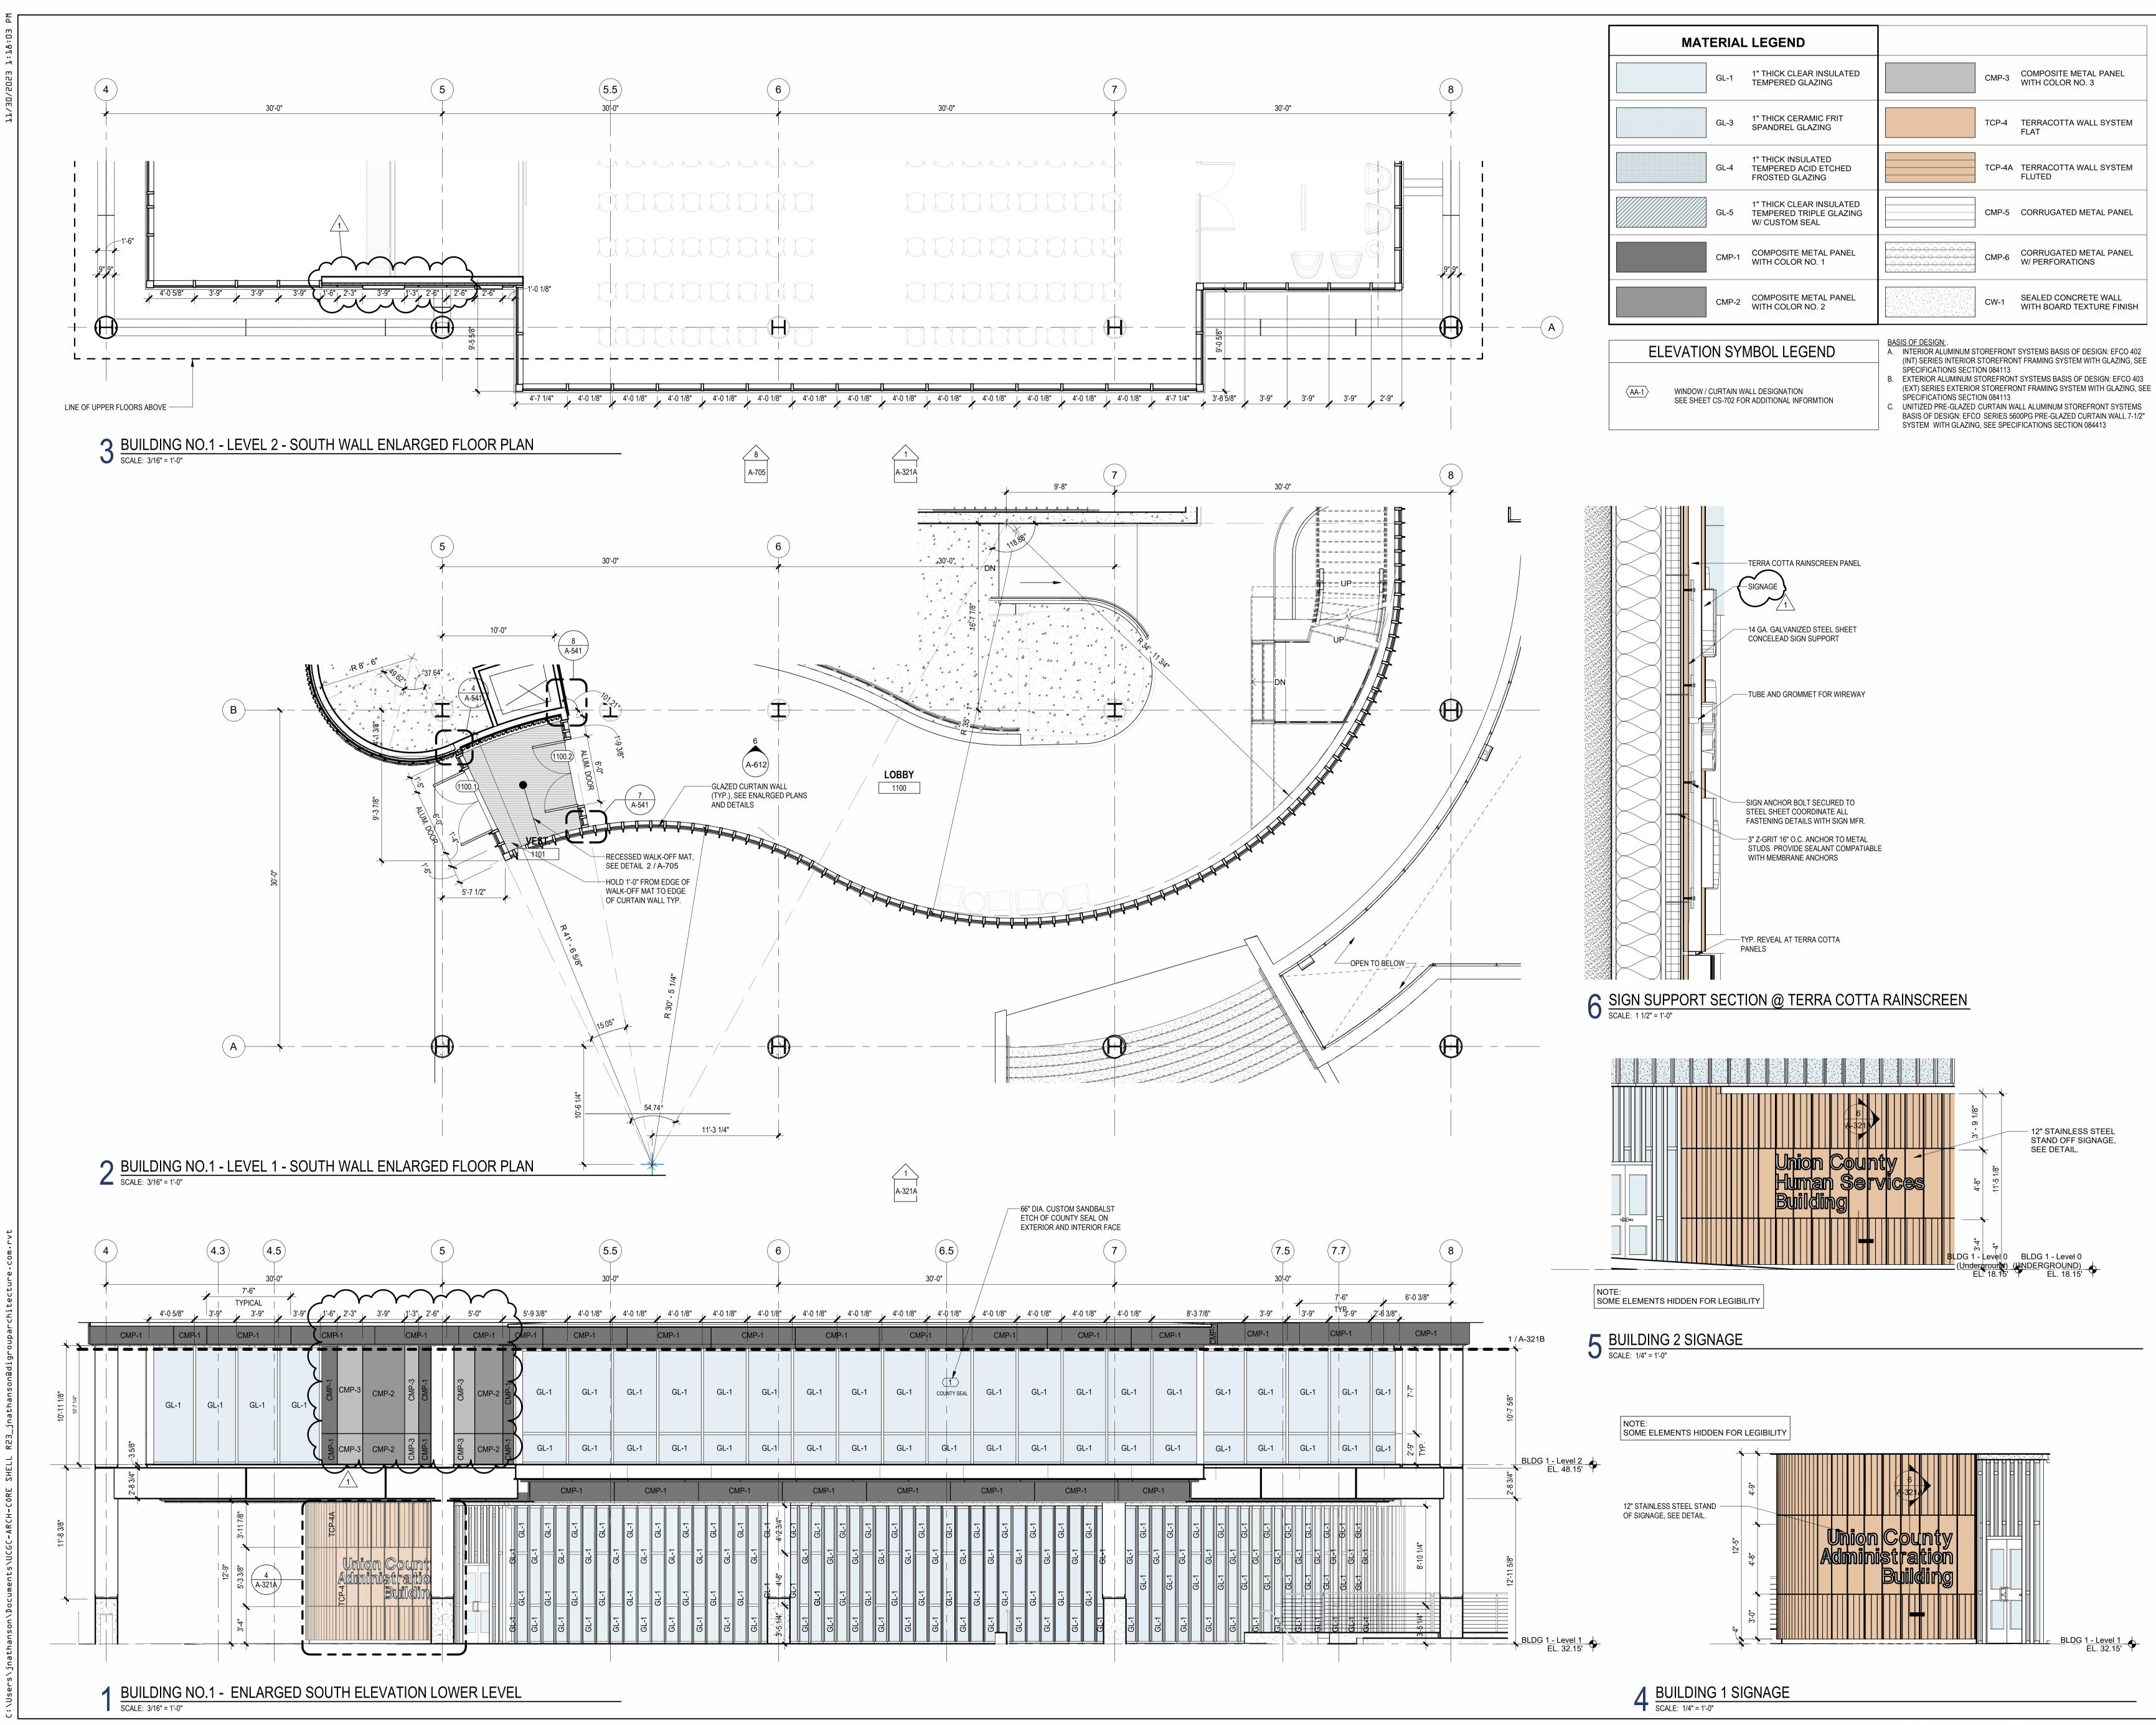
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Drawing Information:
Project No:         20.072           Date:         11.08.2023           Drawn By:         JB / AV / PC           Checked By:         JM / SH
Sheet Name:
BUILDING NO. 1 - NORTH ELEVATIONS
A-305

## Jeffrey D. Venezia, AIA NJ RA AI 00827100

No. Date

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Project No: 20.072 Date: 11.08.2023 Drawn By: JB / AV / PC Checked By: JM / SH
Sheet Name:
ENLARGED ELEVATIONS AND WALL PLANS - BUILDING NO.1 SOUTH
Δ.321Δ

### Jeffrey D. Venezia, AIA NJ RÁ AI 00827100


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PROJECT NORTH TRUE NORTH





				6	)									(	7								
30'-0"		MP-3				6" 2'6	CMP-3		30'-0"	2-6"		GMP-3			CMP-3	$\sim$					CMP 3 3'.9"		
GL-1 CMP-	-2 CMP-1	CMP-3	GL-1	GL-1	GI CWP-1 CMP-1	1 GL·		GL-1	CMP-1	CMP-2	CL-1		GL-1	GL-1	1-3" Z GI	L-1 E-dWD	GL-1	GL-1		1P-2	-1 [-1	CMP-2 CM	1P
GL-1	1 CMP-1 CMP-1	CMP-3	GL-1	GL-1	GWP-1	1 GL	1 GL-1	GL-1	CMP-1	CMP-2	GL-1		GL-1	GL-1	Gr-1 Gr-1	L-1 CWD-3	GL-1	GL-1		IP-2		CMP-2 CM	1P
GL-	2'-6" 1)3" CMP-2	3'-9" CMP-3		1 <sup>1-3</sup> "	3'-9" GL-1	3'-9" CMP-2	2'-6" 2'-6" 2'-6" CMP			3'-9" GL-1	-2	2'-6" CMP-3	3'-6" CMP-1	<sup>1-3"</sup>	2'-6" GL-1	3'-9" GL-1	1'-3" F-J5	3-9" CMP-3	CMP-2	2'-6" CMP-1	3-9" CMP-3		
	3	CMP-3	GL-1	GL-1	GL-1	CMP-2		-1 CMP-	3 CMP-2	GL-1		CMP-3	CMP-1	GL-1	     	GL-1	GL-1	CMP-3	+	CMP-1	CMP-3	7 7 7	
3'-9"	2'-6" ,1'-3	<sup>3'-9"</sup> GL-1		<sup>3'-9"</sup>	2'-6" GL-1	GL-1	3'-9"	2'-6"	3'-6" GL-1	5'-0	GL-1	2'-6"	3'-9"	CL-1	3-1 GL-1	2'-1	6" <u>1'-3</u>	2'-6" 1	CF-1	3'-9" GL-1			15
	-2 CMP-3						P-1 CMP-3	CMP-2		CMP-1		CMP-2	CMP-3	0		> см >	P-2 P-2	CMP-1	CMP-2	1		P-2 CMP-3	CMD_0
GL-1 CMP-	-2 CMP-3	GL-1		GL-1	GL-1	-1 -1 -1	P-1 CMP-3	CMP-2	GL-1	CMP-1	GL-1	CMP-2	CMP-3	GL-1	GI-1		~ E	CMP-1	CMP-2 GL-1	GL-1	СМР	P-2 CMP-3	CMP-2
										0								/	C	MP-1		CMP-1	
	CMP-1		CMP-1	-		CMP-1		CMP-1		CN	ИР-1		СМ										
			11	I			11								Ι							7'-6" TYP.	

MATERIAL LEGEND							
	GL-1	1" THICK CLEAR INSULATED TEMPERED GLAZING					
	GL-3	1" THICK CERAMIC FRIT SPANDREL GLAZING					
	GL-4	1" THICK INSULATED TEMPERED ACID ETCHED FROSTED GLAZING					
	GL-5	1" THICK CLEAR INSULATED TEMPERED TRIPLE GLAZING W/ CUSTOM SEAL					
	CMP-1	COMPOSITE METAL PANEL WITH COLOR NO. 1					
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	TCP-4	TERRACOTTA WALL SYSTEM FLAT					
	TCP-4A	TERRACOTTA WALL SYSTEM FLUTED					
	CMP-5	CORRUGATED METAL PANEL					
	CMP-6	CORRUGATED METAL PANEL W/ PERFORATIONS					
	CW-1	SEALED CONCRETE WALL WITH BOARD TEXTURE FINISH					
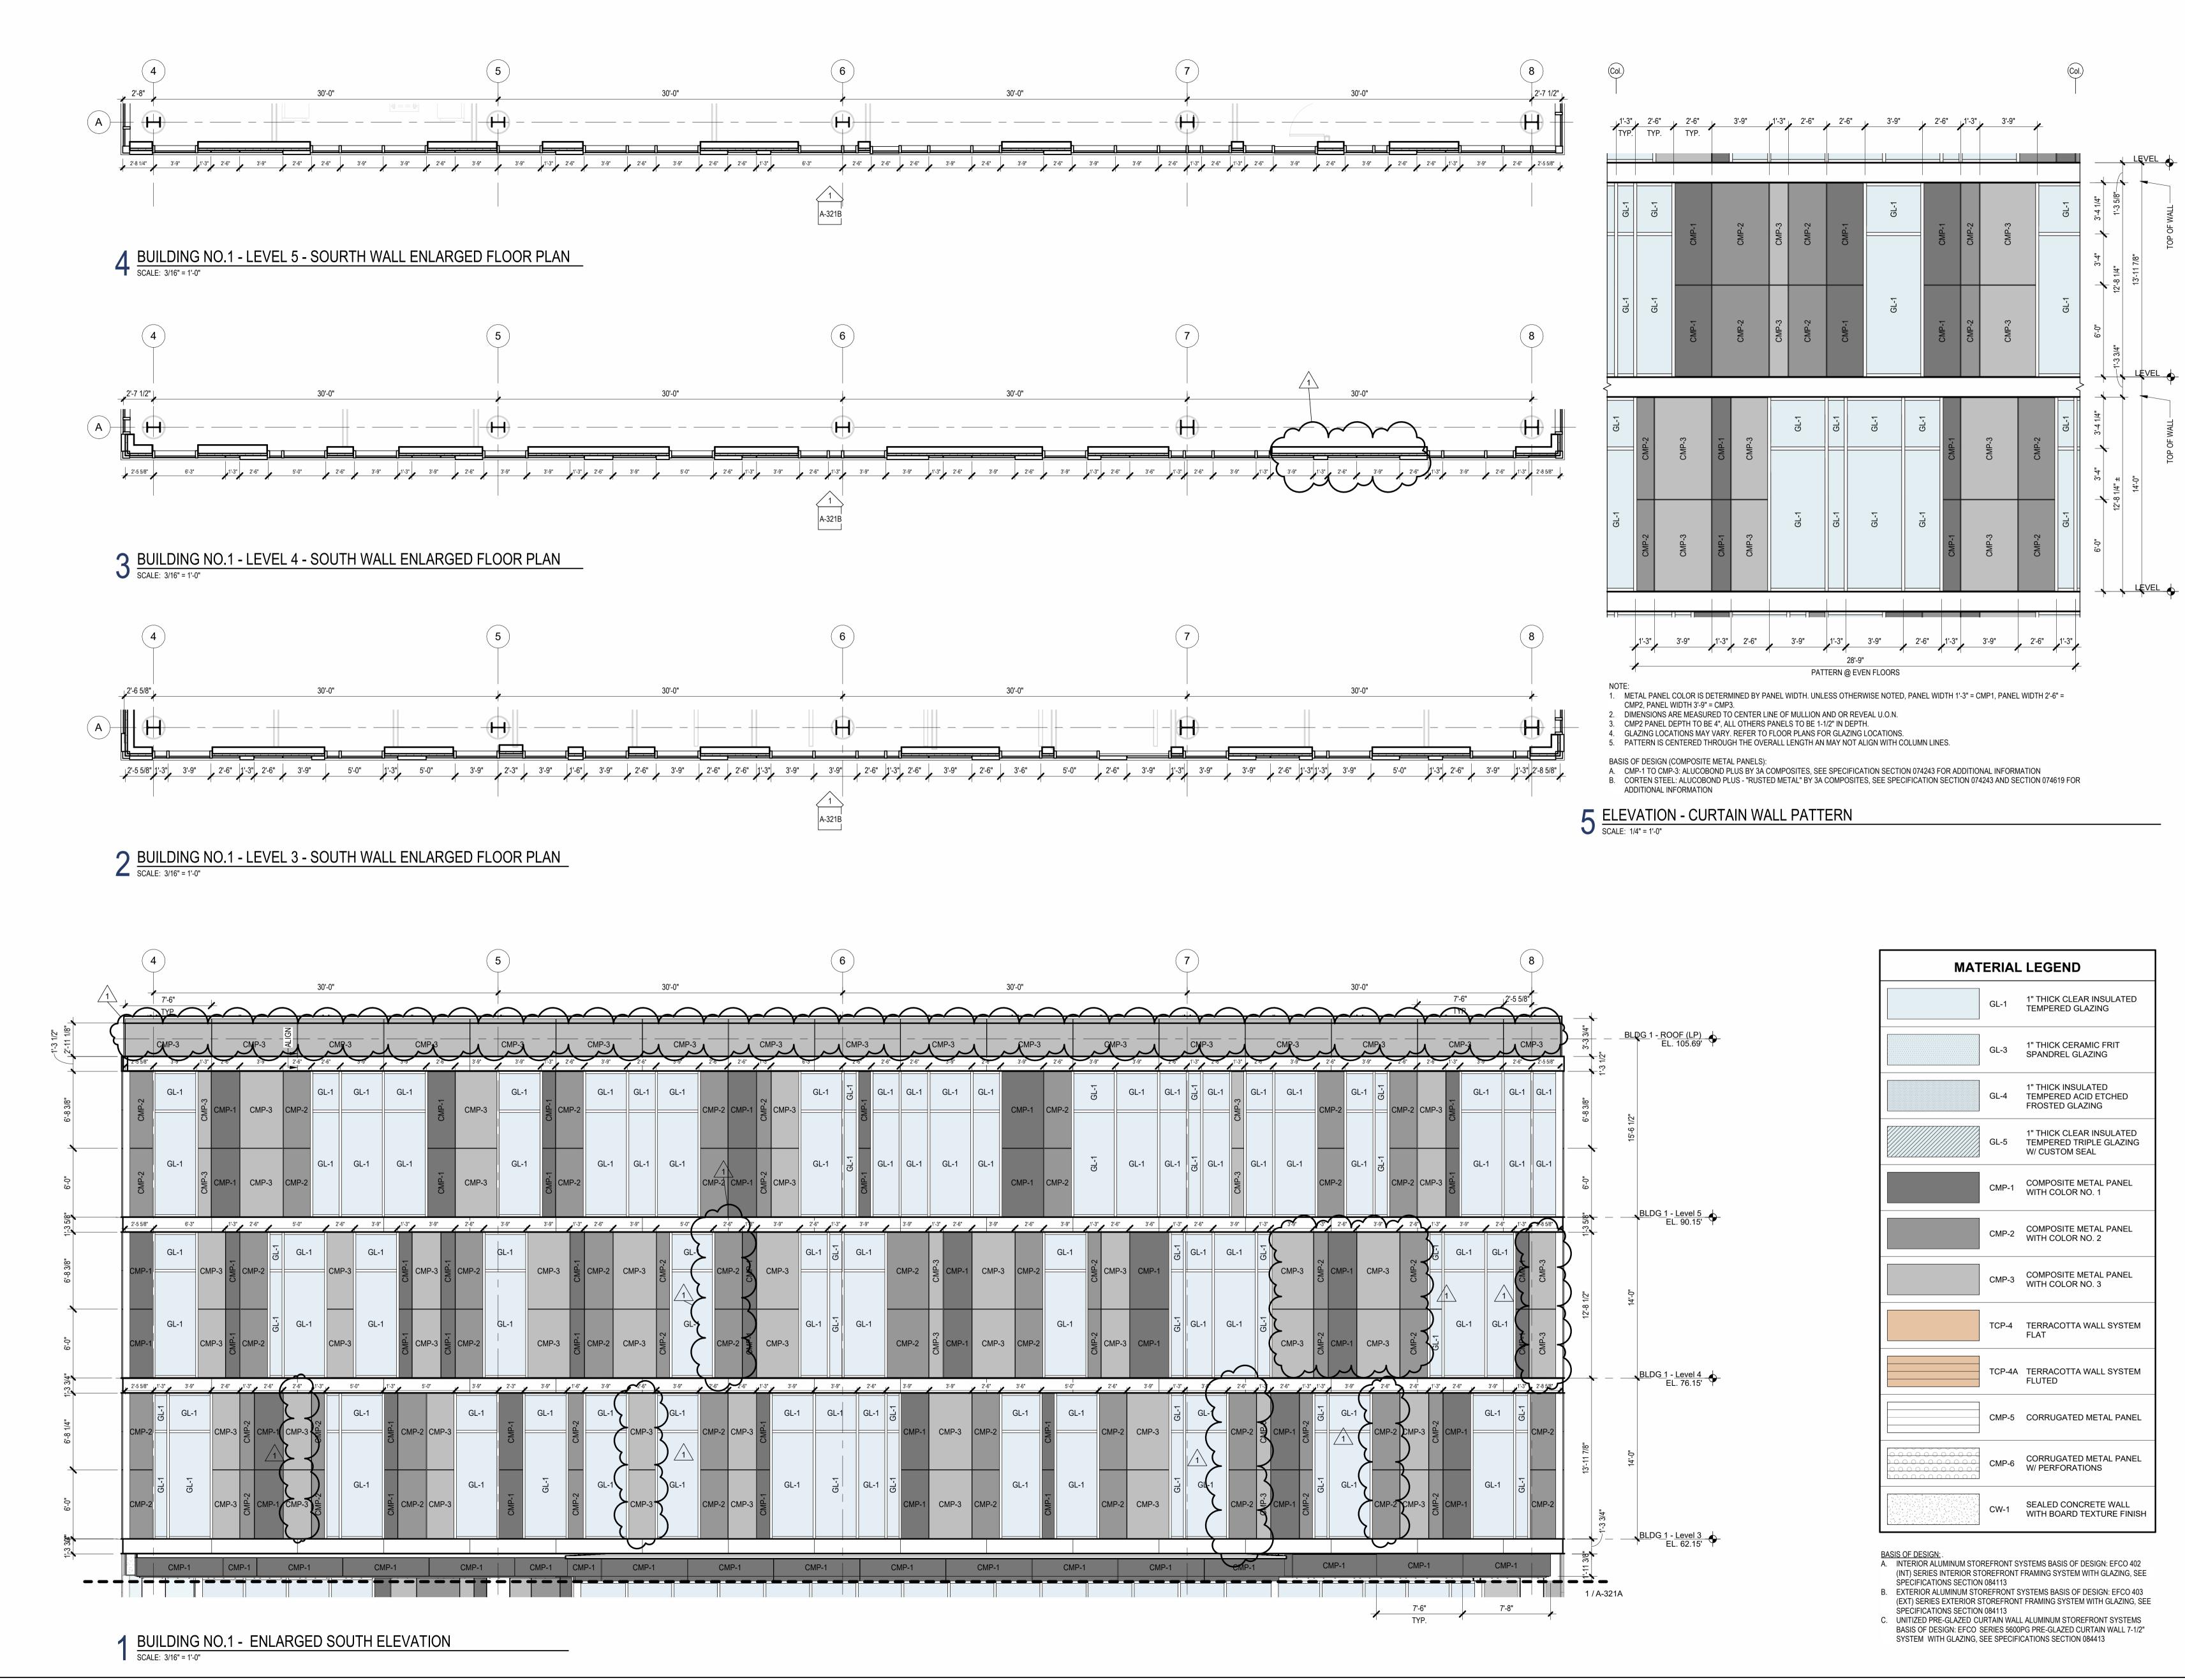
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CITY OF ELIZABETH
NEW JERSEY, 07202
Drawing Information:
Project No: 20.072 Date: 11.08.2023
Drawn By: JB / AV / PC
Checked By: JM / SH
Sheet Name:
ENLARGED ELEVATIONS AND
WALL PLANS - BUILDING NO.1
SOUTH
Sheet No:
A 224D
A-321B


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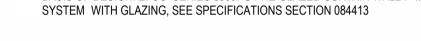
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PROJECT NORTH TRUE NORTH



MATERIAL LEGEND							
	GL-1	1" THICK CLEAR INSULATED TEMPERED GLAZING					
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	CMP-6	CORRUGATED METAL PANEL W/ PERFORATIONS					
	CW-1	SEALED CONCRETE WALL WITH BOARD TEXTURE FINISH					

- BASIS OF DESIGN: . A. INTERIOR ALUMINUM STOREFRONT SYSTEMS BASIS OF DESIGN: EFCO 402 (INT) SERIES INTERIOR STOREFRONT FRAMING SYSTEM WITH GLAZING, SEE SPECIFICATIONS SECTION 084113
- EXTERIOR ALUMINUM STOREFRONT SYSTEMS BASIS OF DESIGN: EFCO 403 (EXT) SERIES EXTERIOR STOREFRONT FRAMING SYSTEM WITH GLAZING, SEE
- SPECIFICATIONS SECTION 084113 C. UNITIZED PRE-GLAZED CURTAIN WALL ALUMINUM STOREFRONT SYSTEMS BASIS OF DESIGN: EFCO SERIES 5600PG PRE-GLAZED CURTAIN WALL 7-1/2"

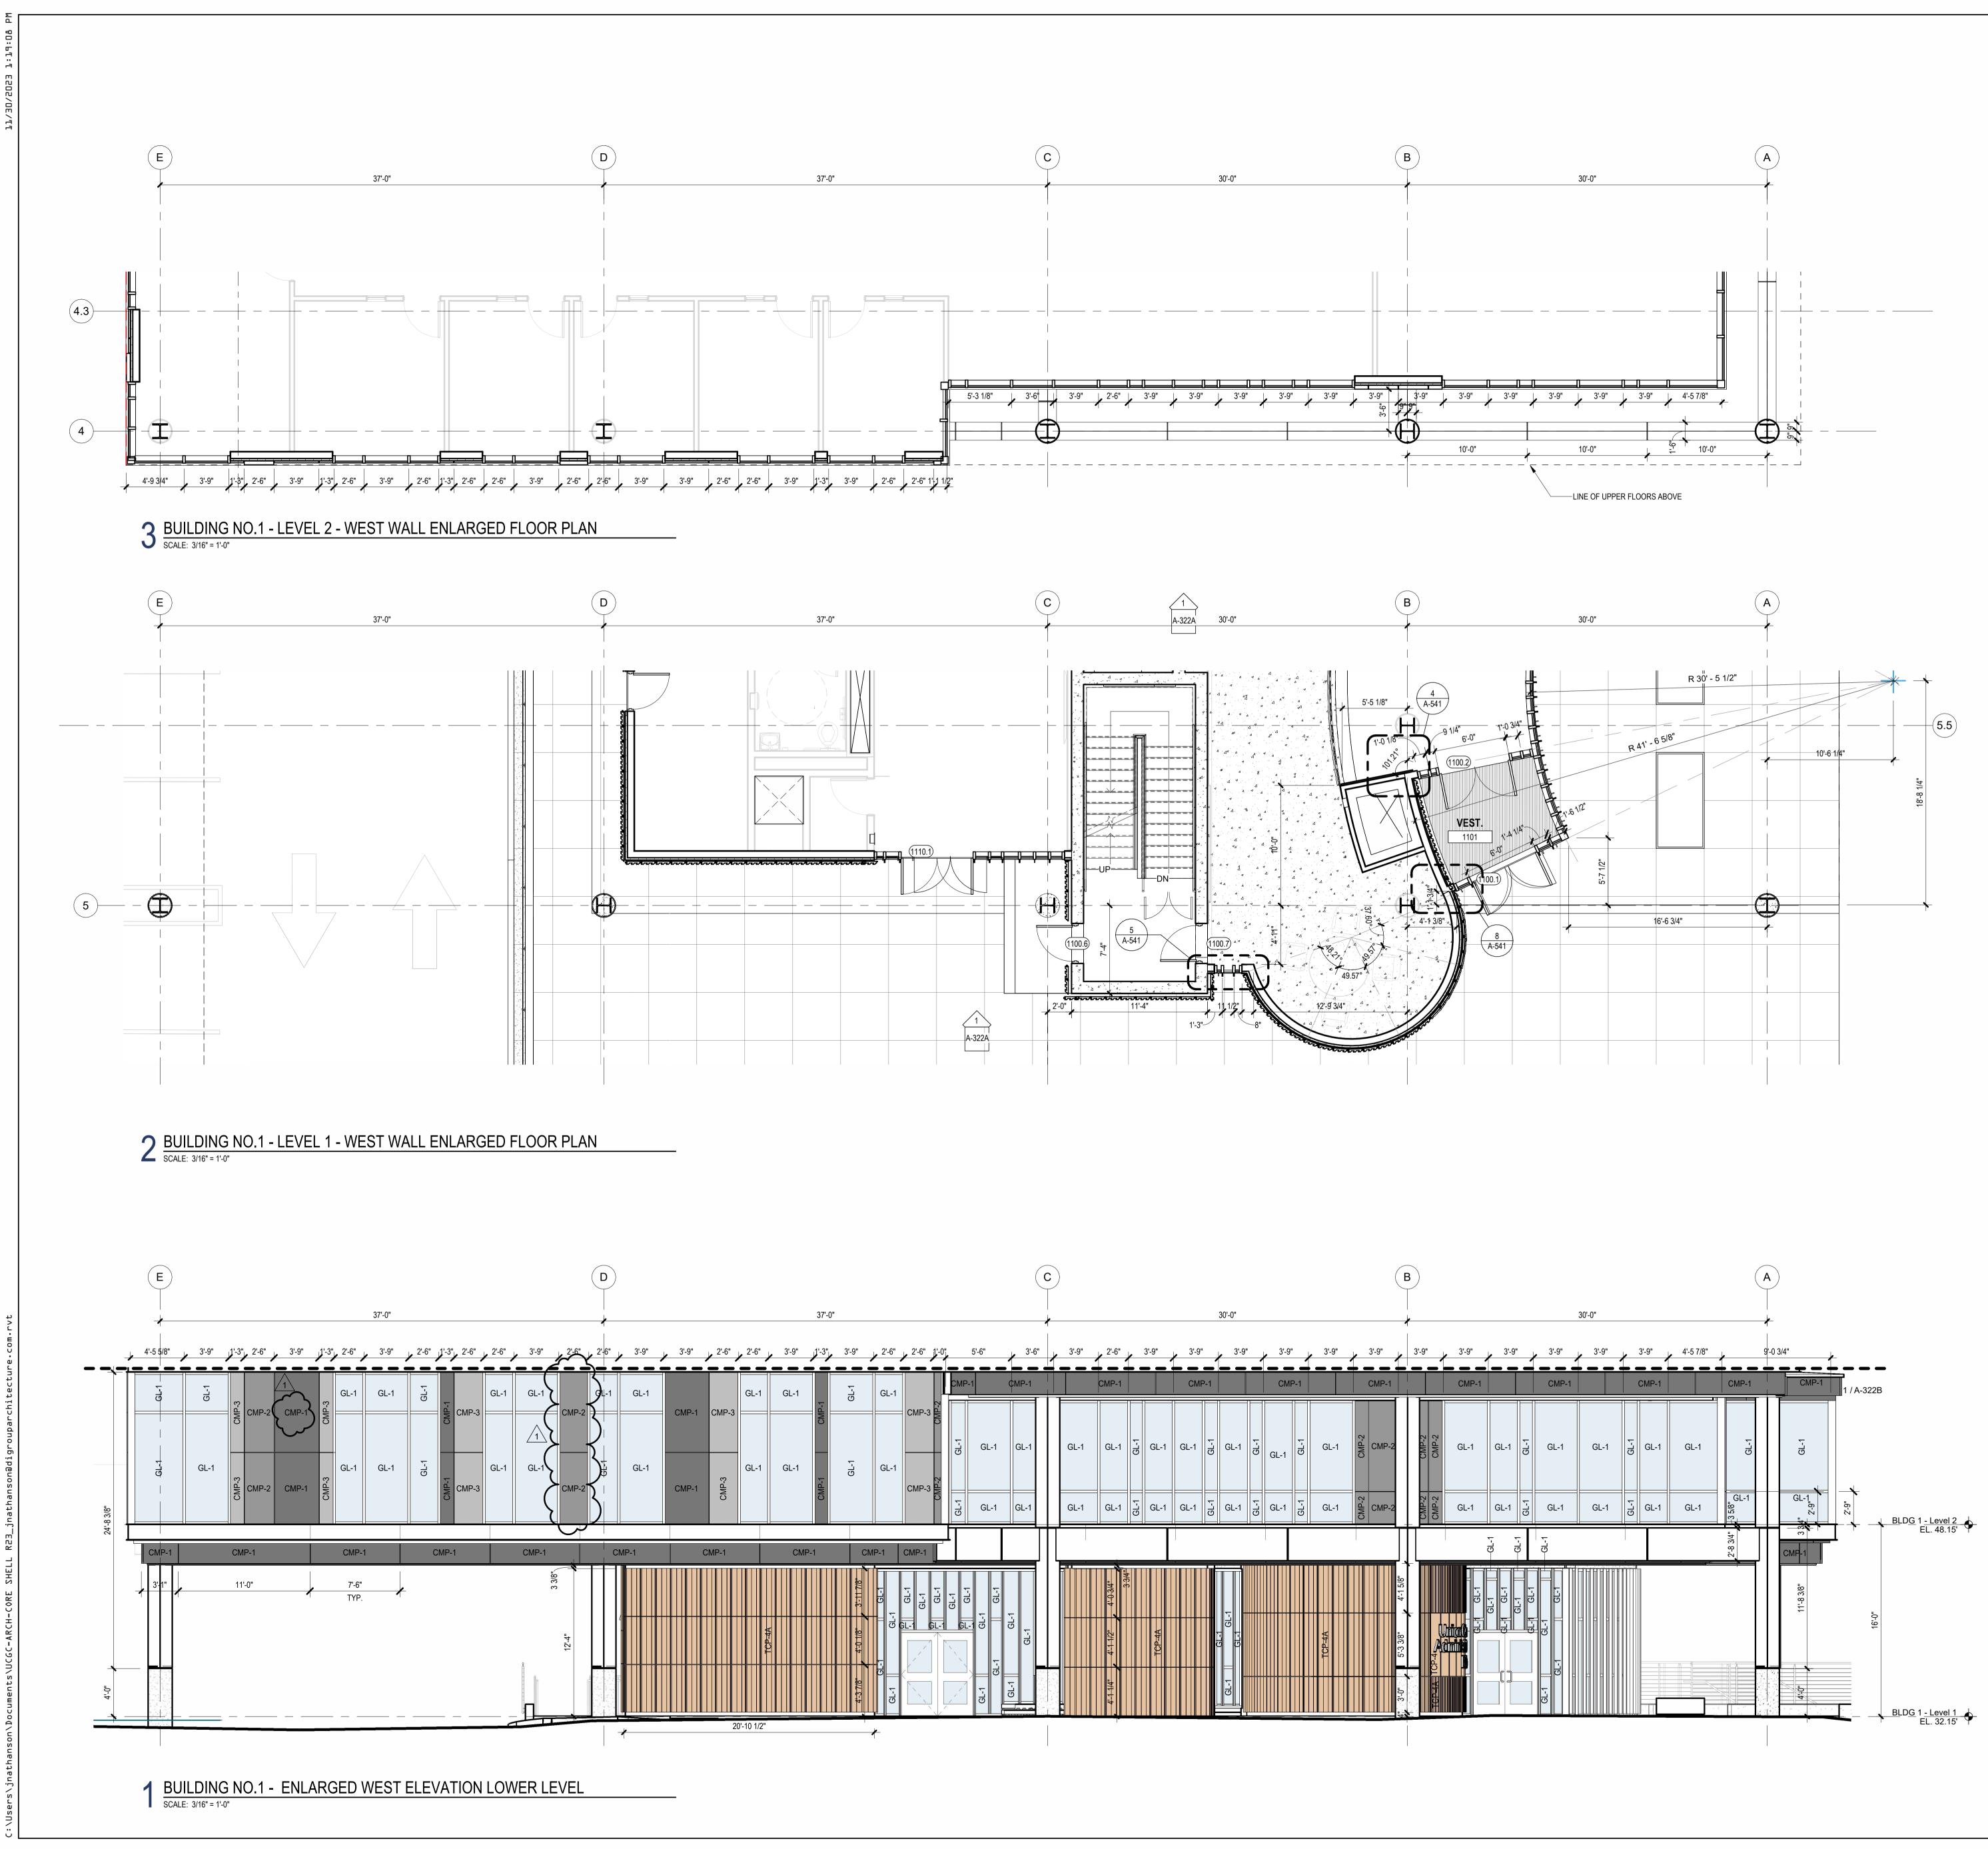


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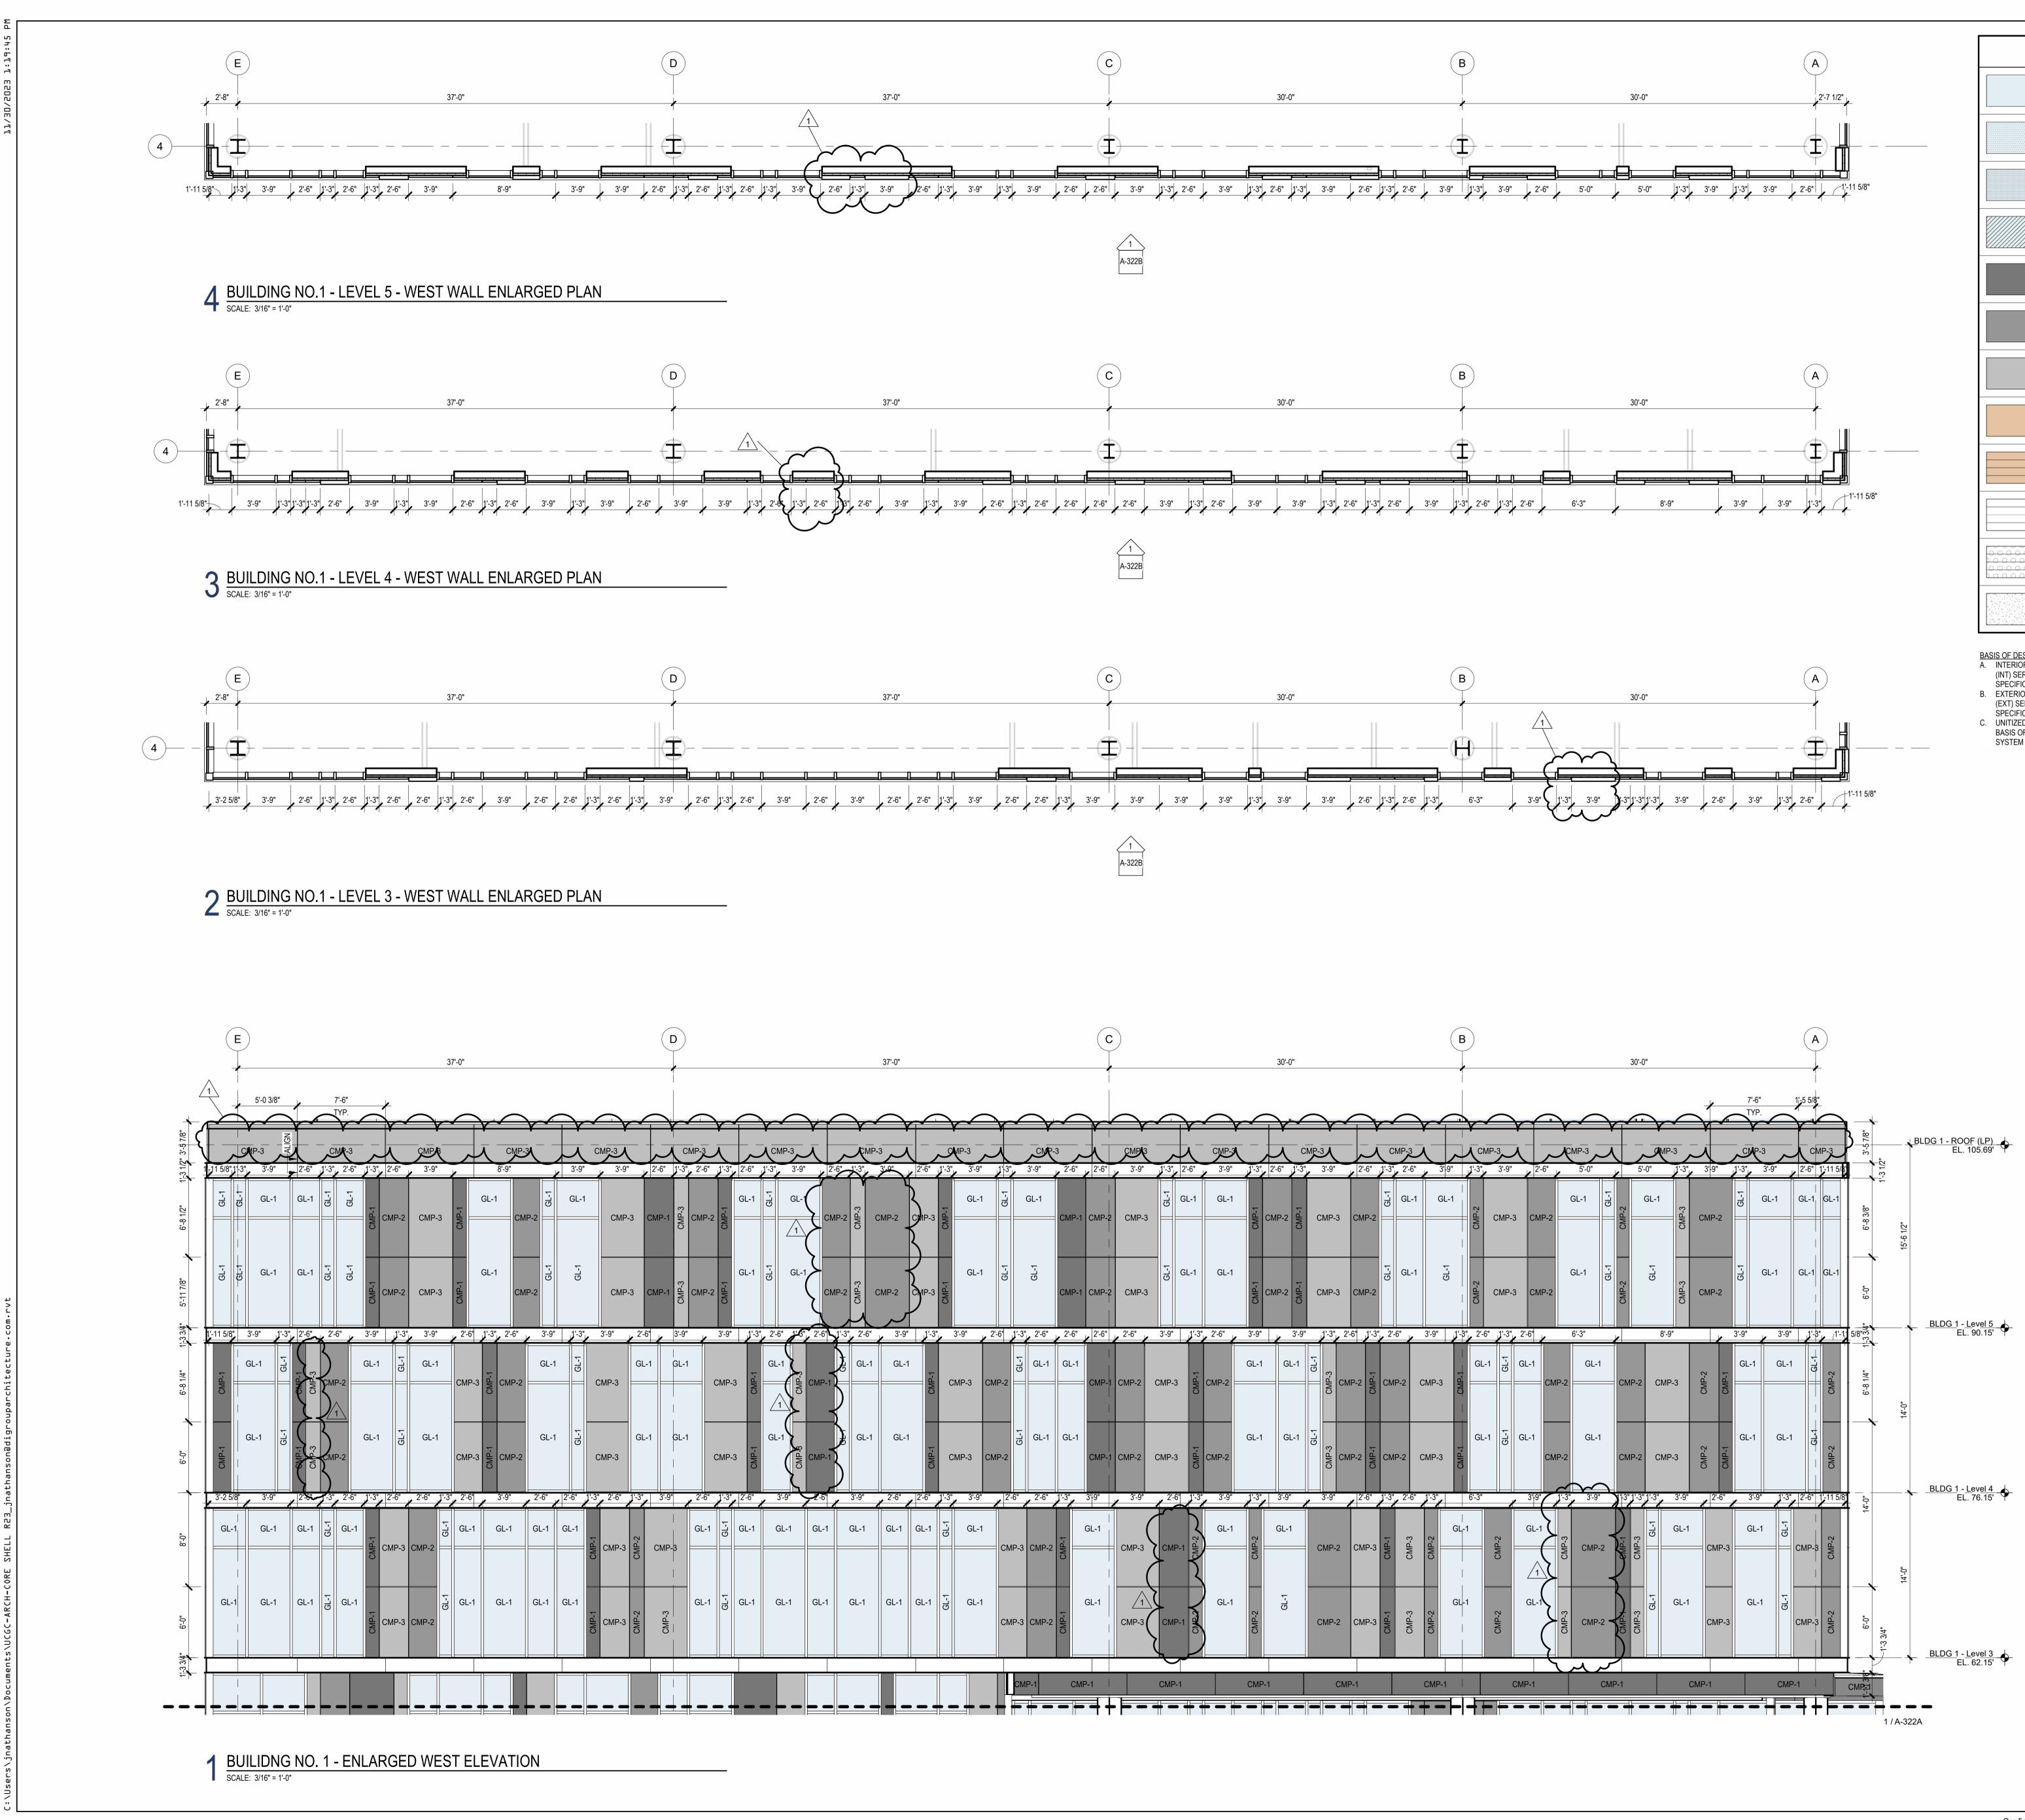
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Drawing Information:
Project No:         20.072           Date:         11.08.2023           Drawn By:         JB / AV / PC           Checked By:         JM / SH
Sheet Name:
ENLARGED ELEVATIONS AND WALL PLANS - BUILDING NO.1 WEST
A 200A

## Jeffrey D. Venezia, AIA NJ RA AI 00827100

No. Date Description **Revisions / Issues DIGroup**Architecture ARCHITECTURE FOR CHANGE 15 Bethany Street • New Brunswick, NJ 08901 • T: 732.249.6242 2450 W Hunting Park Ave • Philadelphia, PA 19122 • T: 215.634.3400

1 12.01.2023 Addendum No. 01 11.08.2023 For Public Bid



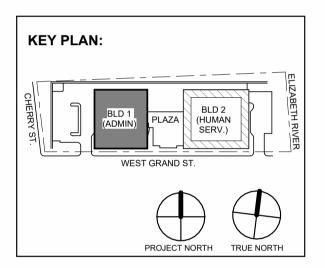

MATERIAL LEGEND							
	GL-1	1" THICK CLEAR INSULATED TEMPERED GLAZING					
	GL-3	1" THICK CERAMIC FRIT SPANDREL GLAZING					
	GL-4	1" THICK INSULATED TEMPERED ACID ETCHED FROSTED GLAZING					
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	TCP-4A	TERRACOTTA WALL SYSTEM FLUTED					
	CMP-5	CORRUGATED METAL PANEL					
	CMP-6	CORRUGATED METAL PANEL W/ PERFORATIONS					
	CW-1	SEALED CONCRETE WALL WITH BOARD TEXTURE FINISH					

BASIS OF DESIGN: .

A. INTERIOR ALUMINUM STOREFRONT SYSTEMS BASIS OF DESIGN: EFCO 402 (INT) SERIES INTERIOR STOREFRONT FRAMING SYSTEM WITH GLAZING, SEE SPECIFICATIONS SECTION 084113

B. EXTERIOR ALUMINUM STOREFRONT SYSTEMS BASIS OF DESIGN: EFCO 403 (EXT) SERIES EXTERIOR STOREFRONT FRAMING SYSTEM WITH GLAZING, SEE

SPECIFICATIONS SECTION 084113 C. UNITIZED PRE-GLAZED CURTAIN WALL ALUMINUM STOREFRONT SYSTEMS BASIS OF DESIGN: EFCO SERIES 5600PG PRE-GLAZED CURTAIN WALL 7-1/2" SYSTEM WITH GLAZING, SEE SPECIFICATIONS SECTION 084413

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Project No: 20.072 Date: 11.08.2023
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## Jeffrey D. Venezia, AIA NJ RA AI 00827100

1 12.01.2023 Addendum No. 01 11.08.2023 For Public Bid

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BLD 2



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\jnathanson\Documents\UCGC-ARCH-C0RE SHELL R23\_jnathanson@digrouparchitecture.com

МАТ	ERIAL	LEGEND
	GL-1	1" THICK CLEAR INSULATED TEMPERED GLAZING
	GL-3	1" THICK CERAMIC FRIT SPANDREL GLAZING
	GL-4	1" THICK INSULATED TEMPERED ACID ETCHED FROSTED GLAZING
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	TCP-4A	TERRACOTTA WALL SYSTEM FLUTED
	CMP-5	CORRUGATED METAL PANEL
	CMP-6	CORRUGATED METAL PANEL W/ PERFORATIONS
	CW-1	SEALED CONCRETE WALL WITH BOARD TEXTURE FINISH

 <u>BASIS OF DESIGN:</u>
 A. INTERIOR ALUMINUM STOREFRONT SYSTEMS BASIS OF DESIGN: EFCO 402 (INT) SERIES INTERIOR STOREFRONT FRAMING SYSTEM WITH GLAZING, SEE

 SPECIFICATIONS SECTION 084113
 EXTERIOR ALUMINUM STOREFRONT SYSTEMS BASIS OF DESIGN: EFCO 403 (EXT) SERIES EXTERIOR STOREFRONT FRAMING SYSTEM WITH GLAZING, SEE

(EXT) SERIES EXTERIOR STOREFRONT FRAMING SYSTEM WITH GLAZING, SE SPECIFICATIONS SECTION 084113 C. UNITIZED PRE-GLAZED CURTAIN WALL ALUMINUM STOREFRONT SYSTEMS

BASIS OF DESIGN: EFCO SERIES 5600PG PRE-GLAZED CURTAIN WALL 7-1/2" SYSTEM WITH GLAZING, SEE SPECIFICATIONS SECTION 084413

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ENLARGED ELEVATIONS AND WALL PLANS - BUILDING NO.1 NORTH
A-323A

### Jeffrey D. Venezia, AIA NJ RA AI 00827100

 1
 12.01.2023
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 11.08.2023
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 No.
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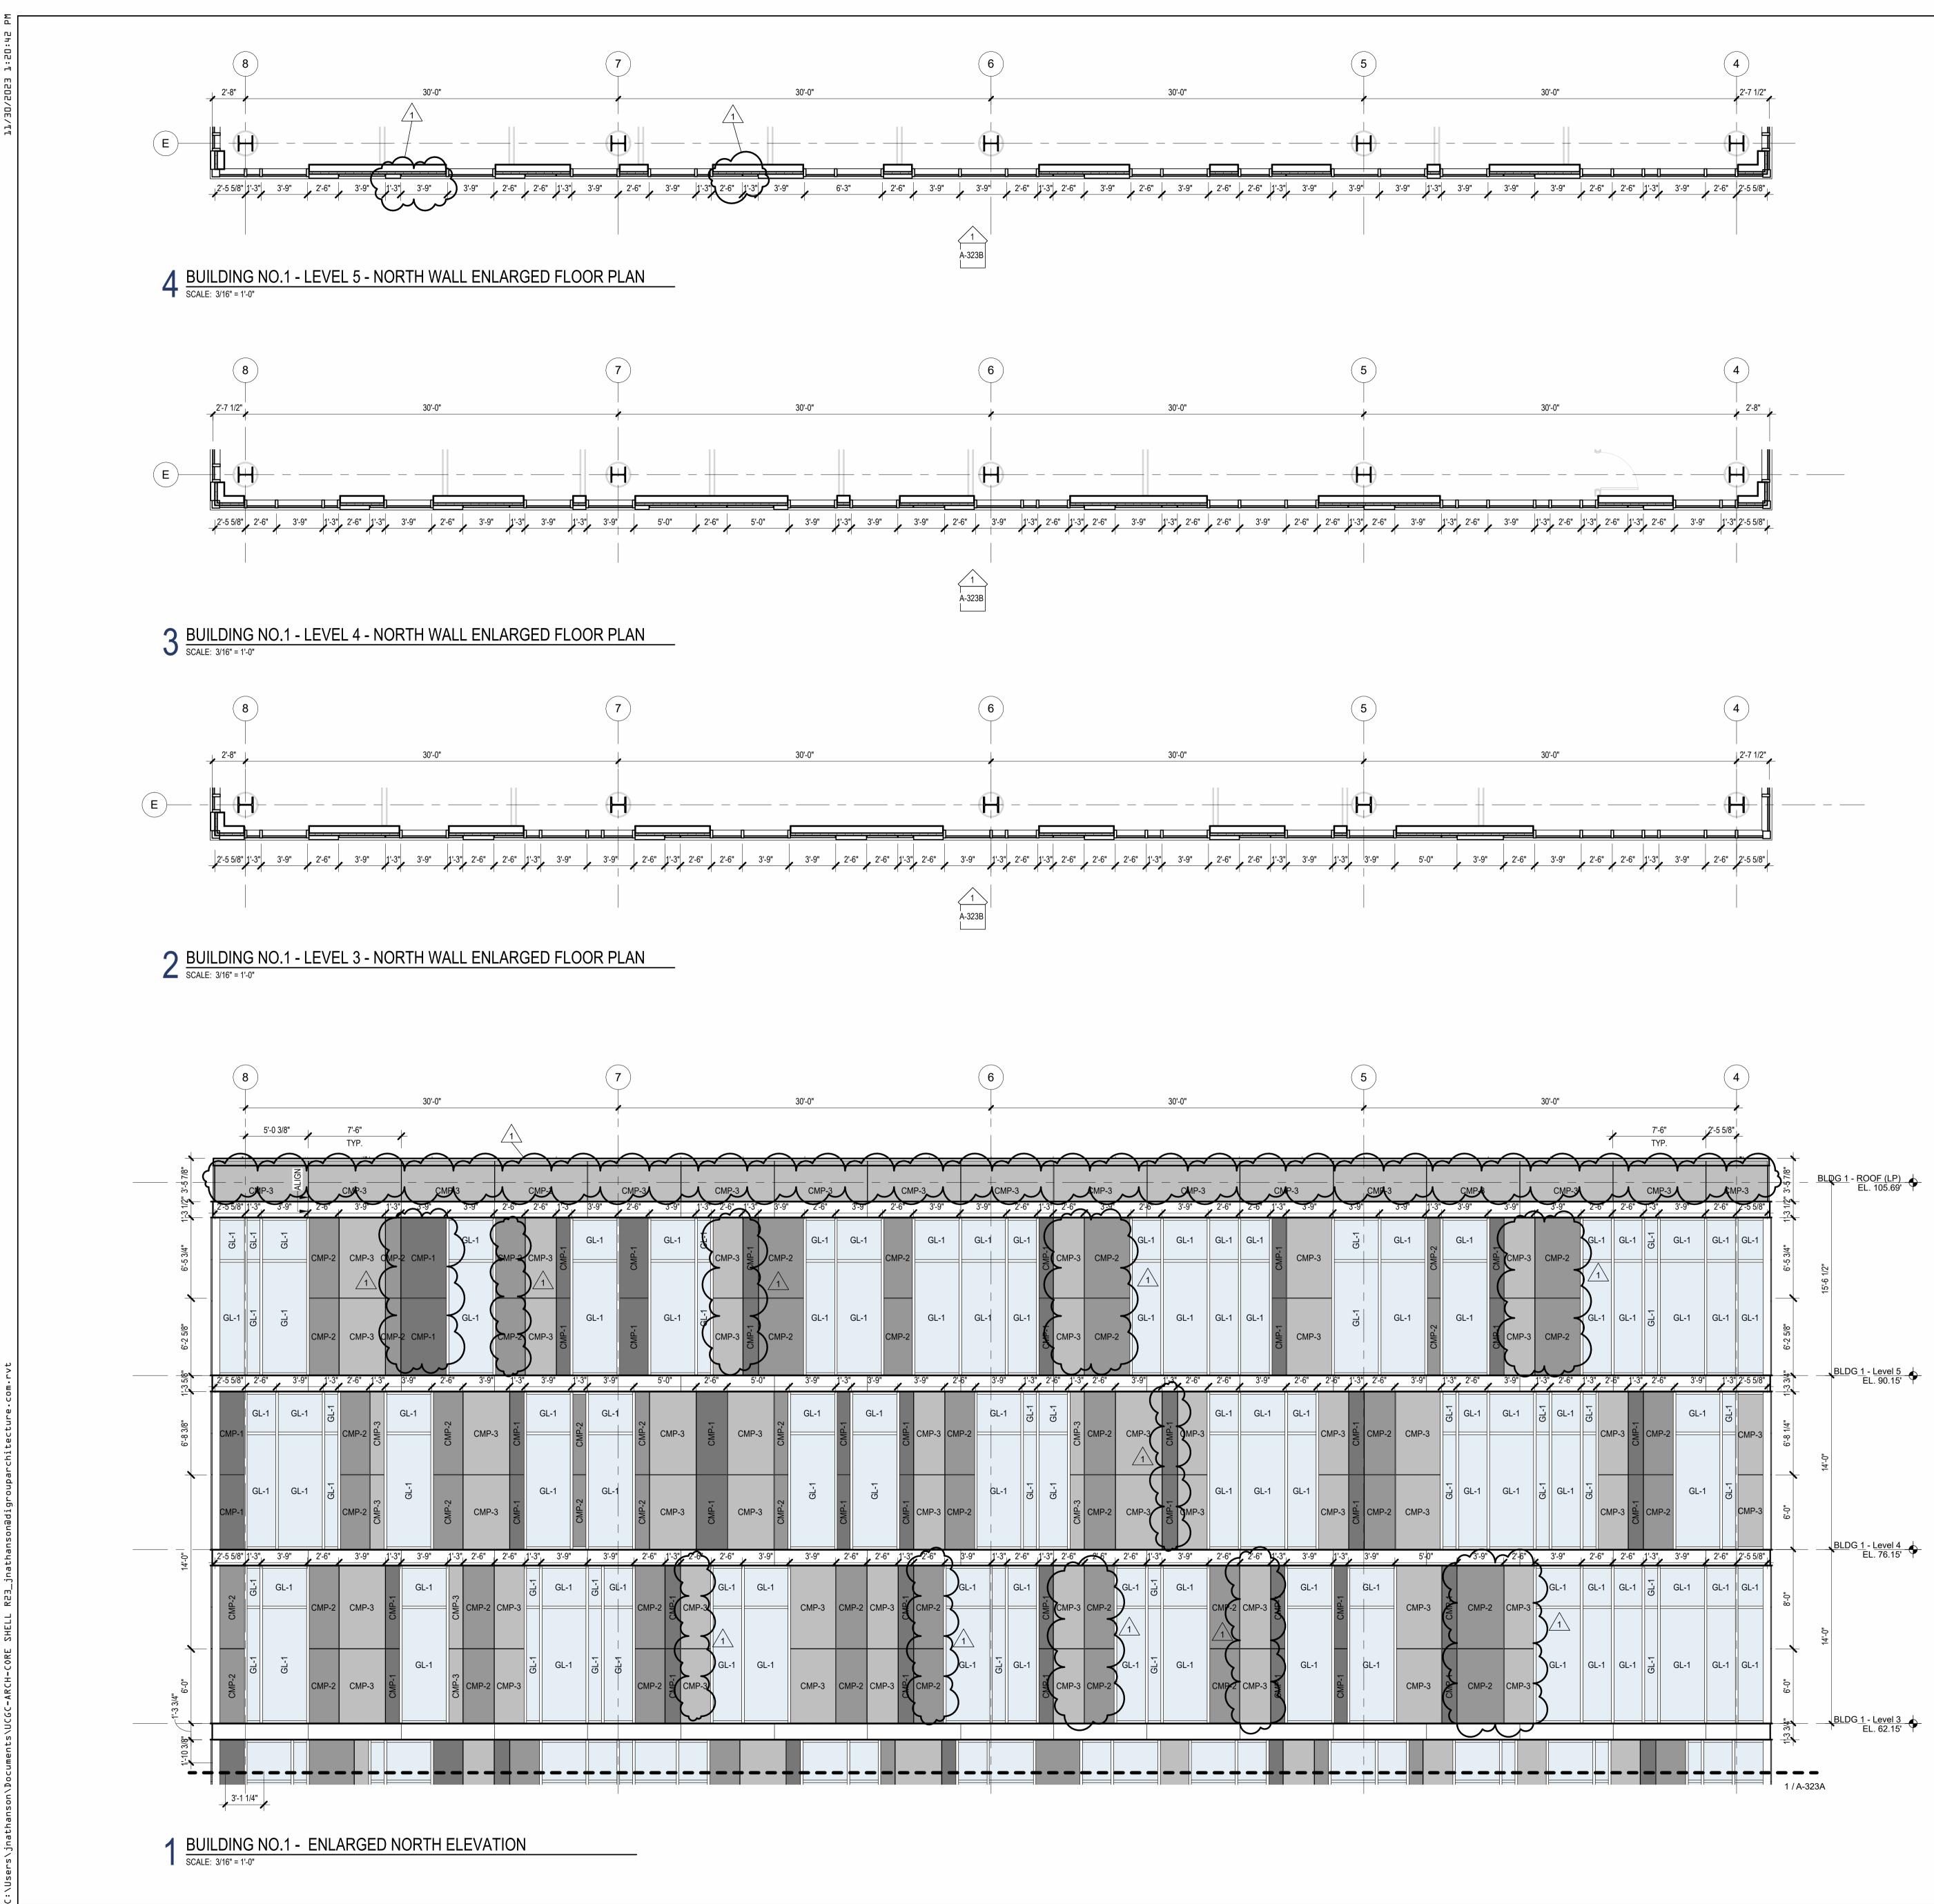
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CHERRY ST. WEST GRAND ST. PROJECT NORTH TRUE NORTH



MAT	ERIAL	LEGEND
	GL-1	1" THICK CLEAR INSULATED TEMPERED GLAZING
	GL-3	1" THICK CERAMIC FRIT SPANDREL GLAZING
	GL-4	1" THICK INSULATED TEMPERED ACID ETCHED FROSTED GLAZING
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	TCP-4A	TERRACOTTA WALL SYSTEM FLUTED
	CMP-5	CORRUGATED METAL PANEL
	CMP-6	CORRUGATED METAL PANEL W/ PERFORATIONS
	CW-1	SEALED CONCRETE WALL WITH BOARD TEXTURE FINISH

BASIS OF DESIGN: . A. INTERIOR ALUMINUM STOREFRONT SYSTEMS BASIS OF DESIGN: EFCO 402 (INT) SERIES INTERIOR STOREFRONT FRAMING SYSTEM WITH GLAZING, SEE SPECIFICATIONS SECTION 084113

B. EXTERIOR ALUMINUM STOREFRONT SYSTEMS BASIS OF DESIGN: EFCO 403

(EXT) SERIES EXTERIOR STOREFRONT FRAMING SYSTEM WITH GLAZING, SEE SPECIFICATIONS SECTION 084113 C. UNITIZED PRE-GLAZED CURTAIN WALL ALUMINUM STOREFRONT SYSTEMS

BASIS OF DESIGN: EFCO SERIES 5600PG PRE-GLAZED CURTAIN WALL 7-1/2" SYSTEM WITH GLAZING, SEE SPECIFICATIONS SECTION 084413

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Project:
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Date: 11.08.2023 Drawn By: JB / AV / PC Checked By: JM / SH
Sheet Name:
ENLARGED ELEVATIONS AND WALL PLANS - BUILDING NO.1 NORTH
A-323B


## Jeffrey D. Venezia, AIA NJ RA AI 00827100

1 12.01.2023 Addendum No. 01

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(HUMAN SERV.) PROJECT NORTH TRUE NORTH



MAT	ERIAL	LEGEND
	GL-1	1" THICK CLEAR INSULATED TEMPERED GLAZING
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	CW-1	SEALED CONCRETE WALL WITH BOARD TEXTURE FINISH

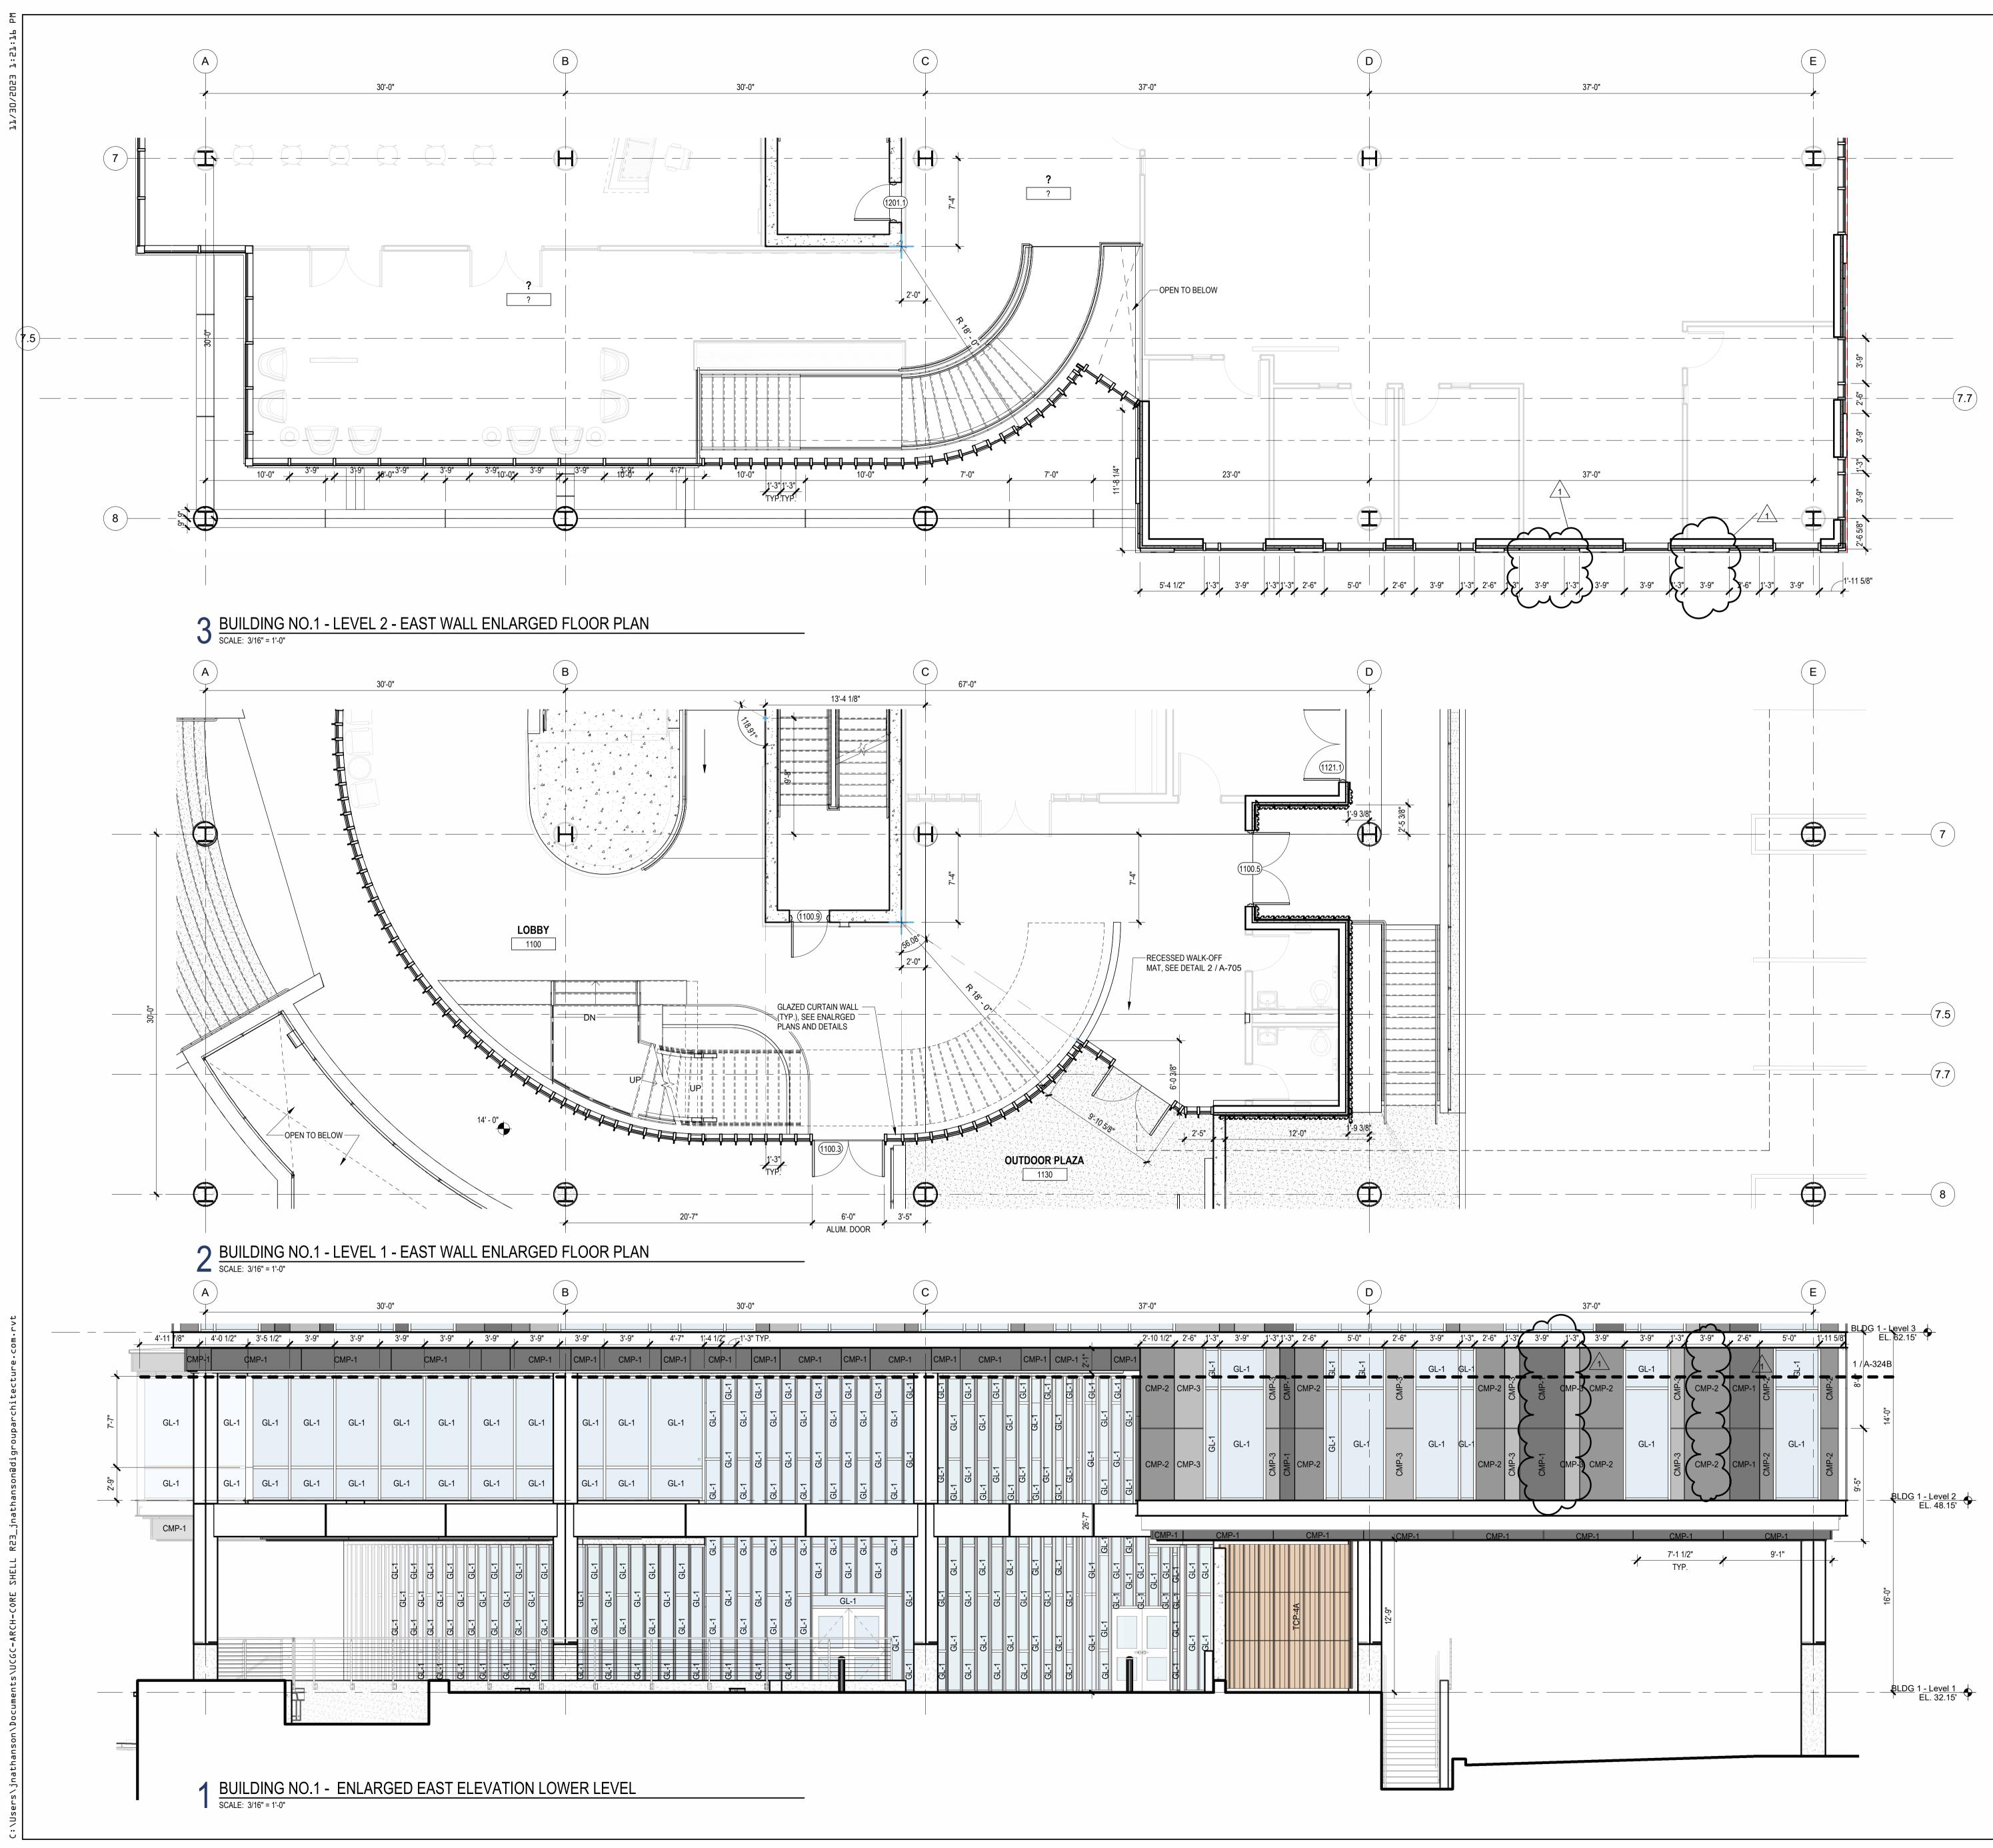BASIS OF DESIGN:

- A. INTERIOR ALUMINUM STOREFRONT SYSTEMS BASIS OF DESIGN: EFCO 402 (INT) SERIES INTERIOR STOREFRONT FRAMING SYSTEM WITH GLAZING, SEE
- SPECIFICATIONS SECTION 084113
- B. EXTERIOR ALUMINUM STOREFRONT SYSTEMS BASIS OF DESIGN: EFCO 403 (EXT) SERIES EXTERIOR STOREFRONT FRAMING SYSTEM WITH GLAZING, SEE SPECIFICATIONS SECTION 084113 C. UNITIZED PRE-GLAZED CURTAIN WALL ALUMINUM STOREFRONT SYSTEMS
- BASIS OF DESIGN: EFCO SERIES 5600PG PRE-GLAZED CURTAIN WALL 7-1/2" SYSTEM WITH GLAZING, SEE SPECIFICATIONS SECTION 084413

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	AND STREET								
81 & 93 WEST GRAND STREET CITY OF ELIZABETH									
NEW JERSEY, 07	NEW JERSEY, 07202								
Drawing Information	n.								
Project No: 20.0									
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UNION COUNTY IMPROVEMENT

## Jeffrey D. Venezia, AIA NJ RA AI 00827100

Client:


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1 12.01.2023 Addendum No. 01 11.08.2023 For Public Bid

No. Date Description Revisions / Issues **DIGroup**Architecture ARCHITECTURE FOR CHANGE 15 Bethany Street • New Brunswick, NJ 08901 • T: 732.249.6242 2450 W Hunting Park Ave • Philadelphia, PA 19122 • T: 215.634.3400

KEY PLAN: PROJECT NORTH TRUE NORTH



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-0" ]-3"	2-5		2-6		3'-9"	2'-6"	2'-6"	 ] <sup>1+3"</sup>	IP-1 3'-9"			CMP. 37 2		-3" / 2	2'-6"	2'-6"			₹-9" •			6"	3'-9"	2-6"	17-1		2'+6"	<u>2'-6</u> "	7-3"	2'-6"	CMP- 3'-9"
1P-2	CMP-3	CMP-2			GL-1	GL-1	GL-1	GL-1	GL-1	GL	-1 2	G	L-1 ä	وز-	GL-1	GL-1	GLA	CMP-1	MP-2	CMP-3			GL-1	GL	C MD 2		-1	GL-1	GL-1	GL-1	GL-1
1P-2	CMP-3	CMP-2			GL-1	GL-1	GL-1	Gt-1	GL-1	GL	-1 2	G	L-1 a	ۍ ورد.ا	GL-1	GL-1	6-4	CMP-1	:MP-2	CMP-3			GL-1	GL				GL-1	GL-1	GL-1	GL-1
3'-9"			2'-6"	1'-3"	2'-6"	3'-9"	1'-3"		3'-9"	2'-6"		2'-6"		-9"	1	2'-6"	1'-3"				1'-3"	2'-6"	, <sup>1'-3"</sup> ,	3'-9"			2'-6"	3'-9'		2'-6"	
CMP-3	er-1	GL-1	= CMP-:	CMP-2	CMP-3 =	GL-1	GL-1		L-1	GL-1	GL-1	GL-1		1	GL-1	CMP-2	CMP-3	GL-1	GL	GL-1	CMP-2	CMP-3	GL-1	GL-1	GL	-1	GЦ-1	CMF	-3	CMP-2	MD CMP-1
CMP-3	GL-1	GL-1	CMP-	CMP-2	CMP-3	GL-1	GL-1	G	L-1	GL-1	GL-1	GL-1	G	1	GL-1	CMP-2	က္	GL-1	GL-1	GL-1	CMP-2	CMP-3	GL-1	GL-1	GL	-1	-1 GŁ-1-	CMF	y_3	CMP-2	MD CMP-1
3'-9"	2'-0		2'-6"	2'-6"	3'-9"	2'-6	" 1'-3"		'-9"	3'-9"		3" 2	<u> </u>	-3" 2		2'-6"		'-9"	3'.	-9" Y	1-3"	2'6	2'-6	3'-	.9"	2'-6"			3" 2'-6		3'-9"
GL-1	GL	2	CMP-3 =	GL-1	GL-1	CMF	۰. CMP-2	G	L-1	GL		CNIC	1P-3 =	יס פרי. פרי	SL-1	GL-1	G		СМ	IP-3	CMP-2	CMP-3	CMP		1	GL-1	ניים   	GL-1	GL-1	CMP-2	CMP-
GL-1	GL	5	CMP-3	GL-1	GL-1	CMF	ი. CMP-2	G	L-1	GL-1 GL		CMC	1P-3		GL-1	GL-1	G	∟- <b>\</b> \ \	СМ	IP-3	CMP-2	CMP-3	CMP			GL-1	์ อ	GL-1	GL-1	CMP-2	CMP-
P-1 CI	MP-1	CMP-	1 CM	IP-1	CMP-	1 C	MP-1	С	MP-1	CMP	-1	CM	P-1	СМ	IP-1	СМГ	P-1	<u> </u>				$\overline{\sim}$									
											7'-6" TYP.							-	-	-	-	• •• •	+			-	-		63'-7	1/2"	-

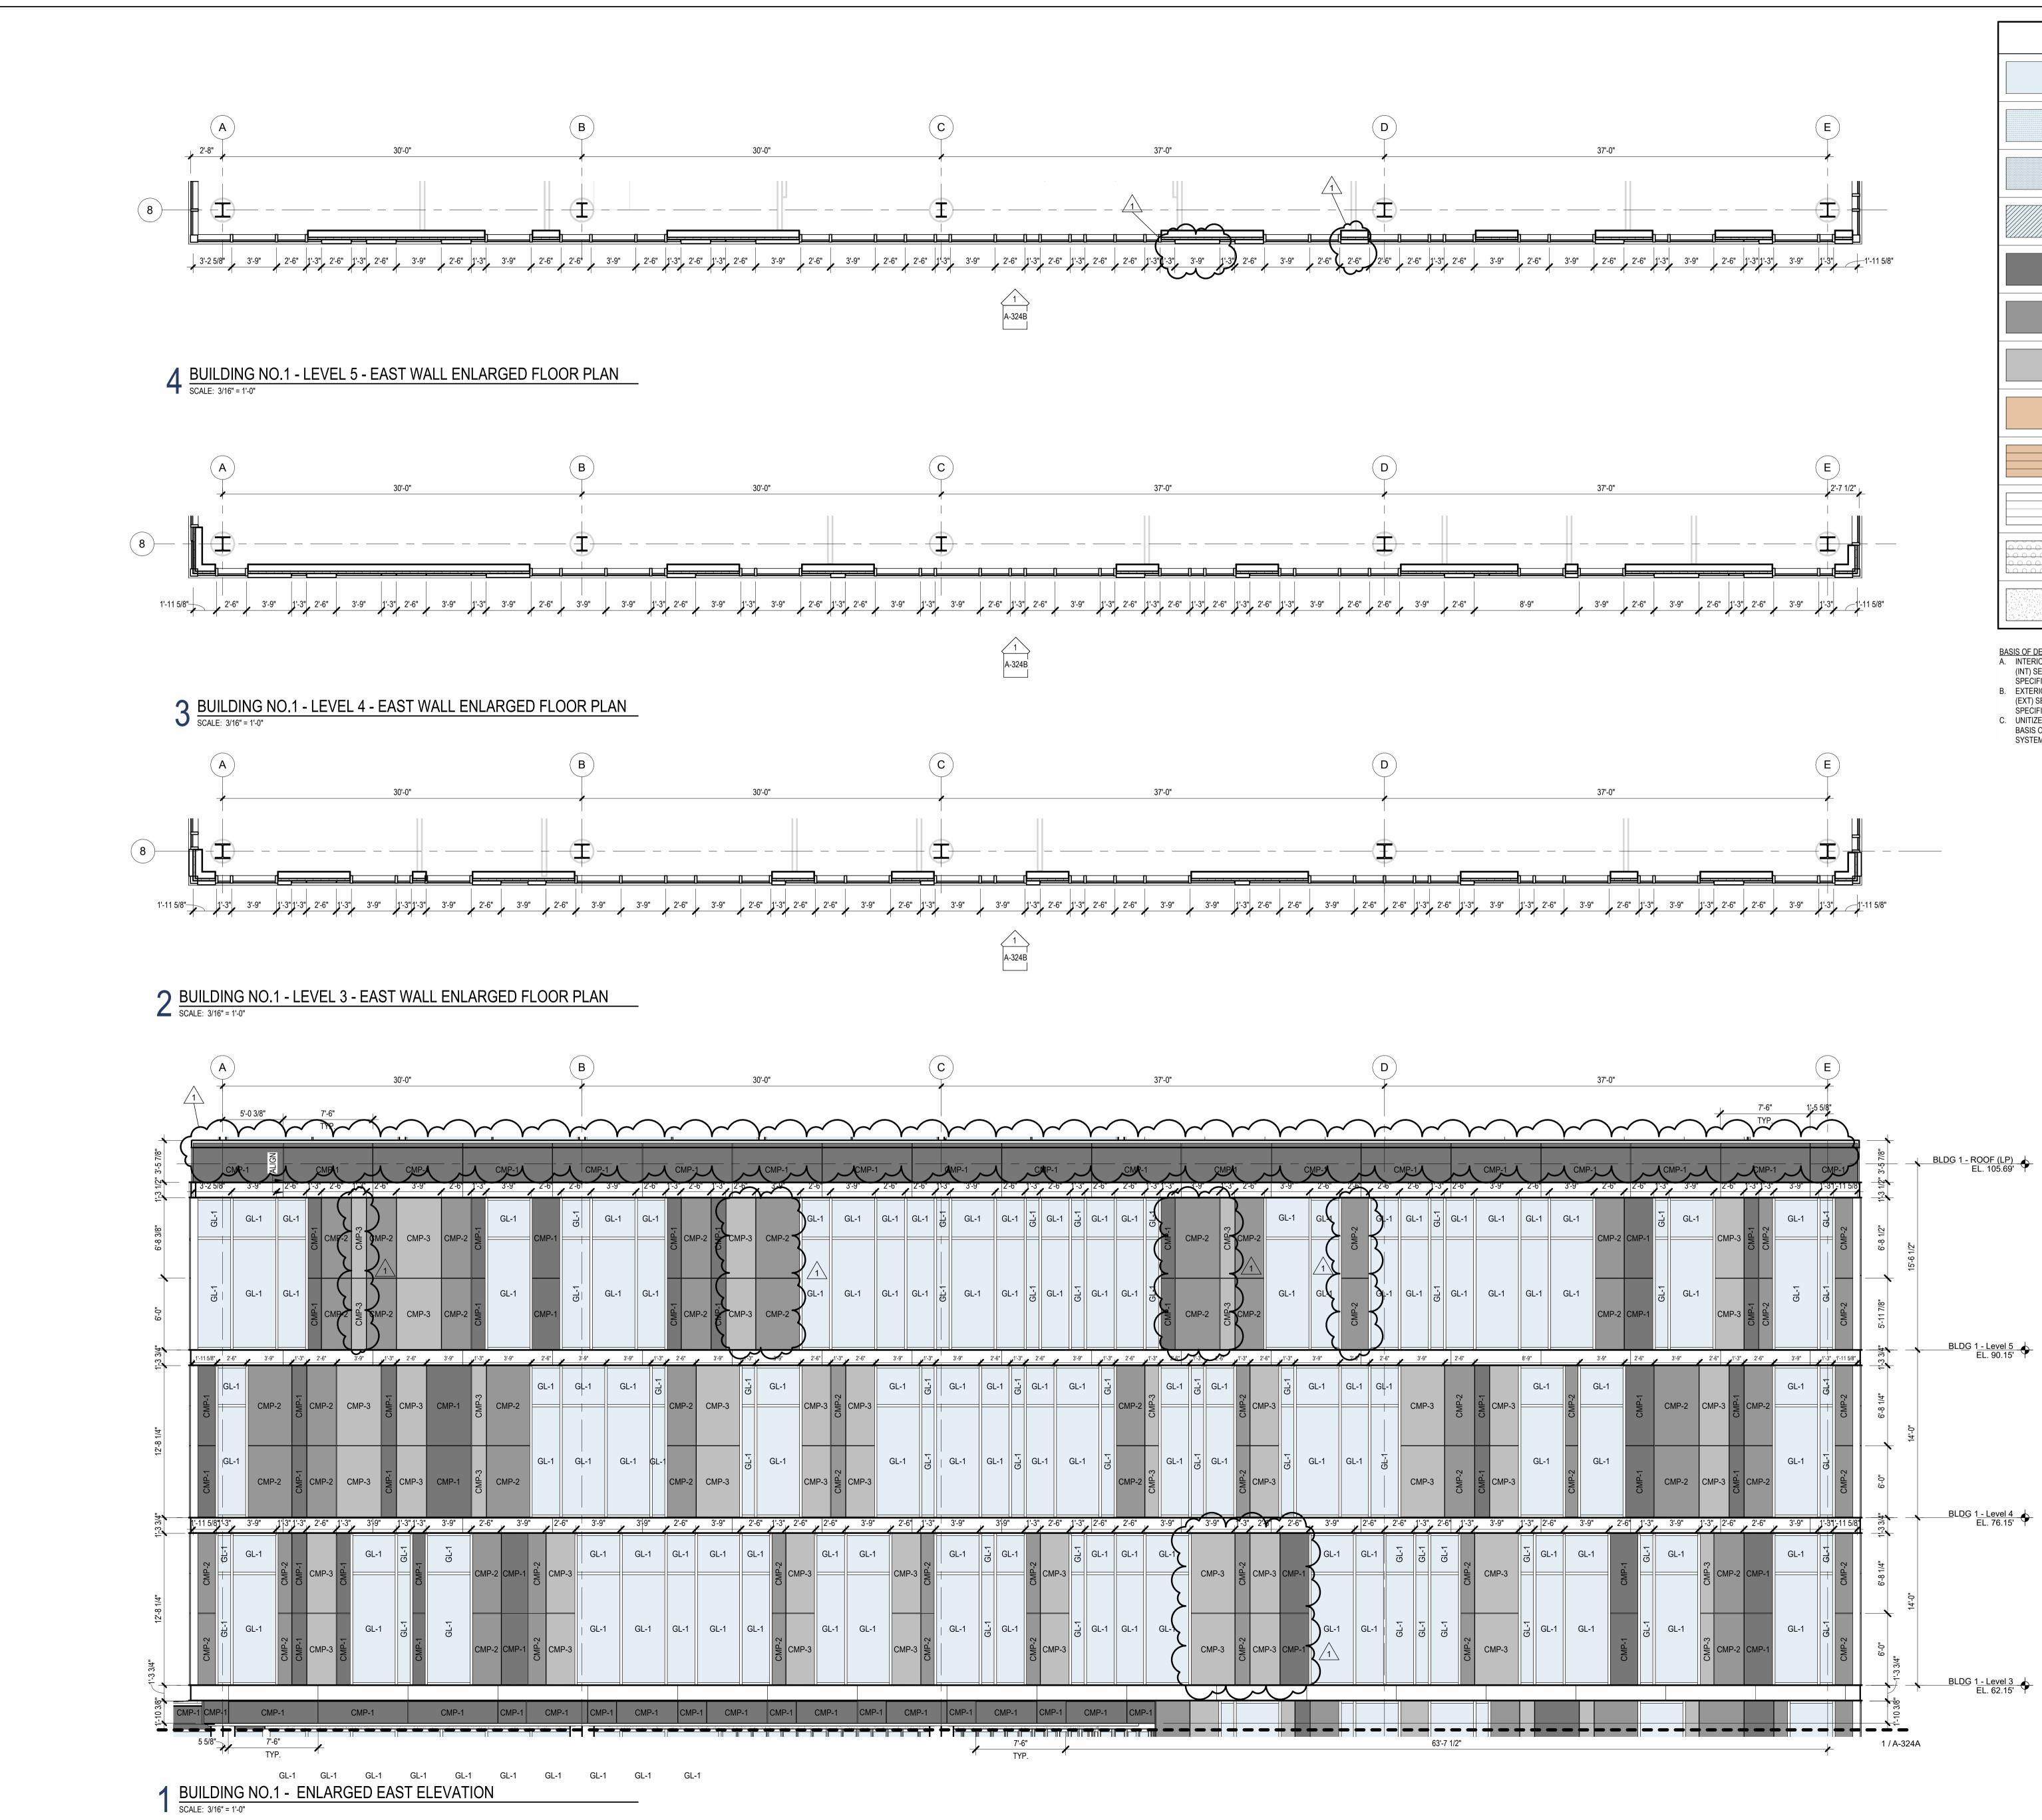MAT	ERIAL	LEGEND
	GL-1	1" THICK CLEAR INSULATED TEMPERED GLAZING
	GL-3	1" THICK CERAMIC FRIT SPANDREL GLAZING
	GL-4	1" THICK INSULATED TEMPERED ACID ETCHED FROSTED GLAZING
	GL-5	1" THICK CLEAR INSULATED TEMPERED TRIPLE GLAZING W/ CUSTOM SEAL
	CMP-1	COMPOSITE METAL PANEL WITH COLOR NO. 1
	CMP-2	COMPOSITE METAL PANEL WITH COLOR NO. 2
	CMP-3	COMPOSITE METAL PANEL WITH COLOR NO. 3
	TCP-4	TERRACOTTA WALL SYSTEM FLAT
	TCP-4A	TERRACOTTA WALL SYSTEM FLUTED
	CMP-5	CORRUGATED METAL PANEL
	CMP-6	CORRUGATED METAL PANEL W/ PERFORATIONS
	CW-1	SEALED CONCRETE WALL WITH BOARD TEXTURE FINISH

BASIS OF DESIGN: . A. INTERIOR ALUMINUM STOREFRONT SYSTEMS BASIS OF DESIGN: EFCO 402

(INT) SERIES INTERIOR STOREFRONT FRAMING SYSTEM WITH GLAZING, SEE SPECIFICATIONS SECTION 084113

B. EXTERIOR ALUMINUM STOREFRONT SYSTEMS BASIS OF DESIGN: EFCO 403 (EXT) SERIES EXTERIOR STOREFRONT FRAMING SYSTEM WITH GLAZING, SEE SPECIFICATIONS SECTION 084113

2. UNITIZED PRE-GLAZED CURTAIN WALL ALUMINUM STOREFRONT SYSTEMS BASIS OF DESIGN: EFCO SERIES 5600PG PRE-GLAZED CURTAIN WALL 7-1/2" SYSTEM WITH GLAZING, SEE SPECIFICATIONS SECTION 084413

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- 00	ductio	on or	other	use of	f thes	e draw	ings o	or idea	as is p	rohibit	ed.

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UNION COUNTY IMPROVEMENT AUTHORITY
Project:
UNION COUNTY GOVERNMENT COMPLEX 81 & 93 WEST GRAND STREET CITY OF ELIZABETH NEW JERSEY, 07202
Drawing Information:
Project No: 20.072 Date: 11.08.2023 Drawn By: JB / AV / PC Checked By: JM / SH
Sheet Name:
ENLARGED ELEVATIONS AND WALL PLANS - BUILDING NO.1 EAST
<b>A-324B</b>


## Jeffrey D. Venezia, AIA NJ RA AI 00827100

 
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 12.01.2023
 Addendum No. 01

 11.08.2023
 For Public Bid

 No.
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 Description
 Revisions / Issues **DIGroup**Architecture ARCHITECTURE FOR CHANGE 15 Bethany Street • New Brunswick, NJ 08901 • T: 732.249.6242 2450 W Hunting Park Ave • Philadelphia, PA 19122 • T: 215.634.3400

(HUMAN SERV.) PROJECT NORTH TRUE NORTH

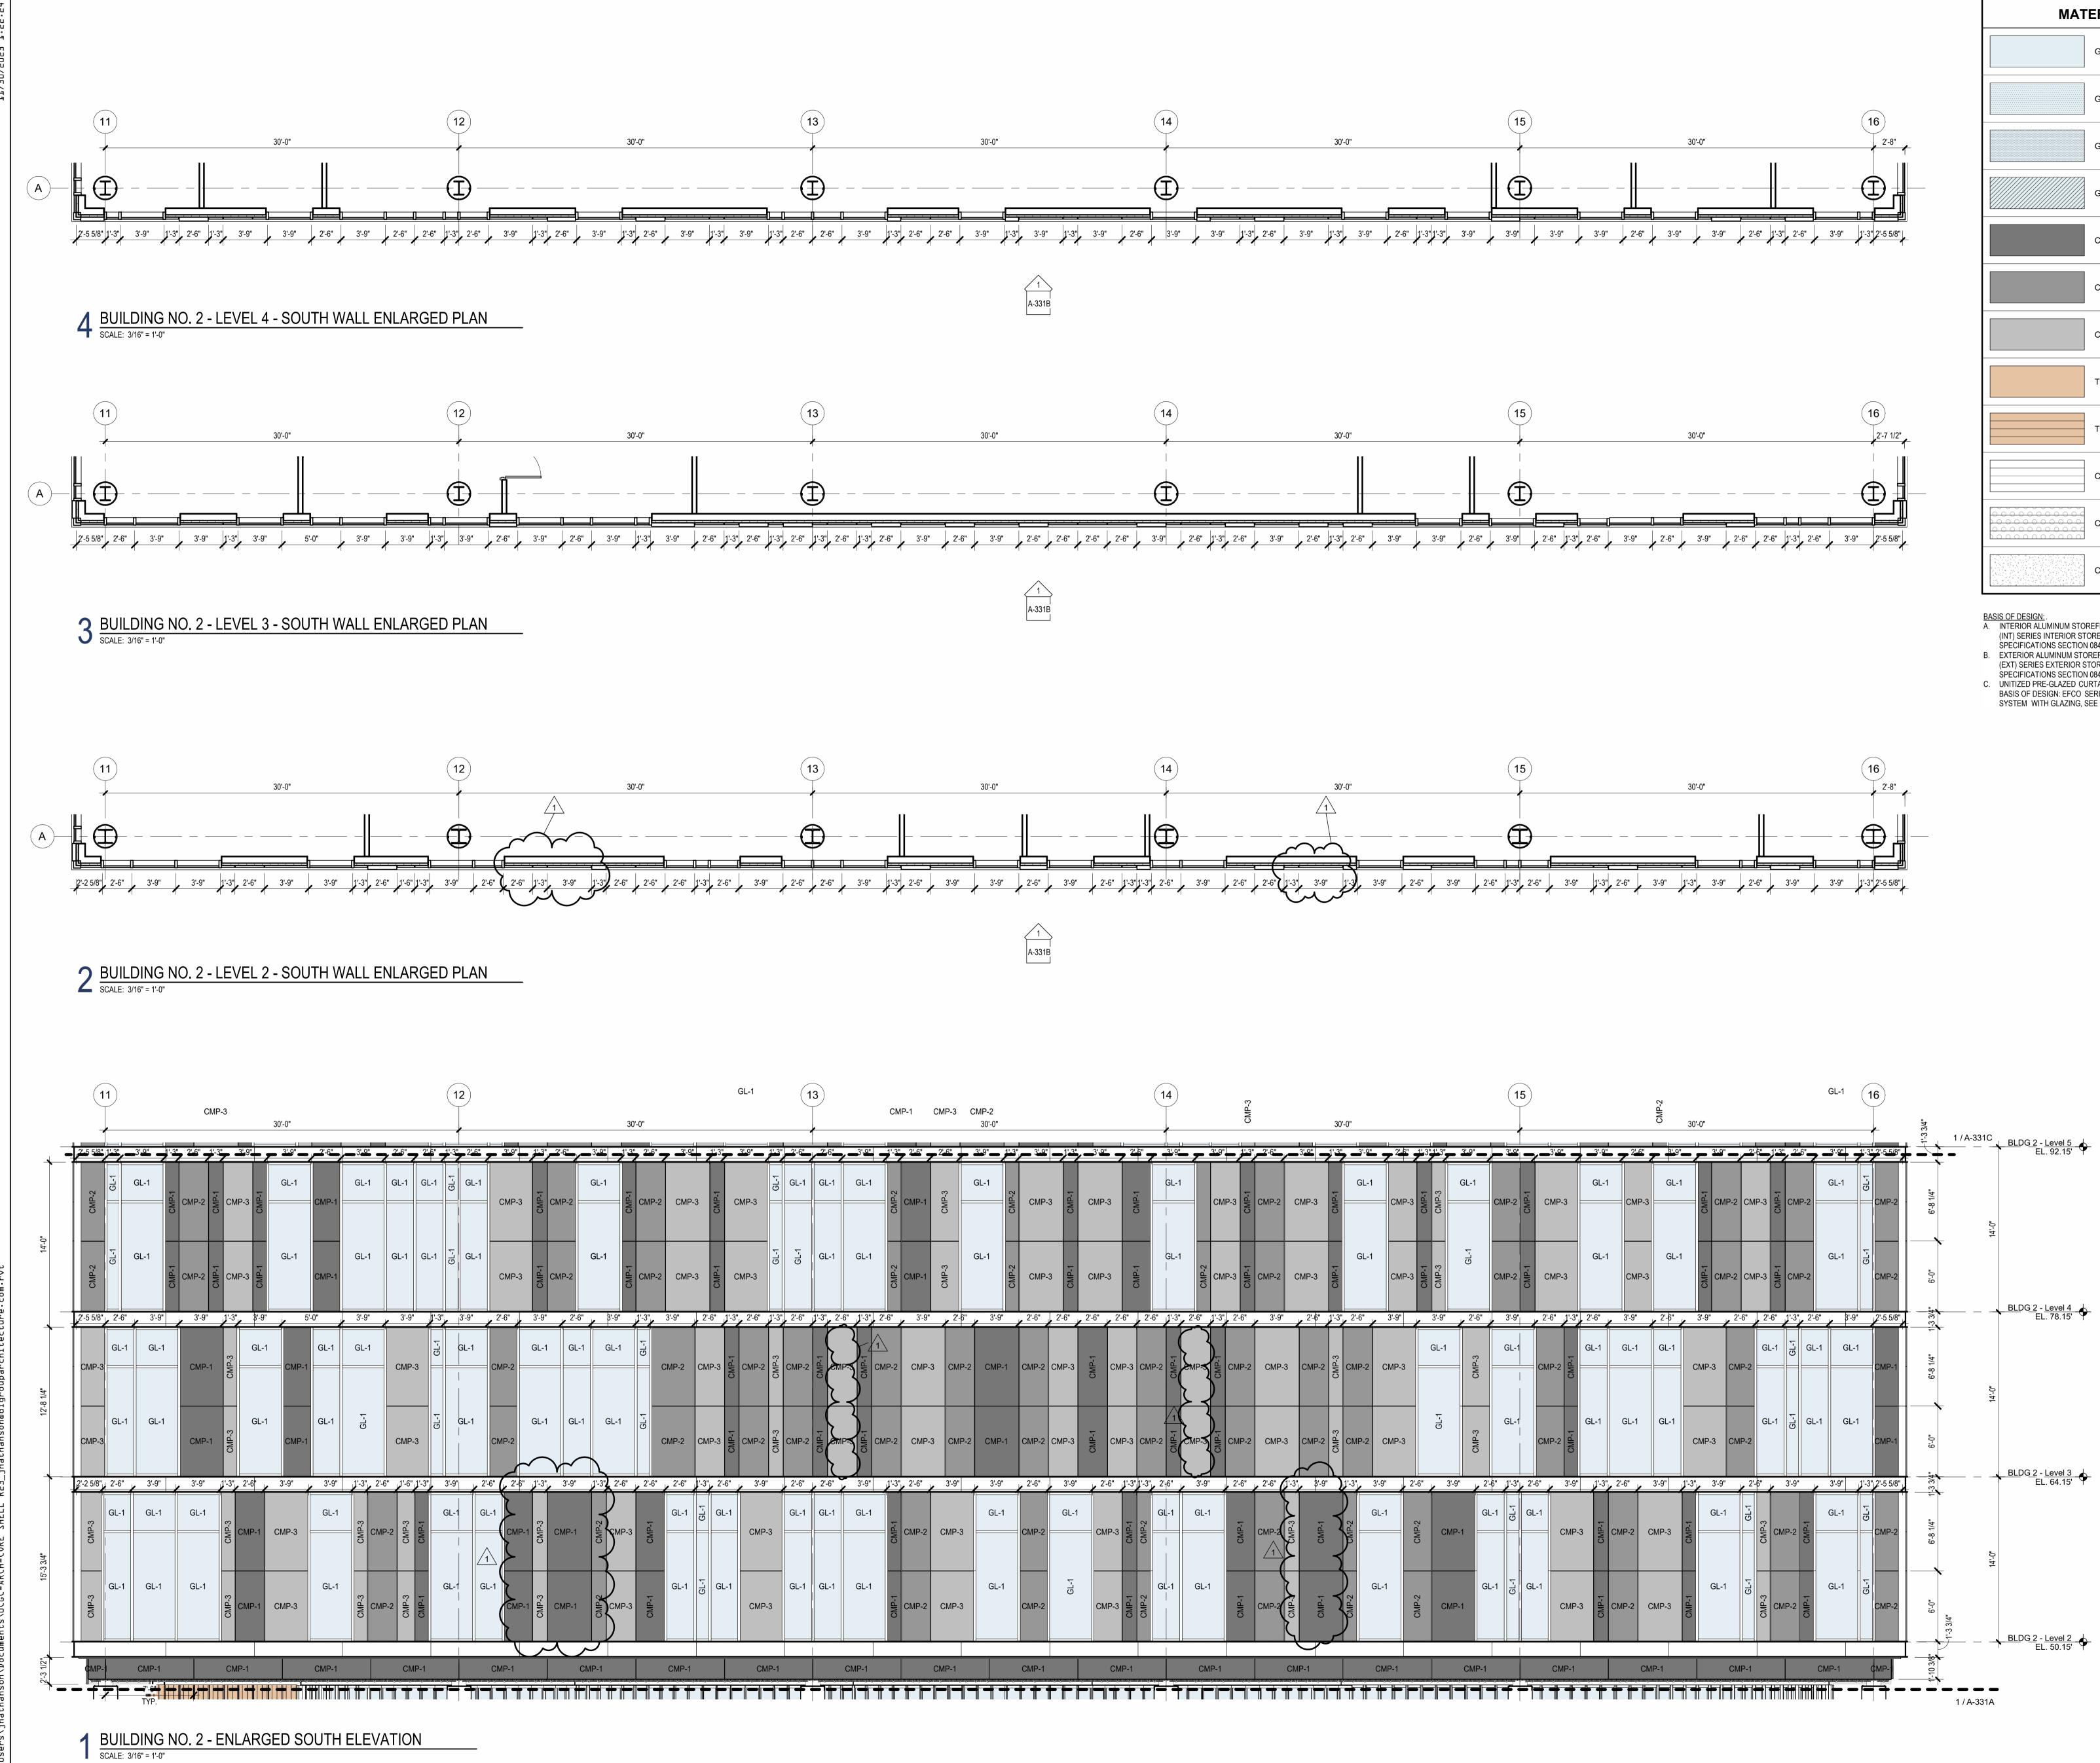

		GL-1		(1	3		CM	P-1	CMP-3	CMP-2 30'-0"						(	14			CMP-3			3	0'-0"					
	<b>1</b> <u>-</u> 3"	3'-9"-	<b>1'-</b> 3"	'2'-6"	2'-6"	<b></b> 3'- <u>0"</u>		2'-6"	2'-6"	3'_0"	<u>1'-3</u> "	3'-0"	'	<b></b> 3'- <u></u> 2"	<b></b> 2'	ê" <b></b>	 		3'-9"	1-3"	<b></b>	3'9"	<b></b> ]':	3"3'-1	2"2	<b>6" _1</b> '3	3"_1'_3"	3'-9"	
3	CMP-1	CMP-3	GL-1	GL-1	GL-1	GL-1	CMP-2	CMP-1	CMP-3	GL-1	-2	CMP-3		CMP-3	3		GL-1		CMP-3		CMP-2	CMP-	-	GL	-1	1P-3		GL-1	
3	CMP-1	CMP-3	GL-1	GL-1	GL-1	GL-1	CMP-2	CMP-1	CMP-3	GL-1	CMP-2	CMP-3	CMP-1	CMP-3	3	- 110	GL-1	CMP-2	CMP-3	CMP-1	CMP-2	CMP-	CMP-1	GL		1P-3	CMP-3	GL-1	
, 2'-6	6" 1'-	3" 2'-6"	1'-3"	2'-6"	1'-3", 2	'-6" 1'-3"	2'-6"	3'-9"	2'-6'	' 3'-9"	/ 2	2'-6"	, 2'-6"	2'-6"	2'-6"	, 2'-6"	1'-3"	, 2'-6"	1'-3"	2'-6"	3'-9"	2'-	-6" 1'-3	3"2'-6"	3'-9'		3'-9"	2'-6'	
CMF	p-3	CMP-2	CMP-3	CMP-2	CMP-1	CMP-1	CMP-2	CMP-	3 CMP	-2 CMP-	1 CI	ИР-2	CMP-3	CMP-1	CMP-3	CMP-2	CMP-1	EMP-5	CMP-1	MP-2	CMP-	3 CM	CMP-3	CMP-2	2 CMP-	3 =	GL-1	CMP-3	
CMF	p-3	CMP-2	CMP-3	CMP-2	CMP-1	CMP-1	CMP-2	CMP-	3 CMP-	-2 CMP-	1 CM	ИР-2	CMP-3	CMP-1	CMP-3	CMP-2	CMP-1	2 CMP-3	CMP-1	MP-2	CMP-3	3 CM	CMP-3	CMP-2	2 CMP-	.3	GL-1	CMP-3	
1'-3"	, 2'-6"	3'-9	)"	2'-6"	2'-6"	3'-9"	1'-3"	2'-6"	3'-9"	3'-9"	<sup>2</sup>	2'-6"	, 3'-9"	2'-6	6" 1'-3"	1'-3"	2'+6"	, 3'-9'		2'-6"	2'-6"	1'-3"	3'-9"	1'-3"	3'-9"	2'-6"	<b>3</b>	5'-9"	2'-
GL-1	GL-1	= CMF	<b>2-3</b>	GL-1	GL-1	GL-1	CMP-1	CMP-2	CMP-3	GL-1		∕IP-2 =	GL-1	CMF	CMP-1		GL-1	GL-		CMP-1	CMP-2	CMP-3	CMP-1	CMP-2	GL-1	CMP-2	CN	/IP-1 =	GL
GL-1	GL-1	CMF	2-3	GL-1	GL-1	GL-1		CMP-2	CMP-3	GL-1		ИР-2	GL-1		cMP-1		GL-1	GL-	1		CMP-2	۲ ۲	CMP-1	CMP-2	GL-1	CMP-2	CN	ЛР-1	GL-
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MAT	ERIAL	LEGEND
	GL-1	1" THICK CLEAR INSULATED TEMPERED GLAZING
	GL-3	1" THICK CERAMIC FRIT SPANDREL GLAZING
	GL-4	1" THICK INSULATED TEMPERED ACID ETCHED FROSTED GLAZING
	GL-5	1" THICK CLEAR INSULATED TEMPERED TRIPLE GLAZING W/ CUSTOM SEAL
	CMP-1	COMPOSITE METAL PANEL WITH COLOR NO. 1
	CMP-2	COMPOSITE METAL PANEL WITH COLOR NO. 2
	CMP-3	COMPOSITE METAL PANEL WITH COLOR NO. 3
	TCP-4	TERRACOTTA WALL SYSTEM FLAT
	TCP-4A	TERRACOTTA WALL SYSTEM FLUTED
	CMP-5	CORRUGATED METAL PANEL
	CMP-6	CORRUGATED METAL PANEL W/ PERFORATIONS
	CW-1	SEALED CONCRETE WALL WITH BOARD TEXTURE FINISH

SPECIFICATIONS SECTION 084113 B. EXTERIOR ALUMINUM STOREFRONT SYSTEMS BASIS OF DESIGN: EFCO 403

(EXT) SERIES EXTERIOR STOREFRONT FRAMING SYSTEM WITH GLAZING, SEE

SPECIFICATIONS SECTION 084113 C. UNITIZED PRE-GLAZED CURTAIN WALL ALUMINUM STOREFRONT SYSTEMS

BASIS OF DESIGN: EFCO SERIES 5600PG PRE-GLAZED CURTAIN WALL 7-1/2" SYSTEM WITH GLAZING, SEE SPECIFICATIONS SECTION 084413

roduc	tion or othe	r use of these	drawings or	ideas is l	prohibited.


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Project:
UNION COUNTY GOVERNMENT COMPLEX 31 & 93 WEST GRAND STREET CITY OF ELIZABETH NEW JERSEY, 07202
Drawing Information:
Project No: 20.072 Date: 11.08.2023 Drawn By: JB / AV / PC Checked By: JM / SH
Sheet Name:
ENLARGED ELEVATIONS AND WALL PLANS - BUILDING NO.2 SOUTH
Δ-331Β

### Jeffrey D. Venezia, AIA NJ RÁ AI 00827100

1 12.01.2023 Addendum No. 01 11.08.2023 For Public Bid

No. Date Description Revisions / Issues **DIGroup**Architecture ARCHITECTURE FOR CHANGE 15 Bethany Street • New Brunswick, NJ 08901 • T: 732.249.6242 2450 W Hunting Park Ave • Philadelphia, PA 19122 • T: 215.634.3400

KEY PLAN: PROJECT NORTH TRUE NORTH

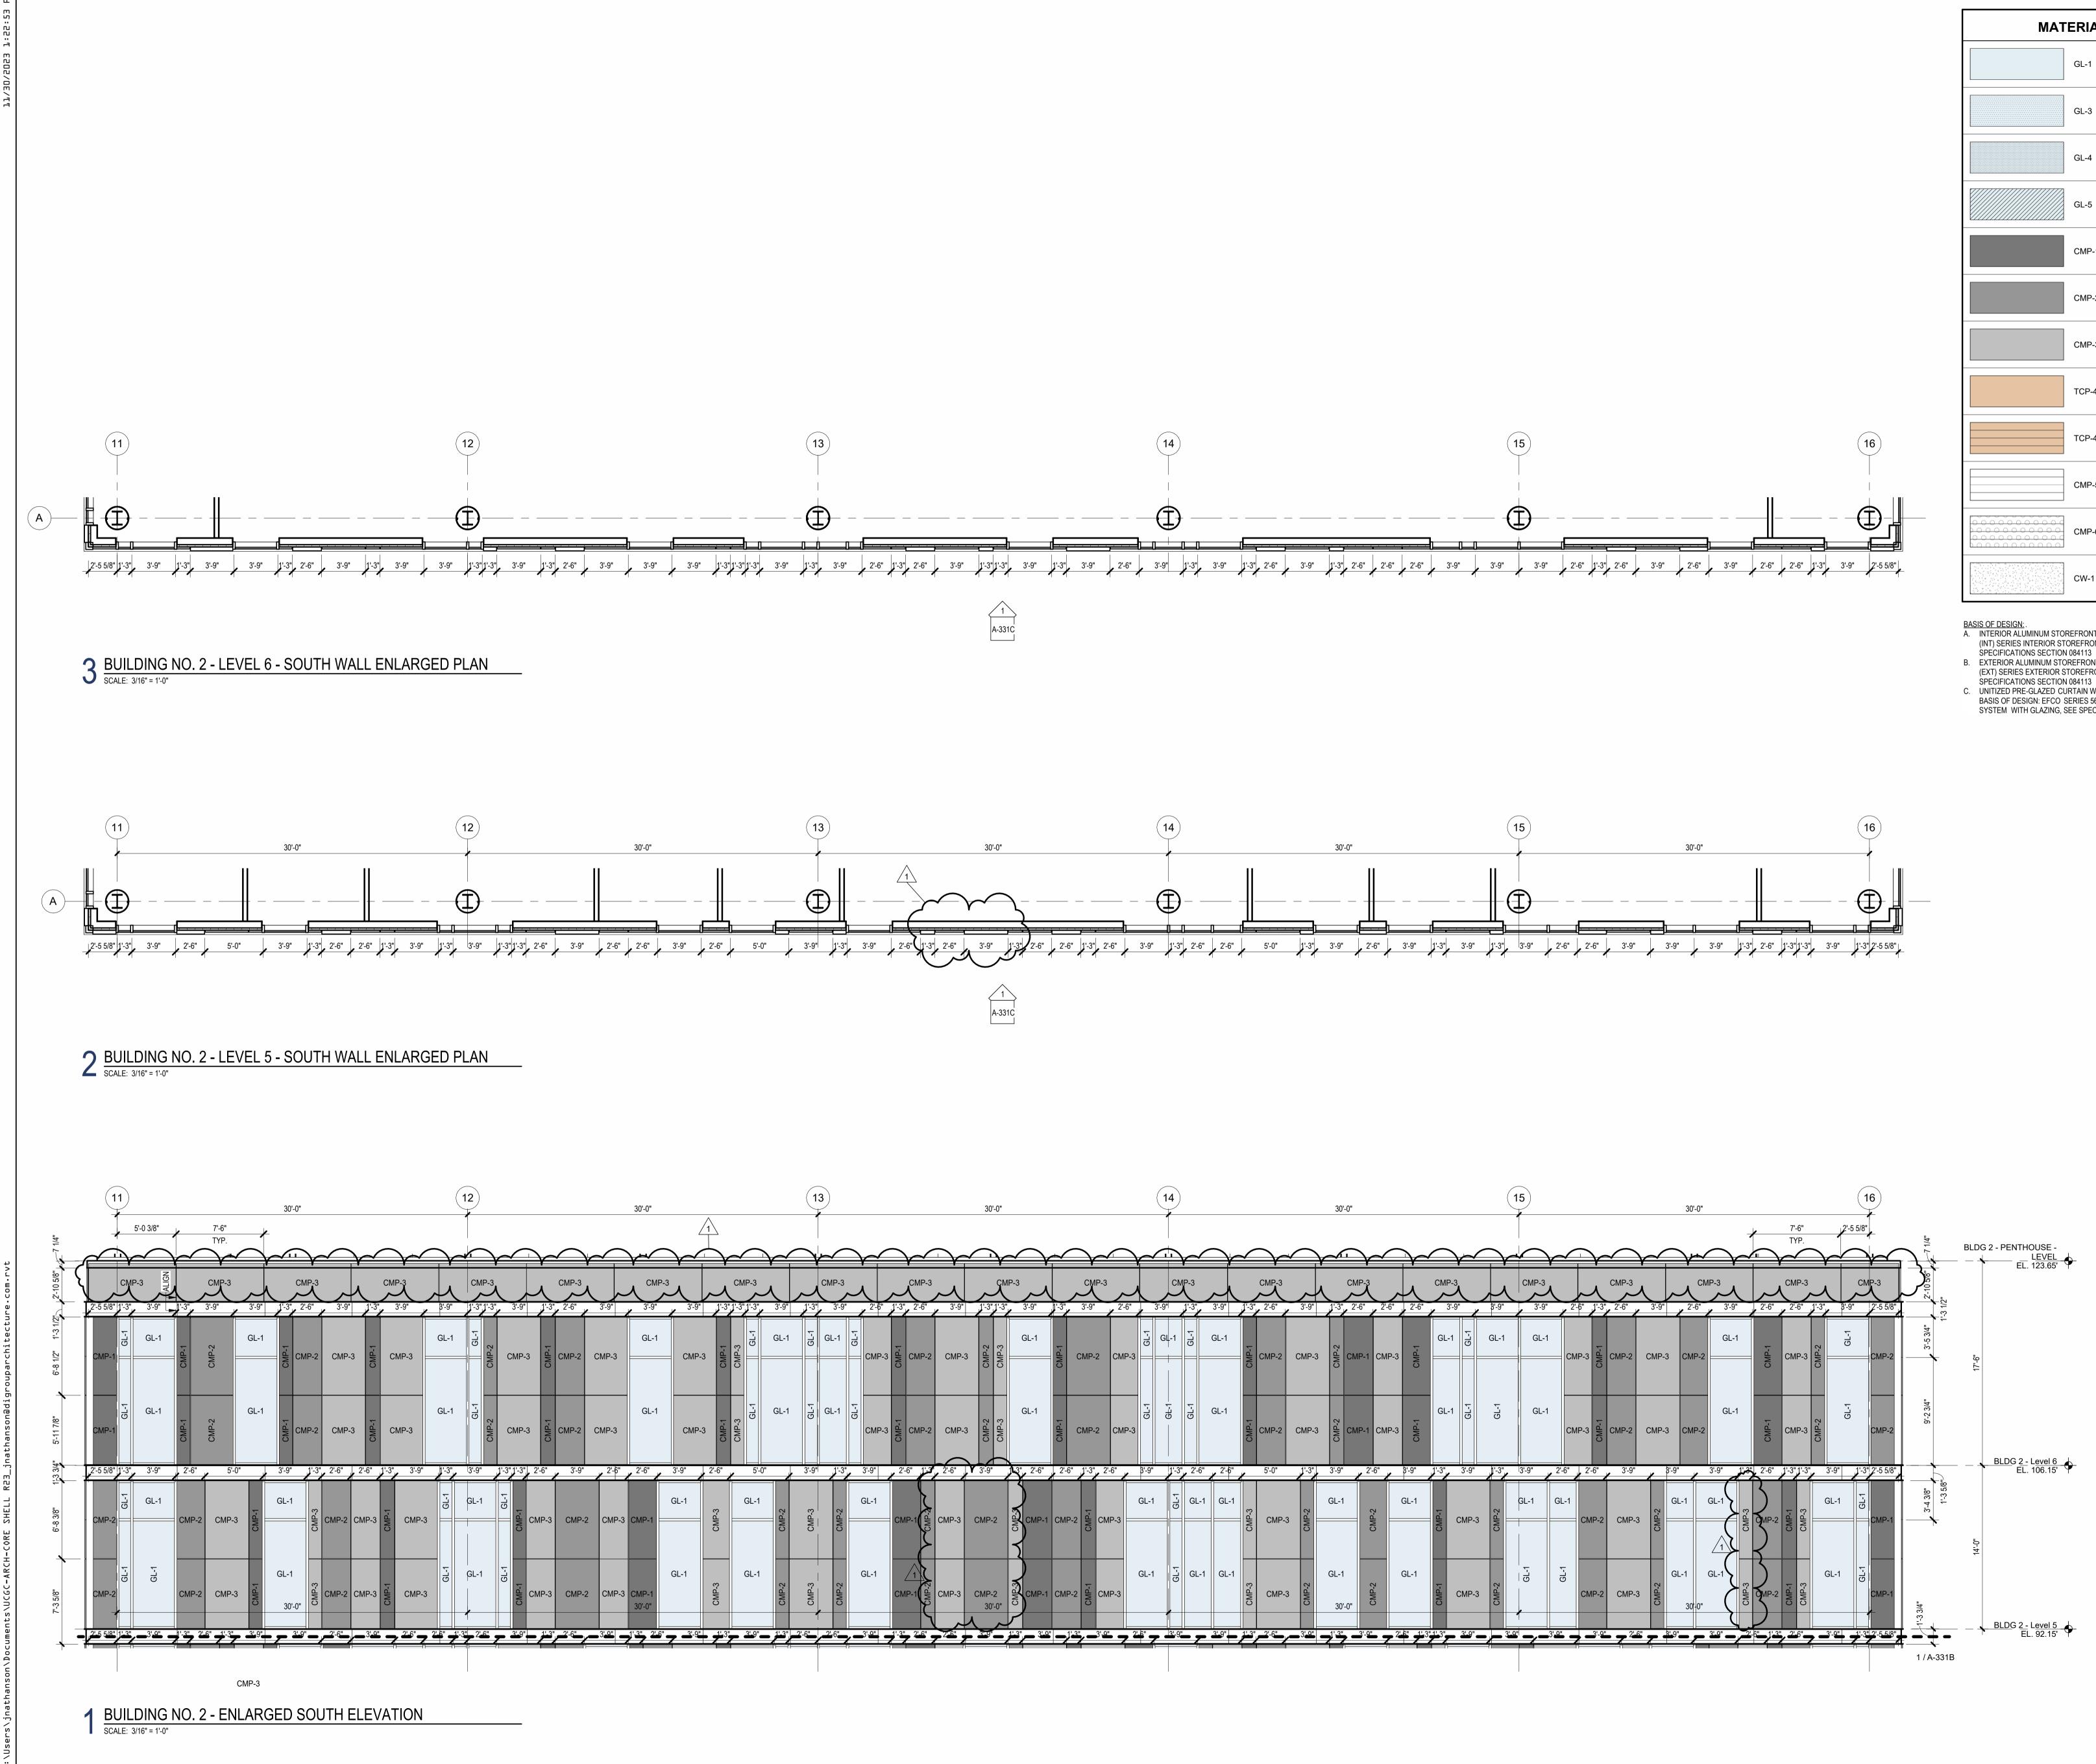

МАТ	ERIAL	LEGEND
	GL-1	1" THICK CLEAR INSULATED TEMPERED GLAZING
	GL-3	1" THICK CERAMIC FRIT SPANDREL GLAZING
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	CMP-6	CORRUGATED METAL PANEL W/ PERFORATIONS
	CW-1	SEALED CONCRETE WALL WITH BOARD TEXTURE FINISH

B. EXTERIOR ALUMINUM STOREFRONT SYSTEMS BASIS OF DESIGN: EFCO 403 (EXT) SERIES EXTERIOR STOREFRONT FRAMING SYSTEM WITH GLAZING, SEE

SPECIFICATIONS SECTION 084113 C. UNITIZED PRE-GLAZED CURTAIN WALL ALUMINUM STOREFRONT SYSTEMS BASIS OF DESIGN: EFCO SERIES 5600PG PRE-GLAZED CURTAIN WALL 7-1/2"

SYSTEM WITH GLAZING, SEE SPECIFICATIONS SECTION 084413

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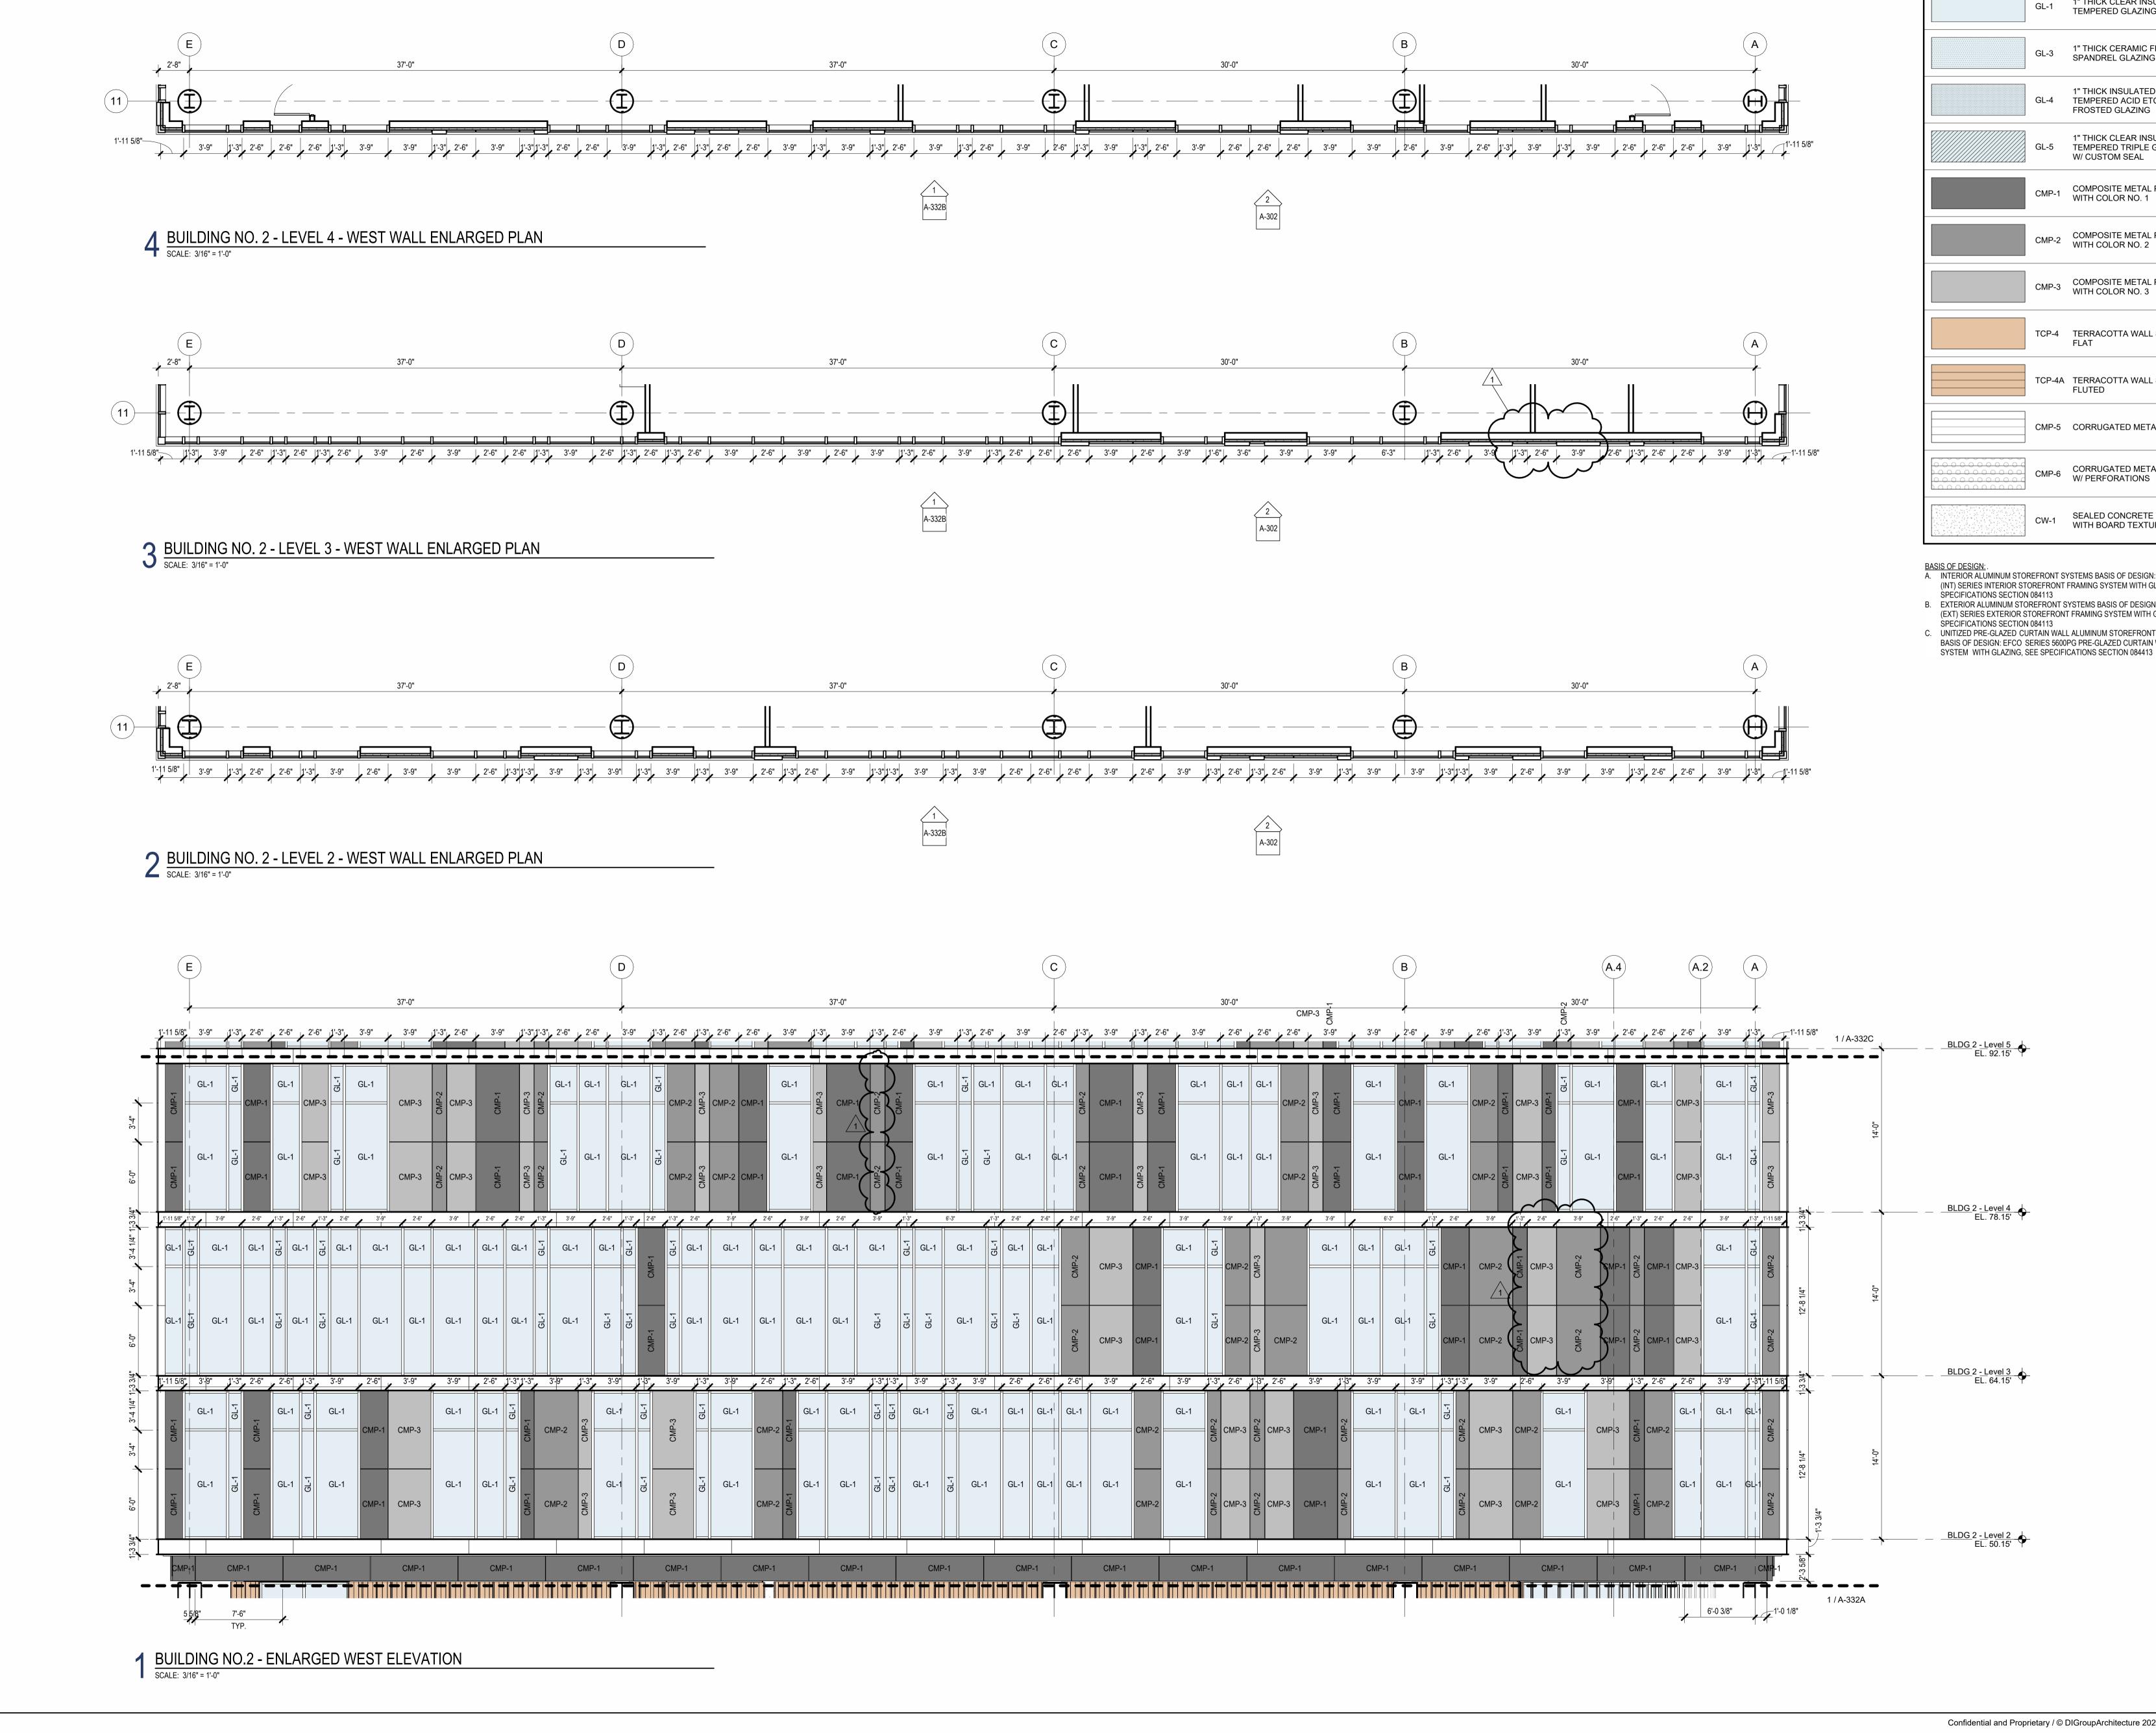
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SERV.) PROJECT NORTH TRUE NORTH



															$\left( \mathbf{C} \right)$													В	
							37'-0"									•						30'-0"			CMP-3	MP-1			
.'-3"	2'-6"	1'-3"	2'-6"	2'-6"	3'-9"	1'-3"	3'-9"	1'-3", 2	2'-6"	3'-9"		'-3" 2'	-6"	3'-9"		2'-6" 1'-3	3'-9"	1'-	-3" 2'-6	5" 3'-9	9"	2'-6"	2'-6	5" 2'-6		5 3'-9"	3'-9"	2'-6"	
GL-1	CMP-2	CMP-3	CMP-2 C		GL-1	CMP-3	CMP-1	CMP-2	CMP-1	GL-1		GE-1	L-1	GL-^		CMP-2	CMP-		CMP-3 CMP-1	GL	-1	GL-1	GL-	-1 CMF	CMP-3	CMP-1	GL-1		
GL-1	CMP-2	CMP-3	CMP-2 C		GL-1	CMP-3	CMP-1	$\sum$	CMP-1	GL-1	ā	GL-1	GL-1	GL-´			CMP-'	1	CMP-3 CMP-1	GL	-1	GL-1	GL-		CMP-3	CMP-1	GL-1	CMP-1	1 1
, 	1'-3"	2'-6"	3'-9"	2'-6"		3'-9"	2'-6"	3'-9"	1'-3"		6'-3"		1'-3"	2'-6"	2'-6"	2'-6"	3'-9"	-4	2'-6"	3'-9"	1	3'-9"	1'-3"	3'-9"		3'-9"		6'-3"	/ <sup>1'-3"</sup> /
	GL-1	GL-1	GL-1	GL-1	G	GL-1	GL-1	GL-1	GL-1	GL-1	GI	L-1	GL-1	GL-1	GL-1	CMP-2	CMP-3	3 0	MP-1	GL-1	GL-1	= CMP-2	IP-3			GL-1	GL-1	GL-1	GL-1
	OL-1	GL-1	GL-1	GL-1	G	GL-1	GL-1	GL-1	GL-1	GL-1	G	L-1	GL-1	GL-1	GL-1		CMP-3		:MP-1	GL-1	3L-1			CMP-2		GL-1	GL-1	GL-1	GL-1
, 3	8'-9"	1'-3"	3'-9"	2'-6"	1'-3"	, 2'-6"	3'-9"	1'-3" 1'-:	3"	3'-9"	1'-3"	3'-9"		2'-6"	2'-6"	2'-6"	3'-9"	_/	2'-6"	, 3'-9"	1'-3"	2'-6"	1'-3"	, 2'-6"	, 3'-9"	1'-3"	3'-9"	3'-9	9"
	CMP-3	GL-1	GL-1	= CMP-2		GL-1	GL-1	GL-1		GL-1	GL-1	GL-´	1	GL-1	GL-1	GL-1	GL-1		CMP-2	GL-1	CMP-2	CMP-3	CMP-2	CMP-3	CMP-	CMP-2	GL-1	GL	-1
	CMP-3	GL-1	GL-1	CMP-2	<u> </u>	GL-1	GL-1	GL-1 GL-1		GL-1	GL-1	GL-´	1	GL-1	GL-1	GL-1	GL-1		CMP-2	GL-1	CMP-2	CMP-3	CMP-2	CMP-3	CMP-	CMP-2	GL-1	GL	-1
																					-1								
	MP-1	<b>#</b>   + <b>#</b>		CMP-1		┥╵┿╋╵╵		_1 <b>†</b>   <b>†</b>   <b>†</b>		CMF	₽-1		<b>+</b>    +		P-1	7	CMP	-1			1P-1	<b>-      </b> -		CMP-	.1 <b>*</b>   * <b>*</b>	<b>**</b>   <b>**</b>	CMP-	•	<b>+</b>
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МАТ	ERIAL	LEGEND
	GL-1	1" THICK CLEAR INSULATED TEMPERED GLAZING
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	CMP-6	CORRUGATED METAL PANEL W/ PERFORATIONS
	CW-1	SEALED CONCRETE WALL WITH BOARD TEXTURE FINISH

B. EXTERIOR ALUMINUM STOREFRONT SYSTEMS BASIS OF DESIGN: EFCO 403 (EXT) SERIES EXTERIOR STOREFRONT FRAMING SYSTEM WITH GLAZING, SEE

SPECIFICATIONS SECTION 084113 C. UNITIZED PRE-GLAZED CURTAIN WALL ALUMINUM STOREFRONT SYSTEMS BASIS OF DESIGN: EFCO SERIES 5600PG PRE-GLAZED CURTAIN WALL 7-1/2"

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Sheet No:


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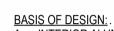
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	TCP-4A	TERRACOTTA WALL SYSTEM FLUTED
	CMP-5	CORRUGATED METAL PANEL
	CMP-6	CORRUGATED METAL PANEL W/ PERFORATIONS
	CW-1	SEALED CONCRETE WALL WITH BOARD TEXTURE FINISH



SPECIFICATIONS SECTION 084113 B. EXTERIOR ALUMINUM STOREFRONT SYSTEMS BASIS OF DESIGN: EFCO 403 (EXT) SERIES EXTERIOR STOREFRONT FRAMING SYSTEM WITH GLAZING, SEE

 (EXT) SERIES EXTERIOR STOREFRONT FRAMING SYSTEM WITH GLAZING, SEE SPECIFICATIONS SECTION 084113
 C. UNITIZED PRE-GLAZED CURTAIN WALL ALUMINUM STOREFRONT SYSTEMS BASIS OF DESIGN: EFCO SERIES 5600PG PRE-GLAZED CURTAIN WALL 7-1/2"

SYSTEM WITH GLAZING, SEE SPECIFICATIONS SECTION 084413
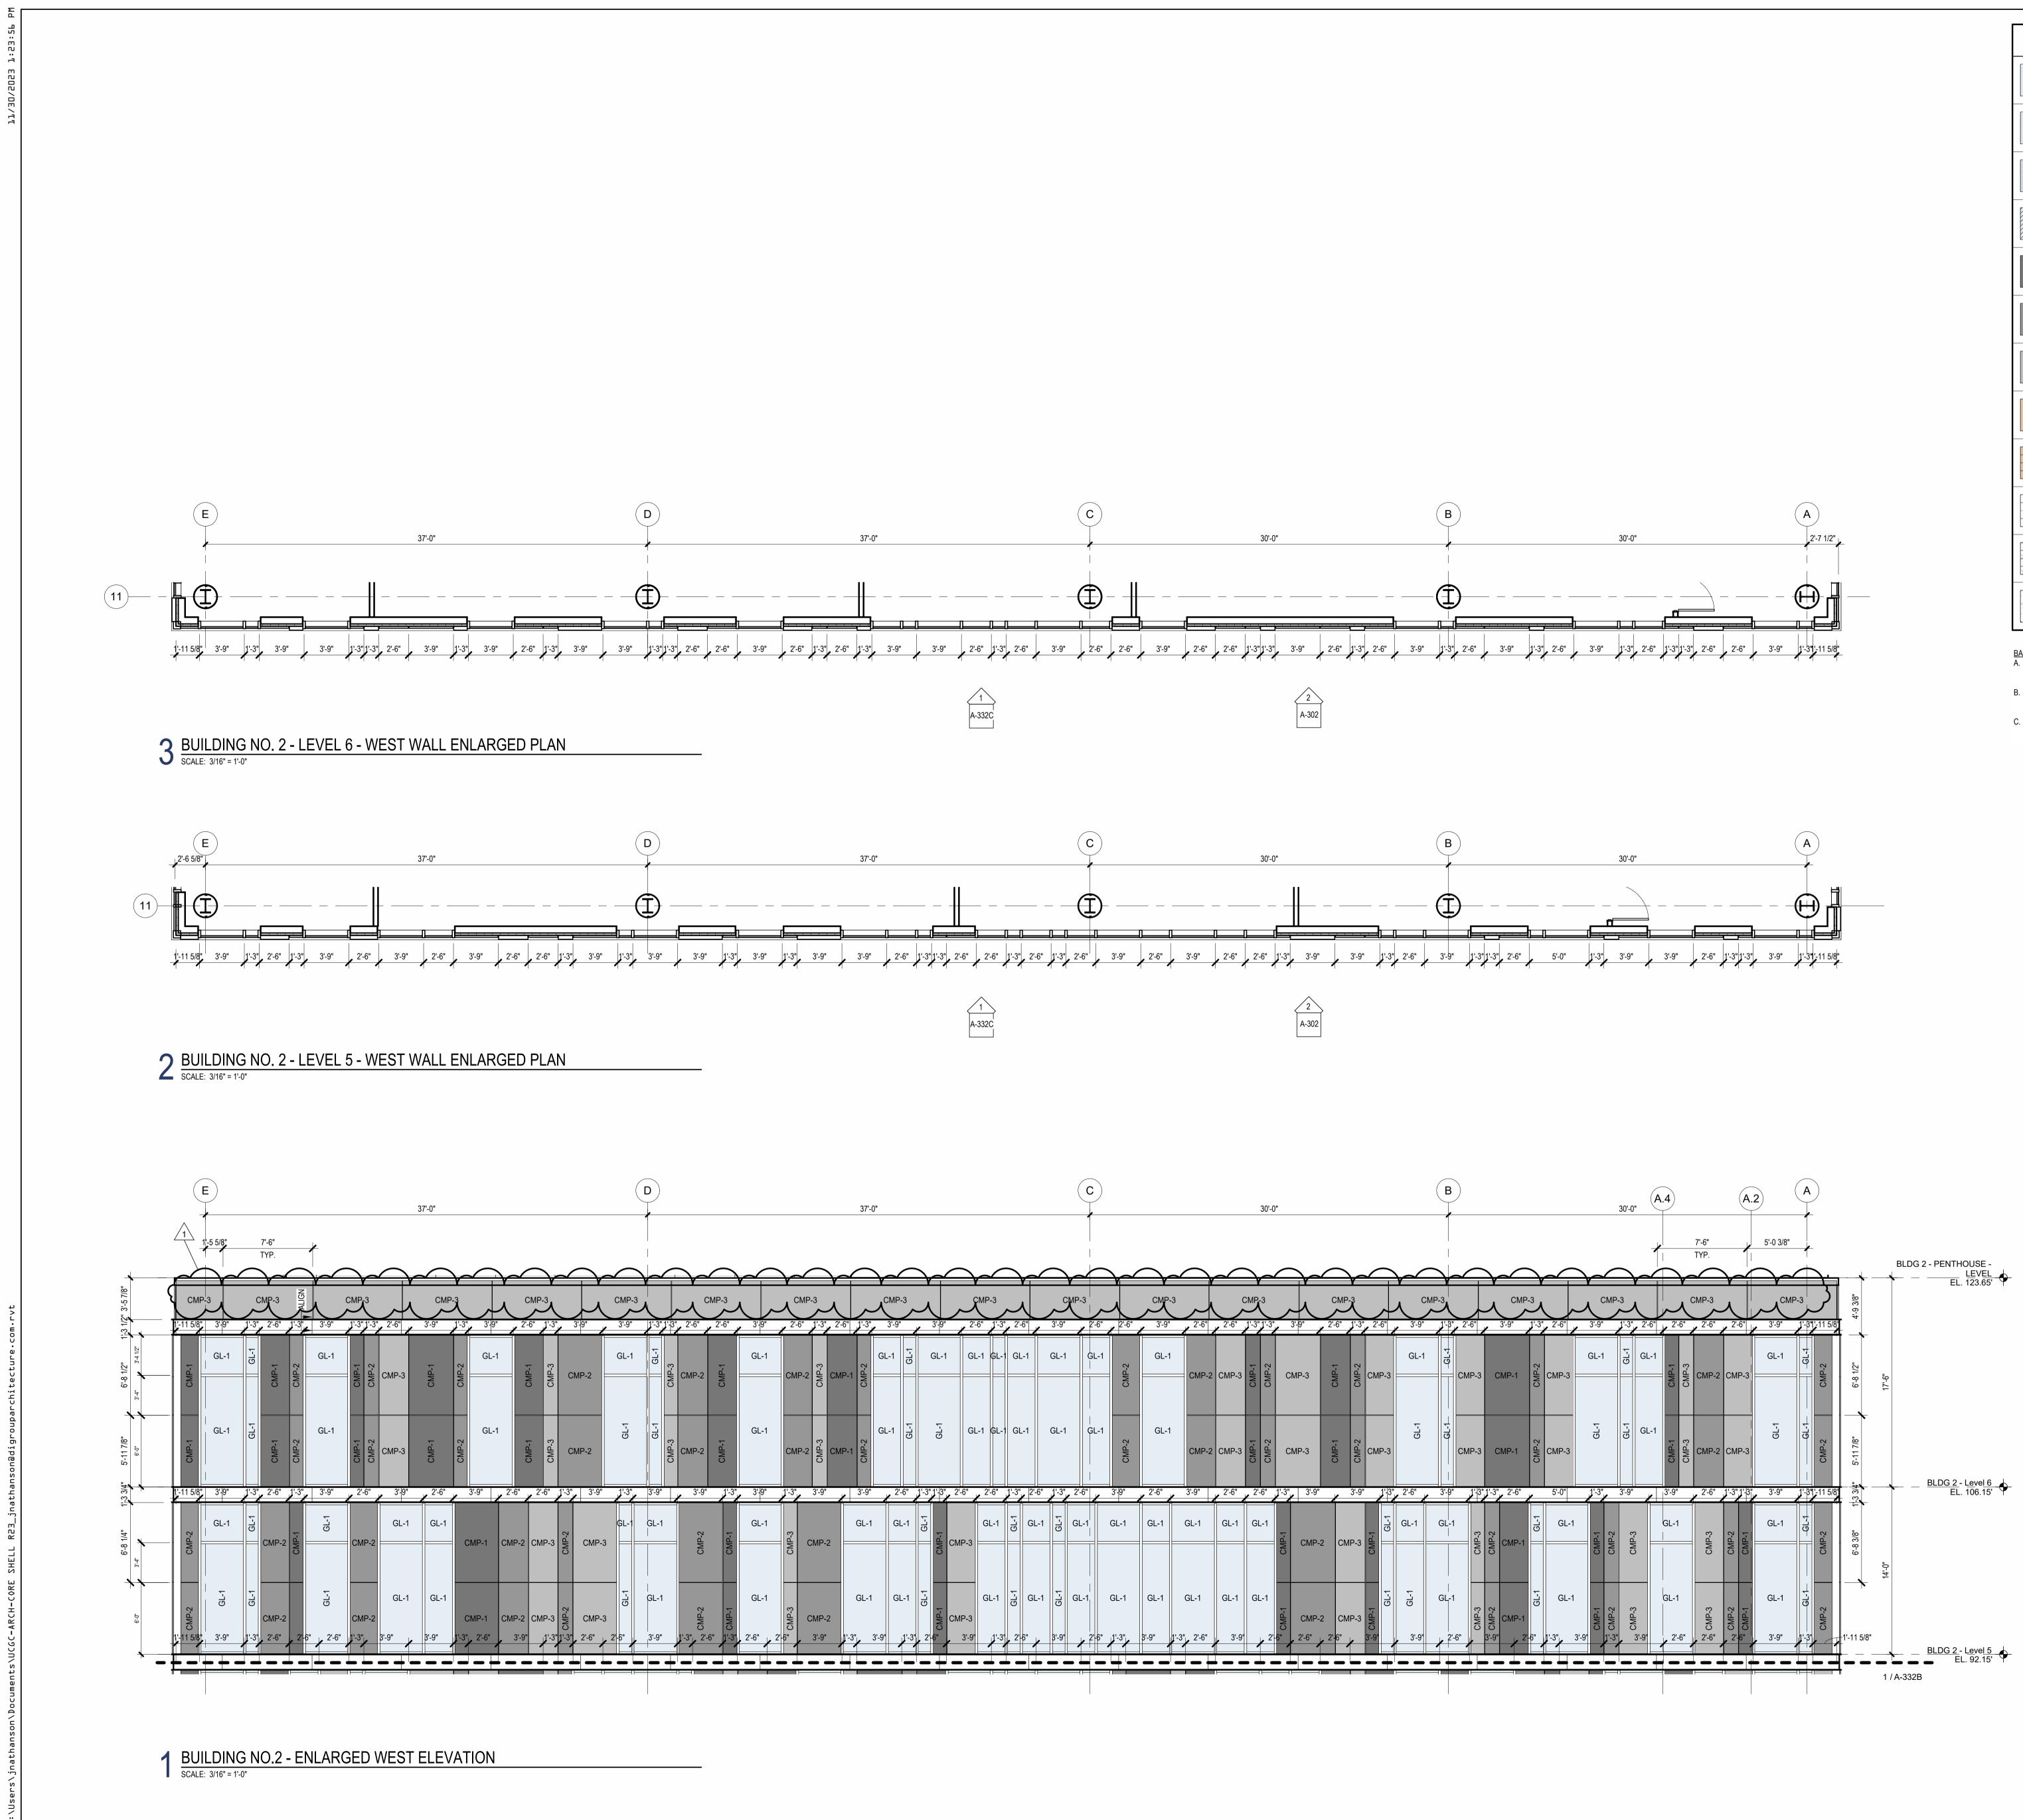
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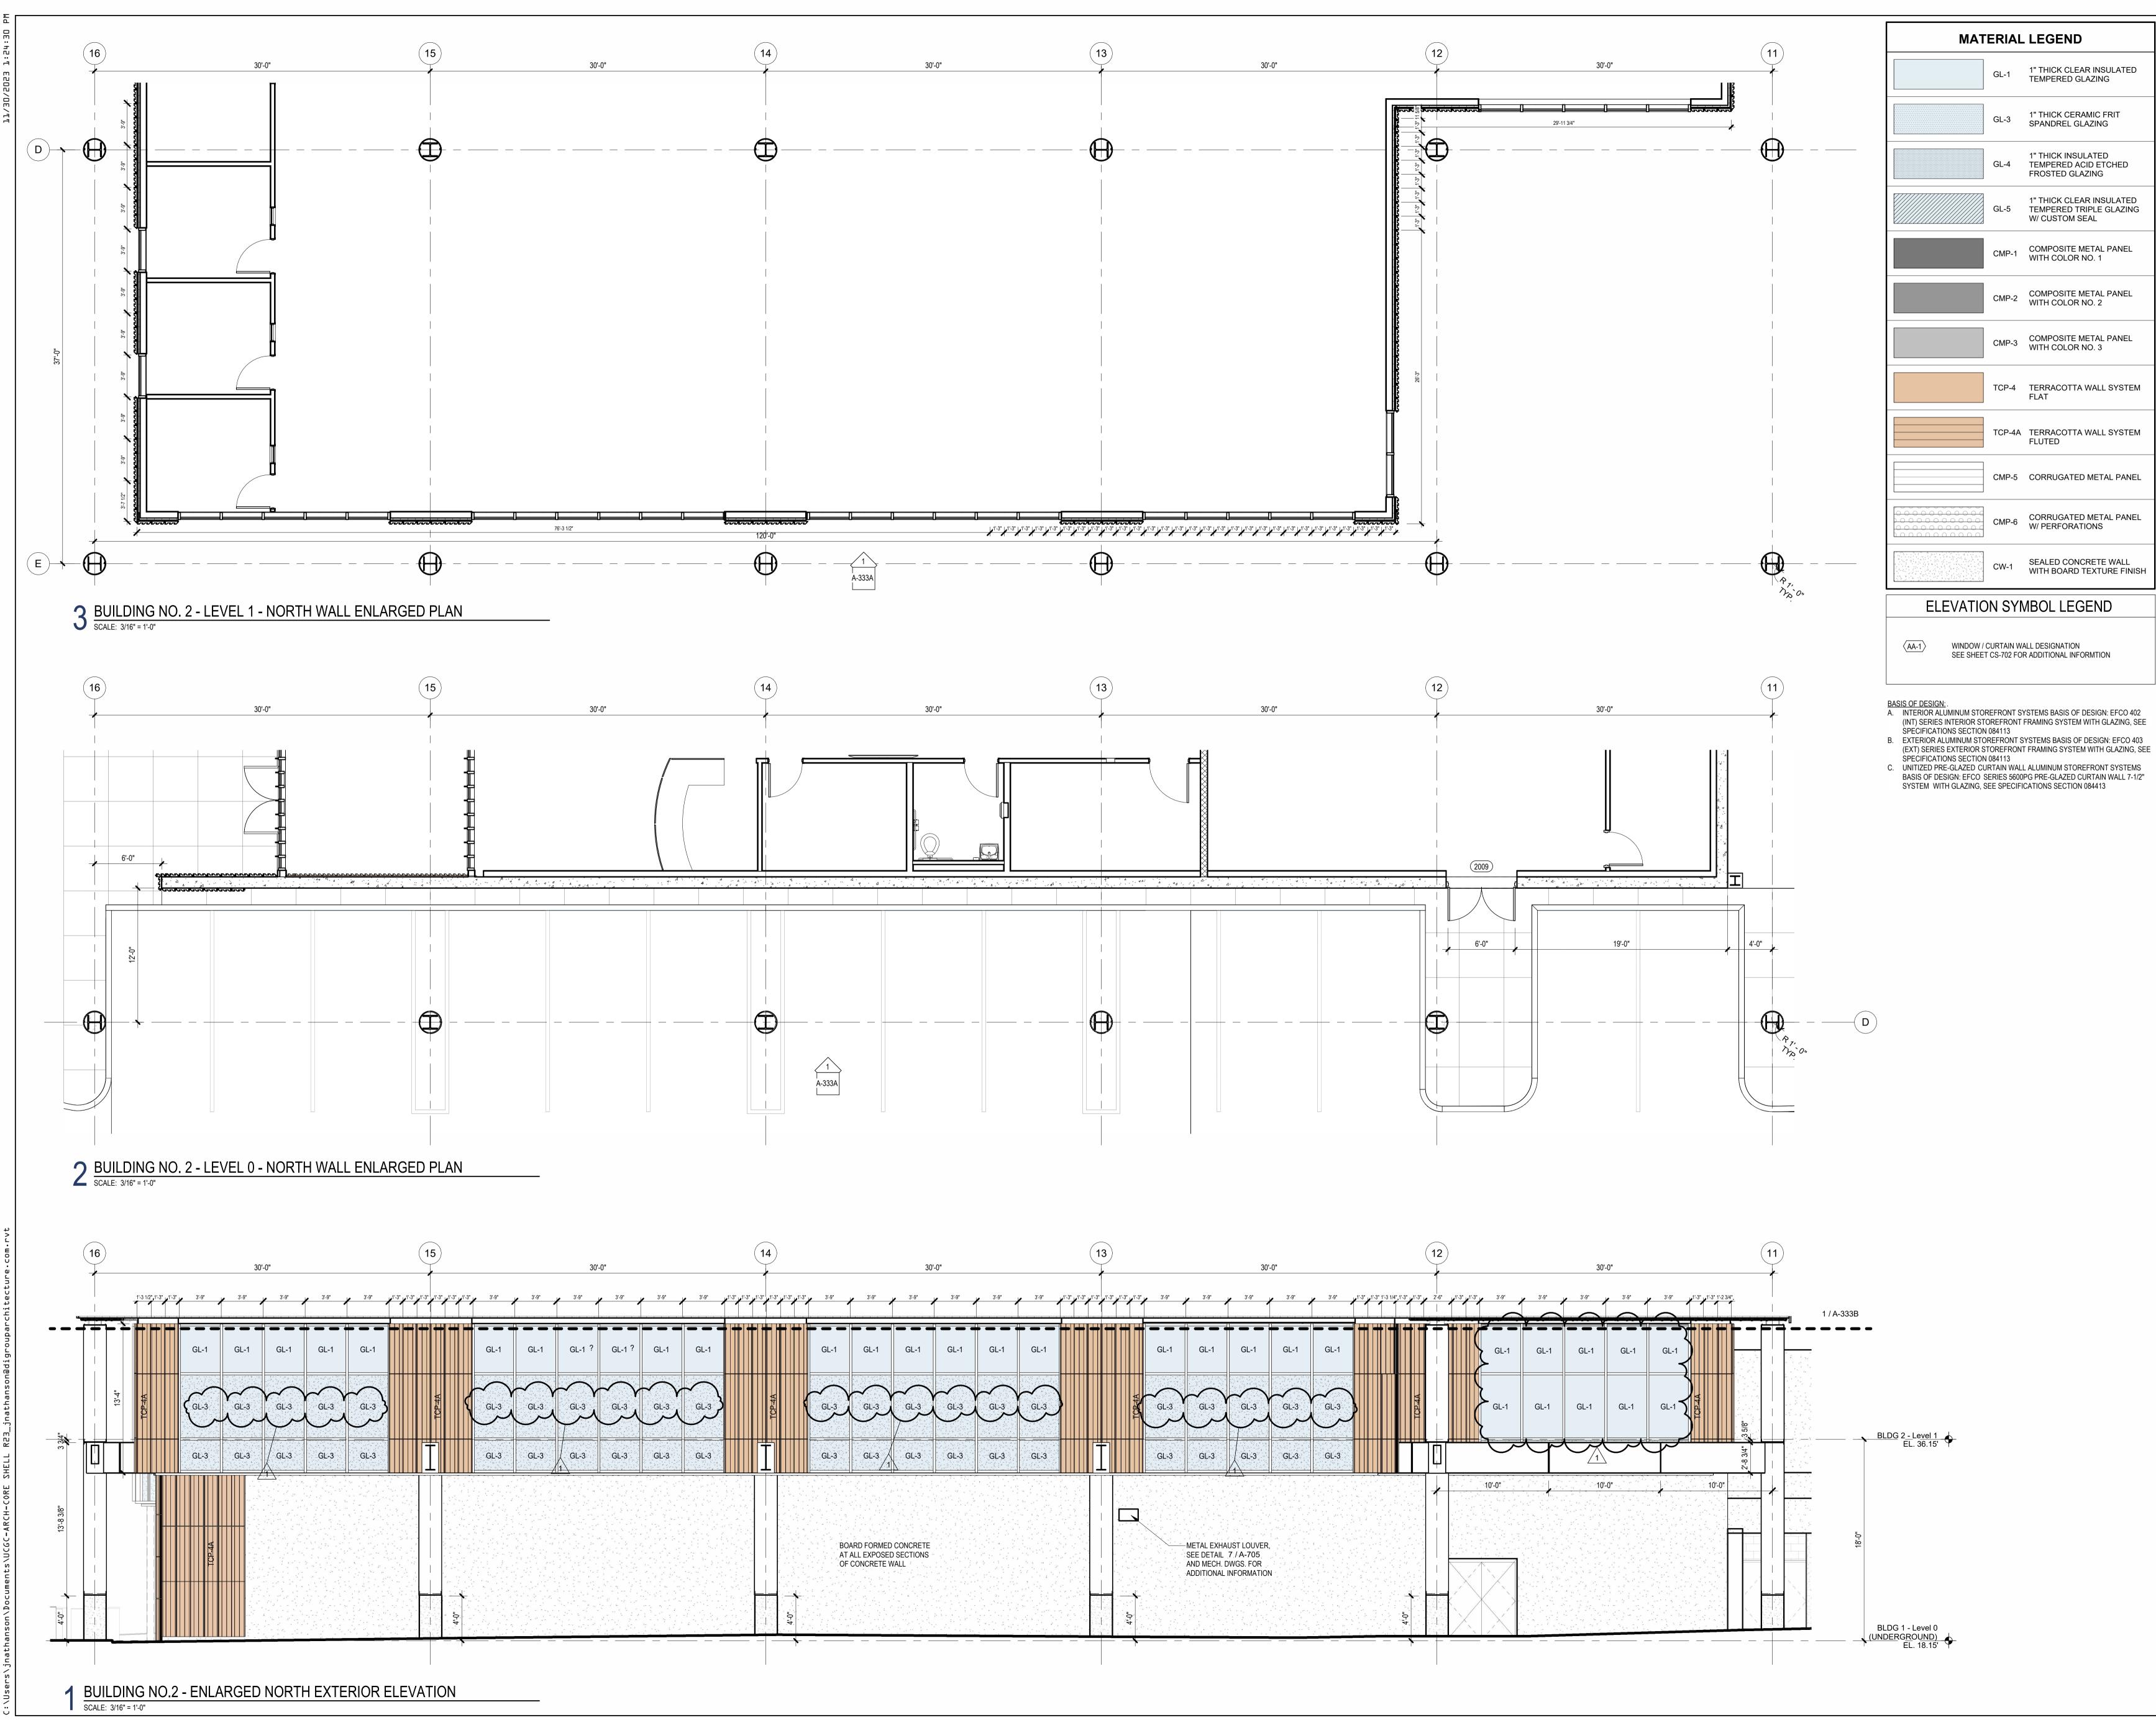
DO NOT SCALE. DRAWING MAY BE PRINTED AT REDUCED SCALE. CONSULT WITH ARCHITECT FOR DIMENSIONS.
Client:
UNION COUNTY IMPROVEMENT AUTHORITY
Project:
UNION COUNTY GOVERNMENT COMPLEX 81 & 93 WEST GRAND STREET CITY OF ELIZABETH NEW JERSEY, 07202
Drawing Information:
Project No:         20.072           Date:         11.08.2023           Drawn By:         JB / AV / PC           Checked By:         JM / SH
Sheet Name:
ENLARGED ELEVATIONS AND WALL PLANS - BUILDING NO.2 WEST
Sheet No:
A-332C

### Jeffrey D. Venezia, AIA NJ RA AI 00827100

1 12.01.2023 Addendum No. 01 11.08.2023 For Public Bid

No. Date Description Revisions / Issues DIGROUPARChitecture ARCHITECTURE FOR CHANGE 15 Bethany Street • New Brunswick, NJ 08901 • T: 732.249.6242 2450 W Hunting Park Ave • Philadelphia, PA 19122 • T: 215.634.3400

WEST GRAND ST. PROJECT NORTH TRUE NORTH



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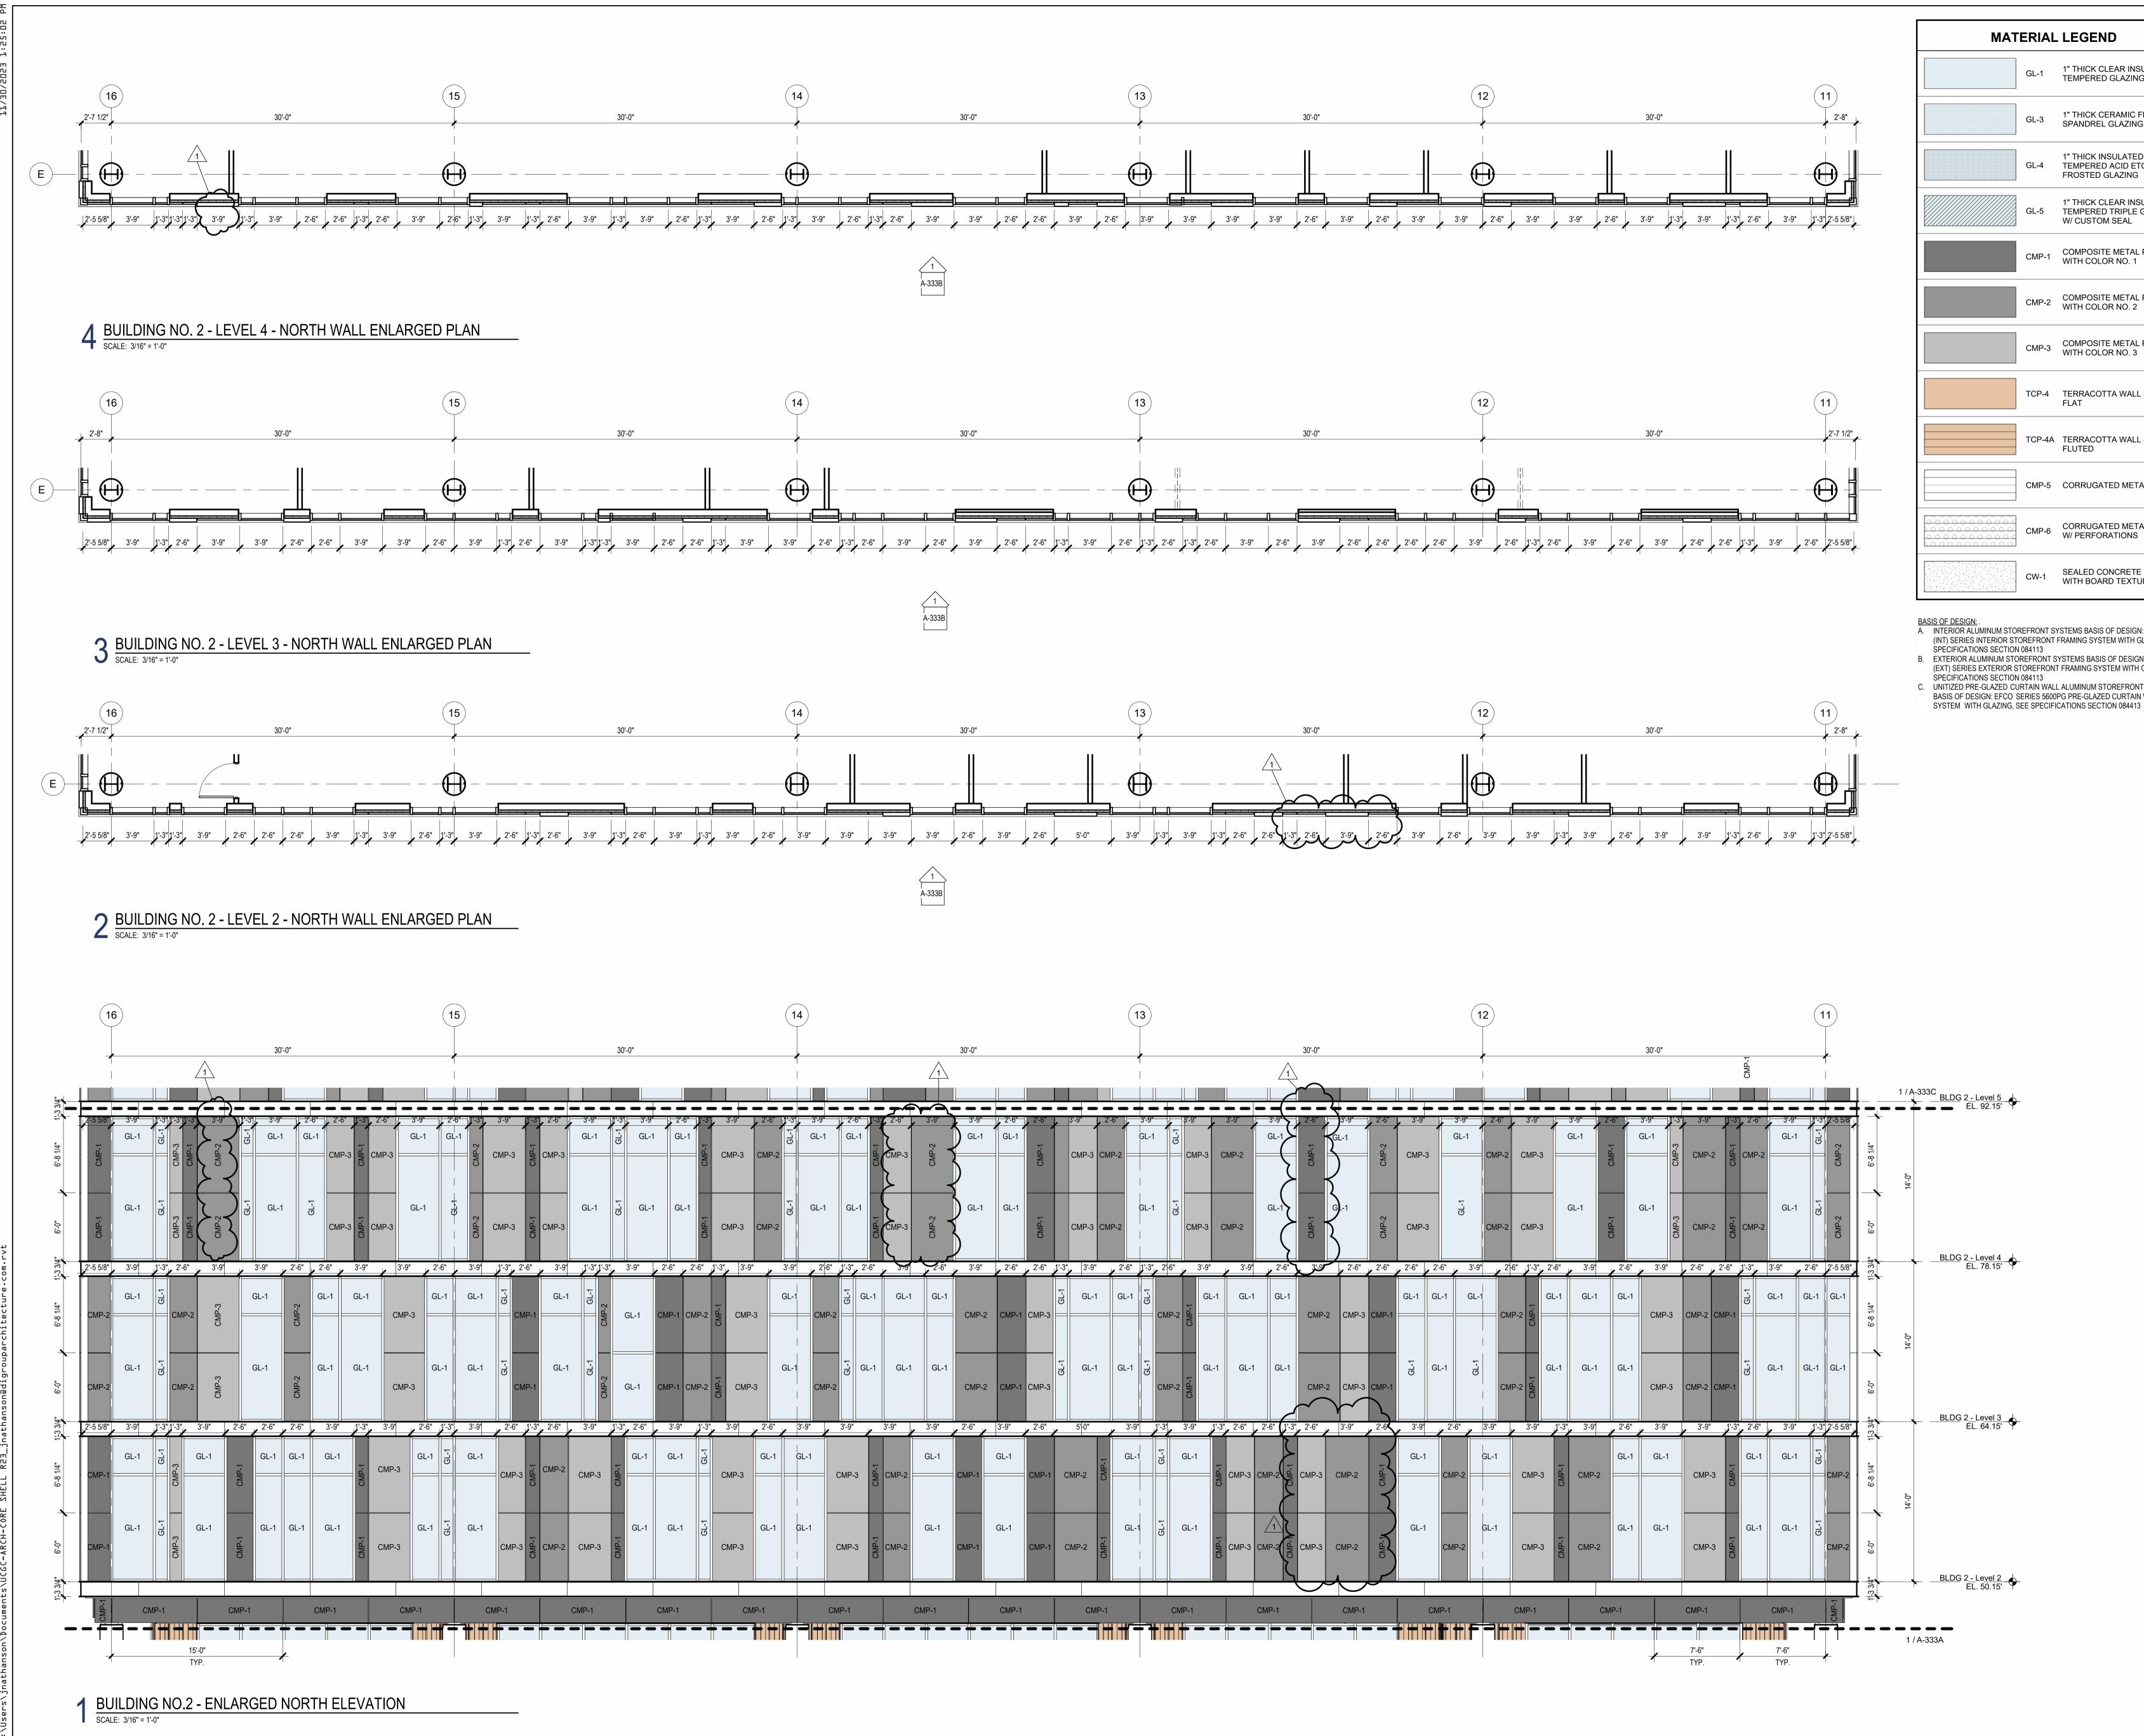
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Client:
UNION COUNTY IMPROVEMENT AUTHORITY
Project:
UNION COUNTY GOVERNMENT COMPLEX 81 & 93 WEST GRAND STREET CITY OF ELIZABETH NEW JERSEY, 07202 Drawing Information:
Project No: 20.072 Date: 11.08.2023 Drawn By: JB / AV / PC Checked By: JM / SH Sheet Name:
ENLARGED ELEVATIONS AND WALL PLANS - BUILDING NO.2 NORTH
A-333A

## Jeffrey D. Venezia, AIA NJ RA AI 00827100

1 12.01.2023 Addendum No. 01 11.08.2023 For Public Bid

No. Date Description **Revisions / Issues DIGroup**Architecture ARCHITECTURE FOR CHANGE 15 Bethany Street • New Brunswick, NJ 08901 • T: 732.249.6242 2450 W Hunting Park Ave • Philadelphia, PA 19122 • T: 215.634.3400

PROJECT NORTH TRUE NORTH



МАТ	ERIAL	LEGEND
	GL-1	1" THICK CLEAR INSULATED TEMPERED GLAZING
	GL-3	1" THICK CERAMIC FRIT SPANDREL GLAZING
	GL-4	1" THICK INSULATED TEMPERED ACID ETCHED FROSTED GLAZING
	GL-5	1" THICK CLEAR INSULATED TEMPERED TRIPLE GLAZING W/ CUSTOM SEAL
	CMP-1	COMPOSITE METAL PANEL WITH COLOR NO. 1
	CMP-2	COMPOSITE METAL PANEL WITH COLOR NO. 2
	CMP-3	COMPOSITE METAL PANEL WITH COLOR NO. 3
	TCP-4	TERRACOTTA WALL SYSTEM FLAT
	TCP-4A	TERRACOTTA WALL SYSTEM FLUTED
	CMP-5	CORRUGATED METAL PANEL
	CMP-6	CORRUGATED METAL PANEL W/ PERFORATIONS
	CW-1	SEALED CONCRETE WALL WITH BOARD TEXTURE FINISH

B. EXTERIOR ALUMINUM STOREFRONT SYSTEMS BASIS OF DESIGN: EFCO 403 (EXT) SERIES EXTERIOR STOREFRONT FRAMING SYSTEM WITH GLAZING, SEE

SPECIFICATIONS SECTION 084113 C. UNITIZED PRE-GLAZED CURTAIN WALL ALUMINUM STOREFRONT SYSTEMS BASIS OF DESIGN: EFCO SERIES 5600PG PRE-GLAZED CURTAIN WALL 7-1/2"

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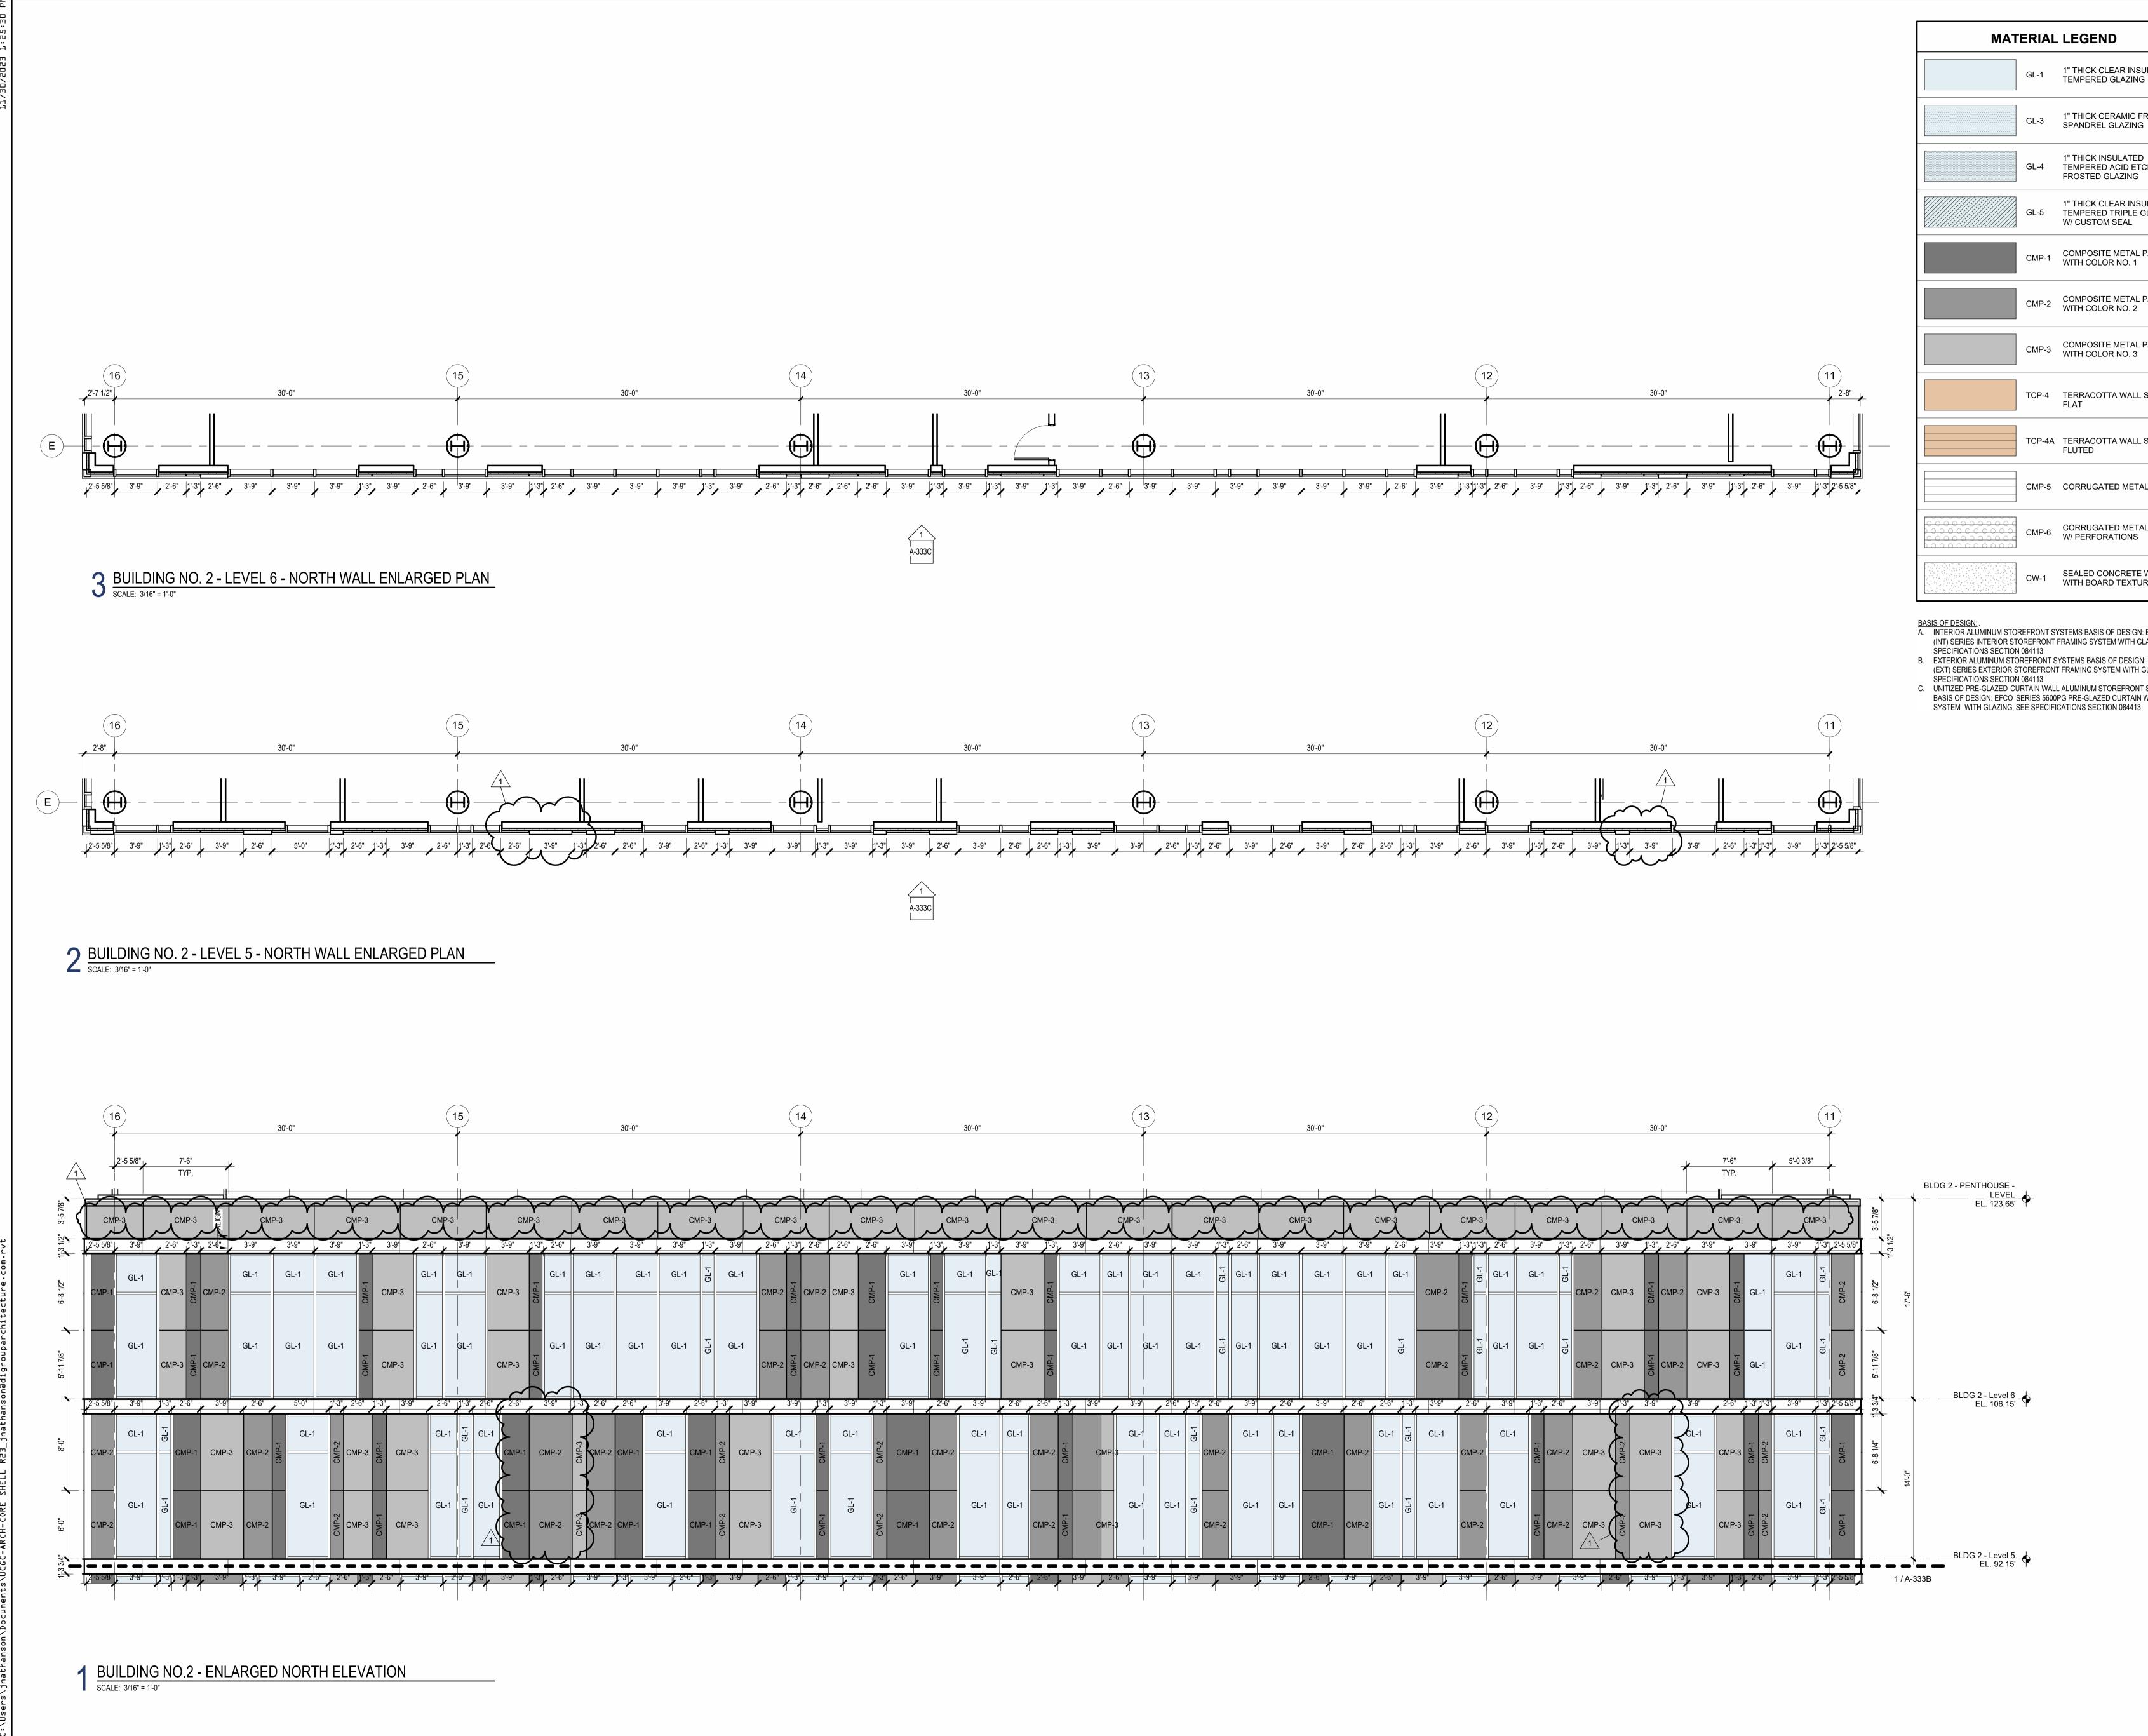
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Client:
UNION COUNTY IMPROVEMENT AUTHORITY
Project:
UNION COUNTY GOVERNMENT COMPLEX 81 & 93 WEST GRAND STREET CITY OF ELIZABETH NEW JERSEY, 07202
Drawing Information:
Project No:         20.072           Date:         11.08.2023           Drawn By:         JB / AV / PC           Checked By:         JM / SH
Sheet Name:
ENLARGED ELEVATIONS AND WALL PLANS - BUILDING NO.2 NORTH
A-333B

## Jeffrey D. Venezia, AIA NJ RA AI 00827100

1 12.01.2023 Addendum No. 0 11.08.2023 For Public Bid


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KEY PLAN: PROJECT NORTH TRUE NORT



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L-1		GL-1	GL-1	CMP-2	P-1	CMP-2	CMP-3	CMP-1	GL-1	CMP-1	GL-1	GL-1	CMP-	CMP-1	GL	1 G	iL-1	GL-1	1	GL-1	GL-1	GL-1	GL-1	GL-1	GL-1	GL	1	CMP-2
					CN		CMP-3	CN		CC				CN														
L-1		GL-1	GL-1	CMP-2	CMP-1	CMP-2	CMP-3	CMP-1	GL-1	CMP-1	GL-1	GL-1	CMP-	CMP-1	GL	1 G	iL-1	GL-1	1	GL-1	GL-1	GL-1	GL-1	GL-1	GL-1	5		CMP-2
	2'-6		.'-3" 3'-9		3'-9	" 1'-3	3'-9"	1'-3"	3'-9"	2'-6	' 3'	-9"	2'-6"	2'-6"	1'-3"	3'-9"	3'	-9"	2'-6"	1'-3"	, 2'-6"	3'-9'	2'-6"	3'-9"	2'-6"	2'-6"	1'-3"	3'-9"
	CME			2	GL-		GL-1			CMD		<b>^</b>	GL-1			CMP		L-1	GL-1	GL-1		GL-	I GL-1				GL-1	GL-1
	CMF	- 1	CMP	-3		CMP-1		CM	CMP-1	CMP	-2			CMP-2	CM	CIVIP					CMP-2			CMP-1	CMP-2			
	CMF	P-1	CMP-2 CMD	-3	GL-1	CMP-1	GL-1	CMP-2	CMP-1	CMP		L-1	GL-1	CMP-2	CMP-1	СМР		 L-1 	GL-1	$\  \cap \ $	CMP-2	GL-	I GL-1	CMP-1	CMP-2		GL-1	GL-1
2'-(	6"	'-3"	3'-9"	2'-6"	<b>1</b> -3	3'-9	2-	-6" 1'-3"	2'-6"	3'-9"	3	-9"	2'-6"	, 2'-6"	3'-{	9" 2	-6"	<del></del>		β'-9"		3'-9"	<u> </u>	2'-6"	3'-9"	2'-6"	<b>3</b>	-9" -

МАТ	ERIAL	LEGEND
	GL-1	1" THICK CLEAR INSULATED TEMPERED GLAZING
	GL-3	1" THICK CERAMIC FRIT SPANDREL GLAZING
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	TCP-4A	TERRACOTTA WALL SYSTEM FLUTED
	CMP-5	CORRUGATED METAL PANEL
	CMP-6	CORRUGATED METAL PANEL W/ PERFORATIONS
	CW-1	SEALED CONCRETE WALL WITH BOARD TEXTURE FINISH



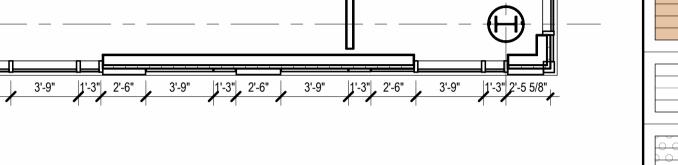

C. UNITIZED PRE-GLAZED CURTAIN WALL ALUMINUM STOREFRONT SYSTEMS BASIS OF DESIGN: EFCO SERIES 5600PG PRE-GLAZED CURTAIN WALL 7-1/2"

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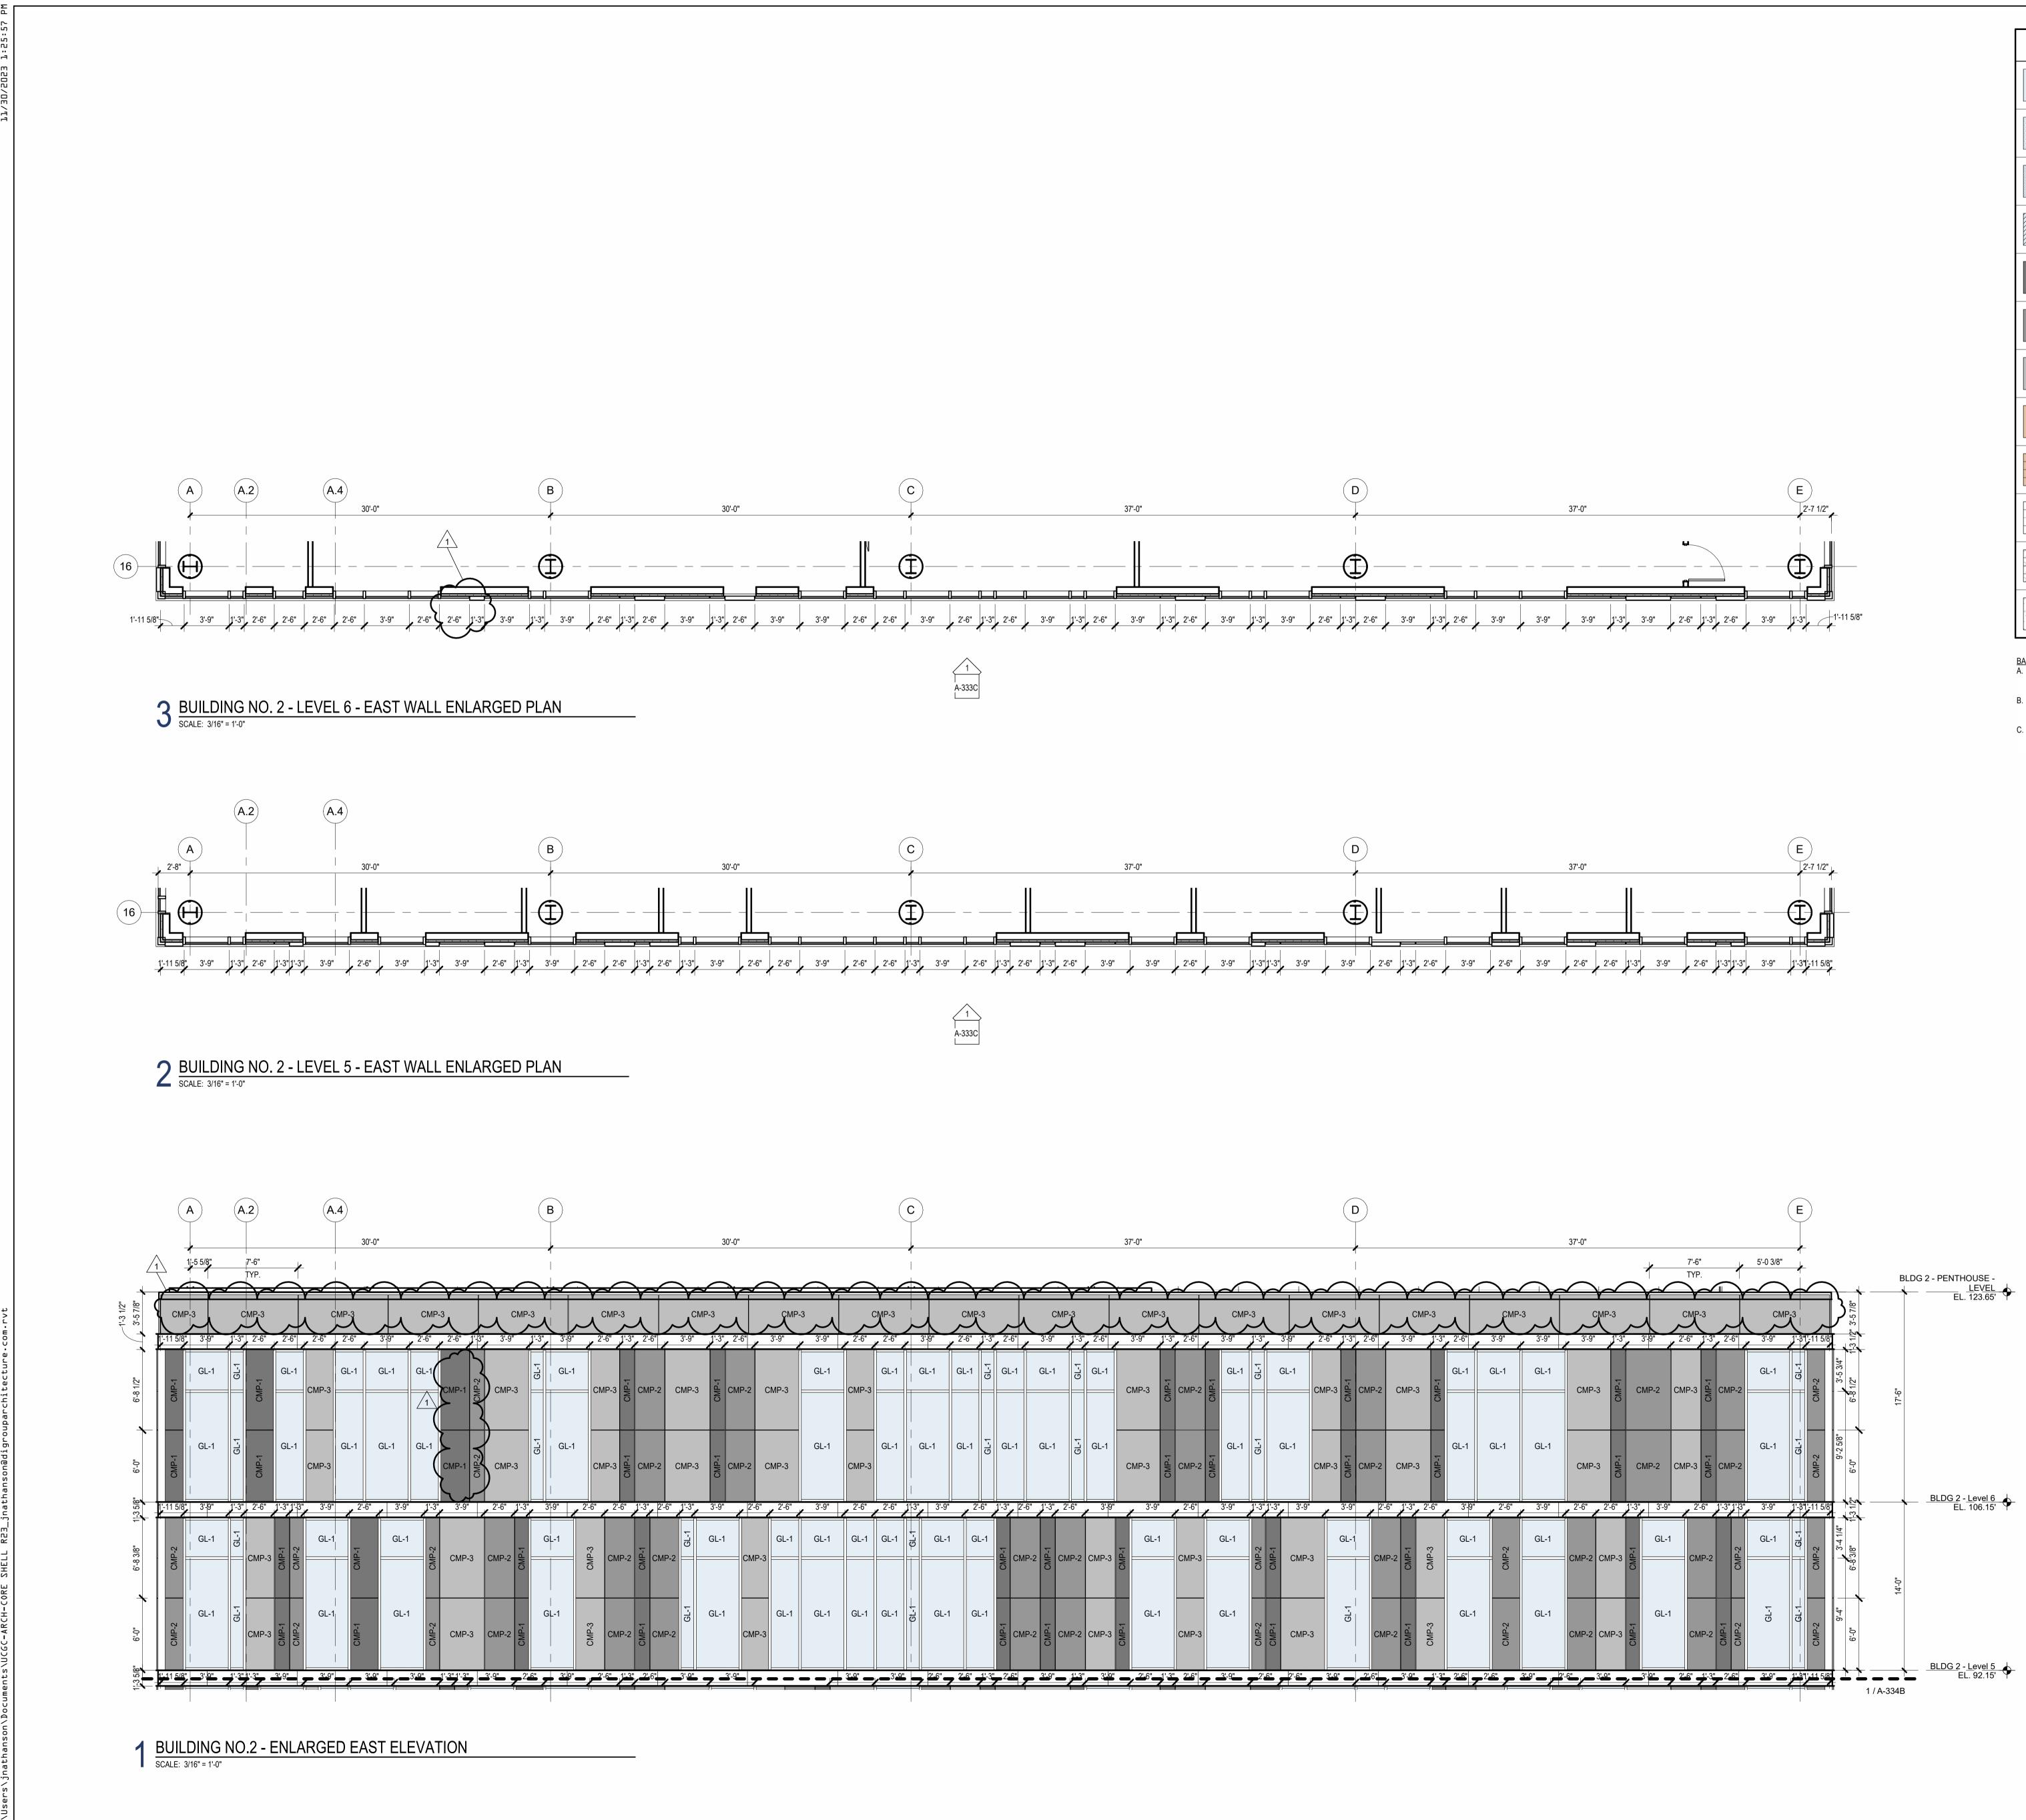
DO NOT SCALE. DRAWING MAY BE PRINTED AT REDUCED SCALE. CONSULT WITH ARCHITECT FOR DIMENSIONS. Client:
UNION COUNTY IMPROVEMENT AUTHORITY
Project:
UNION COUNTY GOVERNMENT COMPLEX 81 & 93 WEST GRAND STREET CITY OF ELIZABETH NEW JERSEY, 07202 Drawing Information: Project No: 20.072
Date: 11.08.2023 Drawn By: JB / AV / PC Checked By: JM / SH
Sheet Name:
ENLARGED ELEVATIONS AND WALL PLANS - BUILDING NO.2 NORTH
A-333C

## Jeffrey D. Venezia, AIA NJ RA AI 00827100


1 12.01.2023 Addendum No. 01 11.08.2023 For Public Bid

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PROJECT NORTH TRUE NORTH



МАТ	ERIAL	LEGEND
	GL-1	1" THICK CLEAR INSULATED TEMPERED GLAZING
	GL-3	1" THICK CERAMIC FRIT SPANDREL GLAZING
	GL-4	1" THICK INSULATED TEMPERED ACID ETCHED FROSTED GLAZING
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	CMP-6	CORRUGATED METAL PANEL W/ PERFORATIONS
	CW-1	SEALED CONCRETE WALL WITH BOARD TEXTURE FINISH

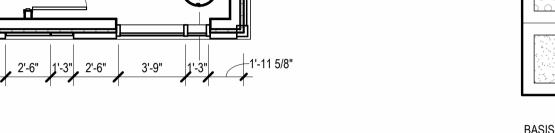

SPECIFICATIONS SECTION 084113 EXTERIOR ALUMINUM STOREFRONT SYSTEMS BASIS OF DESIGN: EFCO 403 (EXT) SERIES EXTERIOR STOREFRONT FRAMING SYSTEM WITH GLAZING, SEE

SPECIFICATIONS SECTION 084113 C. UNITIZED PRE-GLAZED CURTAIN WALL ALUMINUM STOREFRONT SYSTEMS BASIS OF DESIGN: EFCO SERIES 5600PG PRE-GLAZED CURTAIN WALL 7-1/2" SYSTEM WITH GLAZING, SEE SPECIFICATIONS SECTION 084413

A-3340	


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Client:
UNION COUNTY IMPROVEMENT AUTHORITY
Project:
UNION COUNTY GOVERNMENT COMPLEX 81 & 93 WEST GRAND STREET CITY OF ELIZABETH NEW JERSEY, 07202
Drawing Information:
Project No:         20.072           Date:         11.08.2023           Drawn By:         JB / AV / PC           Checked By:         JM / SH
Sheet Name:
ENLARGED ELEVATIONS AND WALL PLANS - BUILDING NO.2 EAST
Sheet No:


## Jeffrey D. Venezia, AIA NJ RA AI 00827100

1 12.01.2023 Addendum No. 01 11.08.2023 For Public Bid


Description No. Date Revisions / Issues **DIGroup**Architecture ARCHITECTURE FOR CHANGE 15 Bethany Street • New Brunswick, NJ 08901 • T: 732.249.6242 2450 W Hunting Park Ave • Philadelphia, PA 19122 • T: 215.634.3400


KEY PLAN: PROJECT NORTH TRUE NORTH

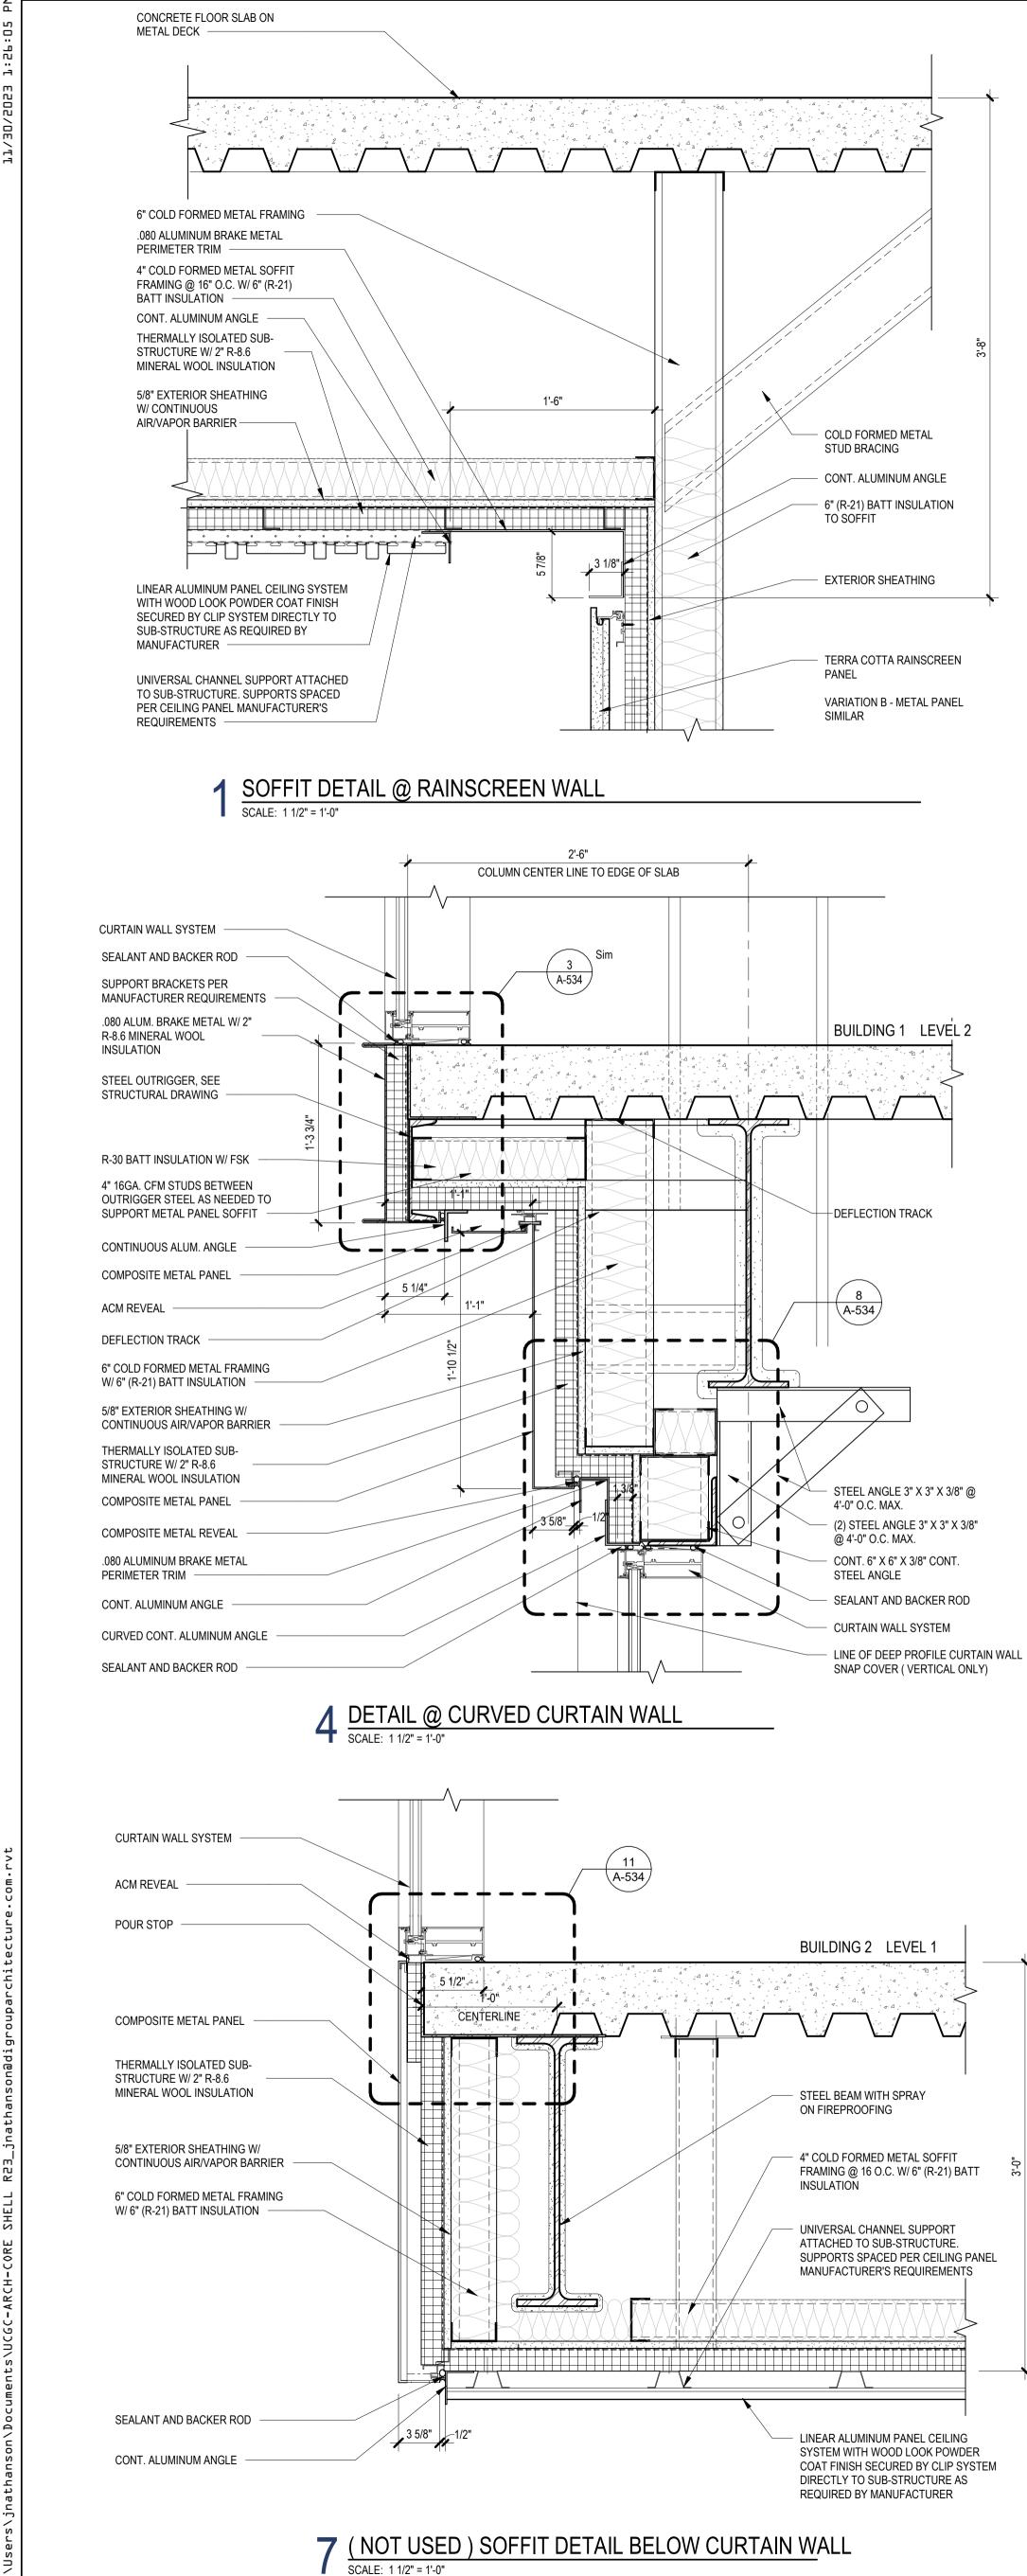


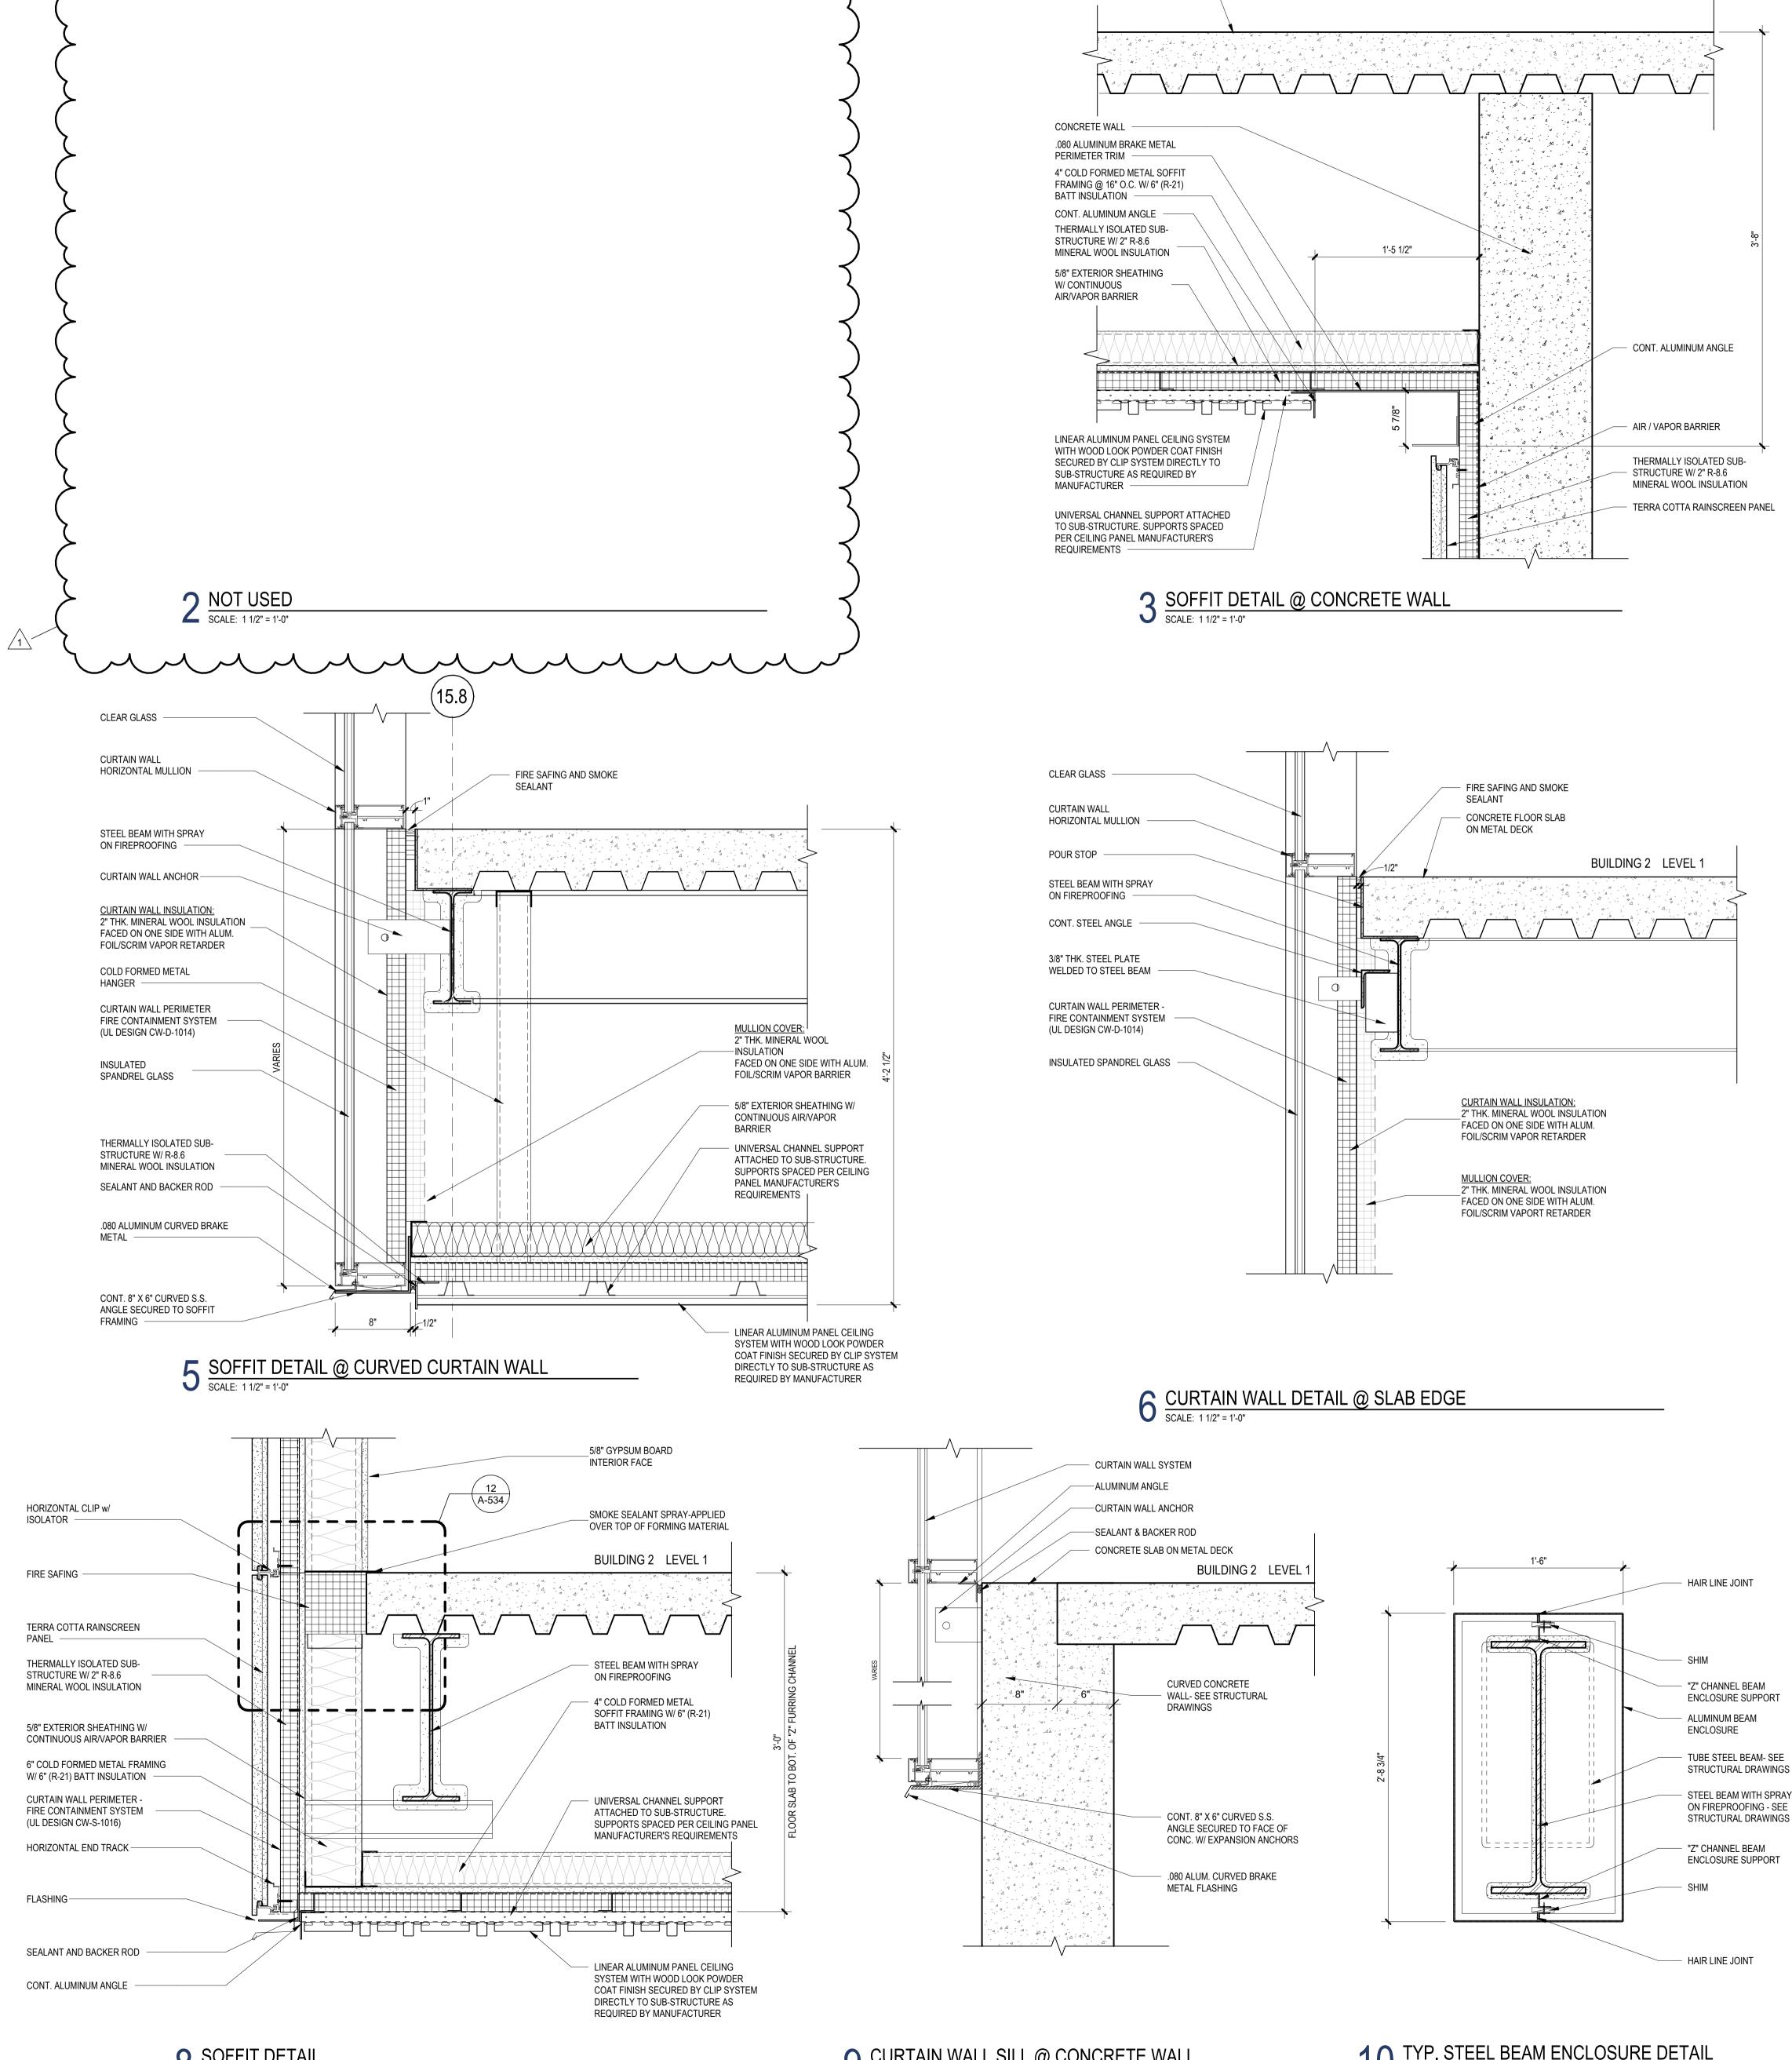

8 SOFFIT DETAIL SCALE: 1 1/2" = 1'-0"

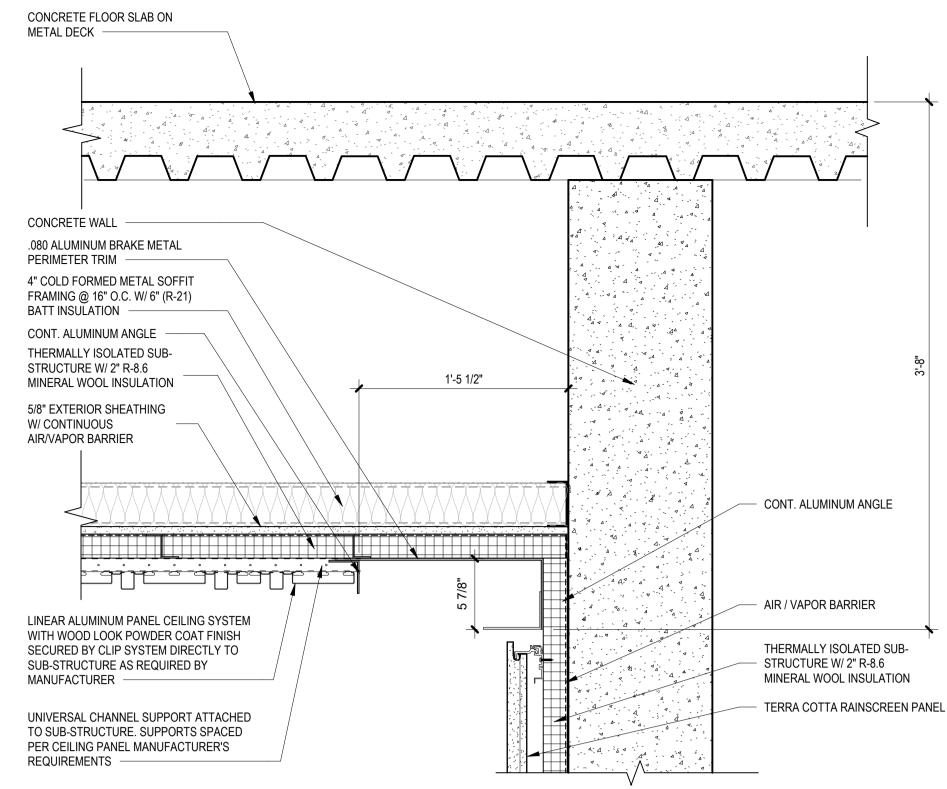

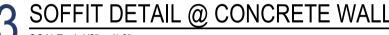

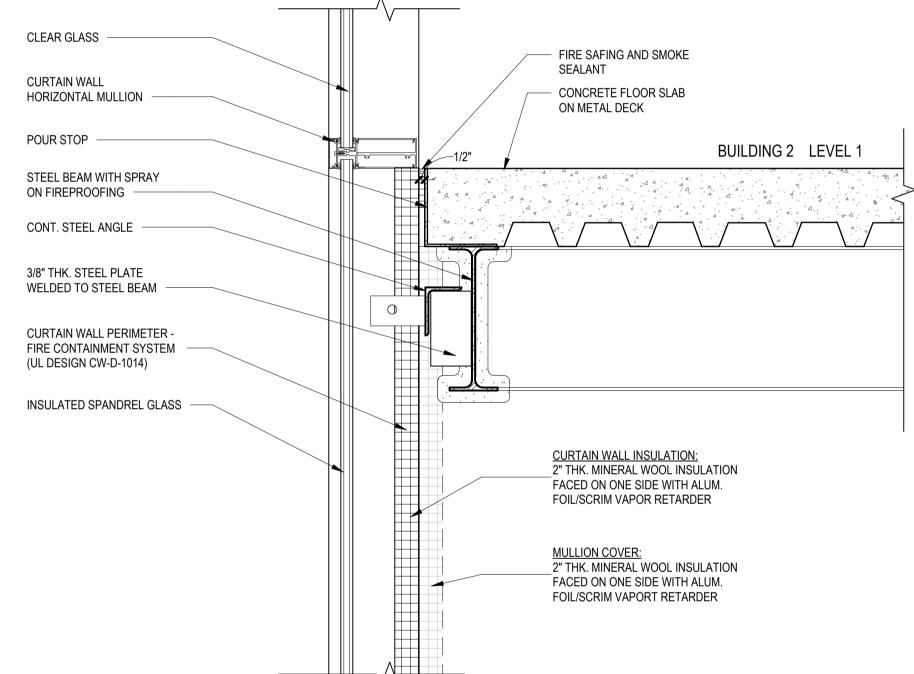

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rod	uction or other	use of these	drawings or	ideas is	prohibited.

Client:	
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CITY OF ELIZ	ZABETH
NEW JERSE	Y, 07202
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### Jeffrey D. Venezia, AIA NJ RÁ AI 00827100

No. Date


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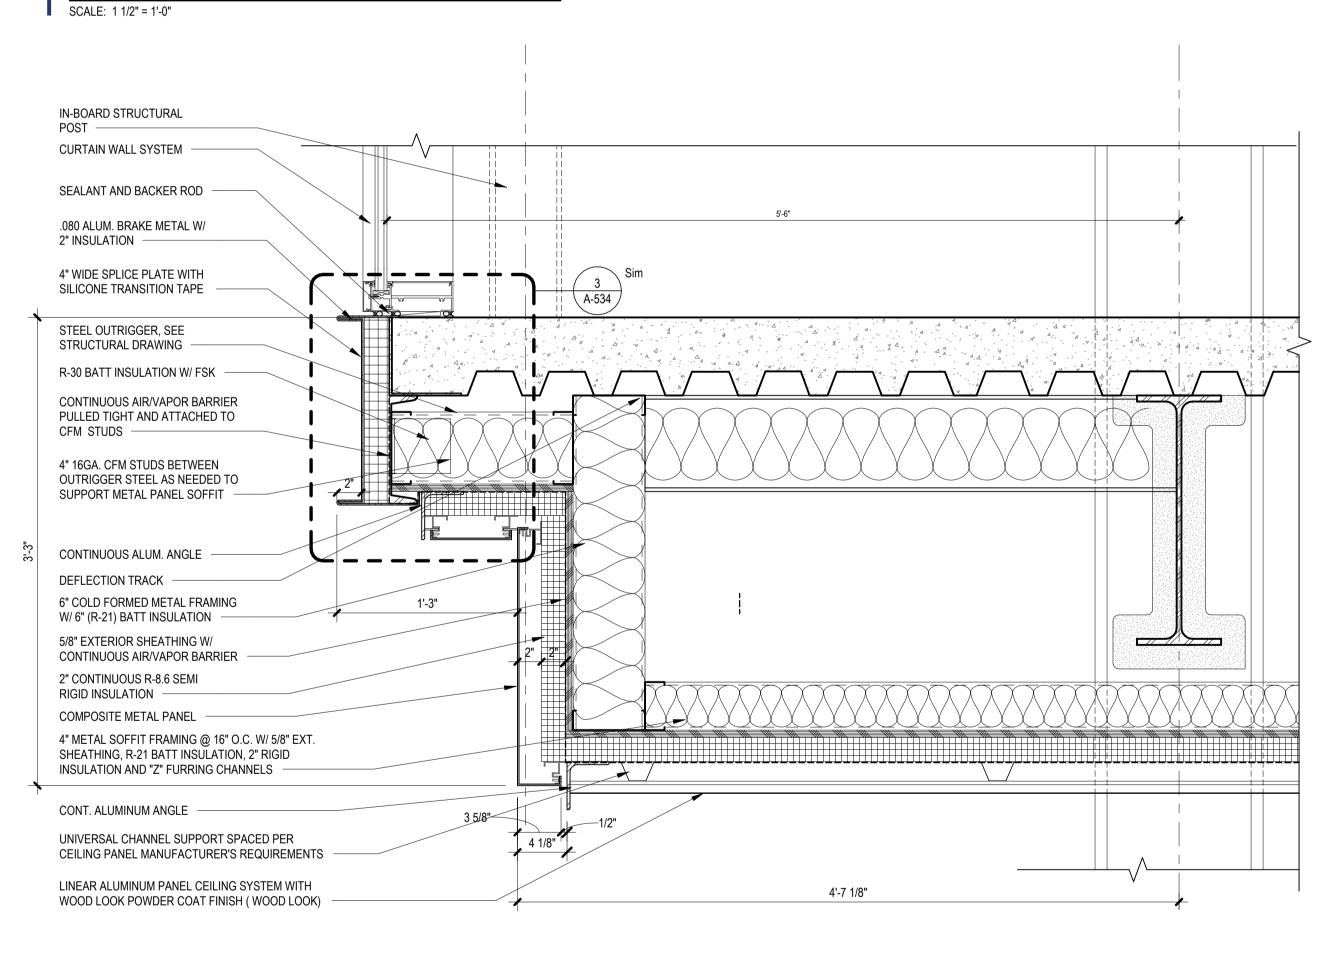
Description

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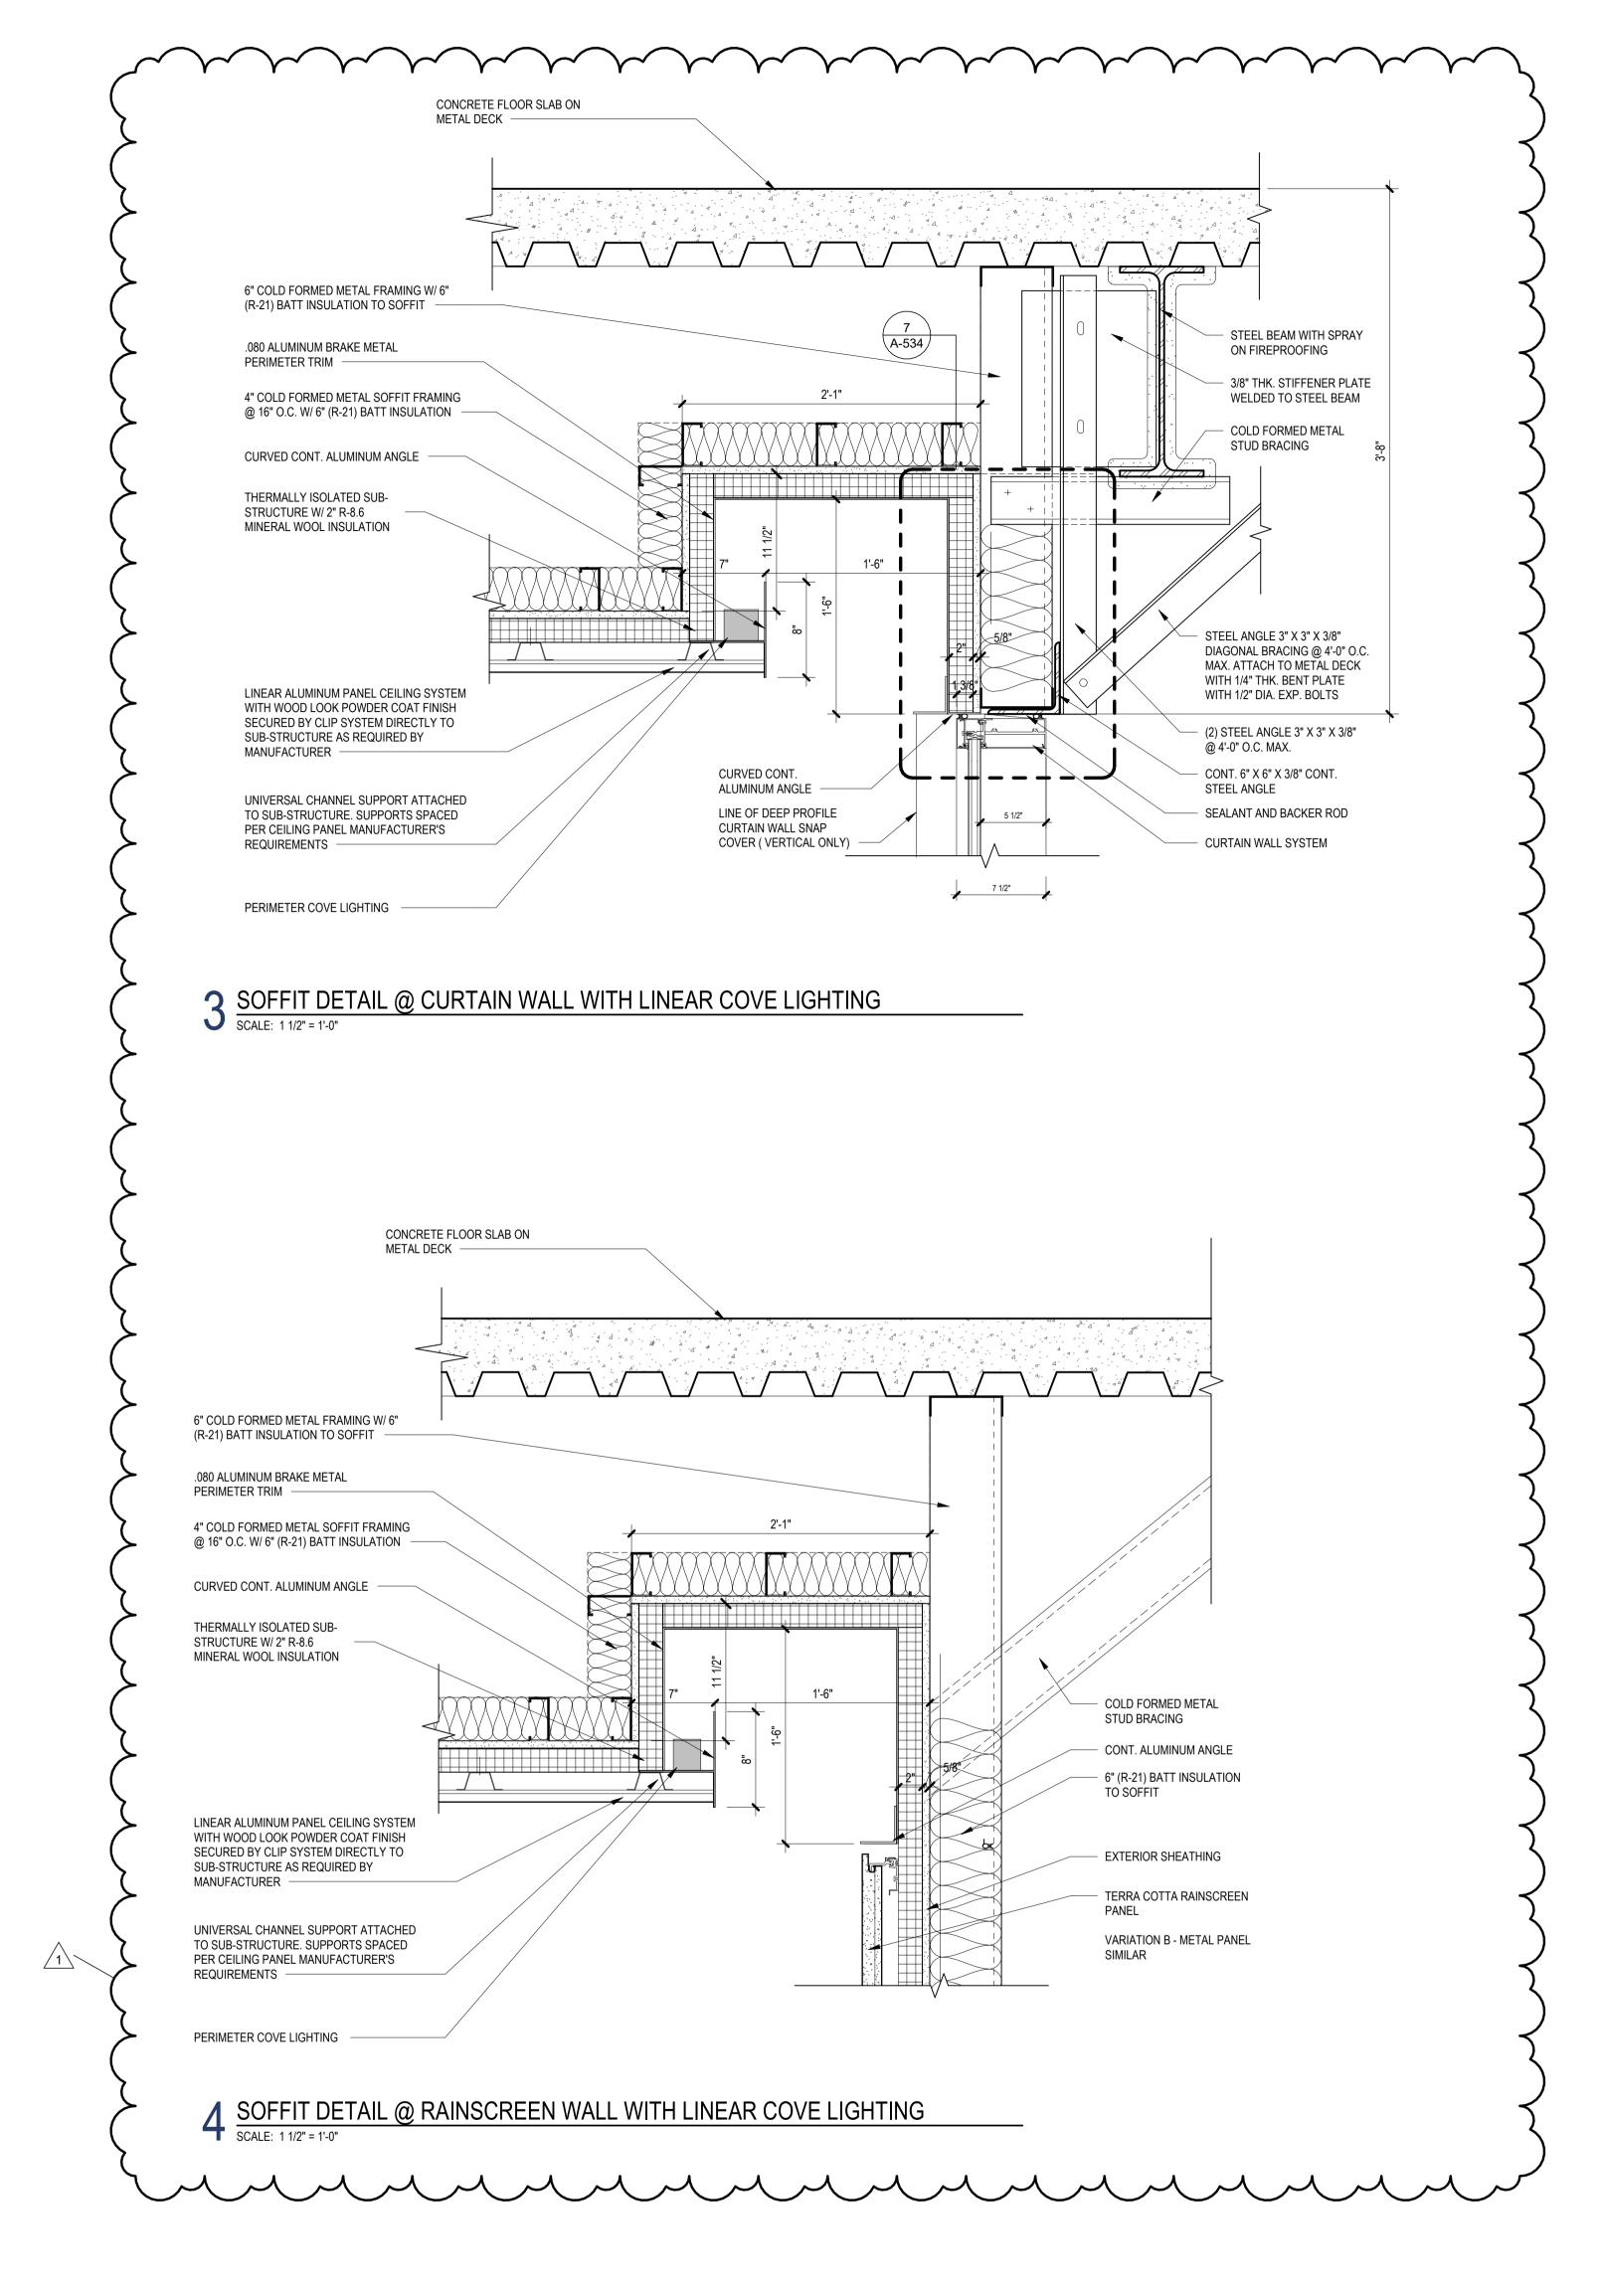
KEY PLAN: SERV.)



## SOFFIT DETAIL COMMISIONER CONFERENCE

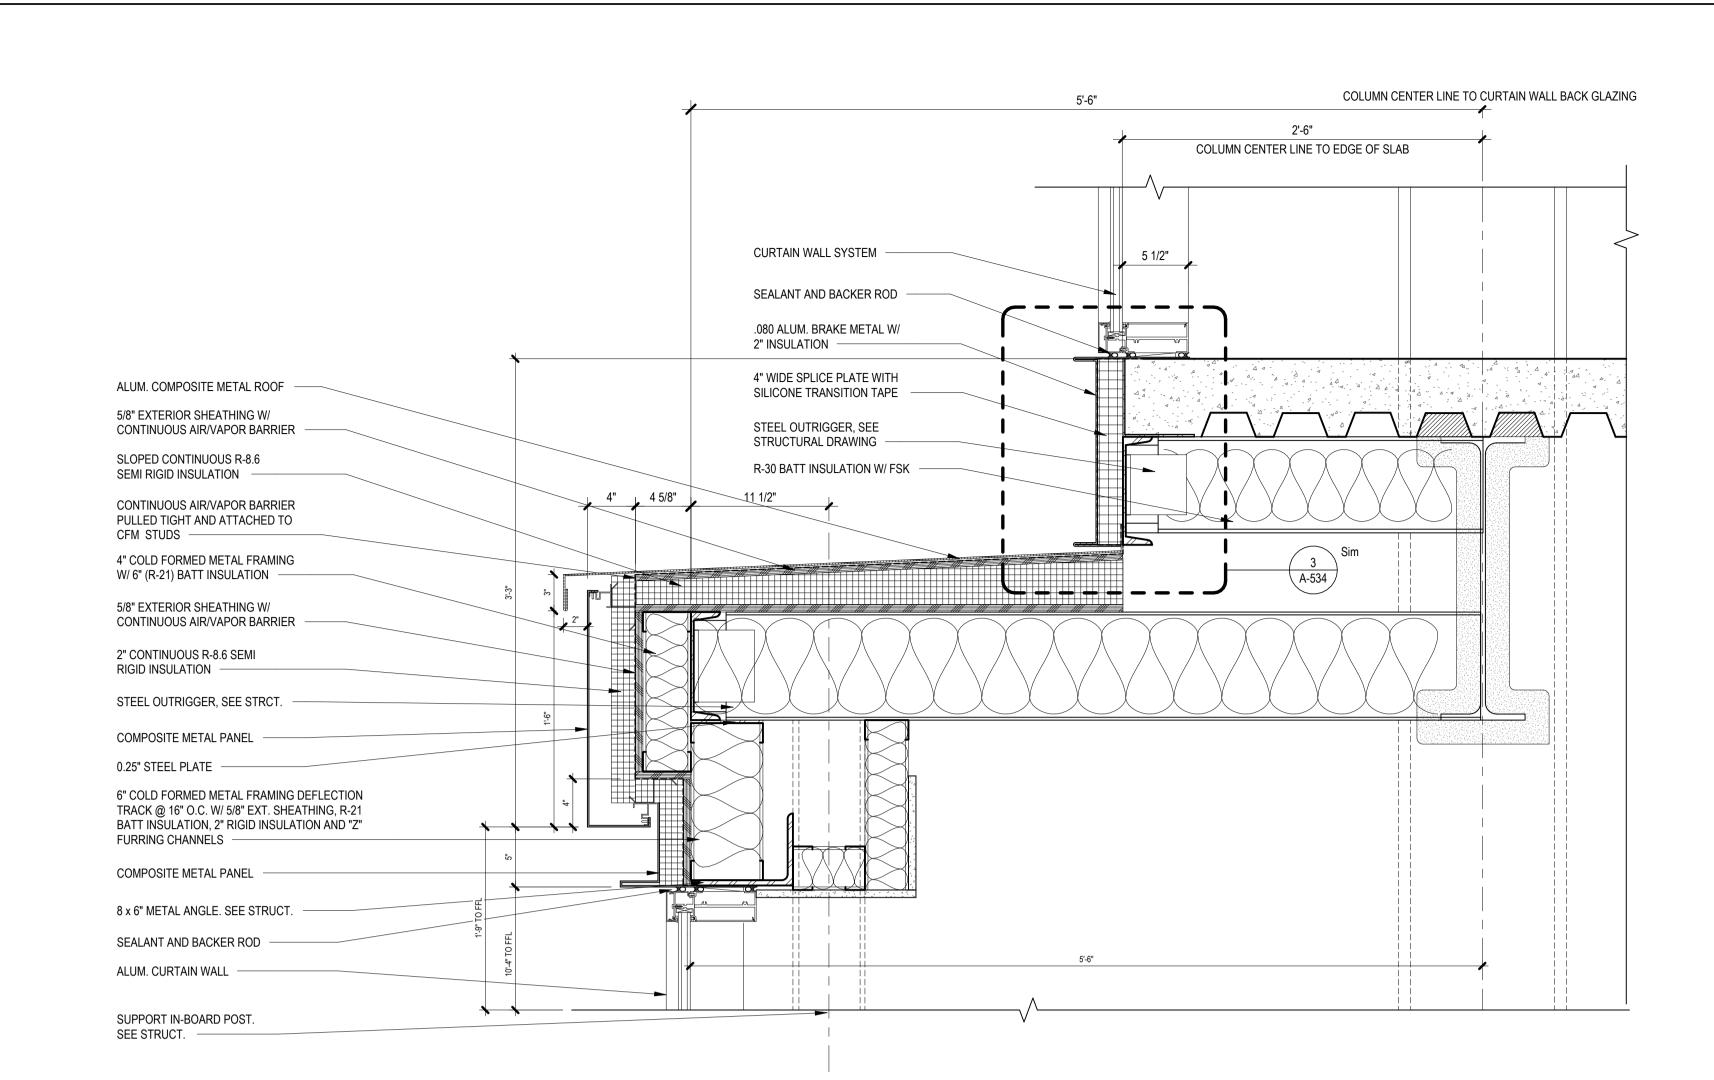

2 LOWER SOFFIT DETAIL @ COMMISIONER CONFERENCE SCALE: 1 1/2" = 1'-0"



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Drawing Inform	nation:
Project No: Date: Drawn By: Checked By:	11.08.2023 JB / AV / PC
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EXTERI DETAIL	OR WALL SECTION S

### Jeffrey D. Venezia, AIA NJ RA AI 00827100

No. Date


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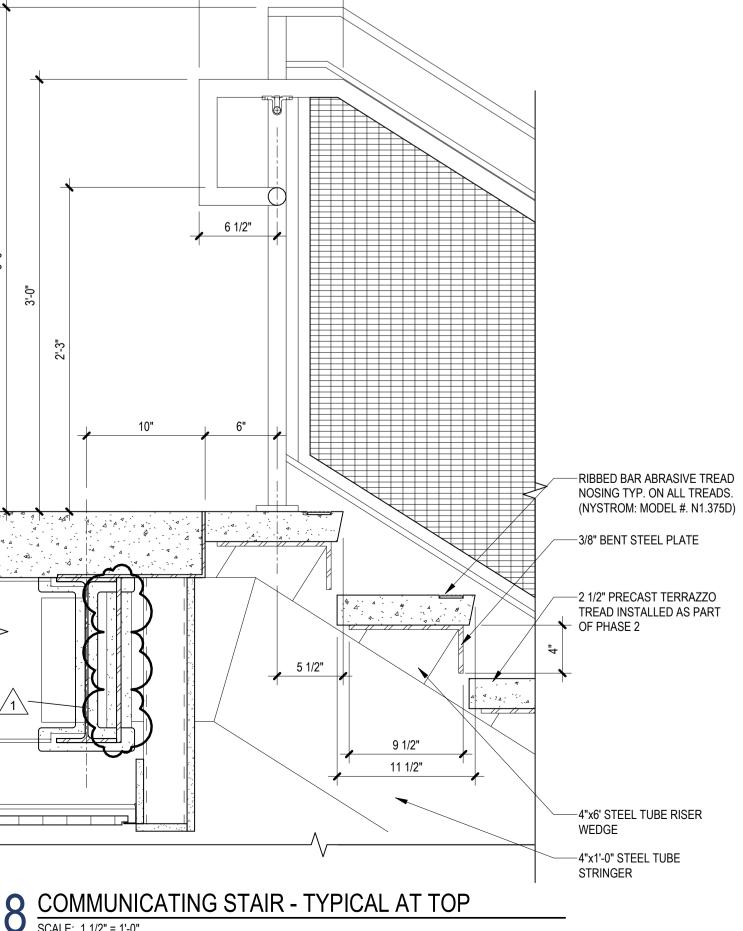
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BLD 1 (ADMIN) PLAZA WEST GRAND ST. WEST GRAND ST.







8. THE CONTRACTOR SHALL PROVIDE SHOP DRAWINGS SHOWING ALL RADII & CURVATURE INFORMATION, CONNECTIONS, ELEVATIONS,

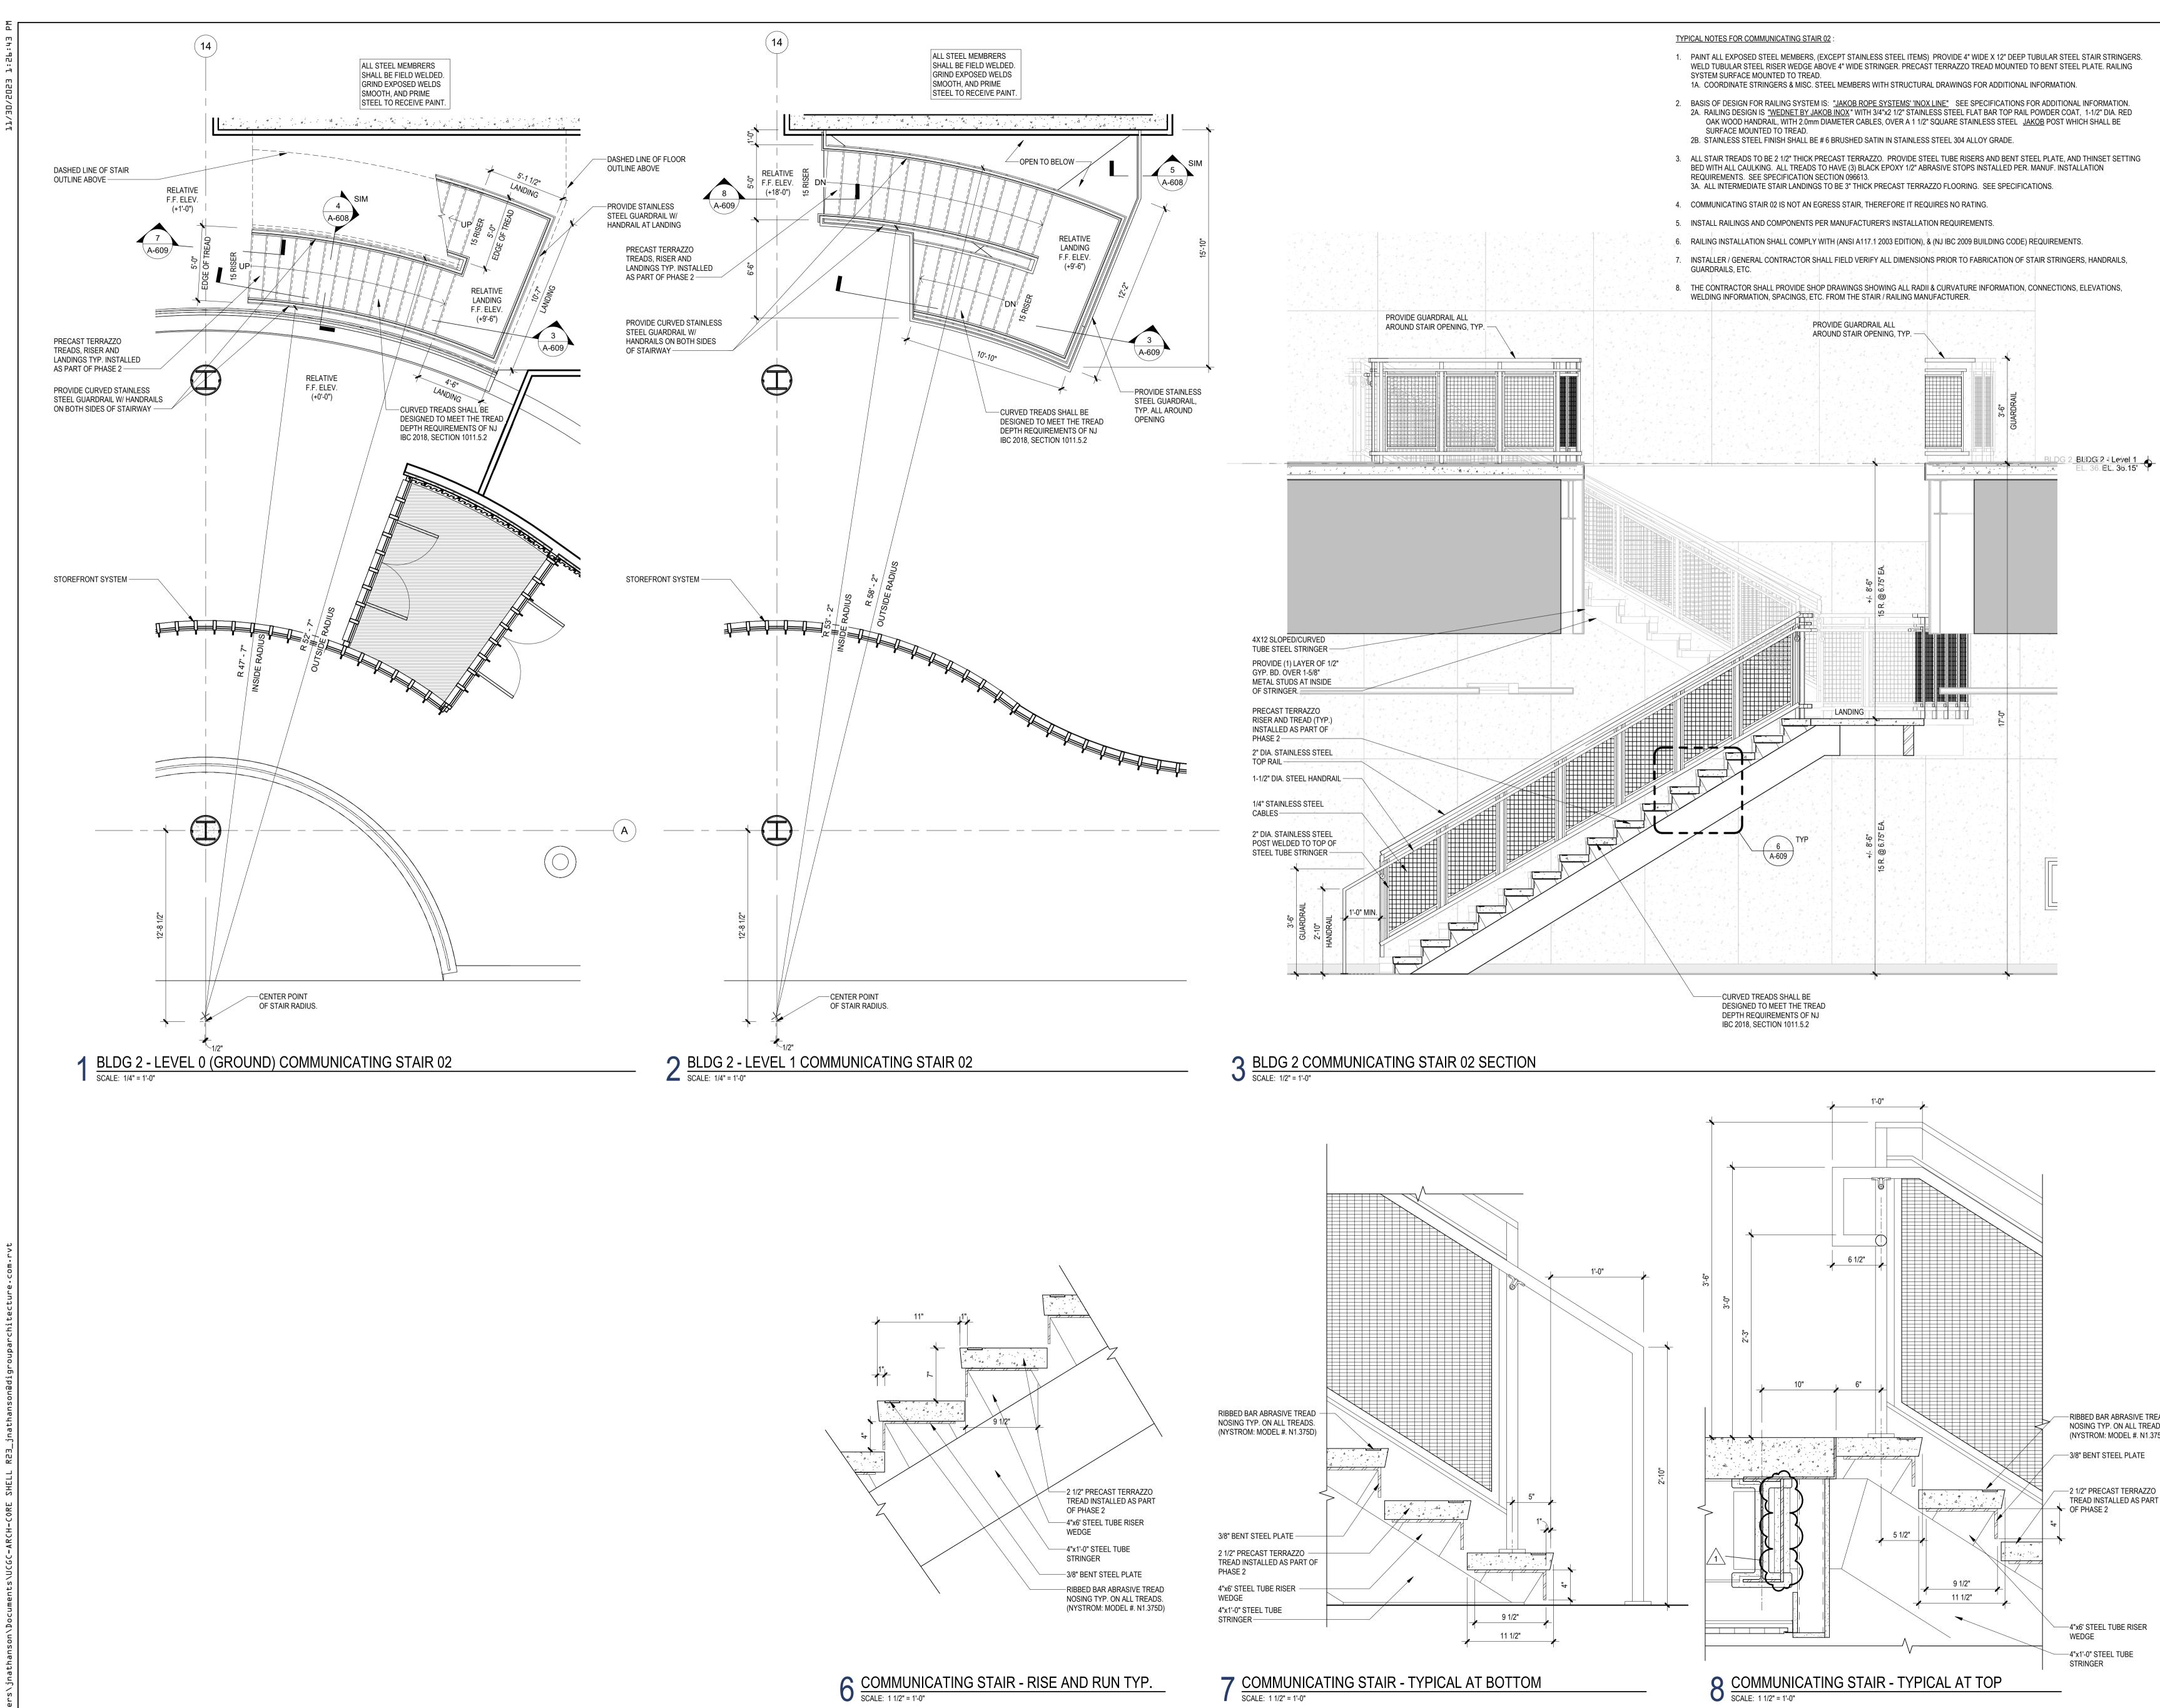Project: UNION COUNTY GOVERNMENT COMPLEX 81 & 93 WEST GRAND STREET CITY OF ELIZABETH NEW JERSEY, 07202 Drawing Information: Project No: 20.072 Date: 11.08.2023 Drawn By: JB / AV / PC Checked By: JM / SH Sheet Name: BUILDING NO. 2 - COMMUNICATING STAIR PLANS AND SECTIONS	SCALE. CONSU Client:	DRAWING MAY BE PRINTED AT REDUCED LT WITH ARCHITECT FOR DIMENSIONS.
COMPLEX 81 & 93 WEST GRAND STREET CITY OF ELIZABETH NEW JERSEY, 07202 Drawing Information: Project No: 20.072 Date: 11.08.2023 Drawn By: JB / AV / PC Checked By: JM / SH Sheet Name: BUILDING NO. 2 - COMMUNICATING STAIR PLANS	Project:	
Project No: 20.072 Date: 11.08.2023 Drawn By: JB / AV / PC Checked By: JM / SH Sheet Name: BUILDING NO. 2 - COMMUNICATING STAIR PLANS	COMPLEX 81 & 93 WEST CITY OF ELIZ	GRAND STREET ABETH
BUILDING NO. 2 - COMMUNICATING STAIR PLANS	Project No: Date: Drawn By:	20.072 11.08.2023 JB / AV / PC
COMMUNICATING STAIR PLANS	Sheet Name:	
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## Jeffrey D. Venezia, AIA NJ RA AI 00827100

No. Date Revisions / Issues


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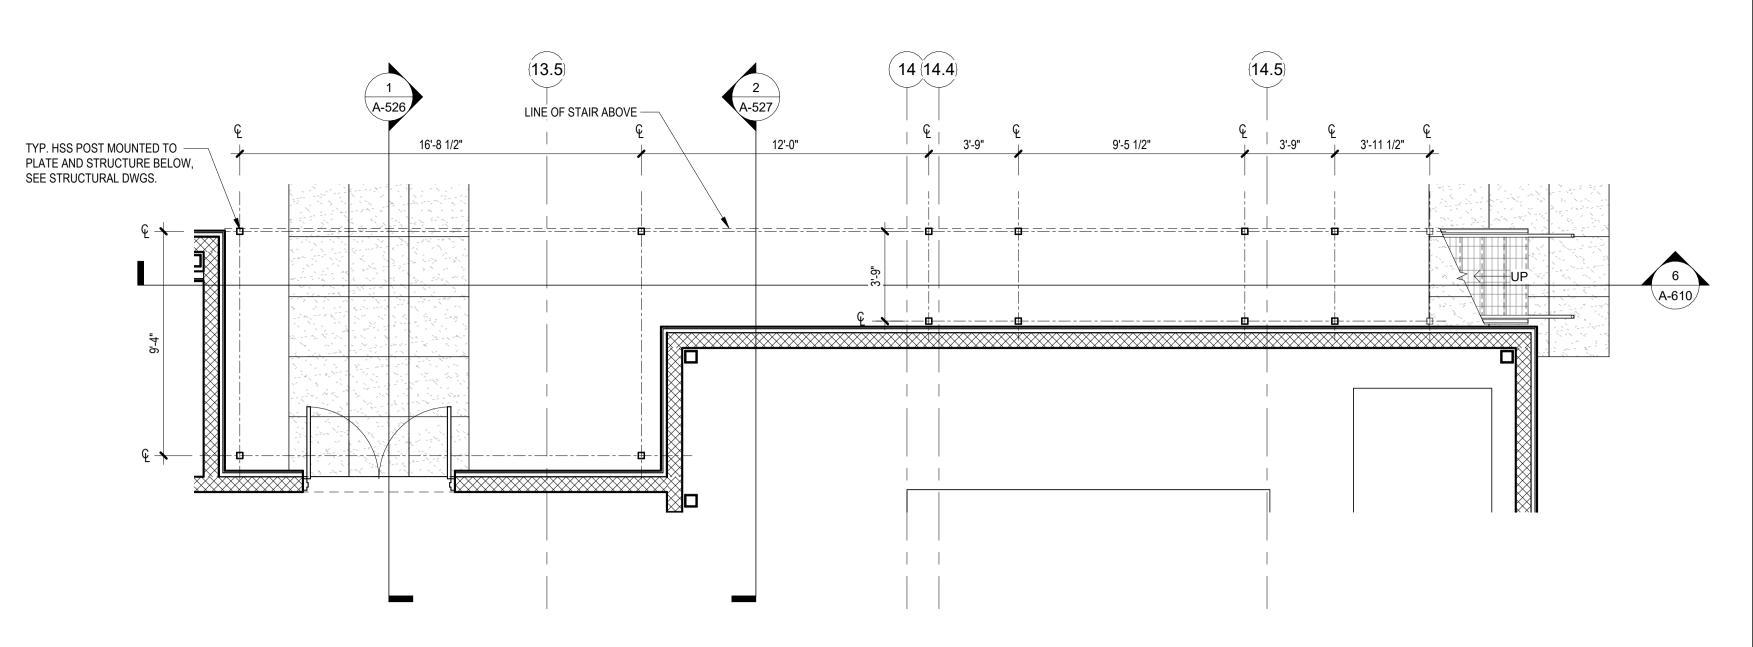
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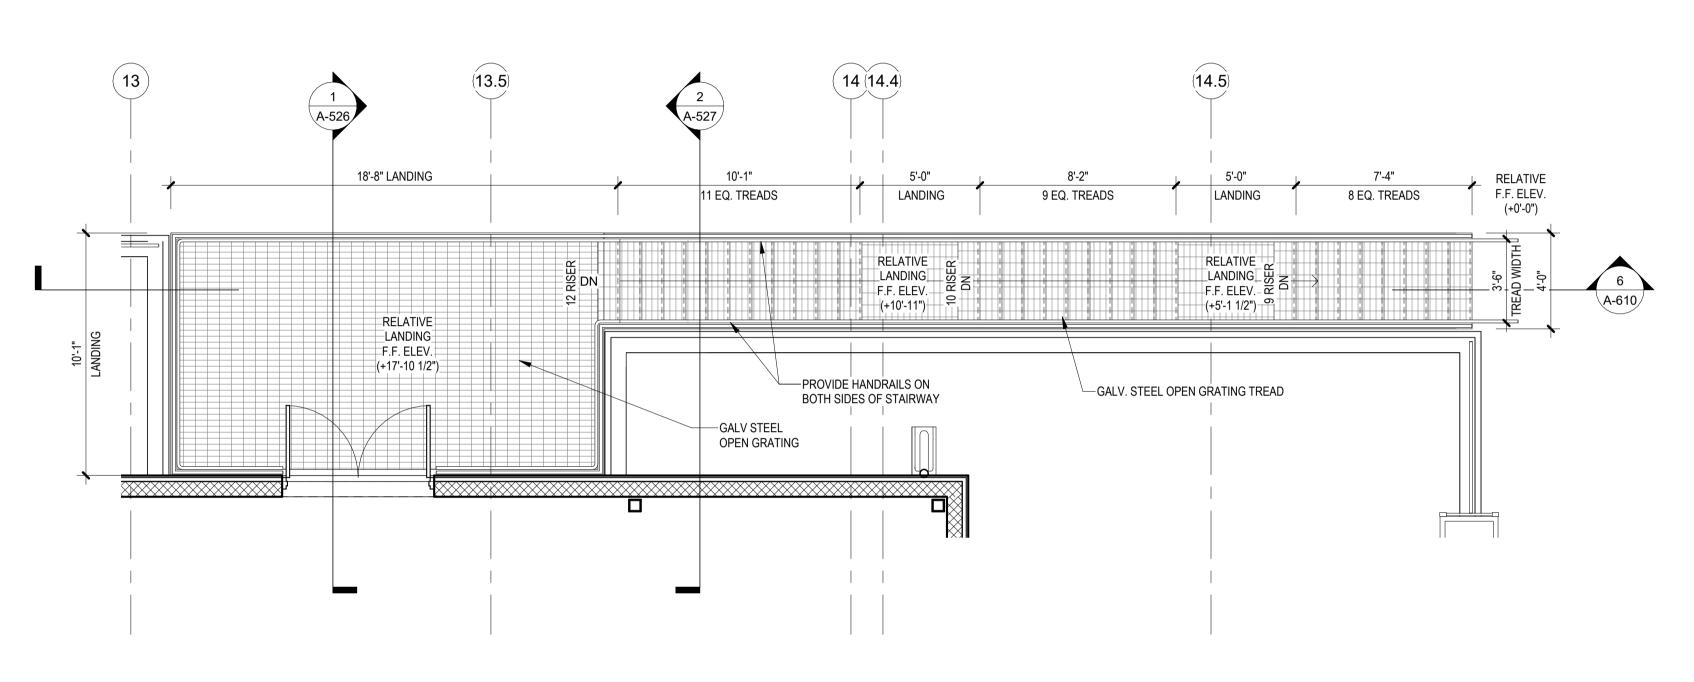
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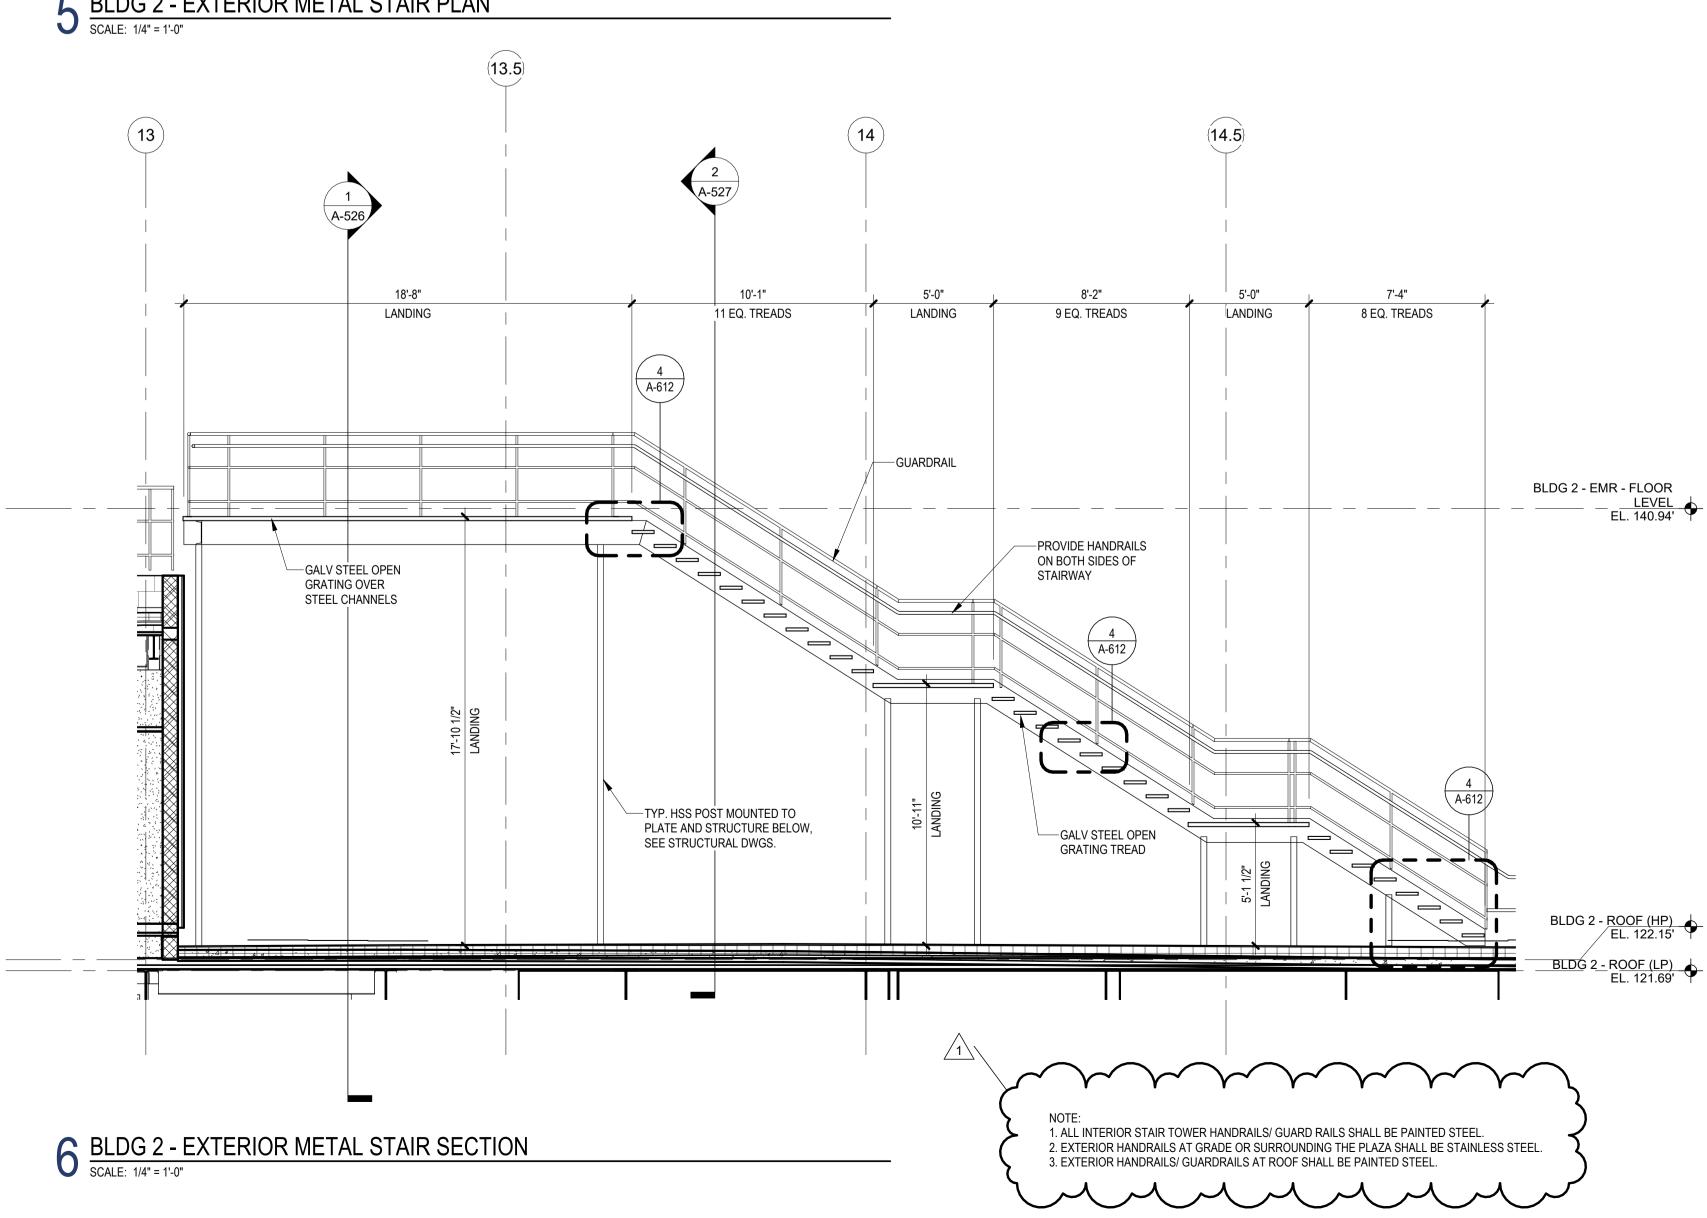




# 4 BLDG 2 - EXTERIOR METAL STAIR POST PLAN SCALE: 1/4" = 1'-0"



# 5 BLDG 2 - EXTERIOR METAL STAIR PLAN SCALE: 1/4" = 1'-0"

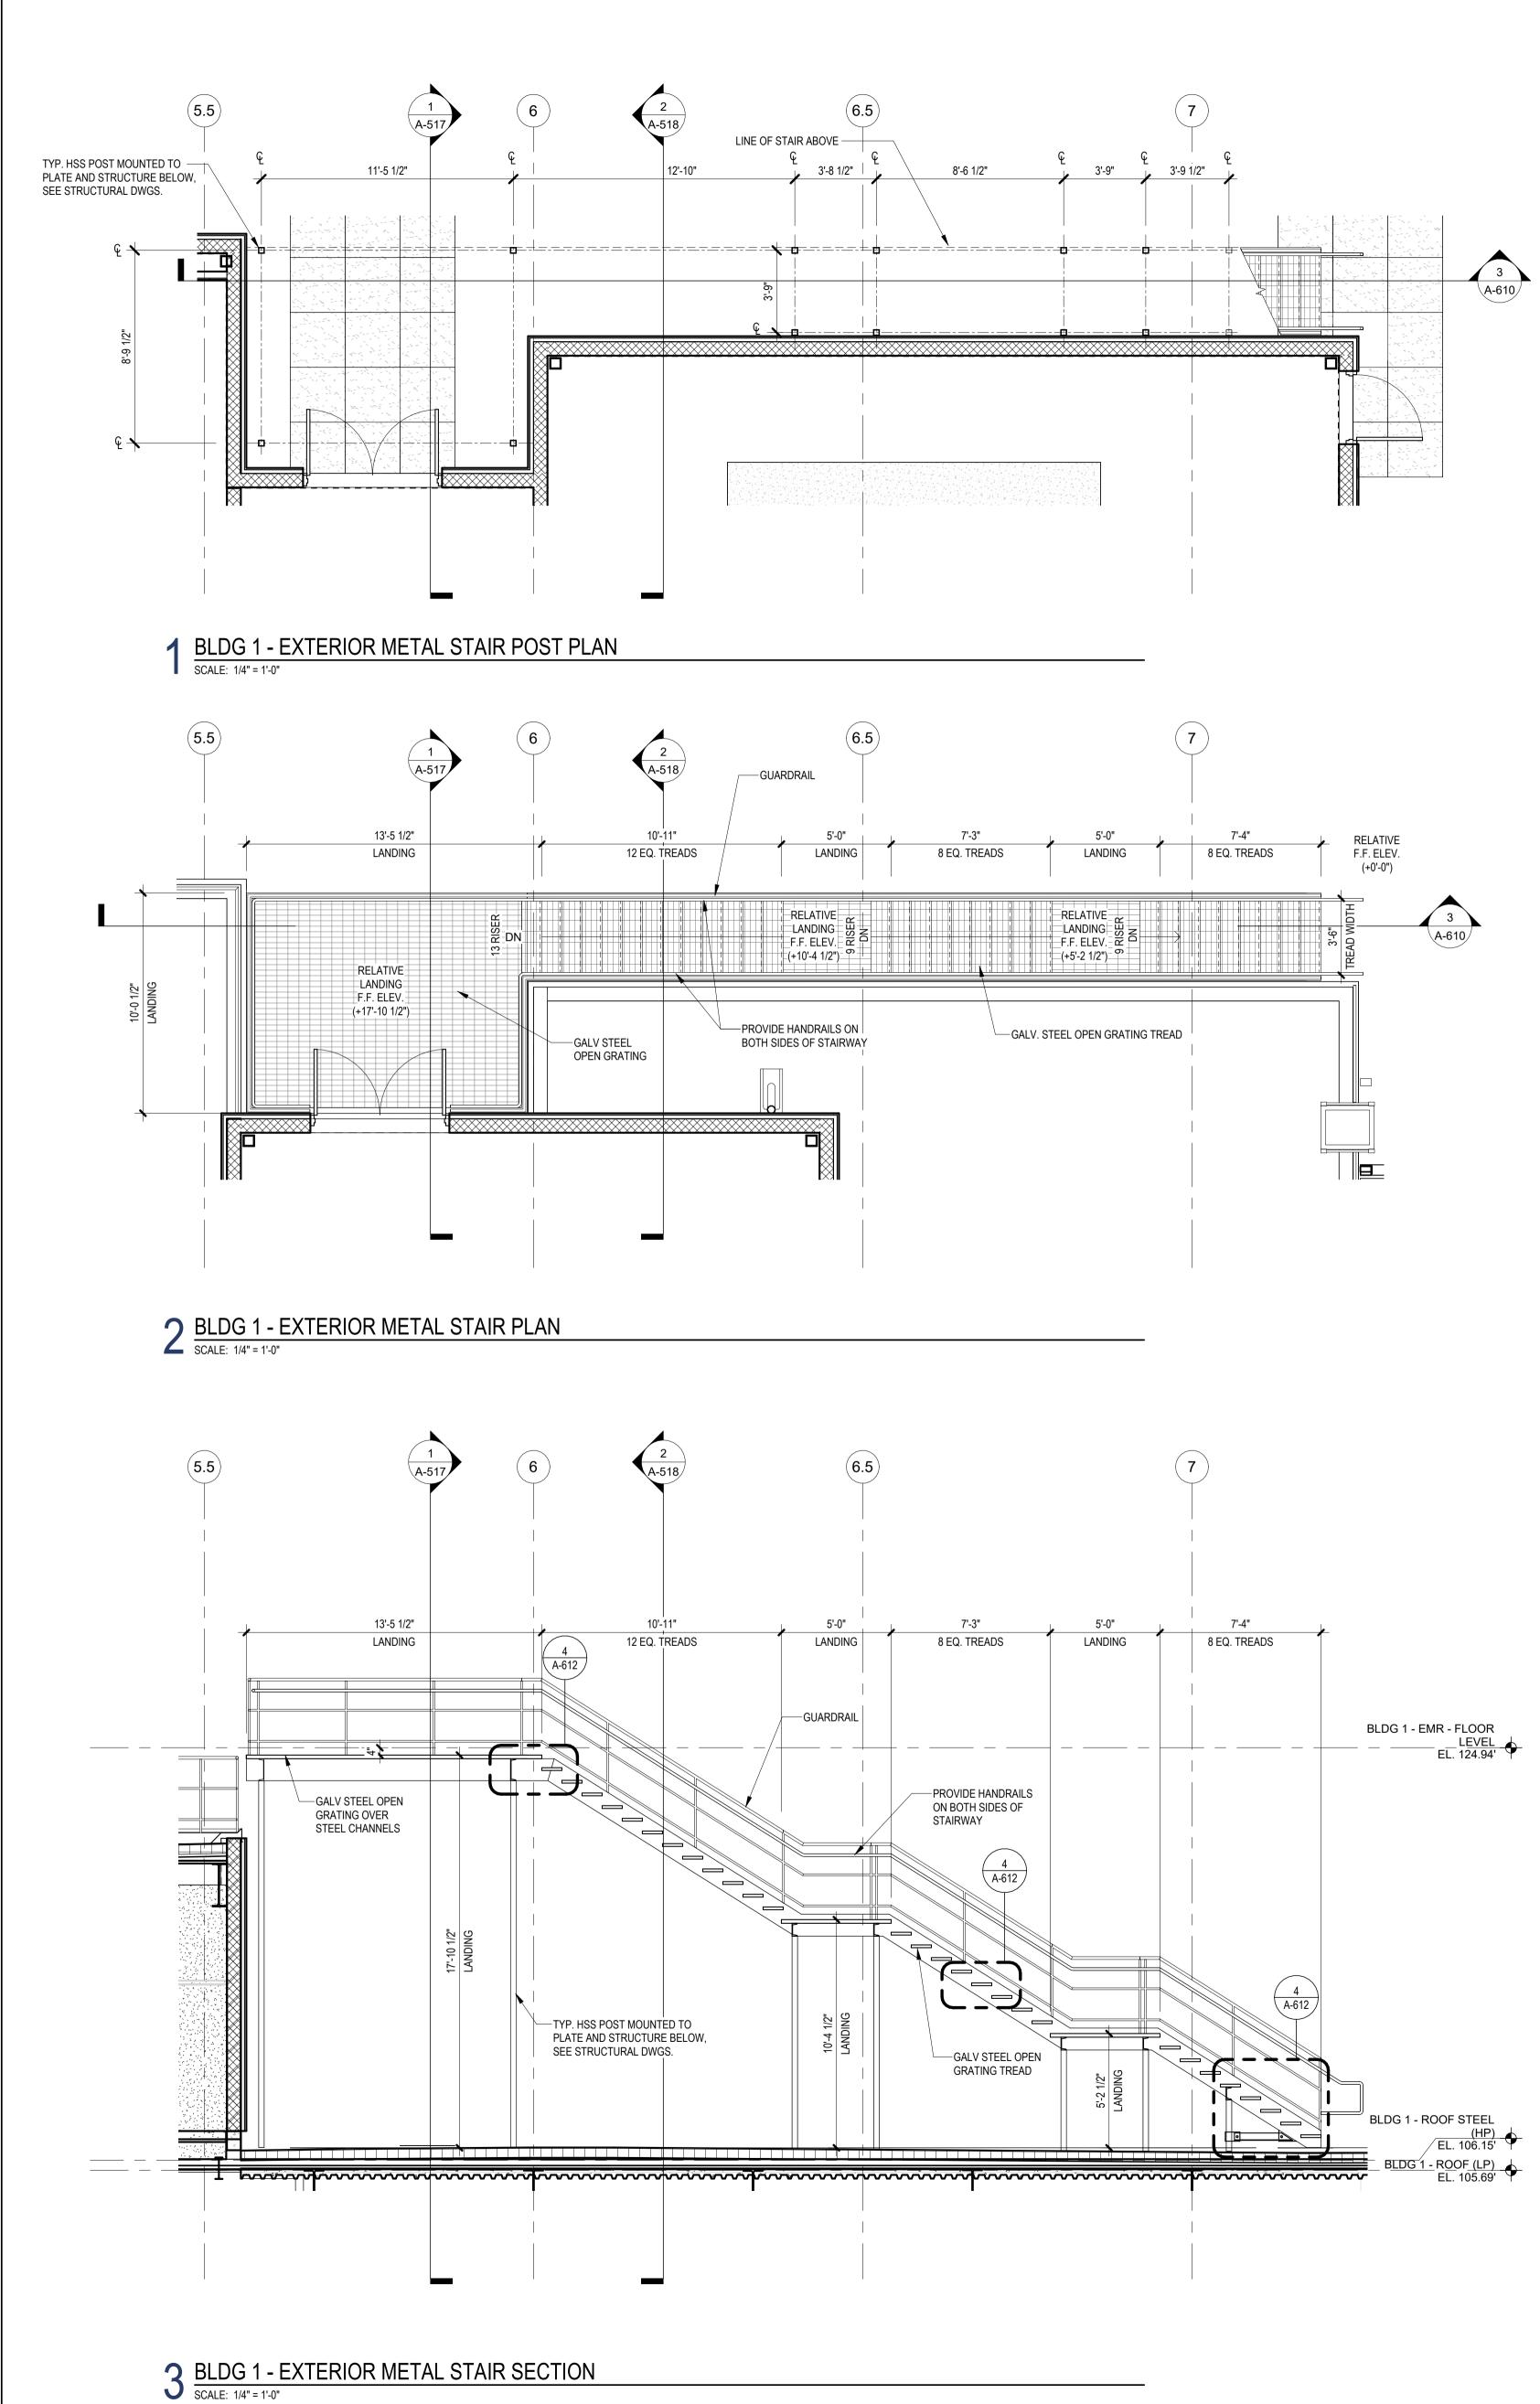

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Client:
UNION COUNTY IMPROVEMENT AUTHORITY
Project:
UNION COUNTY GOVERNMENT COMPLEX 81 & 93 WEST GRAND STREET CITY OF ELIZABETH NEW JERSEY, 07202
Drawing Information:
Project No:         20.072           Date:         11.08.2023           Drawn By:         JB / AV / PC           Checked By:         JM / SH
Sheet Name:
BUILDING NO. 1 & 2 - EXTERIOR METAL STAIRS
<b>A-610</b>


## Jeffrey D. Venezia, AIA NJ RA AI 00827100


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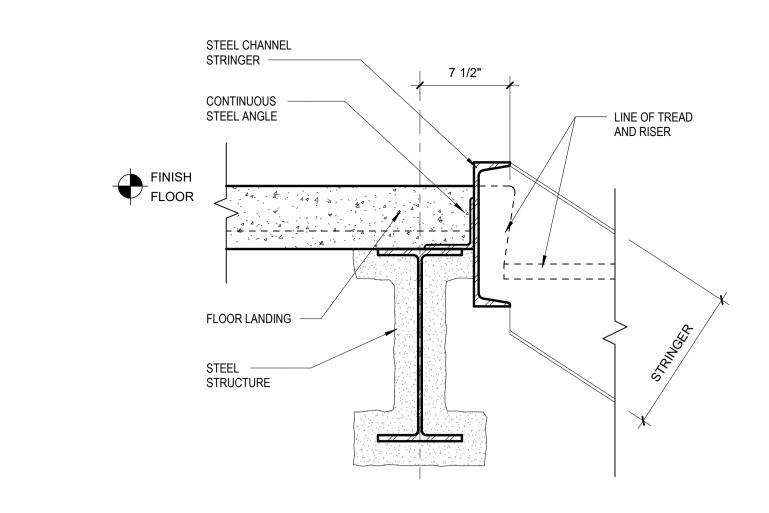
 1
 12.01.2023
 Addendum No. 01

 11.08.2023
 For Public Bid

 No.
 Date
 Description



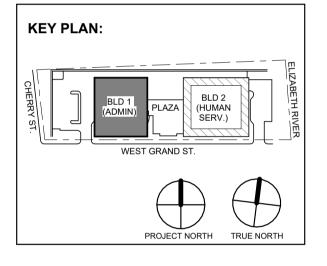

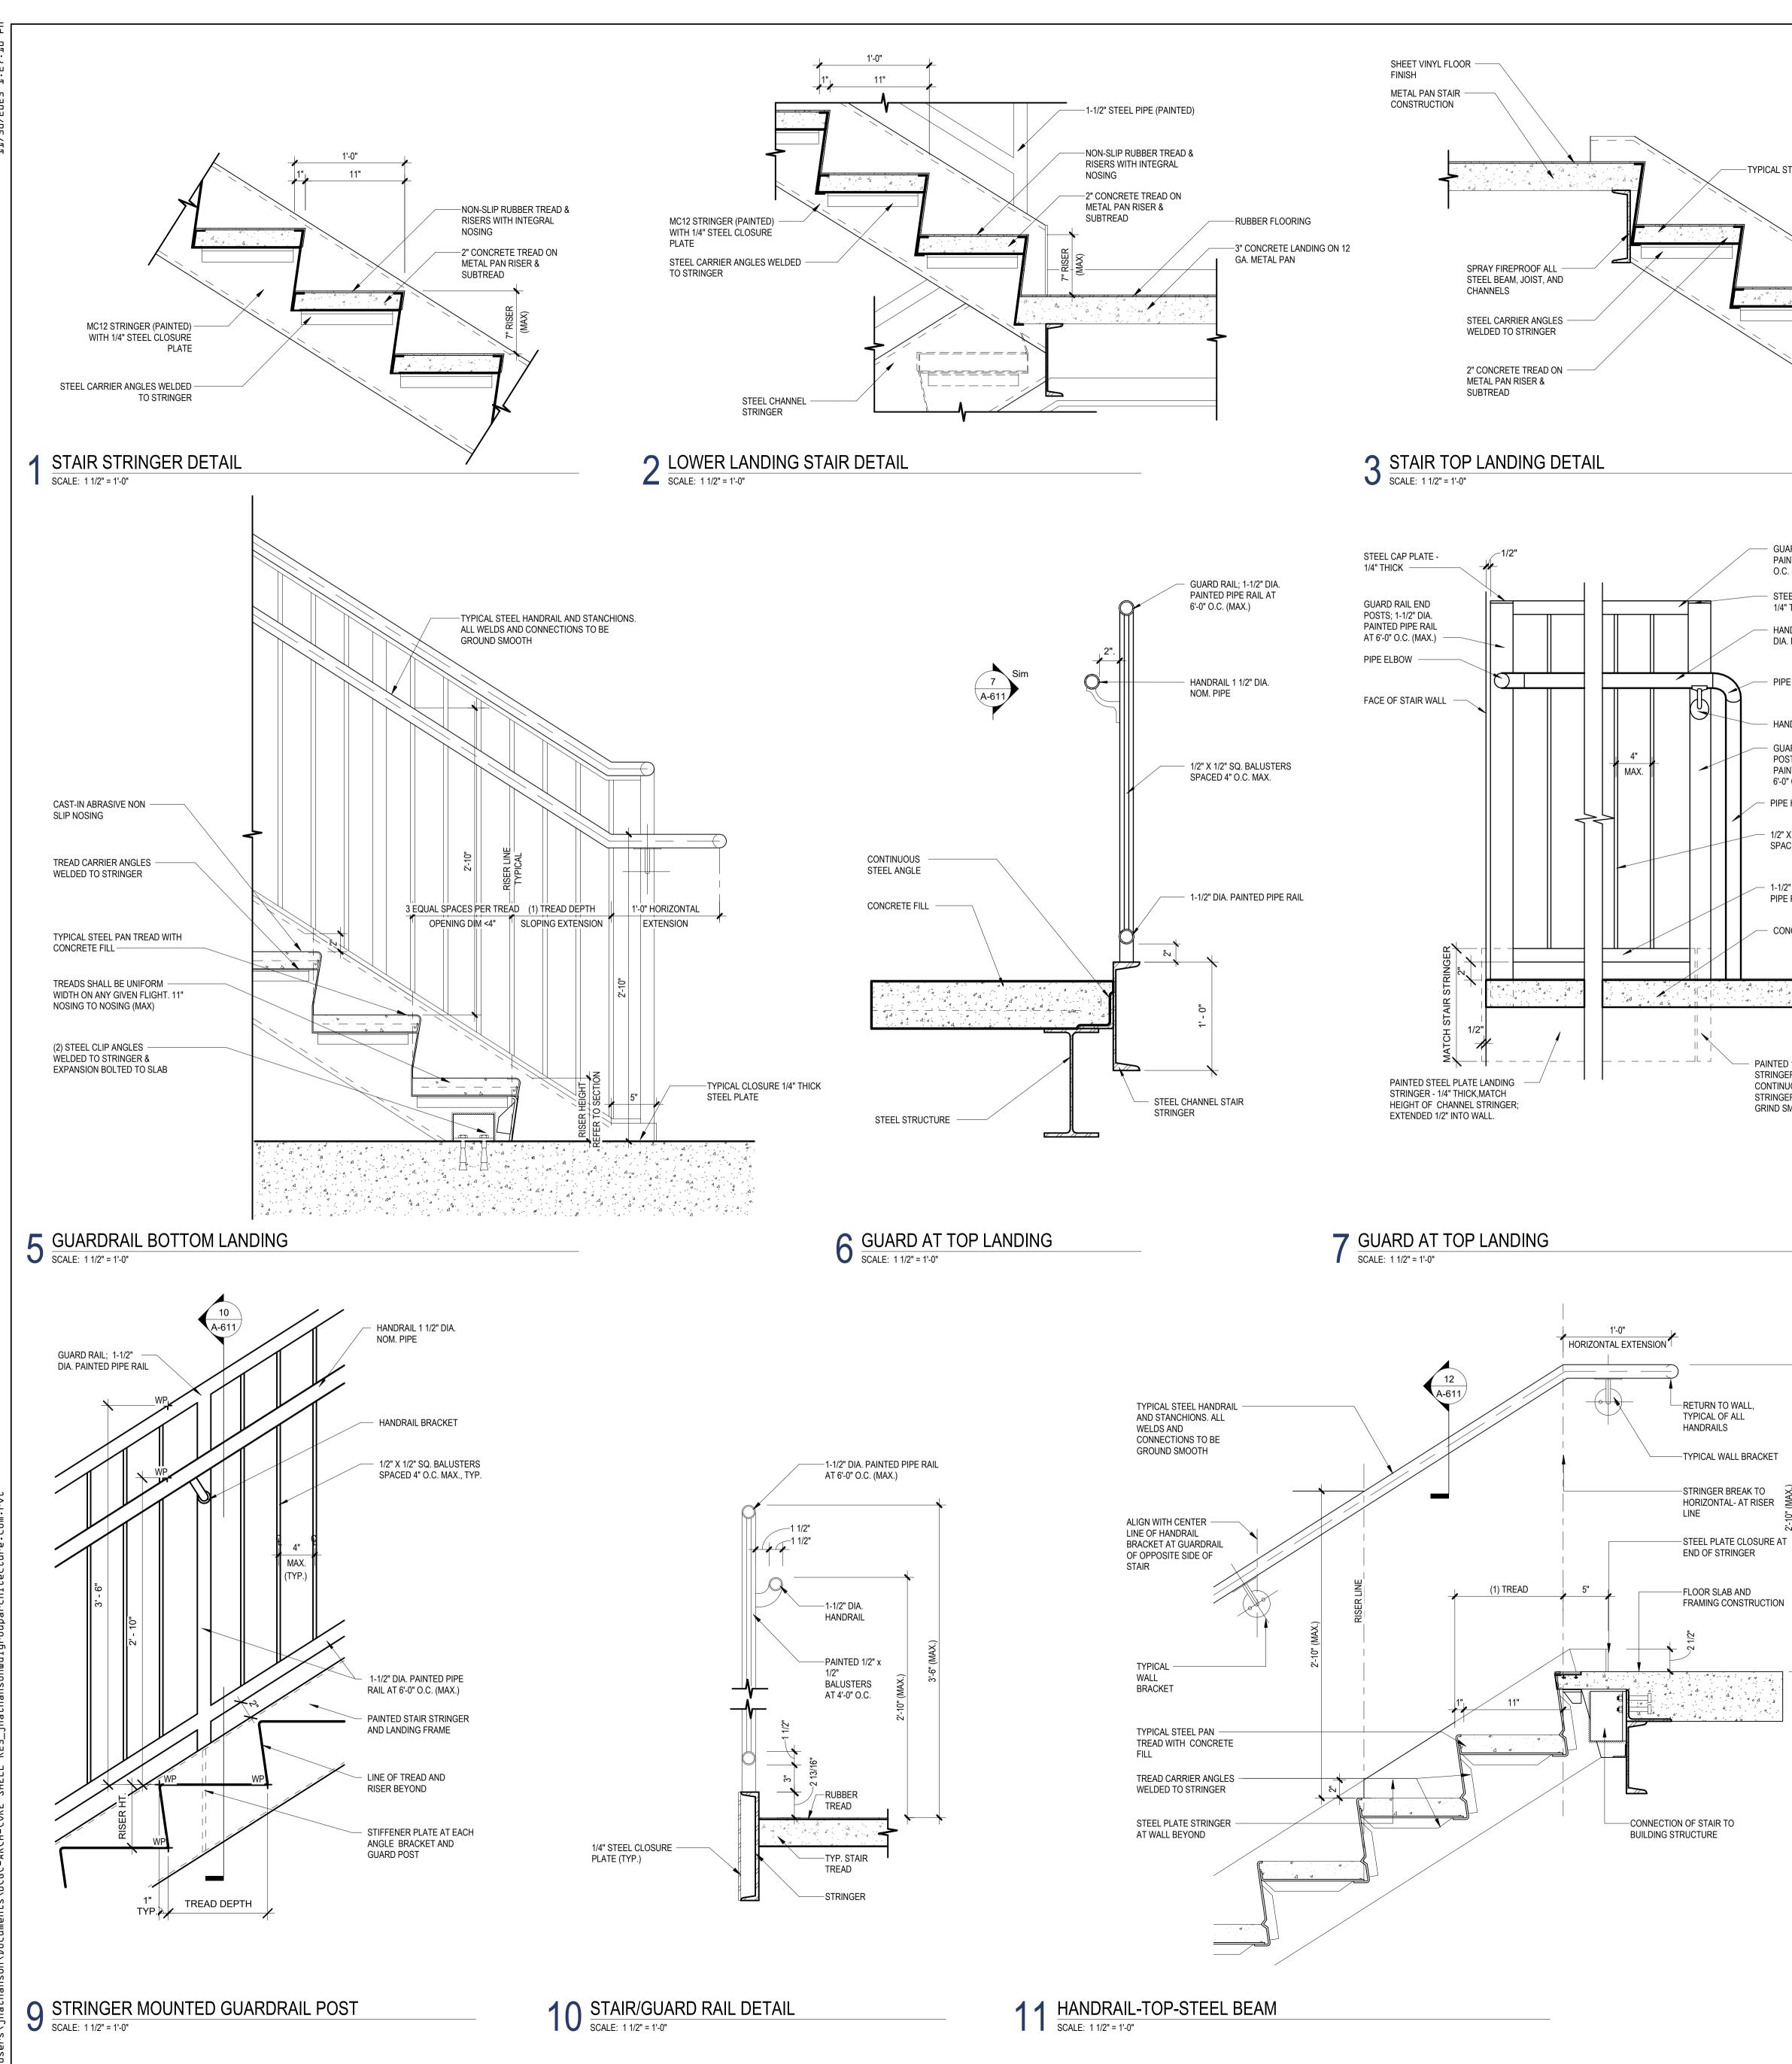

# 4 TOP LANDING DETAIL SCALE: 1 1/2" = 1'-0"

-TYPICAL STAIR TREAD

GUARD RAIL; 1-1/2" DIA.

O.C. (MAX.)

1/4" THICK

STEEL CAP PLATE -

HANDRAIL 1 1/2"

DIA. NOM. PIPE

PIPE ELBOW

HANDRAIL BRACKET

PAINTED PIPE RAIL AT

– PIPE HANDRAIL; 1 1/2" DIA.

- 1/2" X 1/2" SQ. BALUSTERS SPACED 4" O.C. MAX.

- 1-1/2" DIA. PAINTED

PIPE RAIL

CONCRETE FILL


PAINTED 1 1/2" W X 1/4" THICK STRINGER END PLATE; CONTINUOUS WELD TO

STRINGERS LANDING FRAME;


GRIND SMOOTH

GUARD RAIL END POSTS; 1-1/2" DIA.

6'-0" O.C. (MAX.)

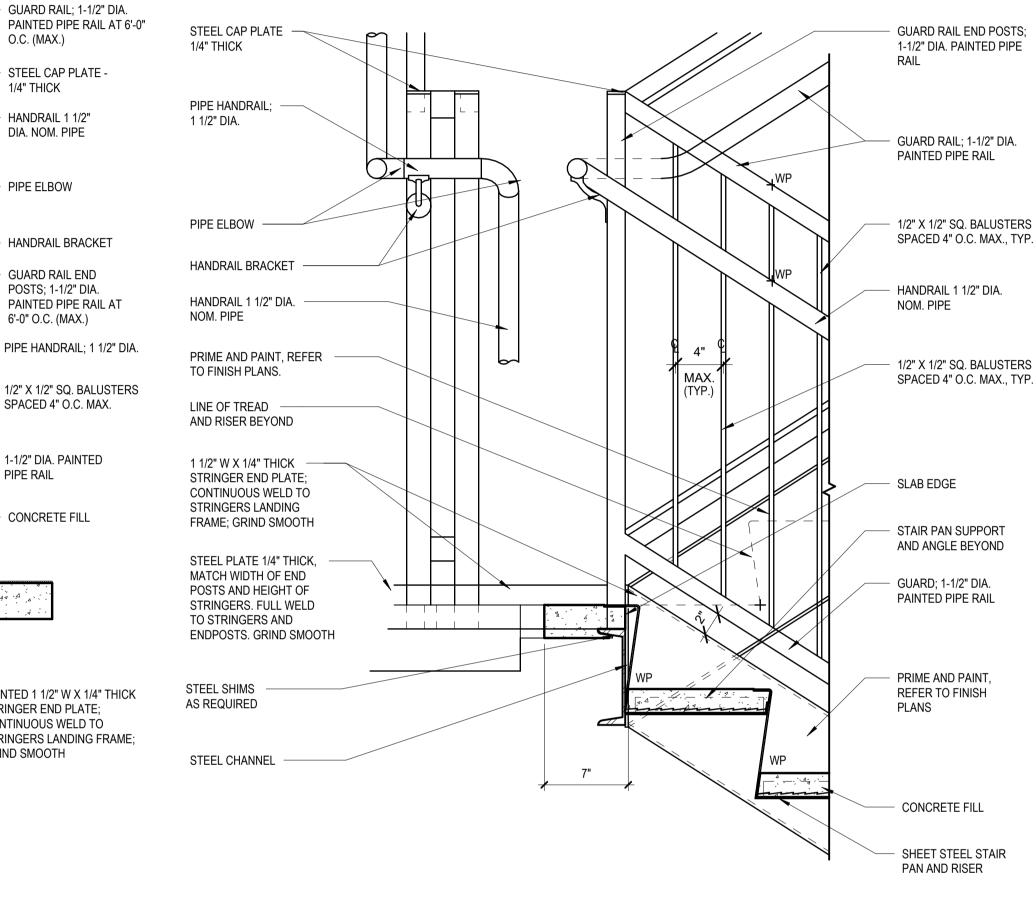

# 8 HANDRAIL AT FLOOR LANDING SCALE: 1 1/2" = 1'-0"

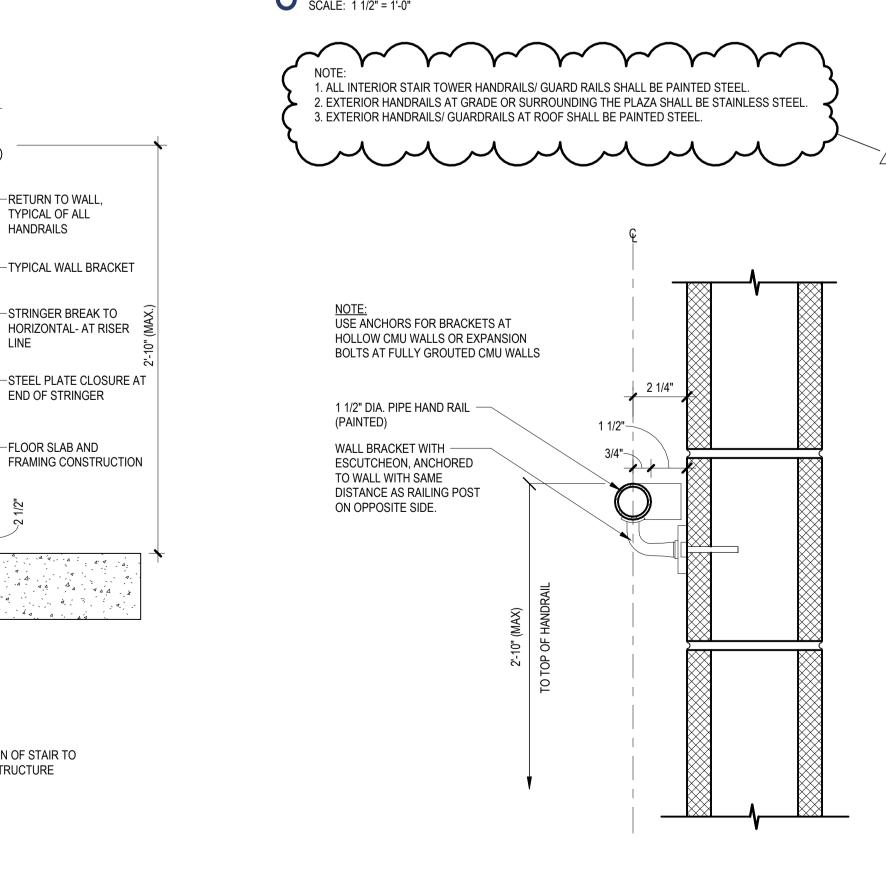

12 WALL RAILING DETAIL SCALE: 3" = 1'-0"

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Client:
UNION COUNTY IMPROVEMENT AUTHORITY
Project:
UNION COUNTY GOVERNMENT
COMPLEX
81 & 93 WEST GRAND STREET CITY OF ELIZABETH
NEW JERSEY, 07202
Drawing Information:
Project No: 20.072
Date: 11.08.2023
Drawn By: JB / AV / PC
Checked By: JM / SH
Sheet Name:
STAIR DETAILS
Sheet No:
V C11

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## Jeffrey D. Venezia, AIA NJ RA AI 00827100

No. Date

1 12.01.2023 Addendum No. 01 11.08.2023 For Public Bid

Description

Revisions / Issues **DIGroup**Architecture ARCHITECTURE FOR CHANGE 15 Bethany Street • New Brunswick, NJ 08901 • T: 732.249.6242 2450 W Hunting Park Ave • Philadelphia, PA 19122 • T: 215.634.3400

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