




1 BLDG NO. 1 - ROOF PLAN AT TOP OF TRELLIS & EQUIPMENT PLATFORM
SCALE: 1/8" = 1'-0"

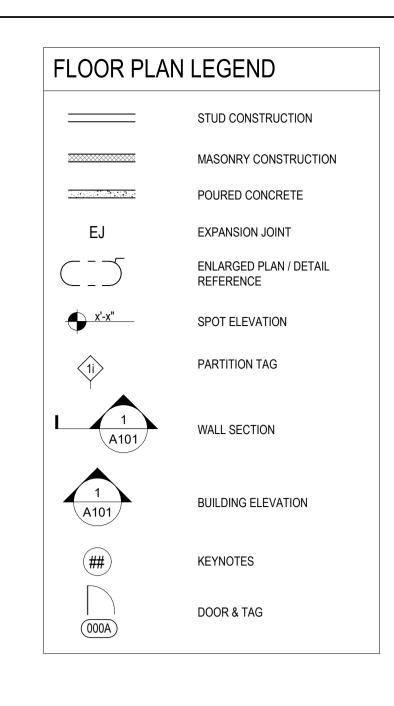


GENERAL NOTES:

- A. SIZE AND LOCATION OF ROOFTOP UNITS, CONDENSERS, PITCH POCKETS AND OTHER ELECTRICAL, MECHANICAL OR PLUMBING EQUIPMENT INDICATED ON THIS PLAN ARE APPROXIMATE. VERIFY EXACT LOCATIONS IN THE FIELD AND NOTIFY ARCHITECT OF ANY DISCREPANCIES.
- B. COORDINATE ALL ROOF EQUIPMENT SHOWN AND ROOF PENETRATIONS WITH STRUCTURAL ROOF FRAMING PLANS AND MECHANICAL DRAWINGS.
- C. ELEVATIONS SHOWN ARE TO THE TOP OF THE ROOF INSULATION FROM EL. 0'-0"
- D. ALL DIMENSIONS ARE TO COLUMN CENTERLINES (U.O.N.)
- E. ALL DIMENSIONS ARE TO CENTERLINE OF ROOF OPENINGS
- F. MECHANICAL OPENINGS ARE BASED ON SPECIFIED EQUIPMENT, VERIFY ALL OPENING SIZES WITH MECHANICAL CONTRACTOR.
- G. SEE DRAWINGS G-012 AND G-013 FOR PARTITION TYPES.
- H. SEE CS-300 SERIES DRAWINGS FOR ALL SLAB EDGE PLANS FOR SIZE OF ROOF OPENINGS, VERIFY EXACT SIZE WITH MECHANICAL CONTRACTOR.
- I. SEE A-600 SERIES DRAWINGS FOR ENLARGED FLOOR PLANS AT EGRESS STAIRS.
- J. SEE DRAWINGS A-425 AND A-426 FOR ENLARGED FLOOR PLANS AT PENTHOUSE AND EMR.
- K. REFER TO DRAWING A-516 AND A-525 FOR ROOF TRELLIS AND GLASS RAILING DETAILS.
- L. SEE A-550 SERIES DRAWINGS FOR ROOF DETAILS.
- M. THE EXACT SIZE, SHAPE, AND LOCATION OF ALL EQUIPMENT PADS SHALL BE DETERMINED BY THE SIZE OF THE EQUIPMENT. COORDINATE LOCATION AND FINAL SIZE OF CONCRETE PADS WITH EQUIPMENT AND MANUFACTURER PRIOR TO CONSTRUCTION. MAINTAIN 4" MINIMUM OF CONCRETE BEYOND EQUIPMENT ALL AROUND, TYPICAL.
- N. REFER TO MECHANICAL, ELECTRICAL AND PLUMBING DRAWINGS FOR ADDITIONAL INFORMATION.
- O. SEE SPECIFICATIONS SECTION 072100 FOR THERMAL INSULATION.
- P. SEE SPECIFICATIONS SECTION 075323 FOR TYPICAL EPDM MEMBRANE ROOFING AND TYPE & THICKNESS OF ROOFING INSULATION. BASIS OF DESIGN CARLISLE SYNTEC "SURE-WHITE".
- Q. SEE SPECIFICATIONS SECTION 077100 FOR ROOF SPECIALTIES AND ACCESSORIES, PROVIDE PRESSURE TREATED WOOD BLOCKING AS REQUIRED FOR PROPER ANCHORAGE.

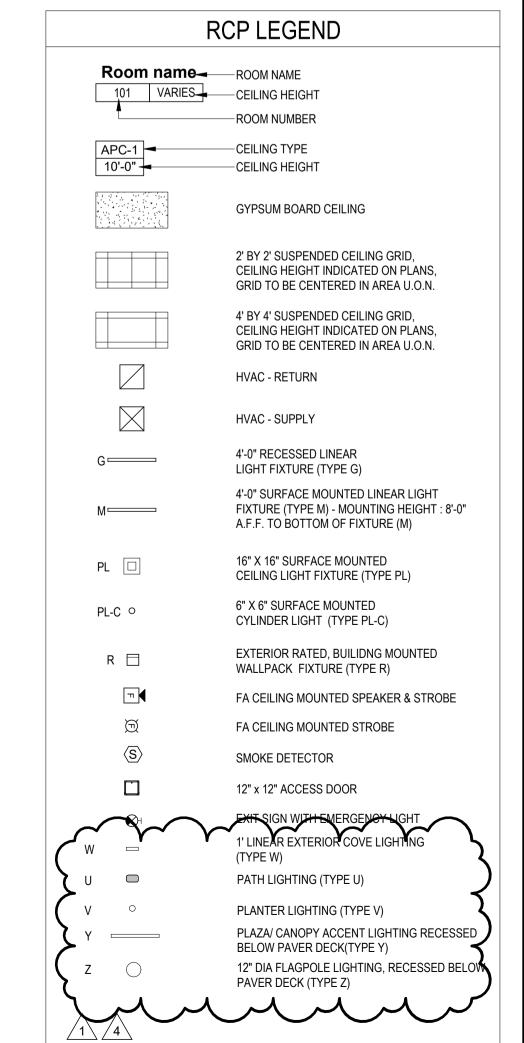

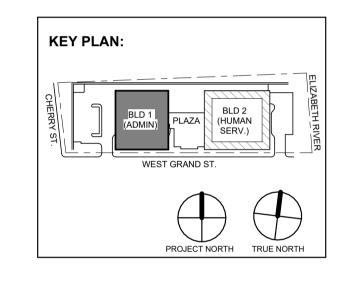

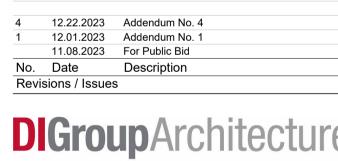

A R C H I T E C T U R E F O R C H A N G E

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Client:

UNION COUNTY IMPROVEMENT

AUTHORITY

Project:
UNION COUNTY GOVERNMENT

COMPLEX
81 & 93 WEST GRAND STREET
CITY OF ELIZABETH
NEW JERSEY, 07202

Drawing Information:

Project No: 20.072
Date: 11.08.2023
Drawn By: JB / AV / PC

EQUIPMENT PLATFORM


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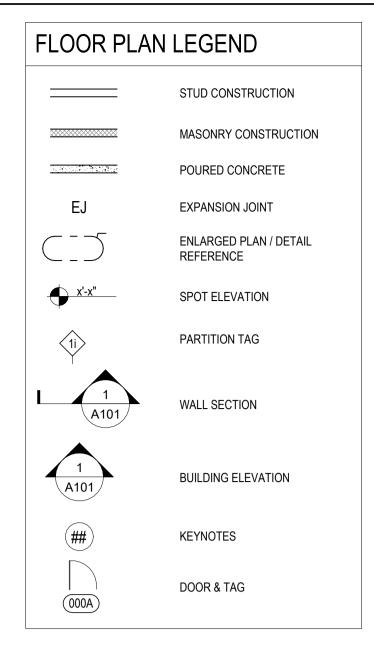
BUILDING NO. 1 - ROOF PLAN AT
TOP OF TRELLIS AND

Sheet No: **CS-108**

Checked By: JM / SH


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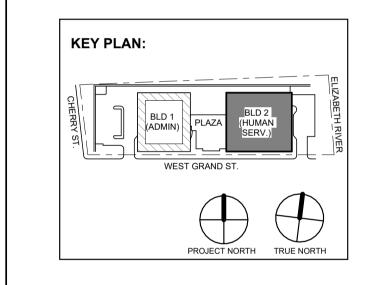


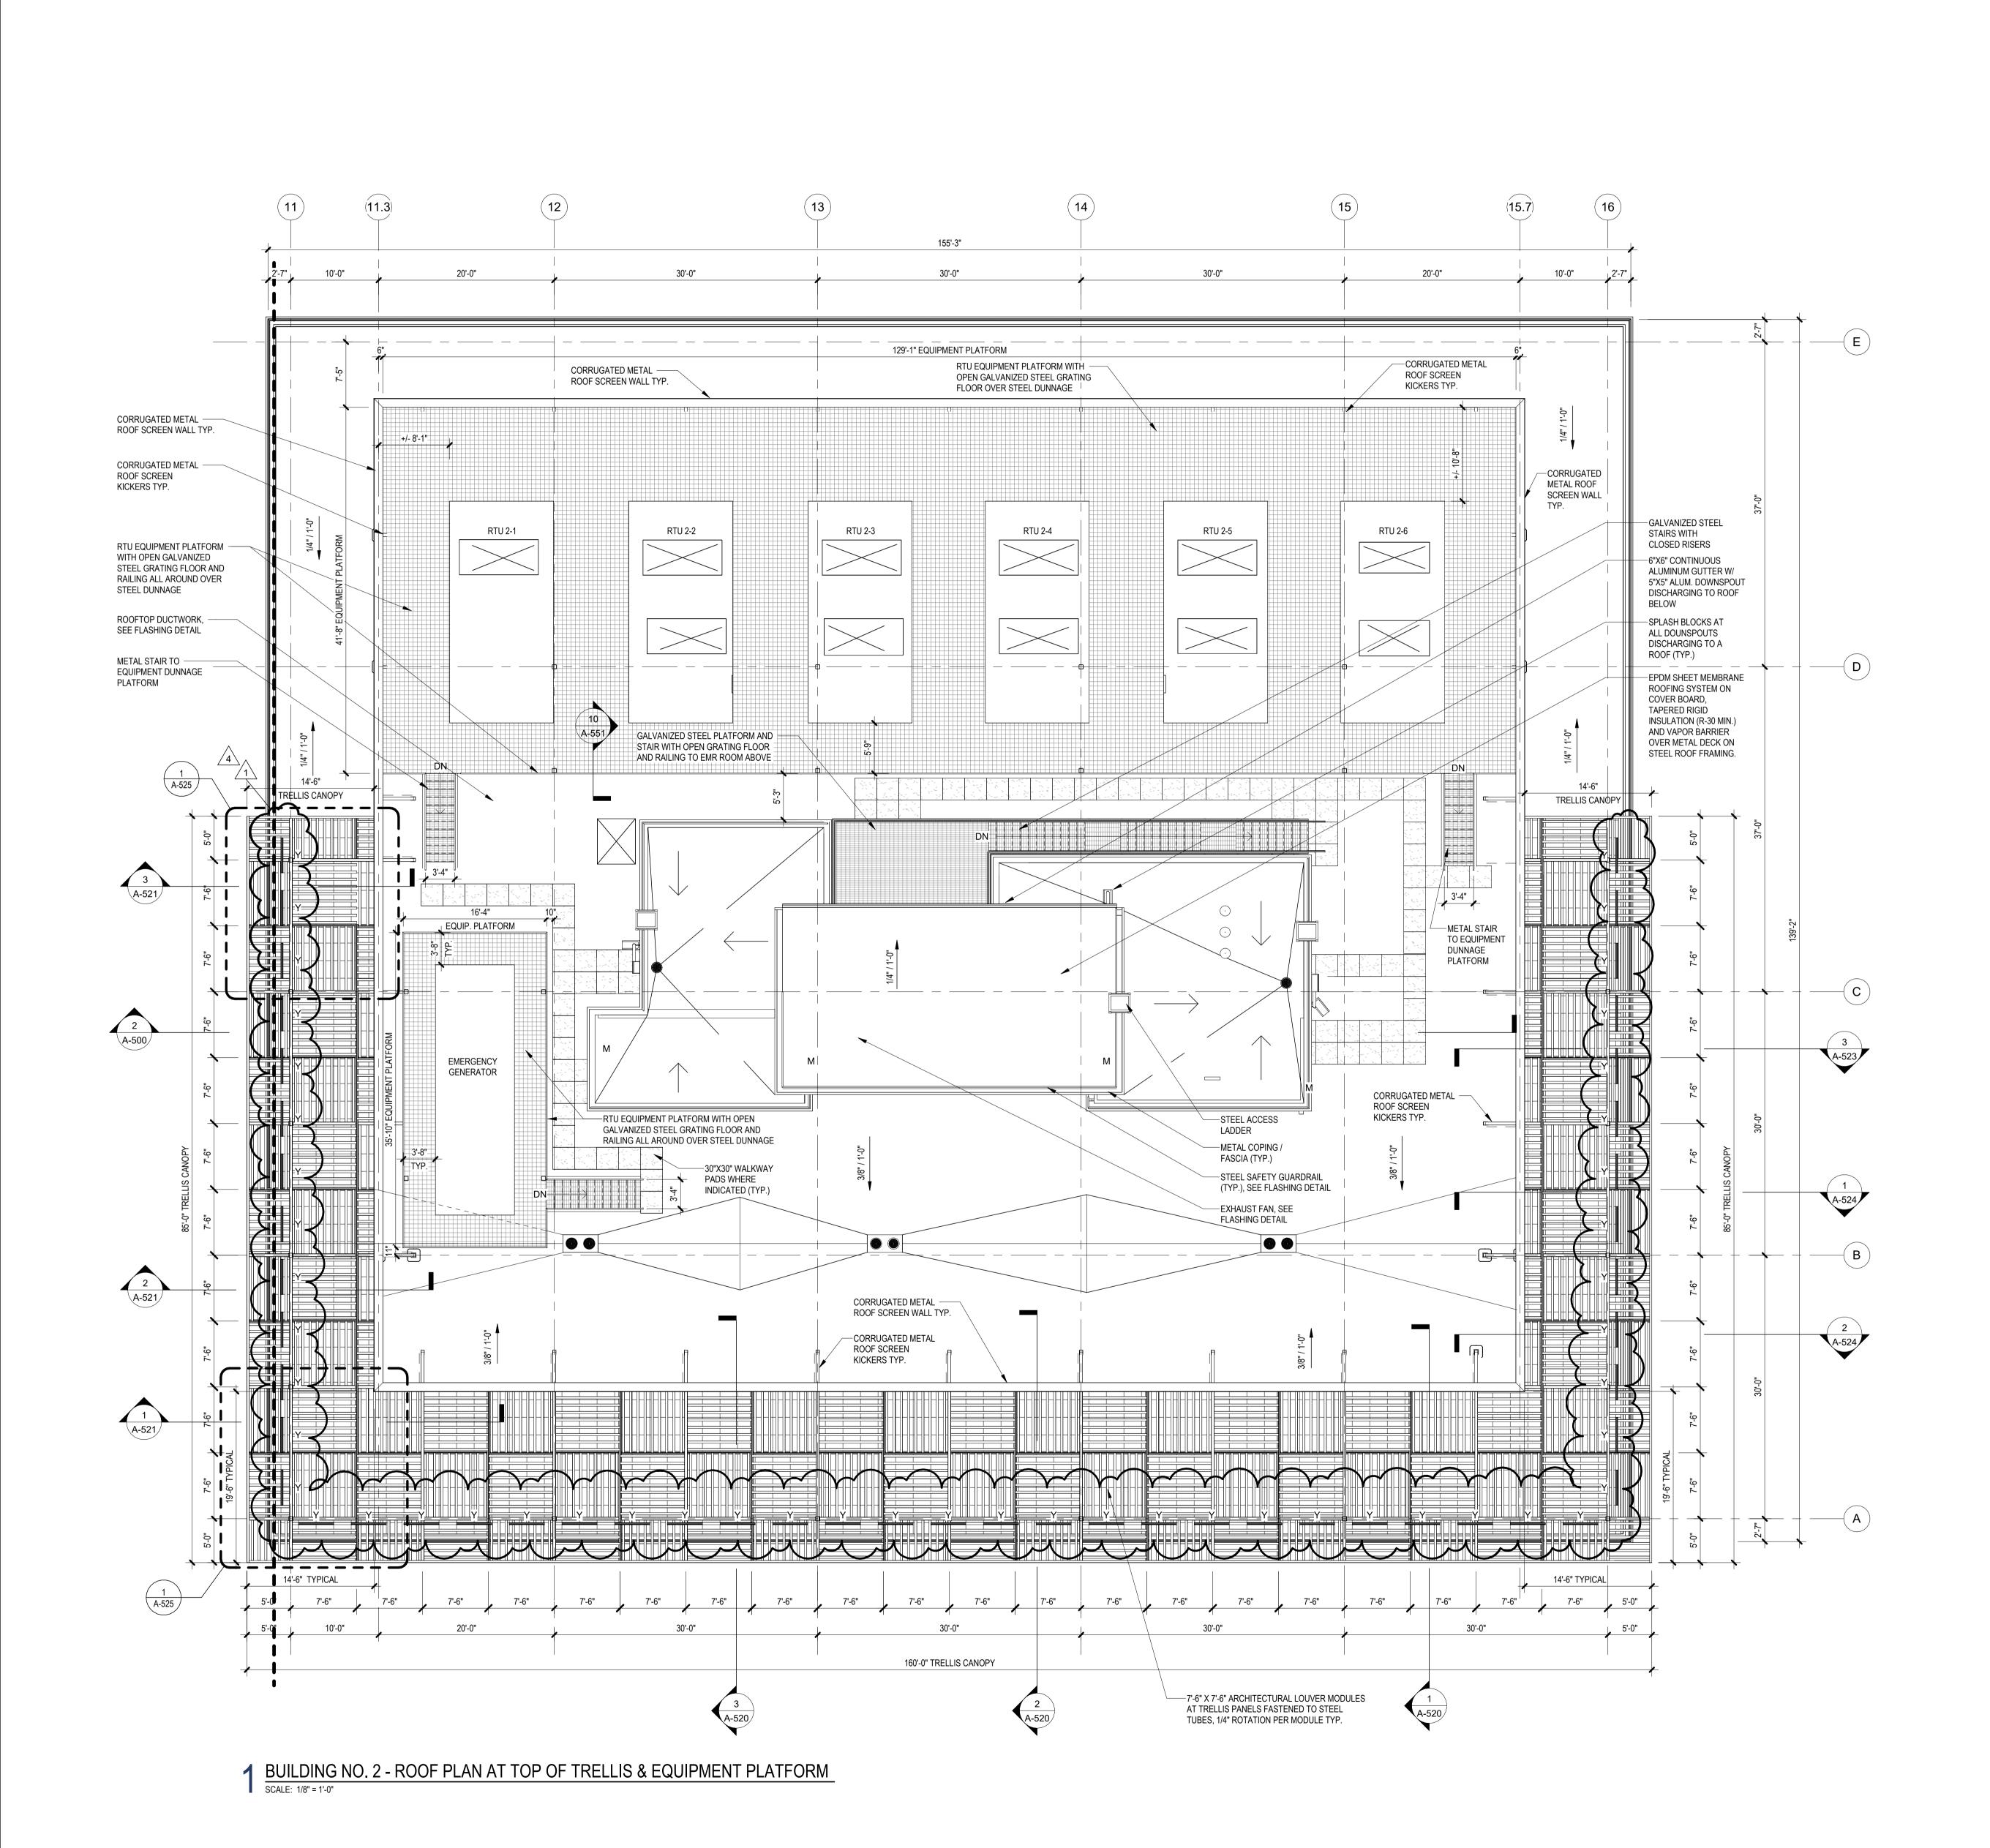


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Project No: 20.072
Date: 11.08.2023
Drawn By: JB / AV / PC
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Sheet Name:

BUILDING NO. 2 - ROOF PLAN AT TOP OF TRELLIS AND EQUIPMENT PLATFORM

Sheet No:

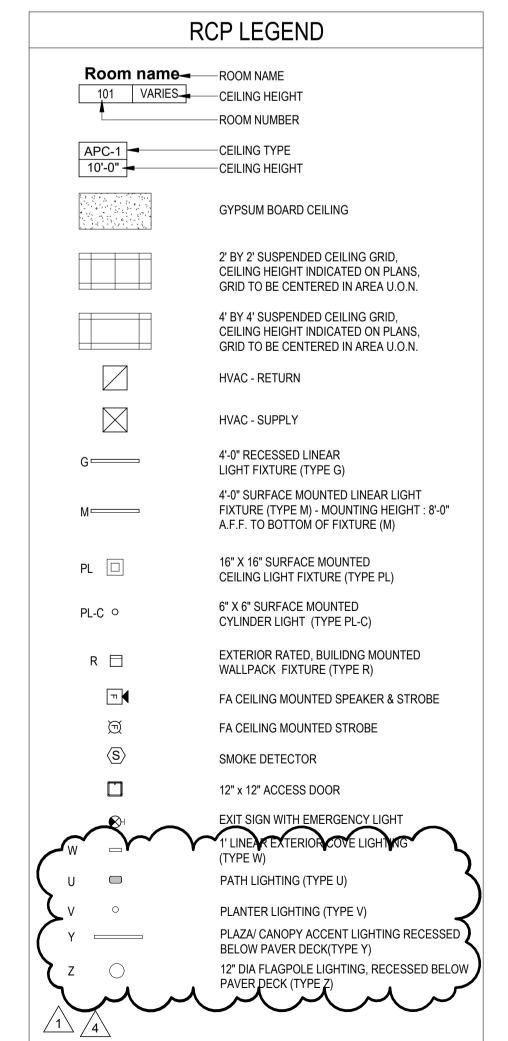CS-118
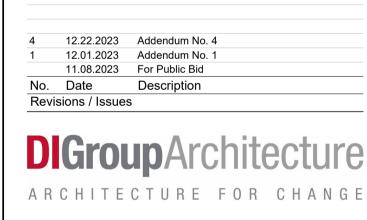
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