- A. BORDERS AT LAY-IN ACOUSTICAL CEILING PANELS SHALL BE CUT TO MATCH FACTORY EDGE PROFILE. NO EXPOSED FASTENERS SHALL BE PERMITTED INCLUDING POP RIVETS
- B. HEIGHT OF CEILINGS SHALL BE MEASURED FROM TOP OF SLAB TO FINISH FACE OF GWB OR FACE OF CEILING GRID AS INDICATED ON THE REFLECTED CEILING PLAN, UON.
- C. ALL LIGHT FIXTURES ARE TO BE INSTALLED IN ACCORDANCE WITH THE ARCHITECTURAL REFLECTED CEILING PLAN. ARCHITECT TO REVIEW CEILING LAYOUT INCLUDING
- BULKHEADS AND GRID PRIOR TO INSTALLATION. D. LIGHT FIXTURES TYPES SHOWN ON ARCHITECTURAL REFLECTED CEILING PLANS ARE NOTED FOR QUANTITIES AND LOCATIONS ONLY. SEE ELECTRICAL DRAWINGS FOR ADDITIONAL INFORMATION REGARDING SPECIFICATIONS, SWITCHING, EXIT LIGHTS,

EMERGENCY LIGHTING, LIFE SAFETY EQUIPMENT AND CIRCUITING.


- E. MECHANICAL INFORMATION SHOWN ON THIS PLAN IS FOR REFERENCE ONLY, SEE MECHANICAL DRAWINGS FOR DIFFUSER LOCATIONS AND FOR ADDITIONAL INFORMATION REGARDING ALL HVAC EQUIPMENT INCLUDING HVAC REGISTERS, GRILLS, ETC.
- F. DIMENSIONED LIGHT FIXTURES ARE FROM FINISHED FACE OF PARTITIONS TO CENTERLINE OF FIXTURE TO CENTERLINE OF FIXTURE. ANY DISCREPANCIES WITH LOCATION OF LIGHT FIXTURES, SWITCHES, THERMOSTATS, OR DIFFUSERS BETWEEN ARCHITECTURAL AND ENGINEERING DRAWINGS SHALL BE CLARIFIED WITH THE ARCHITECT PRIOR TO INSTALLATION.
- G. THE CONTRACTOR SHALL SUBMIT COORDINATION DRAWINGS THAT INCORPORATES ALL TRADES AS REQUIRED BY THE SPECIFICATIONS.
- H. LIGHT FIXTURES, DIFFUSERS, GRILLES AND ALL OTHER SYSTEM DEVICES SHALL BE LOCATED CENTERED ON CEILING TILES, U.O.N.
- I. ALL ACOUSTICAL TILE CEILINGS SHALL BE CENTERED WITHIN EACH ROOM U.O.N. J. ALL FLUSH MOUNTED LIGHT FIXTURES MOUNTED WITHIN A GYPSUM BOARD CEILING SHALL BE FITTED WITH FLUSH TRIM.
- K. WHERE DUCTWORK, CONDUIT, AND PIPING MUST CROSS OPEN CEILINGS, ALL WORK SHALL BE EXECUTED TO PRESENT A NEAT AND MINIMAL APPURTENANCE:
- L. ALL EXPOSED WORK SHALL RUN PARALLEL OR PERPENDICULAR TO STRUCTURE, WITH 90 DEGREE BENDS.
- M. LOCATE WORK SO AS TO MINIMIZE EXTENT EXPOSED. LOCATE WORK AS CLOSE AS POSSIBLE TO ADJACENT WALLS OR CEILINGS PLANES.
- N. PROVIDE ADDITIONAL STRUT SUPPORT SYSTEM TO SUPPORT FIXTURES WHERE LIGHT FIXTURES ARE NOT MOUNTED BELOW STRUCTURAL MEMBERS-DO NOT MOUNT TO ROOF
- WHERE EXPOSED STRUCTURE IS INDICATED, ALL EXPOSED ROOF DECK, STRUCTURAL
- STEEL, CONCRETE BEAMS & DECK, PIPES, DUCTS, CONDUITS, ETC. SHALL BE PAINTED TO MATCH CEILING COLOR; SEE FINISH SCHEDULE.

P. DOWNLIGHTS SHALL BE SYMMETRICALLY CENTERED IN ACOUSTICAL CEILING TILE AND

- GYPSUM BOARD CEILINGS U.O.N. Q. PROVIDE SOFFIT TRANSITIONS BETWEEN ACT CEILINGS AND GYPSUM BOARD CEILINGS
- R. FURNISH AN INSTALL ACCESS DOORS IN GYP. BD. CEILINGS AS REQUIRED TO PROVIDE ACCESS TO ABOVE-CEILINGS VAV BOXES, DAMPERS, VALVES, EQUIPMENT, ETC. SEE MEP DRAWINGS FOR LOCATIONS AND SPECIFICATIONS, COORDINATE FINAL LOCATIONS

WITH DESIGNER PRIOR TO INSTALLATION.

- S. ALL GYP. BD. CEILINGS IN WET AREAS SUCH AS TOILET ROOMS, BATHROOMS, AND JANITORS CLOSETS SHALL RECEIVE MOISTURE AND MOLD RESISTANT GYP. BD. AS PER
- T. SEE SPECIFICATIONS FOR ADDITIONAL INFORMATION REGARDING CEILING TYPES.
- U. SEE A-220 SERIES DRAWINGS FOR TYPICAL CEILING DETAILS, U.O.N. V. ALL EXTERIOR WINDOWS WILL HAVE MANUAL ROLLER SHADES. REFER TO
- SPECIFICATIONS AND A-220 SERIES DRAWINGS FOR LOCATION AND DETAILS.
- W. ALL TRAINING ROOMS AND COMMISSIONER MEETING ROOM WILL HAVE POWERED ROLLER SHADES WITH BOTH SOLAR AND BLACKOUT CAPABILITY TO REFER TO SPECIFICATIONS.
- X. ALL GYP. BOARD SOFFITS AND FASCIAS TO BE PAINTED (PNT-2) U.O.N.

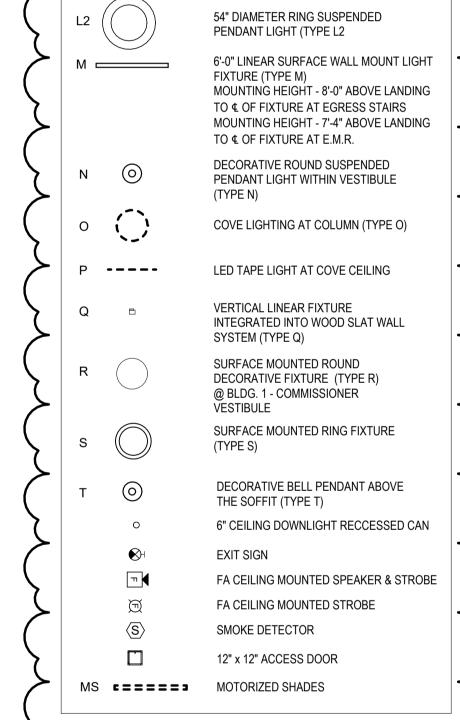

RCP LEGEND

-ROOM NUMBER

-CEILING TYPE

—CEILING HEIGHT

GYPSUM BOARD CEILING

HVAC - RETURN

HVAC - SUPPLY

HVAC - LINEAR SUPPLY

PRIVATE OFFICES

OPEN OFFICES

FIXTURE (TYPE D)

FIXTURE (TYPE D2)

FIXTURE (TYPE E)

HVAC - BATHROOM EXHAUST FAN

CEIING LIGHT FIXTURE (TYPE A) @

2'-0" X 2'-0" RECESSED CEIING LIGHT

2" x VARYING LENGTH CEILING HUNG

PENDANT LIGHT FIXTURE (TYPE C) @

2'-0" X 2'-0" RECESSED TROFFE

FIXTURE (TYPE B) @ UTILITIES

MOUNTING HEIGHT - 8'-0" A.F.F.

2" x 8'-0" RECESSED CEILING LIGHT

2" x 4'-0" RECESSED CEILING LIGHT

4" SQUARE RECESSED DOWNLIGHT

RECESSED DIRECT LINEAR FIXTURE,

LINEAR DIRECT/INDIRECT PENDANT FIXTURE, VARYING LENGTHS (TYPE F2)

LINEAR WALL GRAZER LIGHT (TYPE H)

DECORATIVE ROUND SUSPENDED PENDANT LIGHT (TYPE I) AT CAFE

DECORATIVE ROUND SUSPENDED

PENDANT LIGHT (TYPE J)

FIXTURE (TYPE K)

LED ADJUSTABLE SPOT LIGHT

24" DIAMETER RING SUSPENDED PENDANT LIGHT (TYPE L)

VARYING LENGTHS (TYPE F)

4'-0" RECESSED LINEAR

LIGHT FIXTURE (TYPE G)

2' BY 2' SUSPENDED CEILING GRID,

4' BY 4' SUSPENDED CEILING GRID,

CEILING HEIGHT INDICATED ON PLANS,

GRID TO BE CENTERED IN AREA U.O.N.

CEILING HEIGHT INDICATED ON PLANS.

GRID TO BE CENTERED IN AREA U.O.N.

Room name - ROOM NAME

10'-0"



COLUMN / BEAM COVER BASIS OF DESIGN MANUFACTURER: CENTRIA PRODUCT: COLUMN COVERS SERIES 3000

BASIS OF DESIGN MANUFACTURER: CERTAINTEED PRODUCT: MULTI BOX CONTINOUS REFER TO DETAIL 2 / A1-202 FOR ADDITIONAL INFORMATION

WOOD LOOK ALUMINUM SLATS VARIED WIDTH + DEPTH

MANUAL SHADE SYSTEMS **BASIS OF DESIGN** MANUFACTURER: MECHOSHADE PRODUCT: MECHO/5 SYSTEM

TYPICAL CEILING HEIGHTS (BLDG 1):			
TYPICAL OPEN OFFICE:	9'-5" A.F.F. (2' x 4' ACT-3)		
TYPICAL PRIVATE OFFICE:	9'-5" A.F.F. (2' x 2' ACT-4)		
TYPICAL CONFERENCE / MEETING ROOM:	9'-5" A.F.F.		
TYPICAL STORAGE / FILE / COPY ROOM:	8'-0" A.F.F. (2' x 2' ACT-1)		
ELEVATOR CORE:	9'-5" / 10'-5" A.F.F.		
RESTROOMS:	8'-0" A.F.F. (ACT-3 OR ACT-4)		

12.22.2023 Addendum No. 4 12.08.2023 Addendum No. 2 No. Date

Revisions / Issues

ARCHITECTURE FOR CHANGE 15 Bethany Street • New Brunswick, NJ 08901 • T: 732.249.6242 2450 W Hunting Park Ave • Philadelphia, PA 19122 • T: 215.634.3400

Jeffrey D. Venezia, AIA NJ RA AI 00827100

KEY PLAN:

OO NOT SCALE. DRAWING MAY BE PRINTED AT REDUCED SCALE. CONSULT WITH ARCHITECT FOR DIMENSIONS.

UNION COUNTY IMPROVEMENT **AUTHORITY**

Checked By: JM / SH


UNION COUNTY GOVERNMENT COMPLEX 81 & 93 WEST GRAND STREET CITY OF ELIZABETH NEW JERSEY, 07202 Drawing Information: Project No: 20.072 Drawn By: JB / AV / PC

Sheet Name: **BUILDING NO. 1 - LEVEL 0 -**UNDERGROUND FLOOR

REFLECTED CEILING PLAN


A1-200

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2 SLATTED SOFFIT PATTERN TYPICAL AT LOBBY CEILING TYPE ACT-5 SCALE: 3" = 1'-0"

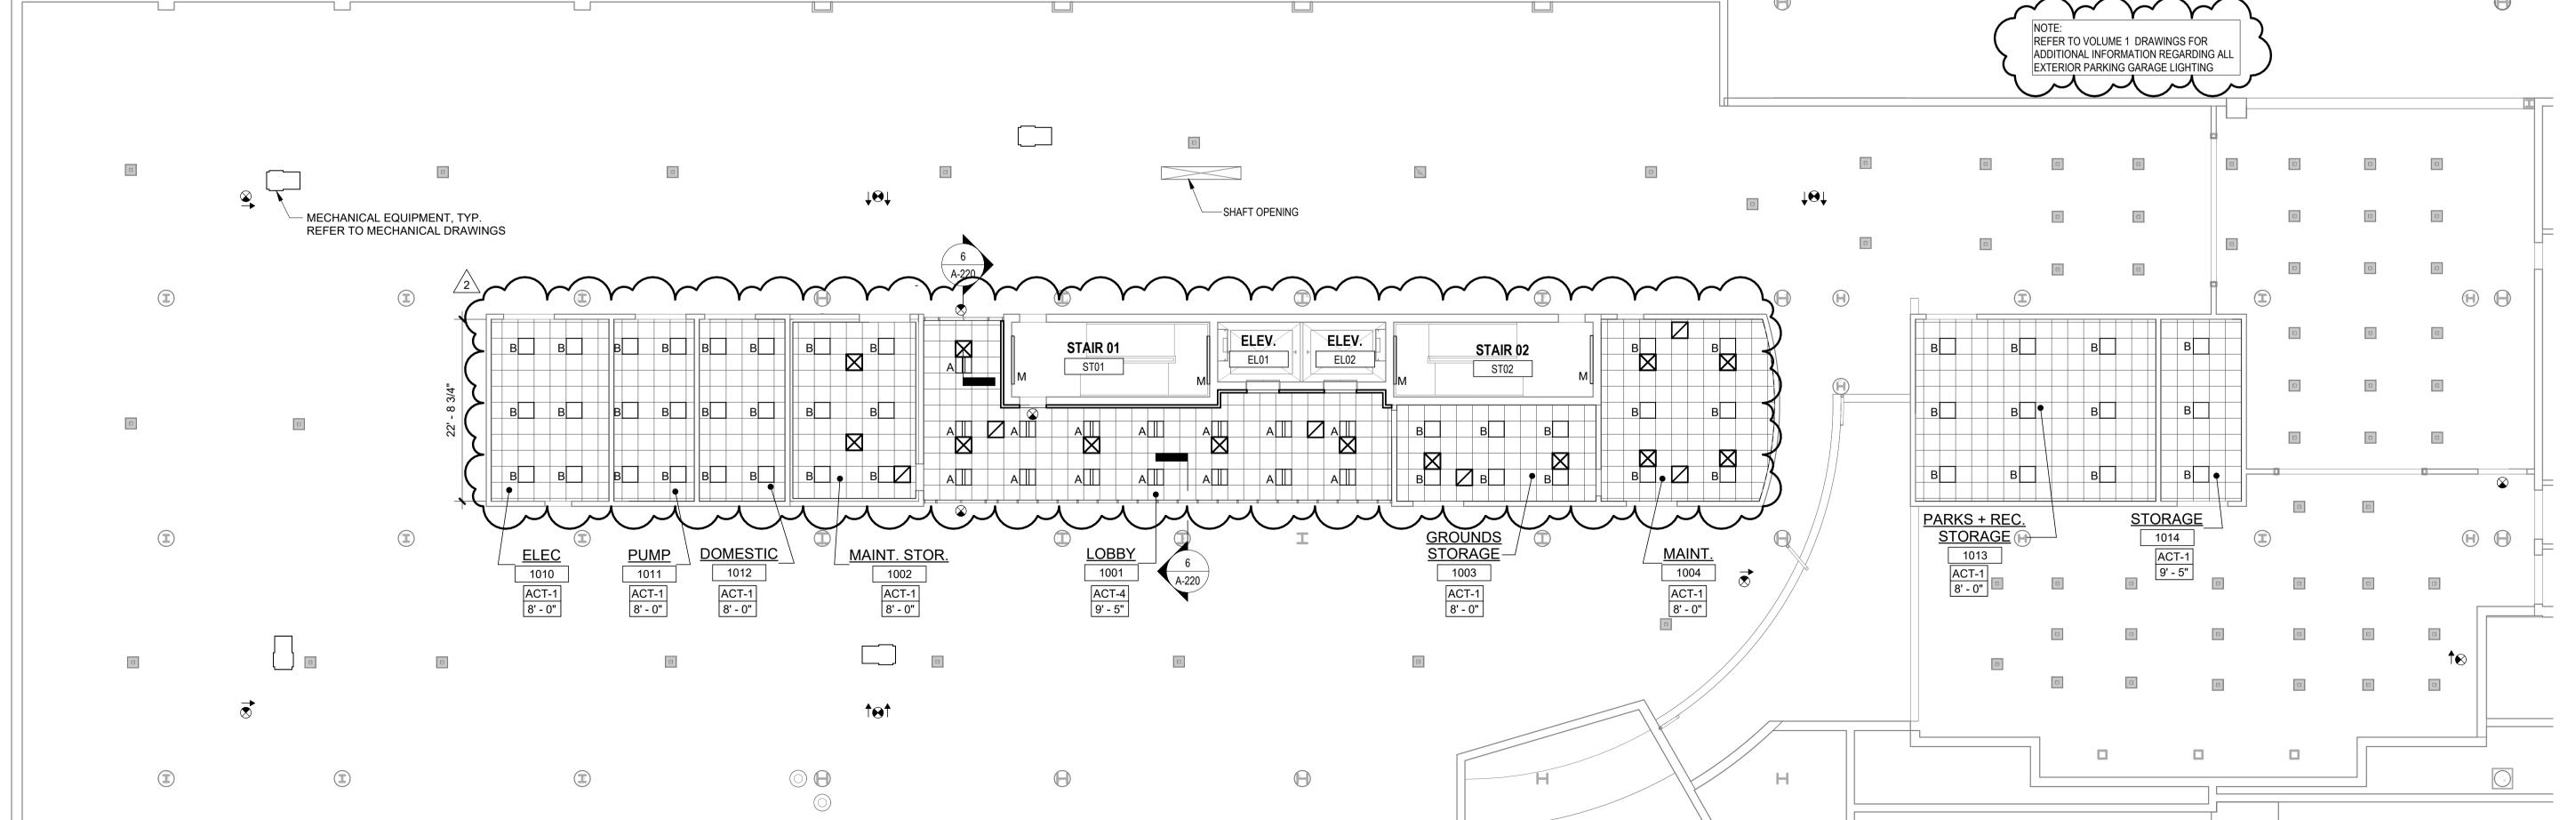2. INTERGRATED LIGHT FIXTURE ONLY TO OCCUR AT DB4 LOCATIONS. REFER TO RCP FOR APPROXIMATE LOCATION AND QUANITITY.



BLDG 1 - LEVEL 1 - GROUND FLOOR REFLECTED CEILING PLAN SCALE: 1/8" = 1'-0"

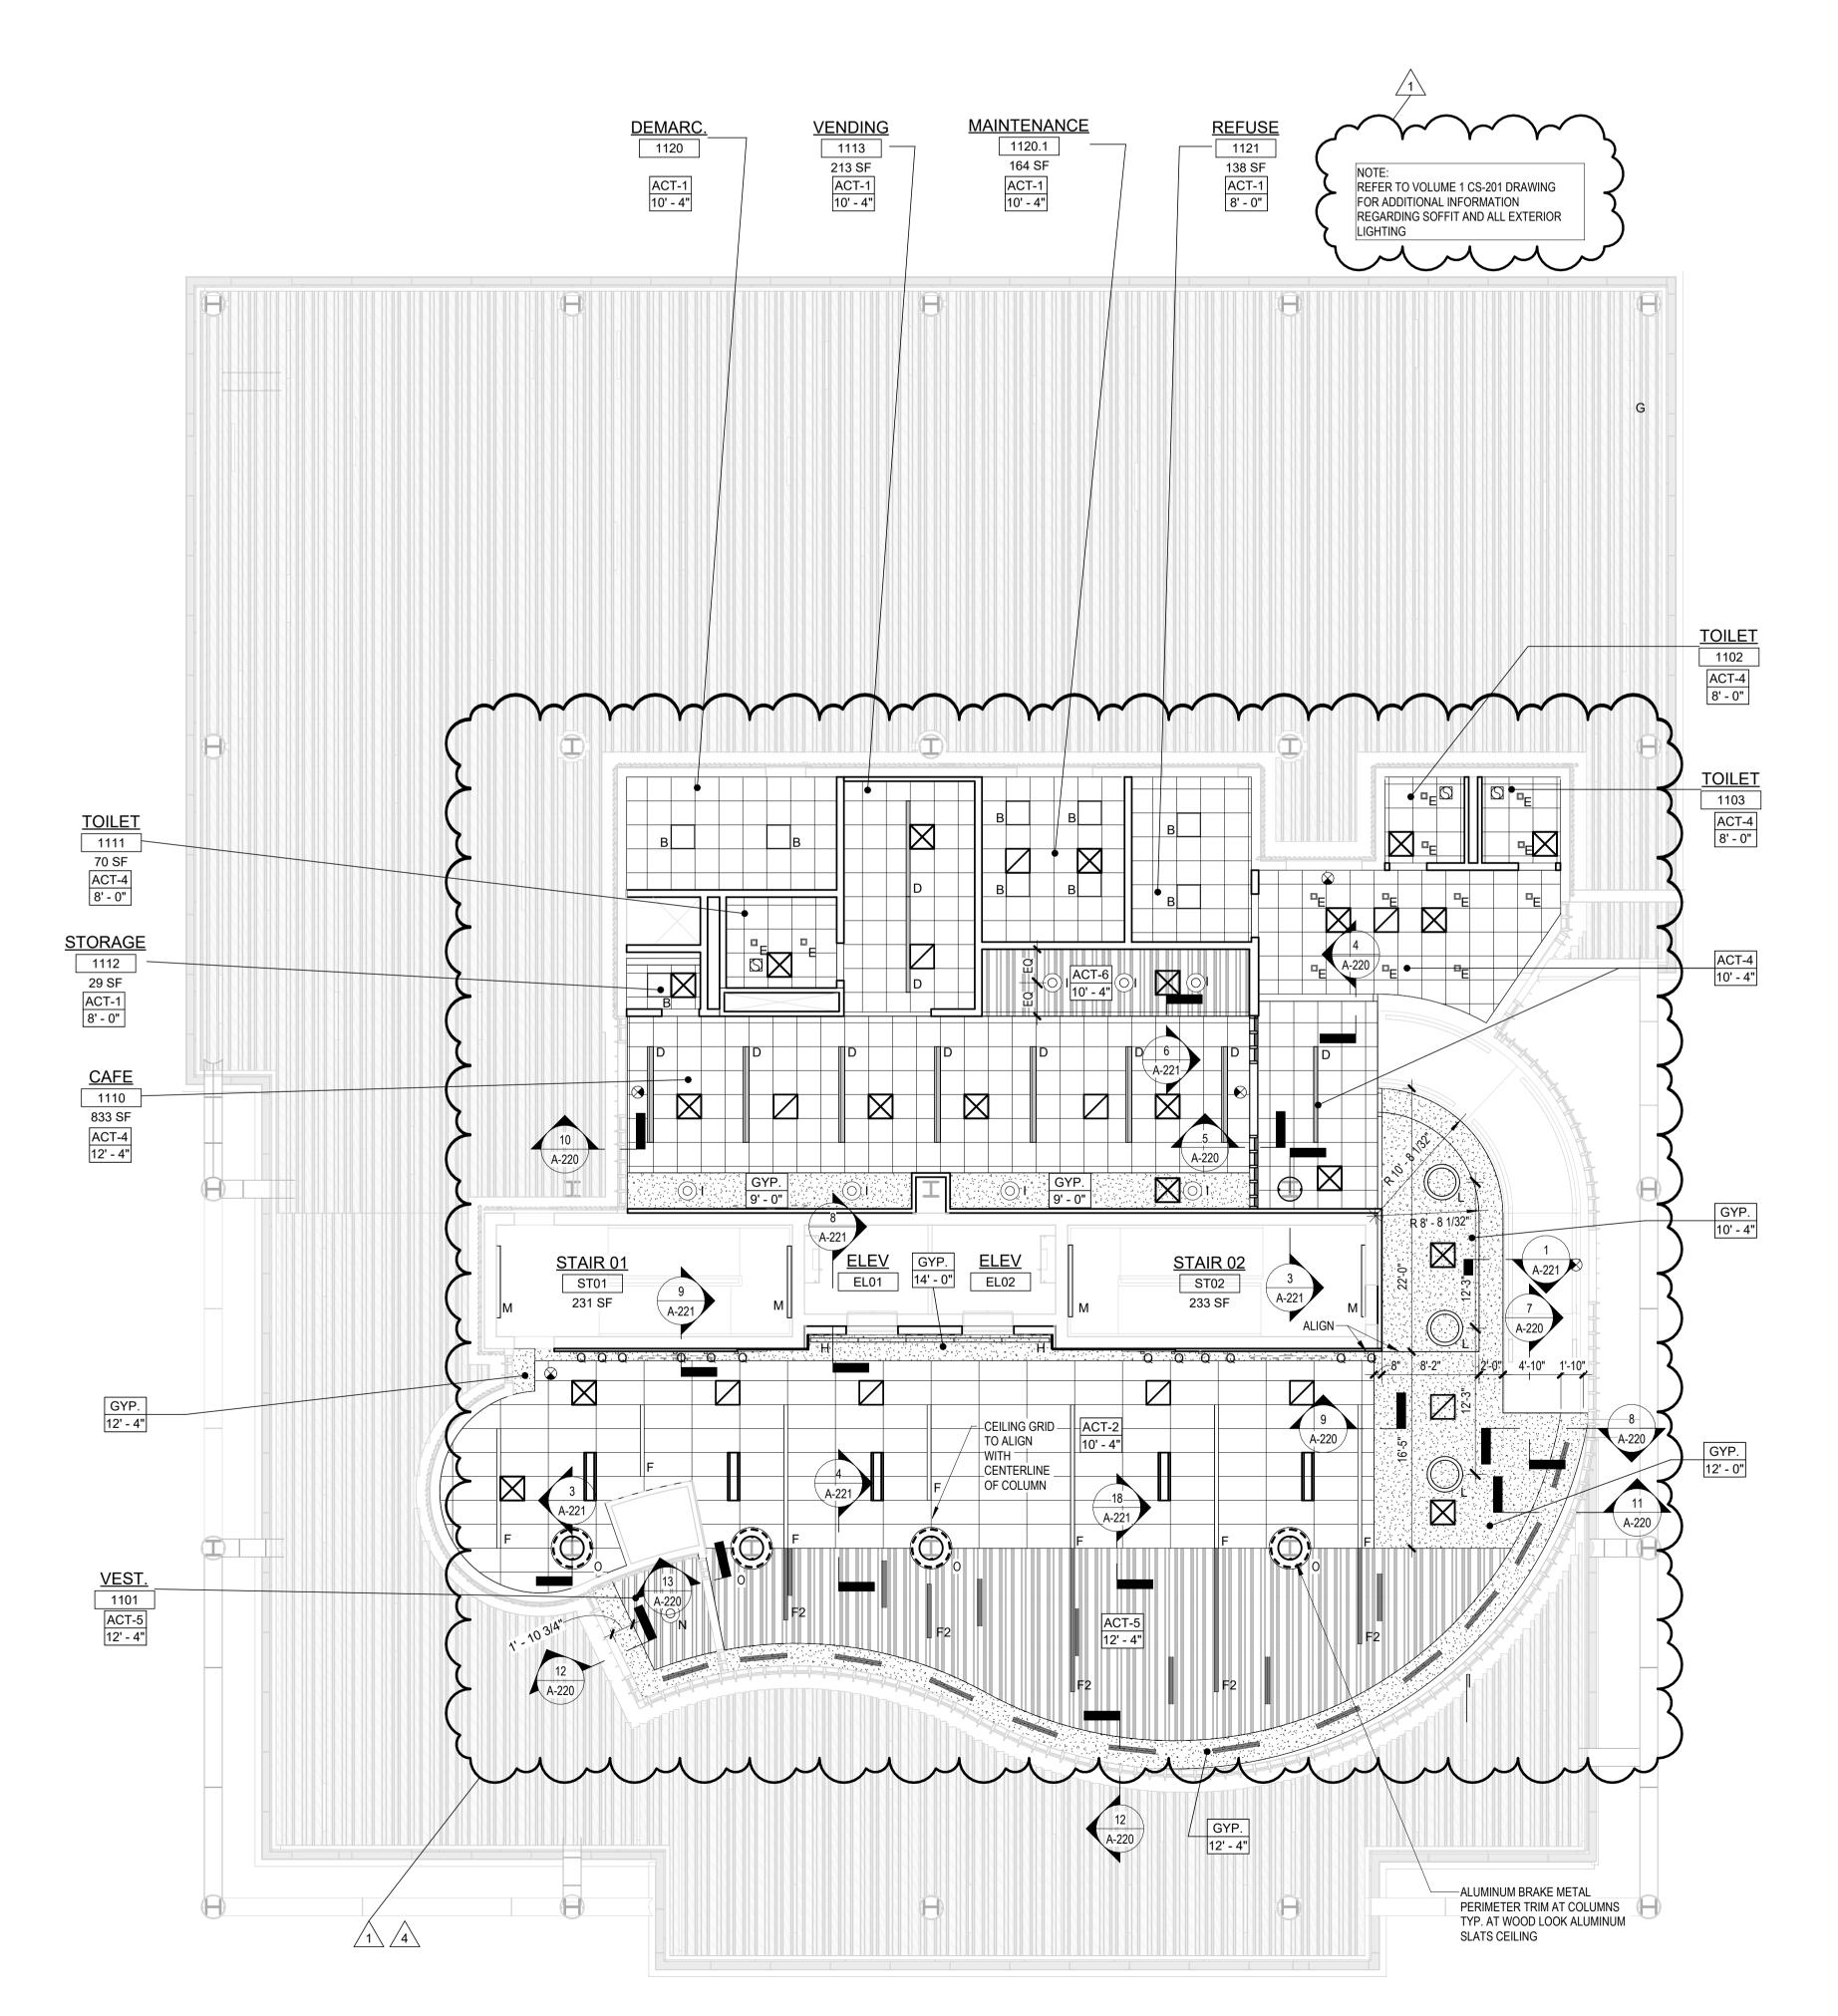REFLECTED CEILING PLAN NOTES:

- A. BORDERS AT LAY-IN ACOUSTICAL CEILING PANELS SHALL BE CUT TO MATCH FACTORY EDGE PROFILE. NO EXPOSED FASTENERS SHALL BE PERMITTED INCLUDING POP RIVETS AND TAPPETS.
- B. HEIGHT OF CEILINGS SHALL BE MEASURED FROM TOP OF SLAB TO FINISH FACE OF GWB OR FACE OF CEILING GRID AS INDICATED ON THE REFLECTED CEILING PLAN, UON.
- C. ALL LIGHT FIXTURES ARE TO BE INSTALLED IN ACCORDANCE WITH THE ARCHITECTURAL REFLECTED CEILING PLAN. ARCHITECT TO REVIEW CEILING LAYOUT INCLUDING BULKHEADS AND GRID PRIOR TO INSTALLATION.
- D. LIGHT FIXTURES TYPES SHOWN ON ARCHITECTURAL REFLECTED CEILING PLANS ARE NOTED FOR QUANTITIES AND LOCATIONS ONLY. SEE ELECTRICAL DRAWINGS FOR ADDITIONAL INFORMATION REGARDING SPECIFICATIONS, SWITCHING, EXIT LIGHTS, EMERGENCY LIGHTING, LIFE SAFETY EQUIPMENT AND CIRCUITING.
- E. MECHANICAL INFORMATION SHOWN ON THIS PLAN IS FOR REFERENCE ONLY, SEE MECHANICAL DRAWINGS FOR DIFFUSER LOCATIONS AND FOR ADDITIONAL INFORMATION REGARDING ALL HVAC EQUIPMENT INCLUDING HVAC REGISTERS, GRILLS, ETC.
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- I. ALL ACOUSTICAL TILE CEILINGS SHALL BE CENTERED WITHIN EACH ROOM U.O.N. J. ALL FLUSH MOUNTED LIGHT FIXTURES MOUNTED WITHIN A GYPSUM BOARD CEILING SHALL BE FITTED WITH FLUSH TRIM.
- K. WHERE DUCTWORK, CONDUIT, AND PIPING MUST CROSS OPEN CEILINGS, ALL WORK SHALL BE EXECUTED TO PRESENT A NEAT AND MINIMAL APPURTENANCE:
- L. ALL EXPOSED WORK SHALL RUN PARALLEL OR PERPENDICULAR TO STRUCTURE, WITH 90 DEGREE BENDS.
- M. LOCATE WORK SO AS TO MINIMIZE EXTENT EXPOSED. LOCATE WORK AS CLOSE AS POSSIBLE TO ADJACENT WALLS OR CEILINGS PLANES.

TO MATCH CEILING COLOR; SEE FINISH SCHEDULE.

- N. PROVIDE ADDITIONAL STRUT SUPPORT SYSTEM TO SUPPORT FIXTURES WHERE LIGHT FIXTURES ARE NOT MOUNTED BELOW STRUCTURAL MEMBERS-DO NOT MOUNT TO ROOF
- O. WHERE EXPOSED STRUCTURE IS INDICATED, ALL EXPOSED ROOF DECK, STRUCTURAL STEEL, CONCRETE BEAMS & DECK, PIPES, DUCTS, CONDUITS, ETC. SHALL BE PAINTED
- P. DOWNLIGHTS SHALL BE SYMMETRICALLY CENTERED IN ACOUSTICAL CEILING TILE AND GYPSUM BOARD CEILINGS U.O.N.
- Q. PROVIDE SOFFIT TRANSITIONS BETWEEN ACT CEILINGS AND GYPSUM BOARD CEILINGS
- R. FURNISH AN INSTALL ACCESS DOORS IN GYP. BD. CEILINGS AS REQUIRED TO PROVIDE ACCESS TO ABOVE-CEILINGS VAV BOXES, DAMPERS, VALVES, EQUIPMENT, ETC. SEE MEP DRAWINGS FOR LOCATIONS AND SPECIFICATIONS, COORDINATE FINAL LOCATIONS WITH DESIGNER PRIOR TO INSTALLATION.
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- T. SEE SPECIFICATIONS FOR ADDITIONAL INFORMATION REGARDING CEILING TYPES.
- V. ALL EXTERIOR WINDOWS WILL HAVE MANUAL ROLLER SHADES. REFER TO

U. SEE A-220 SERIES DRAWINGS FOR TYPICAL CEILING DETAILS, U.O.N.

- W. ALL TRAINING ROOMS AND COMMISSIONER MEETING ROOM WILL HAVE POWERED ROLLER SHADES WITH BOTH SOLAR AND BLACKOUT CAPABILITY TO REFER TO
- X. ALL GYP. BOARD SOFFITS AND FASCIAS TO BE PAINTED (PNT-2) U.O.N.

RCP LEGEND				
Room name	ROOM NAME ROOM NUMBER	~		
ACT-1 10'-0"	CEILING TYPE CEILING HEIGHT			
	GYPSUM BOARD CEILING			
	2' BY 2' SUSPENDED CEILING GRID, CEILING HEIGHT INDICATED ON PLANS, GRID TO BE CENTERED IN AREA U.O.N.	7		
	4' BY 4' SUSPENDED CEILING GRID, CEILING HEIGHT INDICATED ON PLANS, GRID TO BE CENTERED IN AREA U.O.N.	\langle		
	HVAC - RETURN			
\boxtimes	HVAC - SUPPLY	1		
	HVAC - LINEAR SUPPLY	ノ		
	HVAC - BATHROOM EXHAUST FAN	Z		
Α []]	2'-0" X 2'-0" RECESSED TROFFE CEIING LIGHT FIXTURE (TYPE A) @ PRIVATE OFFICES	\downarrow		
В	2'-0" X 2'-0" RECESSED CEIING LIGHT FIXTURE (TYPE B) @ UTILITIES	5		
C • •	2" x VARYING LENGTH CEILING HUNG PENDANT LIGHT FIXTURE (TYPE C) @ OPEN OFFICES MOUNTING HEIGHT - 8'-0" A.F.F.	\langle		
D	2" x 8'-0" RECESSED CEILING LIGHT FIXTURE (TYPE D)	egthinspace = egt		
D2	2" x 4'-0" RECESSED CEILING LIGHT FIXTURE (TYPE D2)	5		
E º	4" SQUARE RECESSED DOWNLIGHT FIXTURE (TYPE E)	$ \langle \rangle $		
F	RECESSED DIRECT LINEAR FIXTURE, VARYING LENGTHS (TYPE F)			

FIXTURE, VARYING LENGTHS (TYPE F2) 4'-0" RECESSED LINEAR LIGHT FIXTURE (TYPE G) LINEAR WALL GRAZER LIGHT (TYPE H) DECORATIVE ROUND SUSPENDED PENDANT LIGHT (TYPE I) AT CAFE

LINEAR DIRECT/INDIRECT PENDANT

DECORATIVE ROUND SUSPENDED

PENDANT LIGHT (TYPE J)

LED ADJUSTABLE SPOT LIGHT FIXTURE (TYPE K) 24" DIAMETER RING SUSPENDED PENDANT LIGHT (TYPE L)

54" DIAMETER RING SUSPENDED PENDANT LIGHT (TYPE L2

SPECIFICATIONS AND A-220 SERIES DRAWINGS FOR LOCATION AND DETAILS.

6'-0" LINEAR SURFACE WALL MOUNT LIGHT FIXTURE (TYPE M) MOUNTING HEIGHT - 8'-0" ABOVE LANDING **KEY PLAN:** TO **⊈** OF FIXTURE AT EGRESS STAIRS MOUNTING HEIGHT - 7'-4" ABOVE LANDING TO € OF FIXTURE AT E.M.R. DECORATIVE ROUND SUSPENDED PENDANT LIGHT WITHIN VESTIBULE COVE LIGHTING AT COLUMN (TYPE O) LED TAPE LIGHT AT COVE CEILING VERTICAL LINEAR FIXTURE INTEGRATED INTO WOOD SLAT WALL SYSTEM (TYPE Q) SURFACE MOUNTED ROUND

DECORATIVE FIXTURE (TYPE R) @ BLDG. 1 - COMMISSIONER SURFACE MOUNTED RING FIXTURE

DECORATIVE BELL PENDANT ABOVE THE SOFFIT (TYPE T) 6" CEILING DOWNLIGHT RECCESSED CAN EXIT SIGN FA CEILING MOUNTED SPEAKER & STROBE

FA CEILING MOUNTED STROBE SMOKE DETECTOR 12" x 12" ACCESS DOOR MS E==== MOTORIZED SHADES

ARCHITECTURE FOR CHANGE

15 Bethany Street • New Brunswick, NJ 08901 • T: 732.249.6242

DO NOT SCALE. DRAWING MAY BE PRINTED AT REDUCED SCALE. CONSULT WITH ARCHITECT FOR DIMENSIONS.

UNION COUNTY IMPROVEMENT

UNION COUNTY GOVERNMENT

81 & 93 WEST GRAND STREET

AUTHORITY

COMPLEX

CITY OF ELIZABETH NEW JERSEY, 07202

Drawing Information:

Project No: 20.072

Description

12.01.2023 Addendum No. 1

11.08.2023 For Public Bid

2450 W Hunting Park Ave • Philadelphia, PA 19122 • T: 215.634.3400 Jeffrey D. Venezia, AIA NJ RA AI 00827100

No. Date Revisions / Issues

FINISH NOTES:

MANUAL SHADE SYSTEMS
BASIS OF DESIGN

MANUFACTURER: MECHOSHADE PRODUCT: MECHO/5 SYSTEM

COLUMN / BEAM COVER **BASIS OF DESIGN** MANUFACTURER: CENTRIA PRODUCT: COLUMN COVERS SERIES 3000

WOOD LOOK ALUMINUM SLATS VARIED WIDTH + DEPTH **BASIS OF DESIGN** MANUFACTURER: CERTAINTEED PRODUCT: MULTI BOX CONTINOUS REFER TO DETAIL 2 / A1-202 FOR ADDITIONAL INFORMATION

TYPICAL CEILING HEIGHTS (BLDG 1): TYPICAL OPEN OFFICE: 9'-5" A.F.F. (2' x 2' ACT-4) **TYPICAL PRIVATE OFFICE:** TYPICAL CONFERENCE / MEETING ROOM: 9'-5" A.F.F. TYPICAL STORAGE / FILE / COPY ROOM: 8'-0" A.F.F. (2' x 2' ACT-1)

ELEVATOR CORE: 9'-5" / 10'-5" A.F.F. RESTROOMS: 8'-0" A.F.F. (ACT-3 OR ACT-4)

Date: 11.08.2023 Drawn By: JB / AV / PC Checked By: JM / SH Sheet Name: BUILDING NO. 1 - LEVEL 1 -

GROUND FLOOR REFLECTED CEILING PLAN

A1-201

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129 SF 130 SF <u>STORAGE</u> REFER TO VOLUME 1 CS-202 DRAWING / SCANNER 1228 1229 GRAPHICS FOR ADDITIONAL INFORMATION 130 SF REGARDING SOFFIT AND ALL EXTERIOR LIGHTING 1220 236 SF 1221 227 SF ACT-4 9' - 5" 164 SF ACT-4 <u>DINING</u> 1226 1222 130 SF ACT-4 9' - 5" EVENT STORAGE 1227 196 SF ACT-1 8' - 0" <u>COMM</u> DIV. HEAD 1223 1212 130 SF ACT-4 9' - 5" 129 SF ACT-4 9' - 5" OPI DIV. HEAD 1224 130 SF ACT-4 1211 1225 <u>TOILET</u> 132 SF ACT-4 9' - 5" 1205 ACT-3 8' - 0" ARCHIVE STORAGE 1222 115 SF ACT-1 8' - 0" 1/2" REVEALS OF PLASTIC LAMINATE PANELS Z-CLIPPED P -COVE TO GYP BOARD ST01 A-222 1245 64 SF ACT-4 8' - 0" STARTING <u>STORAGE</u> **VESTIBULE** 1246 **COMMISSIONER** CONFERENCE 1242 Line MS 1243 154 SF <u>MEETING</u> LINEAR - AUDIO VISUAL ELEMENTS DESCRIBED HERE ARE NOT THE FULL EXTENT OF A/V <u>RM</u> WORK, THOSE SHOWN HERE INDICATED FOR CRITICAL COORDINATION WITH DIFFUSERS 1240 BETWEEN ACT, OTHER CEILING ELEMENTS. REFER TO BALANCE OF DOCUMENTS FOR FULL TYP. SEE DETAIL EXTENT OF CEILING MOUNTED FIXTURES AND PROVIDE COORDINATION PLAN 3123 SF ◆ BLDG 1 - LEVEL 2 - REFLECTED CEILING PLAN 14/A-221 PRIOR TO INSTALLATION IN THIS ROOM.

REFLECTED CEILING PLAN NOTES:

- A. BORDERS AT LAY-IN ACOUSTICAL CEILING PANELS SHALL BE CUT TO MATCH FACTORY EDGE PROFILE. NO EXPOSED FASTENERS SHALL BE PERMITTED INCLUDING POP RIVETS AND TAPPETS.
- B. HEIGHT OF CEILINGS SHALL BE MEASURED FROM TOP OF SLAB TO FINISH FACE OF GWB OR FACE OF CEILING GRID AS INDICATED ON THE REFLECTED CEILING PLAN, UON. C. ALL LIGHT FIXTURES ARE TO BE INSTALLED IN ACCORDANCE WITH THE ARCHITECTURAL REFLECTED CEILING PLAN. ARCHITECT TO REVIEW CEILING LAYOUT INCLUDING
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- SHALL BE FITTED WITH FLUSH TRIM. K. WHERE DUCTWORK, CONDUIT, AND PIPING MUST CROSS OPEN CEILINGS, ALL WORK
- SHALL BE EXECUTED TO PRESENT A NEAT AND MINIMAL APPURTENANCE: L. ALL EXPOSED WORK SHALL RUN PARALLEL OR PERPENDICULAR TO STRUCTURE, WITH
- 90 DEGREE BENDS. M. LOCATE WORK SO AS TO MINIMIZE EXTENT EXPOSED. LOCATE WORK AS CLOSE AS
- N. PROVIDE ADDITIONAL STRUT SUPPORT SYSTEM TO SUPPORT FIXTURES WHERE LIGHT

POSSIBLE TO ADJACENT WALLS OR CEILINGS PLANES.

- FIXTURES ARE NOT MOUNTED BELOW STRUCTURAL MEMBERS-DO NOT MOUNT TO ROOF
- O. WHERE EXPOSED STRUCTURE IS INDICATED, ALL EXPOSED ROOF DECK, STRUCTURAL STEEL, CONCRETE BEAMS & DECK, PIPES, DUCTS, CONDUITS, ETC. SHALL BE PAINTED TO MATCH CEILING COLOR; SEE FINISH SCHEDULE.
- P. DOWNLIGHTS SHALL BE SYMMETRICALLY CENTERED IN ACOUSTICAL CEILING TILE AND GYPSUM BOARD CEILINGS U.O.N.
- Q. PROVIDE SOFFIT TRANSITIONS BETWEEN ACT CEILINGS AND GYPSUM BOARD CEILINGS R. FURNISH AN INSTALL ACCESS DOORS IN GYP. BD. CEILINGS AS REQUIRED TO PROVIDE ACCESS TO ABOVE-CEILINGS VAV BOXES, DAMPERS, VALVES, EQUIPMENT, ETC. SEE MEP DRAWINGS FOR LOCATIONS AND SPECIFICATIONS, COORDINATE FINAL LOCATIONS WITH DESIGNER PRIOR TO INSTALLATION.
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- T. SEE SPECIFICATIONS FOR ADDITIONAL INFORMATION REGARDING CEILING TYPES.
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- X. ALL GYP. BOARD SOFFITS AND FASCIAS TO BE PAINTED (PNT-2) U.O.N.

		CEILING HEIGHT INDICATED ON PLANS, GRID TO BE CENTERED IN AREA U.O.N.
		HVAC - RETURN
	\boxtimes	HVAC - SUPPLY
•		HVAC - LINEAR SUPPLY
	\bigcirc	HVAC - BATHROOM EXHAUST FAN
A		2'-0" X 2'-0" RECESSED TROFFE CEIING LIGHT FIXTURE (TYPE A) @ PRIVATE OFFICES
В		2'-0" X 2'-0" RECESSED CEIING LIGHT FIXTURE (TYPE B) @ UTILITIES
C •	0	2" x VARYING LENGTH CEILING HUNG PENDANT LIGHT FIXTURE (TYPE C) @ OPEN OFFICES
D===		MOUNTING HEIGHT - 8'-0" A.F.F. 2" x 8'-0" RECESSED CEILING LIGHT
D0 -		FIXTURE (TYPE D) 2" x 4'-0" RECESSED CEILING LIGHT
D2 ⊏		FIXTURE (TYPE D2) 4" SQUARE RECESSED DOWNLIGHT
E		FIXTURE (TYPE E) RECESSED DIRECT LINEAR FIXTURE,
F =		VARYING LENGTHS (TYPE F)
F2 ===		LINEAR DIRECT/INDIRECT PENDANT FIXTURE, VARYING LENGTHS (TYPE F2)
G =		4'-0" RECESSED LINEAR LIGHT FIXTURE (TYPE G)
н =		LINEAR WALL GRAZER LIGHT (TYPE H)
I	0	DECORATIVE ROUND SUSPENDED PENDANT LIGHT (TYPE I) AT CAFE
J	\bigcirc	DECORATIVE ROUND SUSPENDED PENDANT LIGHT (TYPE J)
К		LED ADJUSTABLE SPOT LIGHT FIXTURE (TYPE K)
L		24" DIAMETER RING SUSPENDED PENDANT LIGHT (TYPE L)
L2 ((54" DIAMETER RING SUSPENDED PENDANT LIGHT (TYPE L2
М ===		6'-0" LINEAR SURFACE WALL MOUNT LIGHT FIXTURE (TYPE M) MOUNTING HEIGHT - 8'-0" ABOVE LANDING TO & OF FIXTURE AT EGRESS STAIRS MOUNTING HEIGHT - 7'-4" ABOVE LANDING TO & OF FIXTURE AT E.M.R.
N	(DECORATIVE ROUND SUSPENDED PENDANT LIGHT WITHIN VESTIBULE (TYPE N)
0		COVE LIGHTING AT COLUMN (TYPE O)
P ••		LED TAPE LIGHT AT COVE CEILING
Q	ō	VERTICAL LINEAR FIXTURE INTEGRATED INTO WOOD SLAT WALL SYSTEM (TYPE Q)
R (SURFACE MOUNTED ROUND DECORATIVE FIXTURE (TYPE R) @ BLDG. 1 - COMMISSIONER VESTIBULE
s (SURFACE MOUNTED RING FIXTURE (TYPE S)
Т	o	DECORATIVE BELL PENDANT ABOVE THE SOFFIT (TYPE T)
	0	6" CEILING DOWNLIGHT RECCESSED CAN
	⊗ +	EXIT SIGN FA CEILING MOUNTED SPEAKER & STROBE
	Ľ¶ Ø	FA CEILING MOUNTED SPEAKER & STROBE FA CEILING MOUNTED STROBE
	(S)	SMOKE DETECTOR
		12" x 12" ACCESS DOOR
MS E	=====	MOTORIZED SHADES

Room name ROOM NAME

10'-0"

-ROOM NUMBER

—CEILING TYPE

—CEILING HEIGHT

GYPSUM BOARD CEILING

2' BY 2' SUSPENDED CEILING GRID, CEILING HEIGHT INDICATED ON PLANS,

4' BY 4' SUSPENDED CEILING GRID,

GRID TO BE CENTERED IN AREA U.O.N.

FINISH NOTES:

COLUMN / BEAM COVER BASIS OF DESIGN MANUFACTURER: CENTRIA PRODUCT: COLUMN COVERS SERIES 3000 WOOD LOOK ALUMINUM SLATS VARIED WIDTH + DEPTH BASIS OF DESIGN MANUFACTURER: CERTAINTEED


PRODUCT: MULTI BOX CONTINOUS

PRODUCT: MECHO/5 SYSTEM

REFER TO DETAIL 2 / A1-202 FOR ADDITIONAL INFORMATION MANUAL SHADE SYSTEMS BASIS OF DESIGN MANUFACTURER: MECHOSHADE

TYPICAL CEILING HEIGHTS (BLDG 1):

<u> TYPICAL OPEN OFFICE:</u> 9'-5" A.F.F. (2' x 4' ACT-3) TYPICAL PRIVATE OFFICE: 9'-5" A.F.F. (2' x 2' ACT-4) TYPICAL CONFERENCE / MEETING ROOM: 9'-5" A.F.F. TYPICAL STORAGE / FILE / COPY ROOM: 8'-0" A.F.F. (2' x 2' ACT-1) **ELEVATOR CORE:** 9'-5" / 10'-5" A.F.F. RESTROOMS: 8'-0" A.F.F. (ACT-3 OR ACT-4)

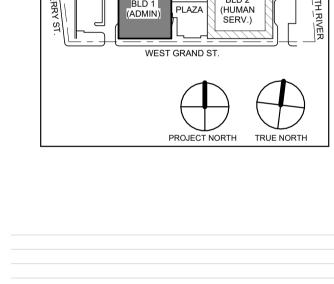

KEY PLAN:

12.22.2023 Addendum No. 4 12.01.2023 Addendum No. 1

No. Date Revisions / Issues

Jeffrey D. Venezia, AIA NJ RA AI 00827100

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UNION COUNTY IMPROVEMENT

AUTHORITY

Project: UNION COUNTY GOVERNMENT COMPLEX 81 & 93 WEST GRAND STREET CITY OF ELIZABETH NEW JERSEY, 07202 Drawing Information: Project No: 20.072


Checked By: JM / SH Sheet Name: **BUILDING NO. 1 - LEVEL 2 -**

REFLECTED CEILING PLAN

Sheet No: A1-202

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Date: 11.08.2023 Drawn By: JB / AV / PC

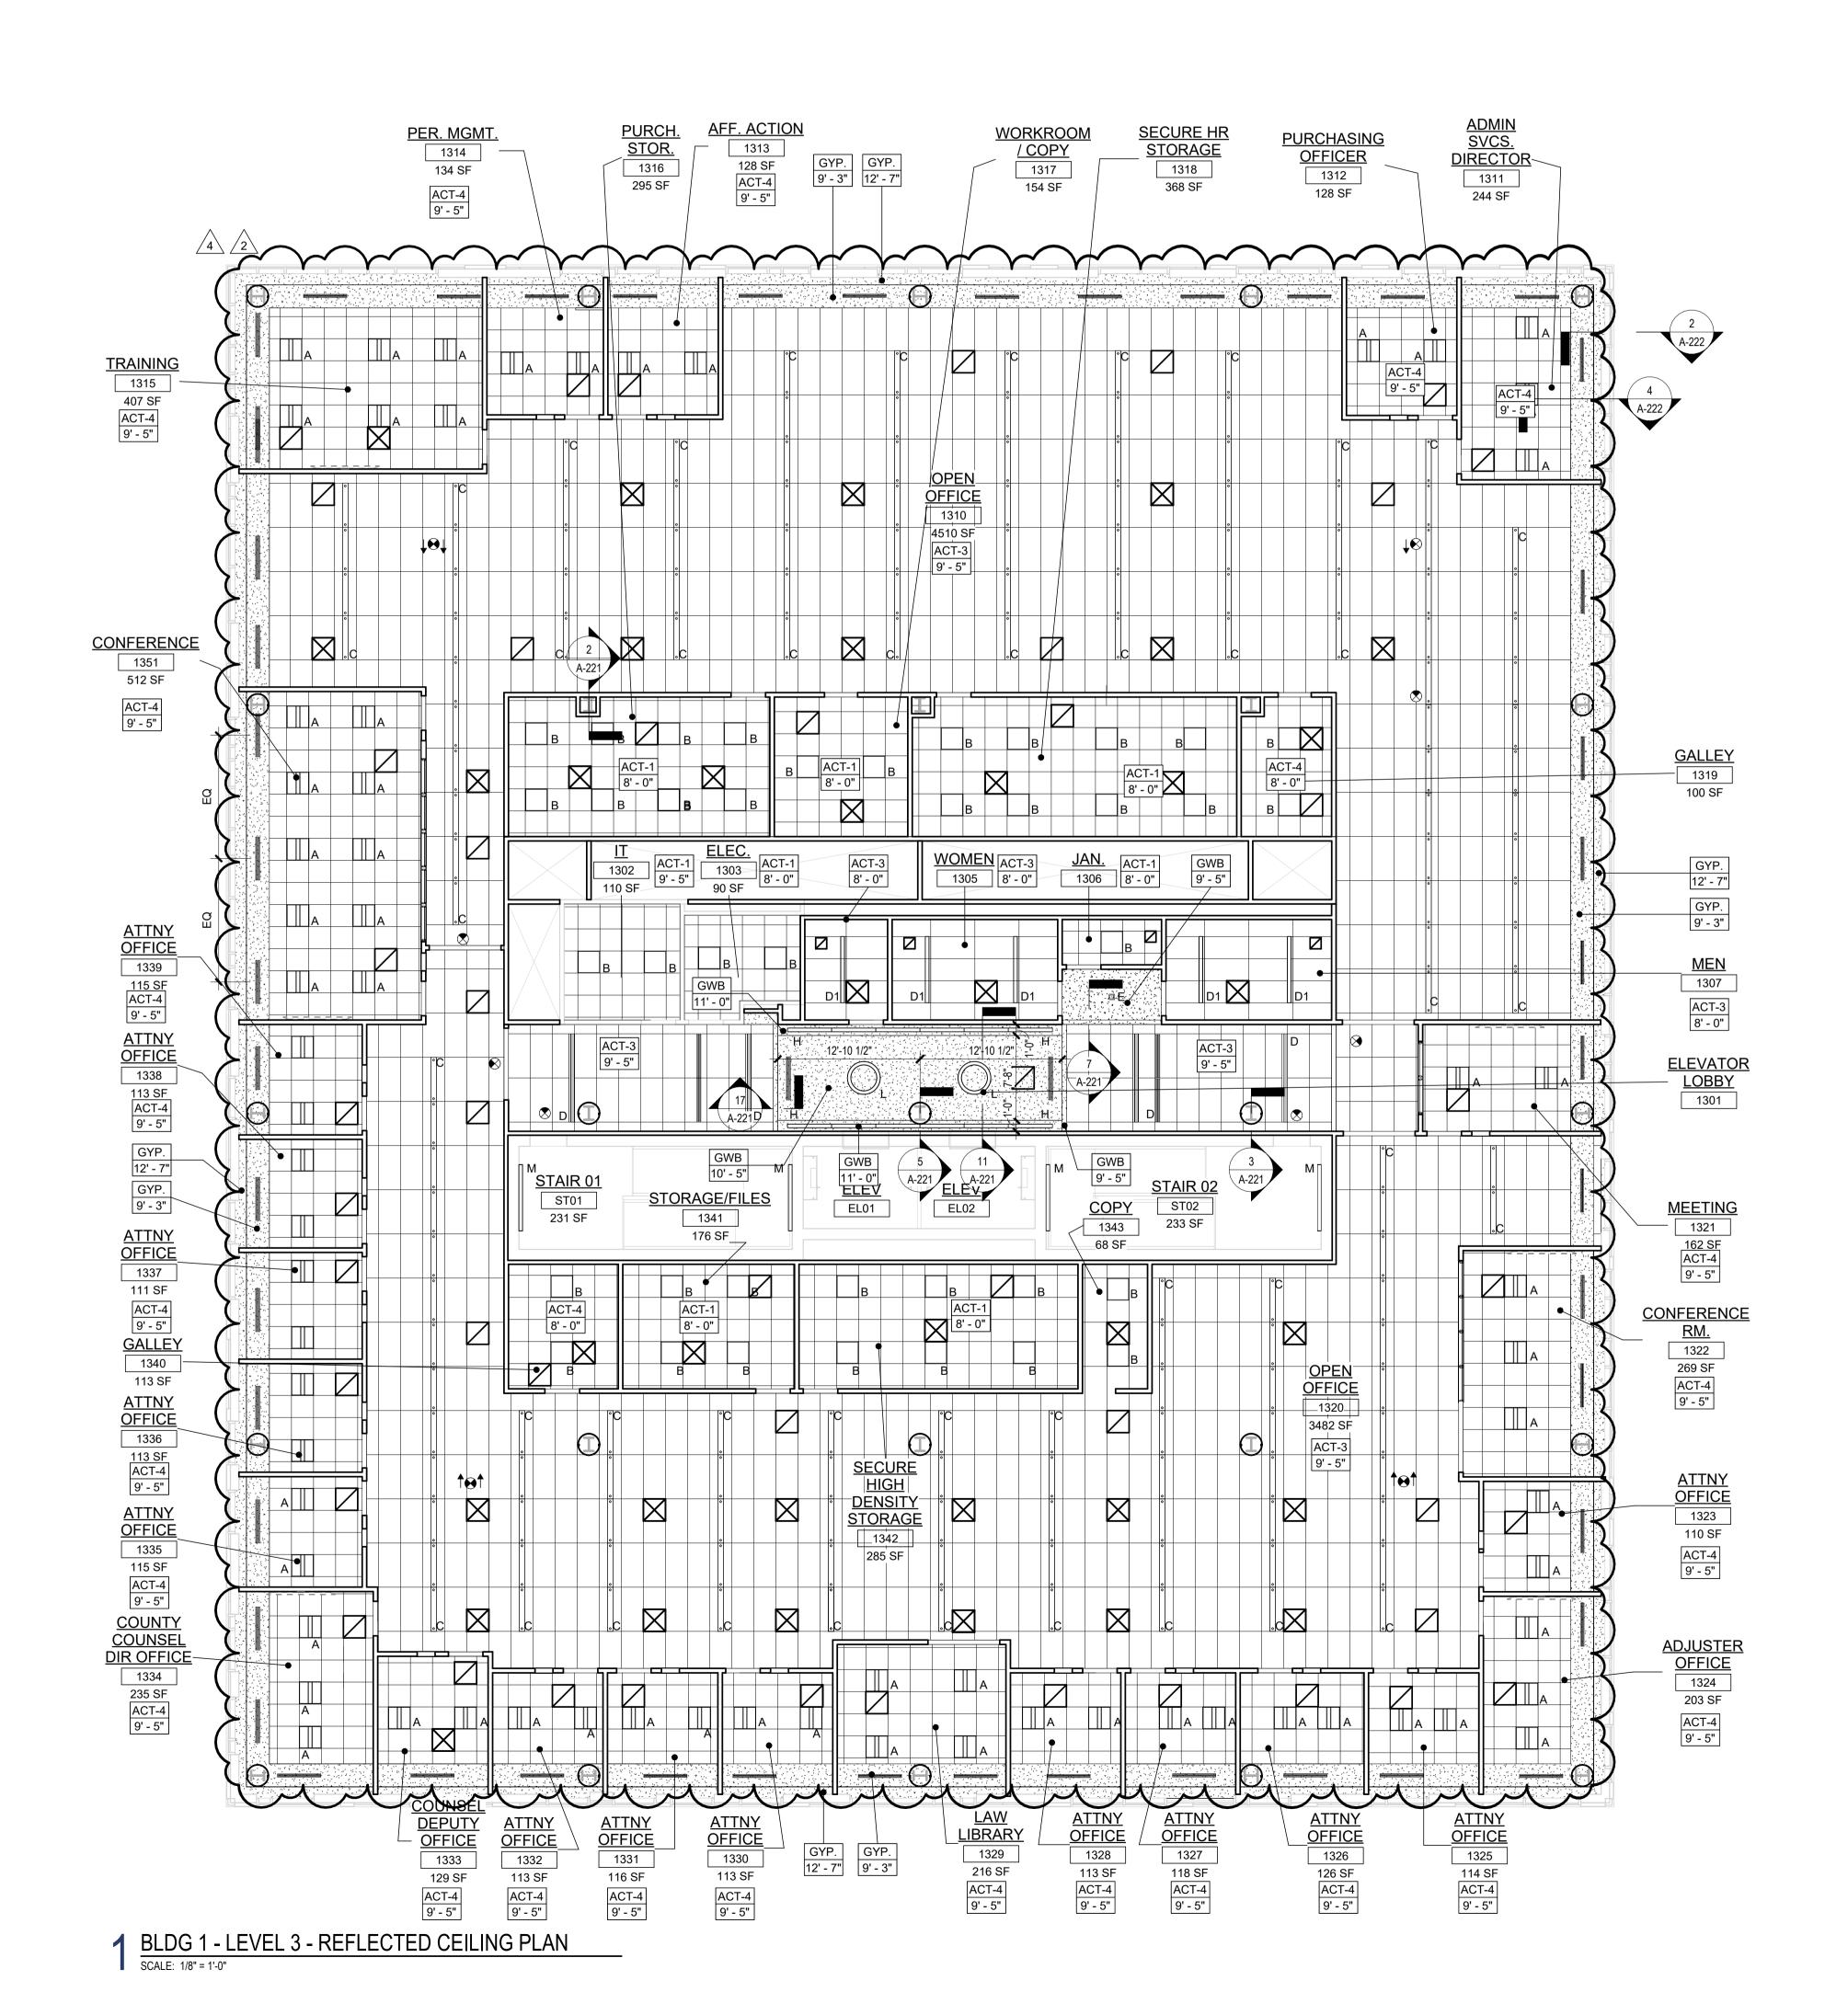

- A. BORDERS AT LAY-IN ACOUSTICAL CEILING PANELS SHALL BE CUT TO MATCH FACTORY EDGE PROFILE. NO EXPOSED FASTENERS SHALL BE PERMITTED INCLUDING POP RIVETS AND TAPPETS.
- B. HEIGHT OF CEILINGS SHALL BE MEASURED FROM TOP OF SLAB TO FINISH FACE OF GWB OR FACE OF CEILING GRID AS INDICATED ON THE REFLECTED CEILING PLAN, UON.
- C. ALL LIGHT FIXTURES ARE TO BE INSTALLED IN ACCORDANCE WITH THE ARCHITECTURAL REFLECTED CEILING PLAN. ARCHITECT TO REVIEW CEILING LAYOUT INCLUDING BULKHEADS AND GRID PRIOR TO INSTALLATION.
- NOTED FOR QUANTITIES AND LOCATIONS ONLY. SEE ELECTRICAL DRAWINGS FOR ADDITIONAL INFORMATION REGARDING SPECIFICATIONS, SWITCHING, EXIT LIGHTS, EMERGENCY LIGHTING, LIFE SAFETY EQUIPMENT AND CIRCUITING.

LIGHT FIXTURES TYPES SHOWN ON ARCHITECTURAL REFLECTED CEILING PLANS ARE

- E. MECHANICAL INFORMATION SHOWN ON THIS PLAN IS FOR REFERENCE ONLY, SEE MECHANICAL DRAWINGS FOR DIFFUSER LOCATIONS AND FOR ADDITIONAL INFORMATION REGARDING ALL HVAC EQUIPMENT INCLUDING HVAC REGISTERS, GRILLS, ETC.
- F. DIMENSIONED LIGHT FIXTURES ARE FROM FINISHED FACE OF PARTITIONS TO CENTERLINE OF FIXTURE TO CENTERLINE OF FIXTURE. ANY DISCREPANCIES WITH LOCATION OF LIGHT FIXTURES, SWITCHES, THERMOSTATS, OR DIFFUSERS BETWEEN ARCHITECTURAL AND ENGINEERING DRAWINGS SHALL BE CLARIFIED WITH THE ARCHITECT PRIOR TO INSTALLATION.
- G. THE CONTRACTOR SHALL SUBMIT COORDINATION DRAWINGS THAT INCORPORATES ALL TRADES AS REQUIRED BY THE SPECIFICATIONS.
- H. LIGHT FIXTURES, DIFFUSERS, GRILLES AND ALL OTHER SYSTEM DEVICES SHALL BE LOCATED CENTERED ON CEILING TILES, U.O.N.
- I. ALL ACOUSTICAL TILE CEILINGS SHALL BE CENTERED WITHIN EACH ROOM U.O.N. J. ALL FLUSH MOUNTED LIGHT FIXTURES MOUNTED WITHIN A GYPSUM BOARD CEILING
- SHALL BE FITTED WITH FLUSH TRIM. K. WHERE DUCTWORK, CONDUIT, AND PIPING MUST CROSS OPEN CEILINGS, ALL WORK

SHALL BE EXECUTED TO PRESENT A NEAT AND MINIMAL APPURTENANCE:

- L. ALL EXPOSED WORK SHALL RUN PARALLEL OR PERPENDICULAR TO STRUCTURE, WITH
- M. LOCATE WORK SO AS TO MINIMIZE EXTENT EXPOSED. LOCATE WORK AS CLOSE AS POSSIBLE TO ADJACENT WALLS OR CEILINGS PLANES.
- N. PROVIDE ADDITIONAL STRUT SUPPORT SYSTEM TO SUPPORT FIXTURES WHERE LIGHT FIXTURES ARE NOT MOUNTED BELOW STRUCTURAL MEMBERS-DO NOT MOUNT TO ROOF
- O. WHERE EXPOSED STRUCTURE IS INDICATED, ALL EXPOSED ROOF DECK, STRUCTURAL STEEL, CONCRETE BEAMS & DECK, PIPES, DUCTS, CONDUITS, ETC. SHALL BE PAINTED TO MATCH CEILING COLOR; SEE FINISH SCHEDULE.
- P. DOWNLIGHTS SHALL BE SYMMETRICALLY CENTERED IN ACOUSTICAL CEILING TILE AND GYPSUM BOARD CEILINGS U.O.N.
- Q. PROVIDE SOFFIT TRANSITIONS BETWEEN ACT CEILINGS AND GYPSUM BOARD CEILINGS
- R. FURNISH AN INSTALL ACCESS DOORS IN GYP. BD. CEILINGS AS REQUIRED TO PROVIDE ACCESS TO ABOVE-CEILINGS VAV BOXES, DAMPERS, VALVES, EQUIPMENT, ETC. SEE MEP DRAWINGS FOR LOCATIONS AND SPECIFICATIONS, COORDINATE FINAL LOCATIONS WITH DESIGNER PRIOR TO INSTALLATION.
- S. ALL GYP. BD. CEILINGS IN WET AREAS SUCH AS TOILET ROOMS, BATHROOMS, AND JANITORS CLOSETS SHALL RECEIVE MOISTURE AND MOLD RESISTANT GYP. BD. AS PER SPECIFICATIONS.
- T. SEE SPECIFICATIONS FOR ADDITIONAL INFORMATION REGARDING CEILING TYPES.
- U. SEE A-220 SERIES DRAWINGS FOR TYPICAL CEILING DETAILS, U.O.N.
- V. ALL EXTERIOR WINDOWS WILL HAVE MANUAL ROLLER SHADES. REFER TO SPECIFICATIONS AND A-220 SERIES DRAWINGS FOR LOCATION AND DETAILS
- W. ALL TRAINING ROOMS AND COMMISSIONER MEETING ROOM WILL HAVE POWERED ROLLER SHADES WITH BOTH SOLAR AND BLACKOUT CAPABILITY TO REFER TO SPECIFICATIONS.
- X. ALL GYP. BOARD SOFFITS AND FASCIAS TO BE PAINTED (PNT-2) U.O.N.

		4' BY 4' SUSPENDED CEILING GRID, CEILING HEIGHT INDICATED ON PLANS, GRID TO BE CENTERED IN AREA U.O.N.
		HVAC - RETURN
	\boxtimes	HVAC - SUPPLY
		HVAC - LINEAR SUPPLY
	\bigcirc	HVAC - BATHROOM EXHAUST FAN
Α		2'-0" X 2'-0" RECESSED TROFFE CEIING LIGHT FIXTURE (TYPE A) @ PRIVATE OFFICES
В		2'-0" X 2'-0" RECESSED CEIING LIGHT FIXTURE (TYPE B) @ UTILITIES
C D	0 0	2" x VARYING LENGTH CEILING HUNG PENDANT LIGHT FIXTURE (TYPE C) @ OPEN OFFICES MOUNTING HEIGHT - 8'-0" A.F.F. 2" x 8'-0" RECESSED CEILING LIGHT FIXTURE (TYPE D)
D2		2" x 4'-0" RECESSED CEILING LIGHT FIXTURE (TYPE D2)
E F =		4" SQUARE RECESSED DOWNLIGHT FIXTURE (TYPE E) RECESSED DIRECT LINEAR FIXTURE, VARYING LENGTHS (TYPE F)
F2 ⊏		LINEAR DIRECT/INDIRECT PENDANT FIXTURE, VARYING LENGTHS (TYPE F2)
G		4'-0" RECESSED LINEAR LIGHT FIXTURE (TYPE G)
Н		LINEAR WALL GRAZER LIGHT (TYPE H)
I	(DECORATIVE ROUND SUSPENDED PENDANT LIGHT (TYPE I) AT CAFE
J	\bigcirc	DECORATIVE ROUND SUSPENDED PENDANT LIGHT (TYPE J)
K		LED ADJUSTABLE SPOT LIGHT FIXTURE (TYPE K)
L		24" DIAMETER RING SUSPENDED PENDANT LIGHT (TYPE L)
L2 (54" DIAMETER RING SUSPENDED PENDANT LIGHT (TYPE L2
M =		6'-0" LINEAR SURFACE WALL MOUNT LIGHT FIXTURE (TYPE M) MOUNTING HEIGHT - 8'-0" ABOVE LANDING TO € OF FIXTURE AT EGRESS STAIRS MOUNTING HEIGHT - 7'-4" ABOVE LANDING TO € OF FIXTURE AT E.M.R.
N	0	DECORATIVE ROUND SUSPENDED PENDANT LIGHT WITHIN VESTIBULE (TYPE N)
0	\bigcirc	COVE LIGHTING AT COLUMN (TYPE O)
Р		LED TAPE LIGHT AT COVE CEILING
Q	b	VERTICAL LINEAR FIXTURE INTEGRATED INTO WOOD SLAT WALL SYSTEM (TYPE Q)
R		SURFACE MOUNTED ROUND DECORATIVE FIXTURE (TYPE R) @ BLDG. 1 - COMMISSIONER VESTIBULE
S		SURFACE MOUNTED RING FIXTURE (TYPE S)
Т	o	DECORATIVE BELL PENDANT ABOVE THE SOFFIT (TYPE T)
	0	6" CEILING DOWNLIGHT RECCESSED CAN
	⊗ ⁺ F • (S)	EXIT SIGN FA CEILING MOUNTED SPEAKER & STROBE FA CEILING MOUNTED STROBE SMOKE DETECTOR
		12" x 12" ACCESS DOOR
		MOTORIZED SHADES

Room name ROOM NAME

-ROOM NUMBER

—CEILING TYPE

—CEILING HEIGHT

GYPSUM BOARD CEILING

2' BY 2' SUSPENDED CEILING GRID, CEILING HEIGHT INDICATED ON PLANS,

4' BY 4' SUSPENDED CEILING GRID.

GRID TO BE CENTERED IN AREA U.O.N.

FINISH NOTES:

COLUMN / BEAM COVER BASIS OF DESIGN MANUFACTURER: CENTRIA PRODUCT: COLUMN COVERS SERIES 3000

BASIS OF DESIGN MANUFACTURER: CERTAINTEED PRODUCT: MULTI BOX CONTINOUS REFER TO DETAIL 2 / A1-202 FOR ADDITIONAL INFORMATION

WOOD LOOK ALUMINUM SLATS VARIED WIDTH + DEPTH

MANUAL SHADE SYSTEMS
BASIS OF DESIGN MANUFACTURER: MECHOSHADE PRODUCT: MECHO/5 SYSTEM

RESTROOMS:

TYPICAL CEILING HEIGHTS (BLDG 1):

YPICAL OPEN OFFICE: 9'-5" A.F.F. (2' x 4' AC1-3) TYPICAL PRIVATE OFFICE: 9'-5" A.F.F. (2' x 2' ACT-4) TYPICAL CONFERENCE / MEETING ROOM: 9'-5" A.F.F. TYPICAL STORAGE / FILE / COPY ROOM: 8'-0" A.F.F. (2' x 2' ACT-1) ELEVATOR CORE: 9'-5" / 10'-5" A.F.F.

8'-0" A.F.F. (ACT-3 OR ACT-4)

Sheet Name: **BUILDING NO. 1 - LEVEL 3 -**REFLECTED CEILING PLAN

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KEY PLAN:

4 12.22.2023 Addendum No. 4 12.08.2023 Addendum No. 2

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UNION COUNTY IMPROVEMENT

UNION COUNTY GOVERNMENT

81 & 93 WEST GRAND STREET

No. Date

Revisions / Issues

Jeffrey D. Venezia, AIA

NJ RÅ AI 00827100

AUTHORITY

COMPLEX

CITY OF ELIZABETH


NEW JERSEY, 07202

Drawing Information:

Project No: 20.072 Date: 11.08.2023 Drawn By: JB / AV / PC

Checked By: JM / SH

A1-203

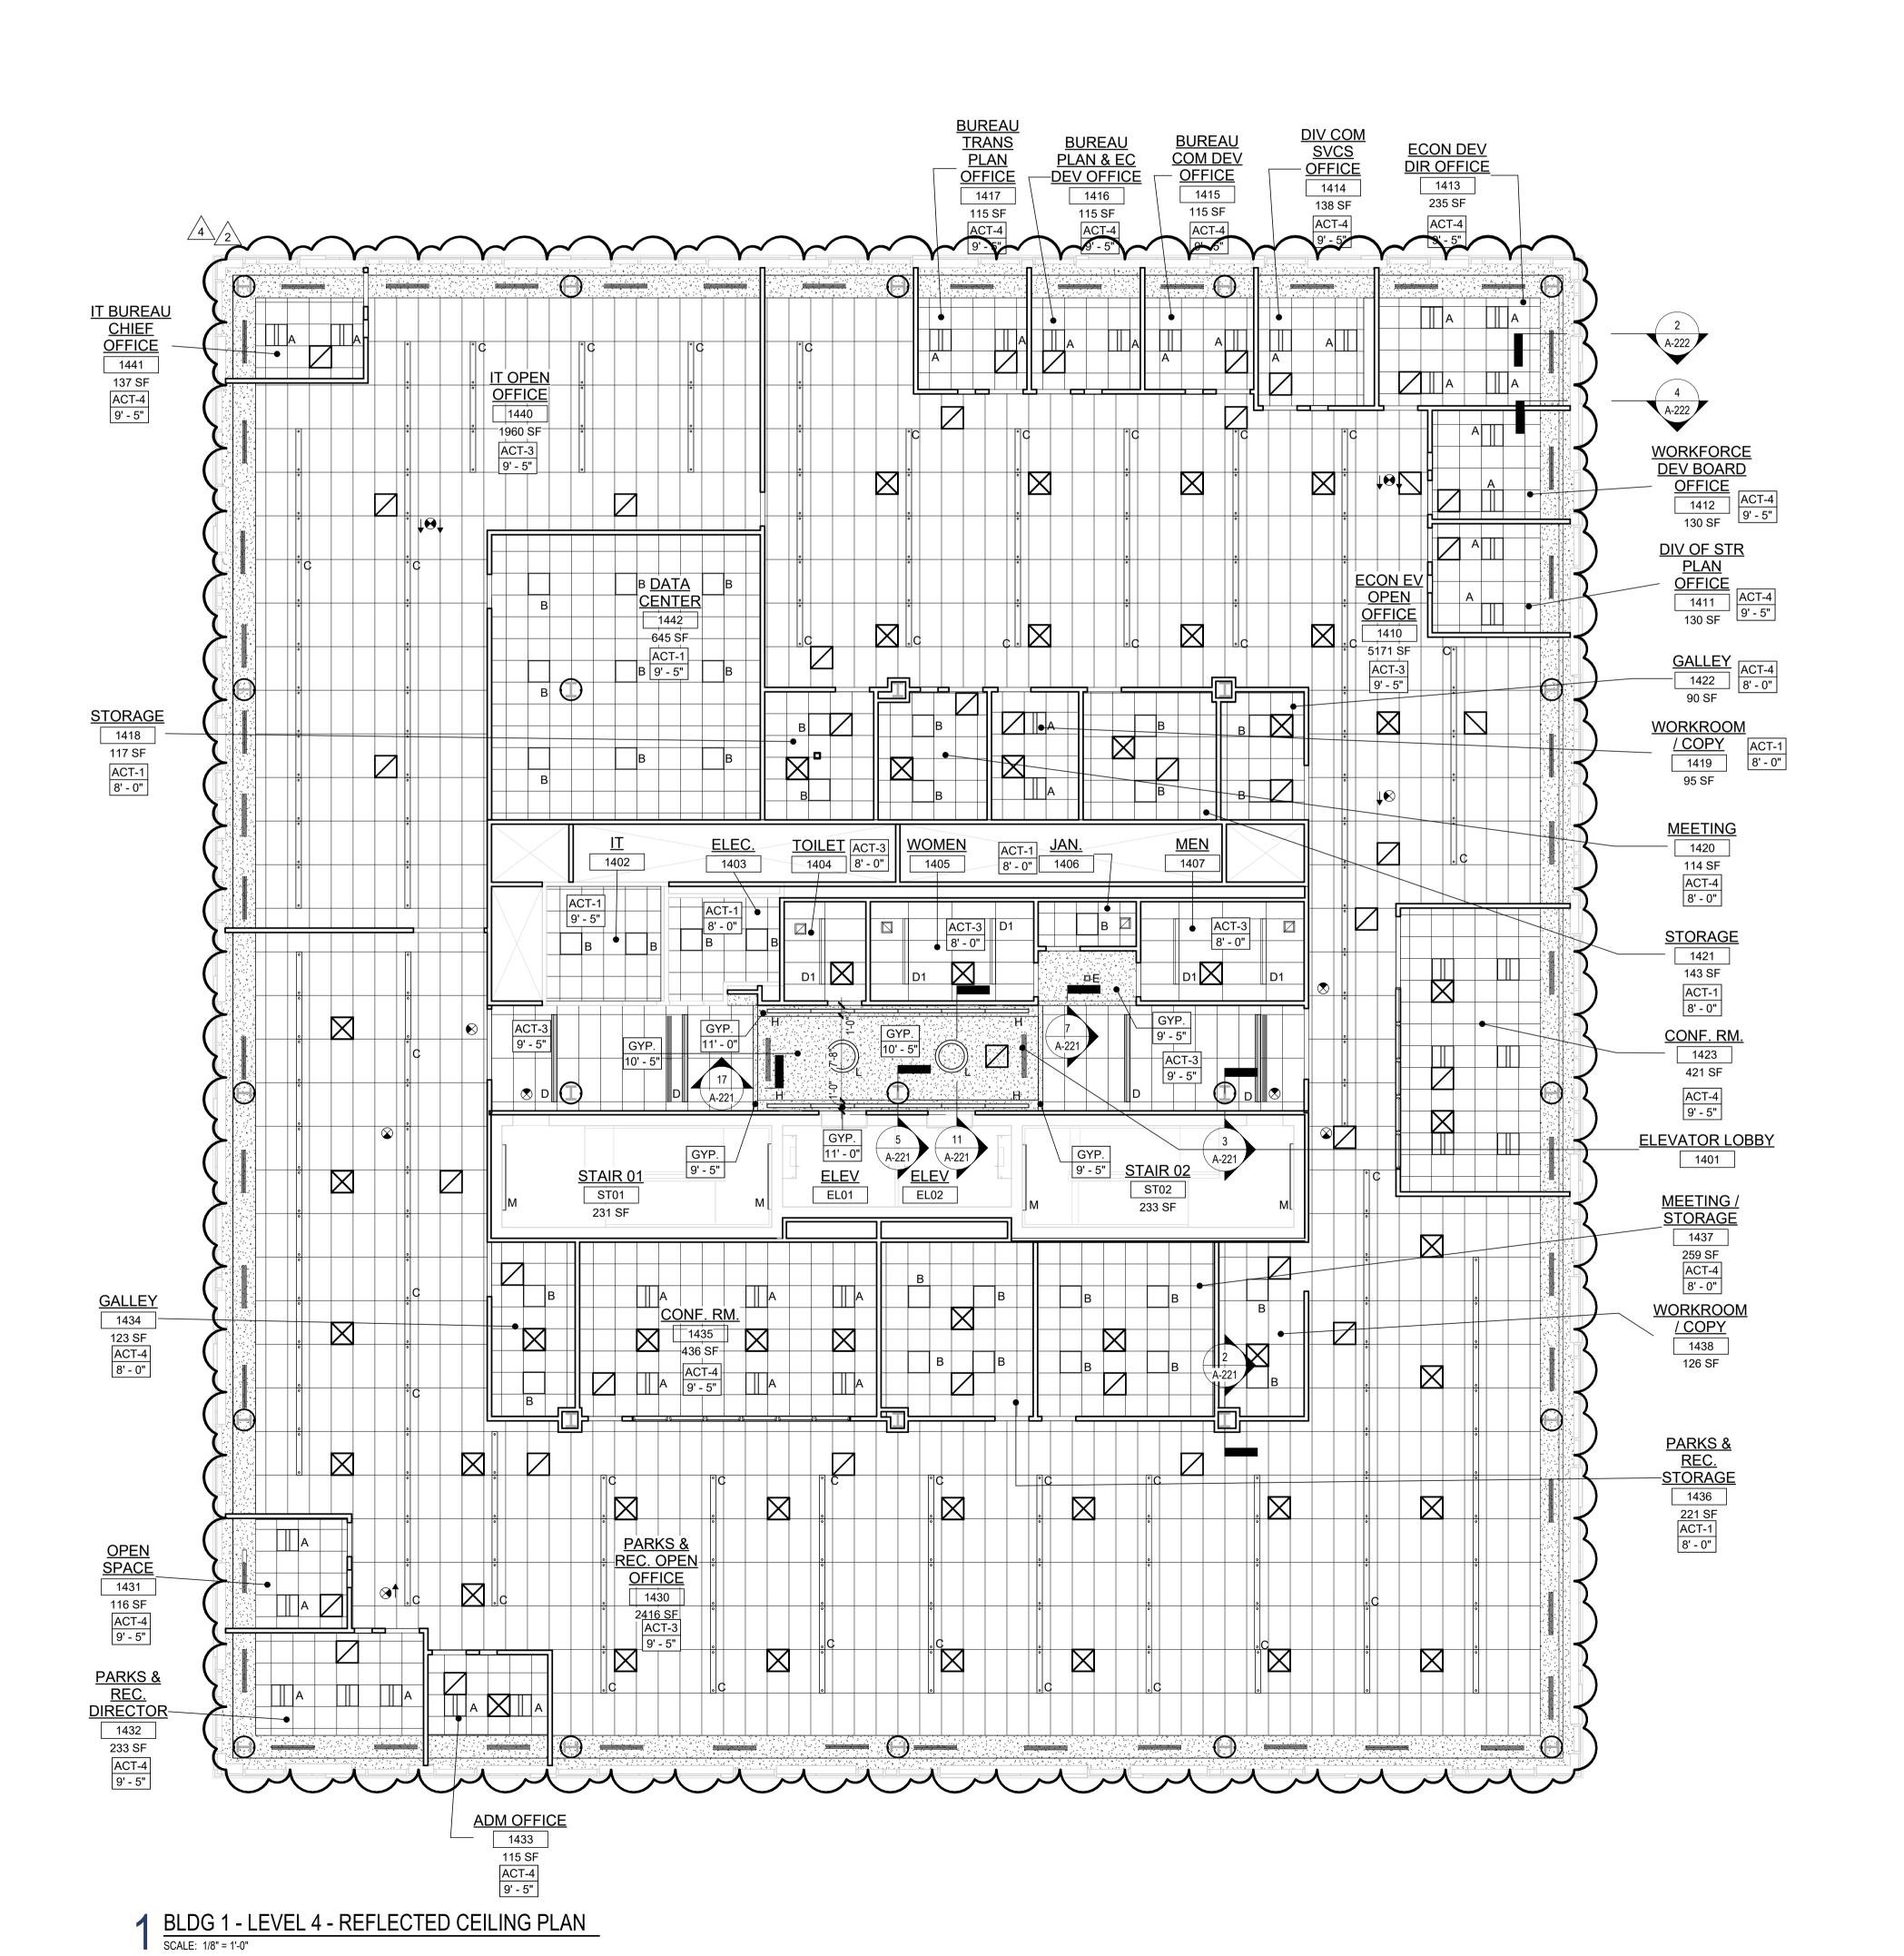

- A. BORDERS AT LAY-IN ACOUSTICAL CEILING PANELS SHALL BE CUT TO MATCH FACTORY EDGE PROFILE. NO EXPOSED FASTENERS SHALL BE PERMITTED INCLUDING POP RIVETS AND TAPPETS.
- B. HEIGHT OF CEILINGS SHALL BE MEASURED FROM TOP OF SLAB TO FINISH FACE OF GWB OR FACE OF CEILING GRID AS INDICATED ON THE REFLECTED CEILING PLAN, UON.
- C. ALL LIGHT FIXTURES ARE TO BE INSTALLED IN ACCORDANCE WITH THE ARCHITECTURAL REFLECTED CEILING PLAN. ARCHITECT TO REVIEW CEILING LAYOUT INCLUDING BULKHEADS AND GRID PRIOR TO INSTALLATION. D. LIGHT FIXTURES TYPES SHOWN ON ARCHITECTURAL REFLECTED CEILING PLANS ARE
- NOTED FOR QUANTITIES AND LOCATIONS ONLY. SEE ELECTRICAL DRAWINGS FOR ADDITIONAL INFORMATION REGARDING SPECIFICATIONS, SWITCHING, EXIT LIGHTS, EMERGENCY LIGHTING, LIFE SAFETY EQUIPMENT AND CIRCUITING.
- MECHANICAL DRAWINGS FOR DIFFUSER LOCATIONS AND FOR ADDITIONAL INFORMATION REGARDING ALL HVAC EQUIPMENT INCLUDING HVAC REGISTERS, GRILLS, ETC. F. DIMENSIONED LIGHT FIXTURES ARE FROM FINISHED FACE OF PARTITIONS TO CENTERLINE OF FIXTURE TO CENTERLINE OF FIXTURE. ANY DISCREPANCIES WITH

E. MECHANICAL INFORMATION SHOWN ON THIS PLAN IS FOR REFERENCE ONLY, SEE

- LOCATION OF LIGHT FIXTURES, SWITCHES, THERMOSTATS, OR DIFFUSERS BETWEEN ARCHITECTURAL AND ENGINEERING DRAWINGS SHALL BE CLARIFIED WITH THE ARCHITECT PRIOR TO INSTALLATION.
- G. THE CONTRACTOR SHALL SUBMIT COORDINATION DRAWINGS THAT INCORPORATES ALL TRADES AS REQUIRED BY THE SPECIFICATIONS.
- LOCATED CENTERED ON CEILING TILES, U.O.N. I. ALL ACOUSTICAL TILE CEILINGS SHALL BE CENTERED WITHIN EACH ROOM U.O.N.

H. LIGHT FIXTURES, DIFFUSERS, GRILLES AND ALL OTHER SYSTEM DEVICES SHALL BE

- J. ALL FLUSH MOUNTED LIGHT FIXTURES MOUNTED WITHIN A GYPSUM BOARD CEILING SHALL BE FITTED WITH FLUSH TRIM.
- K. WHERE DUCTWORK, CONDUIT, AND PIPING MUST CROSS OPEN CEILINGS, ALL WORK SHALL BE EXECUTED TO PRESENT A NEAT AND MINIMAL APPURTENANCE: L. ALL EXPOSED WORK SHALL RUN PARALLEL OR PERPENDICULAR TO STRUCTURE, WITH 90 DEGREE BENDS.
- M. LOCATE WORK SO AS TO MINIMIZE EXTENT EXPOSED. LOCATE WORK AS CLOSE AS POSSIBLE TO ADJACENT WALLS OR CEILINGS PLANES.
- N. PROVIDE ADDITIONAL STRUT SUPPORT SYSTEM TO SUPPORT FIXTURES WHERE LIGHT FIXTURES ARE NOT MOUNTED BELOW STRUCTURAL MEMBERS-DO NOT MOUNT TO ROOF
- O. WHERE EXPOSED STRUCTURE IS INDICATED, ALL EXPOSED ROOF DECK, STRUCTURAL STEEL, CONCRETE BEAMS & DECK, PIPES, DUCTS, CONDUITS, ETC. SHALL BE PAINTED TO MATCH CEILING COLOR; SEE FINISH SCHEDULE.
- P. DOWNLIGHTS SHALL BE SYMMETRICALLY CENTERED IN ACOUSTICAL CEILING TILE AND GYPSUM BOARD CEILINGS U.O.N.
- Q. PROVIDE SOFFIT TRANSITIONS BETWEEN ACT CEILINGS AND GYPSUM BOARD CEILINGS
- R. FURNISH AN INSTALL ACCESS DOORS IN GYP. BD. CEILINGS AS REQUIRED TO PROVIDE ACCESS TO ABOVE-CEILINGS VAV BOXES, DAMPERS, VALVES, EQUIPMENT, ETC. SEE MEP DRAWINGS FOR LOCATIONS AND SPECIFICATIONS, COORDINATE FINAL LOCATIONS WITH DESIGNER PRIOR TO INSTALLATION.
- S. ALL GYP. BD. CEILINGS IN WET AREAS SUCH AS TOILET ROOMS, BATHROOMS, AND JANITORS CLOSETS SHALL RECEIVE MOISTURE AND MOLD RESISTANT GYP. BD. AS PER SPECIFICATIONS.
- T. SEE SPECIFICATIONS FOR ADDITIONAL INFORMATION REGARDING CEILING TYPES.
- U. SEE A-220 SERIES DRAWINGS FOR TYPICAL CEILING DETAILS, U.O.N.
- V. ALL EXTERIOR WINDOWS WILL HAVE MANUAL ROLLER SHADES. REFER TO SPECIFICATIONS AND A-220 SERIES DRAWINGS FOR LOCATION AND DETAILS.
- W. ALL TRAINING ROOMS AND COMMISSIONER MEETING ROOM WILL HAVE POWERED ROLLER SHADES WITH BOTH SOLAR AND BLACKOUT CAPABILITY TO REFER TO
- X. ALL GYP. BOARD SOFFITS AND FASCIAS TO BE PAINTED (PNT-2) U.O.N.

D======	MOUNTING HEIGHT - 8'-0" A.F.F. 2" x 8'-0" RECESSED CEILING LIGHT	\mathcal{L}
_	FIXTURE (TYPE D) 2" x 4'-0" RECESSED CEILING LIGHT	
D2	FIXTURE (TYPE D2)	J
E -	4" SQUARE RECESSED DOWNLIGHT FIXTURE (TYPE E)	
F	RECESSED DIRECT LINEAR FIXTURE, VARYING LENGTHS (TYPE F)	\langle
F2	LINEAR DIRECT/INDIRECT PENDANT FIXTURE, VARYING LENGTHS (TYPE F2)	
G	4'-0" RECESSED LINEAR LIGHT FIXTURE (TYPE G)	\
н 💳	LINEAR WALL GRAZER LIGHT (TYPE H)	
ı	DECORATIVE ROUND SUSPENDED PENDANT LIGHT (TYPE I) AT CAFE)
1 O	DECORATIVE ROUND SUSPENDED PENDANT LIGHT (TYPE J)	3
К	LED ADJUSTABLE SPOT LIGHT FIXTURE (TYPE K)	\leq
L O	24" DIAMETER RING SUSPENDED PENDANT LIGHT (TYPE L)	
L2	54" DIAMETER RING SUSPENDED PENDANT LIGHT (TYPE L2	3
M	6'-0" LINEAR SURFACE WALL MOUNT LIGHT FIXTURE (TYPE M) MOUNTING HEIGHT - 8'-0" ABOVE LANDING TO & OF FIXTURE AT EGRESS STAIRS MOUNTING HEIGHT - 7'-4" ABOVE LANDING TO & OF FIXTURE AT E.M.R.	3
N 🔘	DECORATIVE ROUND SUSPENDED PENDANT LIGHT WITHIN VESTIBULE (TYPE N))
· ()	COVE LIGHTING AT COLUMN (TYPE O)	7
Р	LED TAPE LIGHT AT COVE CEILING	\forall
Q 🗈	VERTICAL LINEAR FIXTURE INTEGRATED INTO WOOD SLAT WALL SYSTEM (TYPE Q)	3
R	SURFACE MOUNTED ROUND DECORATIVE FIXTURE (TYPE R) @ BLDG. 1 - COMMISSIONER VESTIBULE	
s O	SURFACE MOUNTED RING FIXTURE (TYPE S)	3
т 💿	DECORATIVE BELL PENDANT ABOVE THE SOFFIT (TYPE T)	\forall
0	6" CEILING DOWNLIGHT RECCESSED CAN	\
lacksquare	EXIT SIGN	
7	FA CEILING MOUNTED SPEAKER & STROBE	ξ
\Box	FA CEILING MOUNTED STROBE)
S	SMOKE DETECTOR	\prec
	12" x 12" ACCESS DOOR	\
MS =====3	MOTORIZED SHADES	

Room name - ROOM NAME

---ROOM NUMBER

—CEILING TYPE

—CEILING HEIGHT

GYPSUM BOARD CEILING

HVAC - RETURN

HVAC - SUPPLY

HVAC - LINEAR SUPPLY

PRIVATE OFFICES

OPEN OFFICES

2' BY 2' SUSPENDED CEILING GRID, CEILING HEIGHT INDICATED ON PLANS,

4' BY 4' SUSPENDED CEILING GRID, CEILING HEIGHT INDICATED ON PLANS,

HVAC - BATHROOM EXHAUST FAN

CEIING LIGHT FIXTURE (TYPE A) @

2'-0" X 2'-0" RECESSED CEIING LIGHT

2" x VARYING LENGTH CEILING HUNG

PENDANT LIGHT FIXTURE (TYPE C) @

2'-0" X 2'-0" RECESSED TROFFE

FIXTURE (TYPE B) @ UTILITIES

GRID TO BE CENTERED IN AREA U.O.N.

GRID TO BE CENTERED IN AREA U.O.N.

101 🚤

FINISH NOTES:

MANUFACTURER: CENTRIA

MANUFACTURER: CERTAINTEED

MANUFACTURER: MECHOSHADE

TYPICAL CONFERENCE / MEETING ROOM:

TYPICAL STORAGE / FILE / COPY ROOM:

PRODUCT: MECHO/5 SYSTEM

PRODUCT: MULTI BOX CONTINOUS

PRODUCT: COLUMN COVERS SERIES 3000

WOOD LOOK ALUMINUM SLATS VARIED WIDTH + DEPTH

REFER TO DETAIL 2 / A1-202 FOR ADDITIONAL INFORMATION

TYPICAL CEILING HEIGHTS (BLDG 1):

9'-5" A.F.F. (2' x 4' ACT-3)

9'-5" A.F.F. (2' x 2' ACT-4)

8'-0" A.F.F. (2' x 2' ACT-1)

8'-0" A.F.F. (ACT-3 OR ACT-4)

9'-5" / 10'-5" A.F.F.

9'-5" A.F.F.

COLUMN / BEAM COVER BASIS OF DESIGN

BASIS OF DESIGN


MANUAL SHADE SYSTEMS
BASIS OF DESIGN

TYPICAL OPEN OFFICE:

ELEVATOR CORE:

RESTROOMS:

TYPICAL PRIVATE OFFICE:

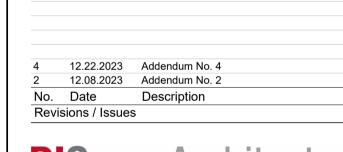

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Jeffrey D. Venezia, AIA NJ RA AI 00827100

KEY PLAN:

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UNION COUNTY IMPROVEMENT AUTHORITY

Checked By: JM / SH


Sheet Name:

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UNION COUNTY GOVERNMENT COMPLEX 81 & 93 WEST GRAND STREET CITY OF ELIZABETH NEW JERSEY, 07202 Drawing Information: Project No: 20.072 Date: 11.08.2023 Drawn By: JB / AV / PC

BUILDING NO. 1 - LEVEL 4 -REFLECTED CEILING PLAN

Sheet No: **A1-204**

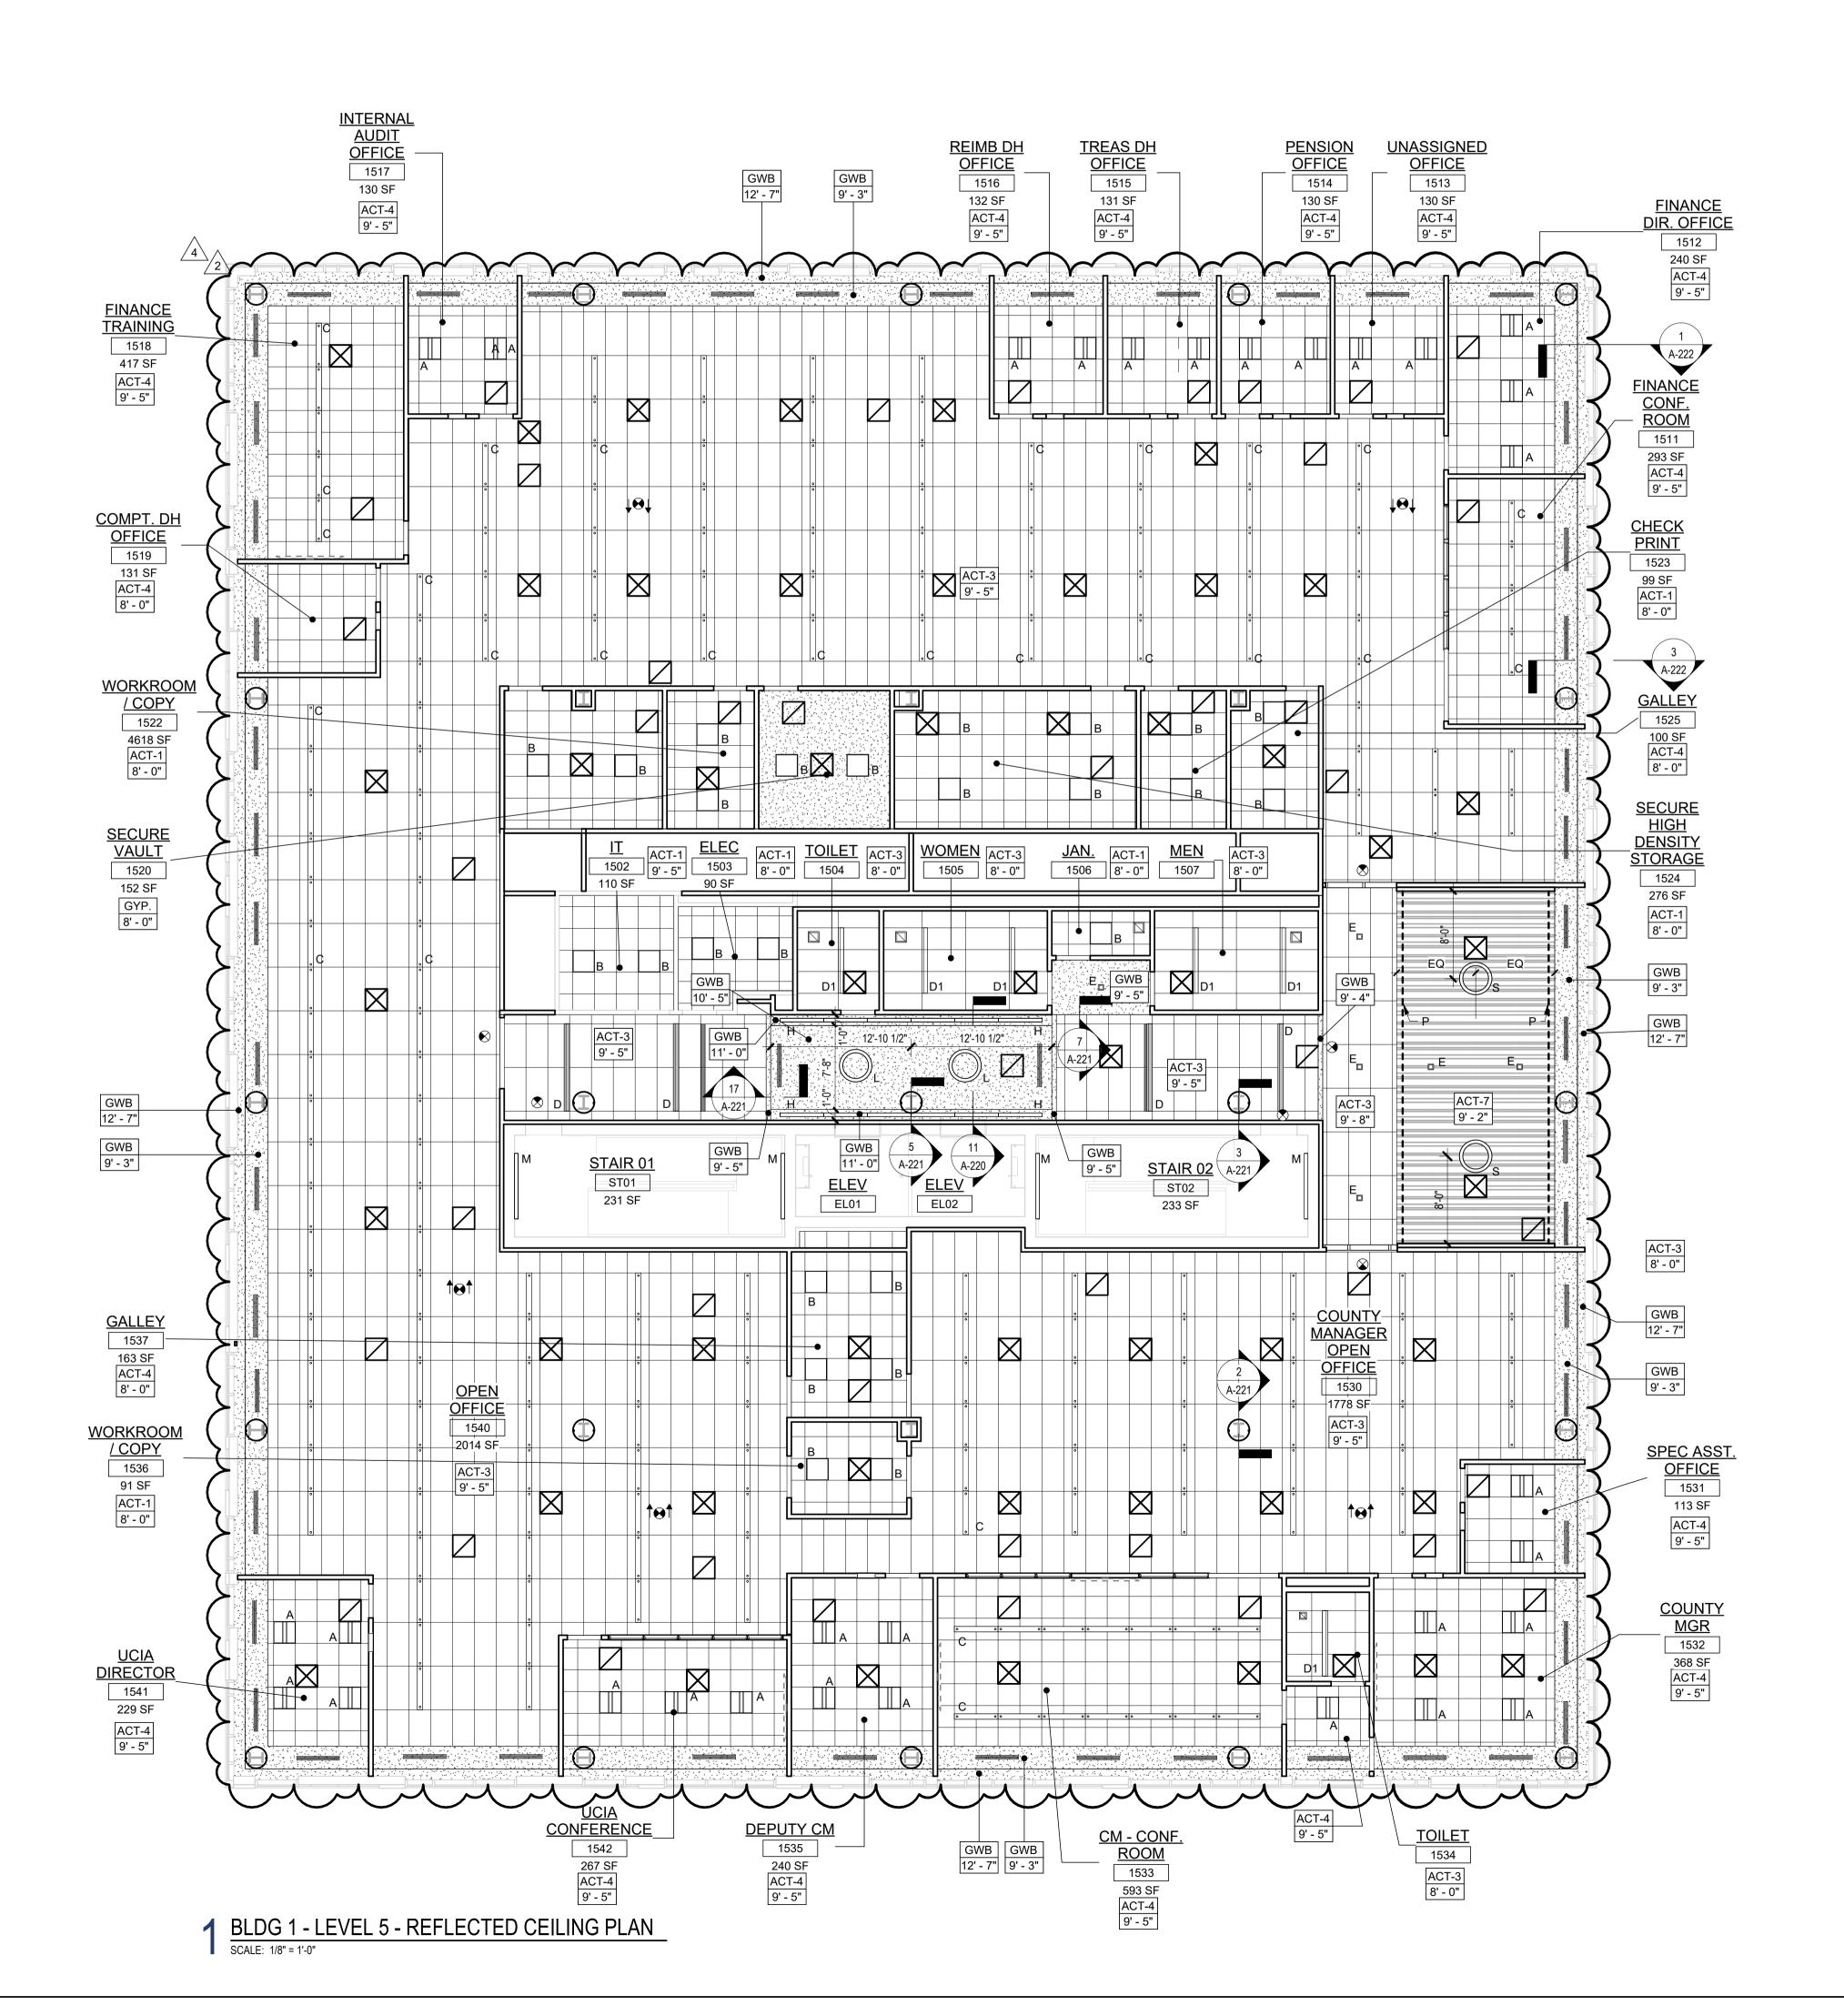

- A. BORDERS AT LAY-IN ACOUSTICAL CEILING PANELS SHALL BE CUT TO MATCH FACTORY EDGE PROFILE. NO EXPOSED FASTENERS SHALL BE PERMITTED INCLUDING POP RIVETS
- B. HEIGHT OF CEILINGS SHALL BE MEASURED FROM TOP OF SLAB TO FINISH FACE OF GWB OR FACE OF CEILING GRID AS INDICATED ON THE REFLECTED CEILING PLAN, UON.
- C. ALL LIGHT FIXTURES ARE TO BE INSTALLED IN ACCORDANCE WITH THE ARCHITECTURAL REFLECTED CEILING PLAN. ARCHITECT TO REVIEW CEILING LAYOUT INCLUDING BULKHEADS AND GRID PRIOR TO INSTALLATION.
- D. LIGHT FIXTURES TYPES SHOWN ON ARCHITECTURAL REFLECTED CEILING PLANS ARE NOTED FOR QUANTITIES AND LOCATIONS ONLY. SEE ELECTRICAL DRAWINGS FOR ADDITIONAL INFORMATION REGARDING SPECIFICATIONS, SWITCHING, EXIT LIGHTS, EMERGENCY LIGHTING, LIFE SAFETY EQUIPMENT AND CIRCUITING.
- E. MECHANICAL INFORMATION SHOWN ON THIS PLAN IS FOR REFERENCE ONLY, SEE MECHANICAL DRAWINGS FOR DIFFUSER LOCATIONS AND FOR ADDITIONAL INFORMATION REGARDING ALL HVAC EQUIPMENT INCLUDING HVAC REGISTERS, GRILLS, ETC.
- F. DIMENSIONED LIGHT FIXTURES ARE FROM FINISHED FACE OF PARTITIONS TO CENTERLINE OF FIXTURE TO CENTERLINE OF FIXTURE. ANY DISCREPANCIES WITH LOCATION OF LIGHT FIXTURES, SWITCHES, THERMOSTATS, OR DIFFUSERS BETWEEN ARCHITECTURAL AND ENGINEERING DRAWINGS SHALL BE CLARIFIED WITH THE ARCHITECT PRIOR TO INSTALLATION.
- G. THE CONTRACTOR SHALL SUBMIT COORDINATION DRAWINGS THAT INCORPORATES ALL TRADES AS REQUIRED BY THE SPECIFICATIONS. H. LIGHT FIXTURES, DIFFUSERS, GRILLES AND ALL OTHER SYSTEM DEVICES SHALL BE
- LOCATED CENTERED ON CEILING TILES, U.O.N. I. ALL ACOUSTICAL TILE CEILINGS SHALL BE CENTERED WITHIN EACH ROOM U.O.N.
- J. ALL FLUSH MOUNTED LIGHT FIXTURES MOUNTED WITHIN A GYPSUM BOARD CEILING SHALL BE FITTED WITH FLUSH TRIM.
- K. WHERE DUCTWORK, CONDUIT, AND PIPING MUST CROSS OPEN CEILINGS, ALL WORK SHALL BE EXECUTED TO PRESENT A NEAT AND MINIMAL APPURTENANCE:
- L. ALL EXPOSED WORK SHALL RUN PARALLEL OR PERPENDICULAR TO STRUCTURE, WITH 90 DEGREE BENDS.
- M. LOCATE WORK SO AS TO MINIMIZE EXTENT EXPOSED. LOCATE WORK AS CLOSE AS POSSIBLE TO ADJACENT WALLS OR CEILINGS PLANES.
- N. PROVIDE ADDITIONAL STRUT SUPPORT SYSTEM TO SUPPORT FIXTURES WHERE LIGHT FIXTURES ARE NOT MOUNTED BELOW STRUCTURAL MEMBERS-DO NOT MOUNT TO ROOF
- O. WHERE EXPOSED STRUCTURE IS INDICATED, ALL EXPOSED ROOF DECK, STRUCTURAL STEEL, CONCRETE BEAMS & DECK, PIPES, DUCTS, CONDUITS, ETC. SHALL BE PAINTED TO MATCH CEILING COLOR; SEE FINISH SCHEDULE.
- P. DOWNLIGHTS SHALL BE SYMMETRICALLY CENTERED IN ACOUSTICAL CEILING TILE AND GYPSUM BOARD CEILINGS U.O.N. Q. PROVIDE SOFFIT TRANSITIONS BETWEEN ACT CEILINGS AND GYPSUM BOARD CEILINGS
- R. FURNISH AN INSTALL ACCESS DOORS IN GYP. BD. CEILINGS AS REQUIRED TO PROVIDE ACCESS TO ABOVE-CEILINGS VAV BOXES, DAMPERS, VALVES, EQUIPMENT, ETC. SEE MEP DRAWINGS FOR LOCATIONS AND SPECIFICATIONS, COORDINATE FINAL LOCATIONS WITH DESIGNER PRIOR TO INSTALLATION.
- S. ALL GYP. BD. CEILINGS IN WET AREAS SUCH AS TOILET ROOMS, BATHROOMS, AND JANITORS CLOSETS SHALL RECEIVE MOISTURE AND MOLD RESISTANT GYP. BD. AS PER SPECIFICATIONS.
- T. SEE SPECIFICATIONS FOR ADDITIONAL INFORMATION REGARDING CEILING TYPES.
- U. SEE A-220 SERIES DRAWINGS FOR TYPICAL CEILING DETAILS, U.O.N.
- V. ALL EXTERIOR WINDOWS WILL HAVE MANUAL ROLLER SHADES. REFER TO SPECIFICATIONS AND A-220 SERIES DRAWINGS FOR LOCATION AND DETAILS.
- W. ALL TRAINING ROOMS AND COMMISSIONER MEETING ROOM WILL HAVE POWERED ROLLER SHADES WITH BOTH SOLAR AND BLACKOUT CAPABILITY TO REFER TO SPECIFICATIONS.
- X. ALL GYP. BOARD SOFFITS AND FASCIAS TO BE PAINTED (PNT-2) U.O.N.

D 0			
RC	PL	.EG	ΕN

Room name Room NAME 101 🚤 -ROOM NUMBER -CEILING TYPE 10'-0" —CEILING HEIGHT

GYPSUM BOARD CEILING

2' BY 2' SUSPENDED CEILING GRID, CEILING HEIGHT INDICATED ON PLANS, GRID TO BE CENTERED IN AREA U.O.N. 4' BY 4' SUSPENDED CEILING GRID, CEILING HEIGHT INDICATED ON PLANS,

GRID TO BE CENTERED IN AREA U.O.N.

HVAC - RETURN HVAC - SUPPLY

HVAC - LINEAR SUPPLY

2'-0" X 2'-0" RECESSED TROFFE CEIING LIGHT FIXTURE (TYPE A) @ PRIVATE OFFICES 2'-0" X 2'-0" RECESSED CEIING LIGHT FIXTURE (TYPE B) @ UTILITIES 2" x VARYING LENGTH CEILING HUNG

HVAC - BATHROOM EXHAUST FAN

PENDANT LIGHT FIXTURE (TYPE C) @ OPEN OFFICES MOUNTING HEIGHT - 8'-0" A.F.F. 2" x 8'-0" RECESSED CEILING LIGHT FIXTURE (TYPE D)

2" x 4'-0" RECESSED CEILING LIGHT

4" SQUARE RECESSED DOWNLIGHT FIXTURE (TYPE E) RECESSED DIRECT LINEAR FIXTURE,

FIXTURE (TYPE D2)

VARYING LENGTHS (TYPE F) LINEAR DIRECT/INDIRECT PENDANT

C

D2 —

FIXTURE, VARYING LENGTHS (TYPE F2) 4'-0" RECESSED LINEAR

Description

12.22.2023 Addendum No. 4 12.08.2023 Addendum No. 2

ARCHITECTURE FOR CHANGE 15 Bethany Street • New Brunswick, NJ 08901 • T: 732.249.6242 2450 W Hunting Park Ave • Philadelphia, PA 19122 • T: 215.634.3400

Jeffrey D. Venezia, AIA NJ RA AI 00827100

Revisions / Issues

KEY PLAN:

8'-0" A.F.F. (ACT-3 OR ACT-4)

DO NOT SCALE. DRAWING MAY BE PRINTED AT REDUCED SCALE. CONSULT WITH ARCHITECT FOR DIMENSIONS.

UNION COUNTY IMPROVEMENT AUTHORITY

Project:

UNION COUNTY GOVERNMENT COMPLEX 81 & 93 WEST GRAND STREET CITY OF ELIZABETH

NEW JERSEY, 07202 **Drawing Information:** Project No: 20.072 Date: 11.08.2023 Drawn By: JB / AV / PC

Checked By: JM / SH Sheet Name: **BUILDING NO. 1 - LEVEL 5 -**

REFLECTED CEILING PLAN

Sheet No:

G _____ LIGHT FIXTURE (TYPE G) LINEAR WALL GRAZER LIGHT (TYPE H) н — DECORATIVE ROUND SUSPENDED PENDANT LIGHT (TYPE I) AT CAFE DECORATIVE ROUND SUSPENDED PENDANT LIGHT (TYPE J) LED ADJUSTABLE SPOT LIGHT FIXTURE (TYPE K) 24" DIAMETER RING SUSPENDED PENDANT LIGHT (TYPE L) 54" DIAMETER RING SUSPENDED 6'-0" LINEAR SURFACE WALL MOUNT LIGHT FIXTURE (TYPE M) MOUNTING HEIGHT - 8'-0" ABOVE LANDING TO **⊈** OF FIXTURE AT EGRESS STAIRS MOUNTING HEIGHT - 7'-4" ABOVE LANDING TO **⊈** OF FIXTURE AT E.M.R. DECORATIVE ROUND SUSPENDED PENDANT LIGHT WITHIN VESTIBULE COVE LIGHTING AT COLUMN (TYPE O) LED TAPE LIGHT AT COVE CEILING VERTICAL LINEAR FIXTURE INTEGRATED INTO WOOD SLAT WALL SYSTEM (TYPE Q) SURFACE MOUNTED ROUND DECORATIVE FIXTURE (TYPE R) @ BLDG. 1 - COMMISSIONER VESTIBULE SURFACE MOUNTED RING FIXTURE DECORATIVE BELL PENDANT ABOVE THE SOFFIT (TYPE T) 6" CEILING DOWNLIGHT RECCESSED CAN FA CEILING MOUNTED SPEAKER & STROBE FA CEILING MOUNTED STROBE SMOKE DETECTOR 12" x 12" ACCESS DOOR MS E==== MOTORIZED SHADES FINISH NOTES:

COLUMN / BEAM COVER

BASIS OF DESIGN MANUFACTURER: CENTRIA PRODUCT: COLUMN COVERS SERIES 3000 WOOD LOOK ALUMINUM SLATS VARIED WIDTH + DEPTH BASIS OF DESIGN

MANUFACTURER: CERTAINTEED PRODUCT: MULTI BOX CONTINOUS REFER TO DETAIL 2 / A1-202 FOR ADDITIONAL INFORMATION MANUAL SHADE SYSTEMS

BASIS OF DESIGN MANUFACTURER: MECHOSHADE PRODUCT: MECHO/5 SYSTEM

RESTROOMS:

TYPICAL CEILING HEIGHTS (BLDG 1):

9'-5" A.F.F. (2' x 4' ACT-3) TYPICAL OPEN OFFICE: TYPICAL PRIVATE OFFICE: 9'-5" A.F.F. (2' x 2' ACT-4) TYPICAL CONFERENCE / MEETING ROOM: 9'-5" A.F.F. TYPICAL STORAGE / FILE / COPY ROOM: 8'-0" A.F.F. (2' x 2' ACT-1) **ELEVATOR CORE:** 9'-5" / 10'-5" A.F.F.

A1-205


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REFLECTED CEILING PLAN NOTES: A. BORDERS AT LAY-IN ACOUSTICAL CEILING PANELS SHALL BE CUT TO MATCH FACTORY EDGE PROFILE. NO EXPOSED FASTENERS SHALL BE PERMITTED INCLUDING POP RIVETS AND TAPPETS.

- B. HEIGHT OF CEILINGS SHALL BE MEASURED FROM TOP OF SLAB TO FINISH FACE OF GWB
- OR FACE OF CEILING GRID AS INDICATED ON THE REFLECTED CEILING PLAN, UON.
- C. ALL LIGHT FIXTURES ARE TO BE INSTALLED IN ACCORDANCE WITH THE ARCHITECTURAL REFLECTED CEILING PLAN. ARCHITECT TO REVIEW CEILING LAYOUT INCLUDING BULKHEADS AND GRID PRIOR TO INSTALLATION.
- D. LIGHT FIXTURES TYPES SHOWN ON ARCHITECTURAL REFLECTED CEILING PLANS ARE NOTED FOR QUANTITIES AND LOCATIONS ONLY. SEE ELECTRICAL DRAWINGS FOR ADDITIONAL INFORMATION REGARDING SPECIFICATIONS, SWITCHING, EXIT LIGHTS, EMERGENCY LIGHTING, LIFE SAFETY EQUIPMENT AND CIRCUITING.
- E. MECHANICAL INFORMATION SHOWN ON THIS PLAN IS FOR REFERENCE ONLY, SEE MECHANICAL DRAWINGS FOR DIFFUSER LOCATIONS AND FOR ADDITIONAL INFORMATION REGARDING ALL HVAC EQUIPMENT INCLUDING HVAC REGISTERS, GRILLS, ETC.
- F. DIMENSIONED LIGHT FIXTURES ARE FROM FINISHED FACE OF PARTITIONS TO CENTERLINE OF FIXTURE TO CENTERLINE OF FIXTURE. ANY DISCREPANCIES WITH LOCATION OF LIGHT FIXTURES, SWITCHES, THERMOSTATS, OR DIFFUSERS BETWEEN ARCHITECTURAL AND ENGINEERING DRAWINGS SHALL BE CLARIFIED WITH THE ARCHITECT PRIOR TO INSTALLATION.
- G. THE CONTRACTOR SHALL SUBMIT COORDINATION DRAWINGS THAT INCORPORATES ALL TRADES AS REQUIRED BY THE SPECIFICATIONS.
- H. LIGHT FIXTURES, DIFFUSERS, GRILLES AND ALL OTHER SYSTEM DEVICES SHALL BE LOCATED CENTERED ON CEILING TILES, U.O.N.
- I. ALL ACOUSTICAL TILE CEILINGS SHALL BE CENTERED WITHIN EACH ROOM U.O.N. J. ALL FLUSH MOUNTED LIGHT FIXTURES MOUNTED WITHIN A GYPSUM BOARD CEILING
- SHALL BE FITTED WITH FLUSH TRIM. K. WHERE DUCTWORK, CONDUIT, AND PIPING MUST CROSS OPEN CEILINGS, ALL WORK
- SHALL BE EXECUTED TO PRESENT A NEAT AND MINIMAL APPURTENANCE: L. ALL EXPOSED WORK SHALL RUN PARALLEL OR PERPENDICULAR TO STRUCTURE, WITH
- 90 DEGREE BENDS. M. LOCATE WORK SO AS TO MINIMIZE EXTENT EXPOSED. LOCATE WORK AS CLOSE AS
- POSSIBLE TO ADJACENT WALLS OR CEILINGS PLANES. N. PROVIDE ADDITIONAL STRUT SUPPORT SYSTEM TO SUPPORT FIXTURES WHERE LIGHT
- FIXTURES ARE NOT MOUNTED BELOW STRUCTURAL MEMBERS-DO NOT MOUNT TO ROOF
- STEEL, CONCRETE BEAMS & DECK, PIPES, DUCTS, CONDUITS, ETC. SHALL BE PAINTED TO MATCH CEILING COLOR; SEE FINISH SCHEDULE.

O. WHERE EXPOSED STRUCTURE IS INDICATED, ALL EXPOSED ROOF DECK, STRUCTURAL

- P. DOWNLIGHTS SHALL BE SYMMETRICALLY CENTERED IN ACOUSTICAL CEILING TILE AND GYPSUM BOARD CEILINGS U.O.N.
- Q. PROVIDE SOFFIT TRANSITIONS BETWEEN ACT CEILINGS AND GYPSUM BOARD CEILINGS R. FURNISH AN INSTALL ACCESS DOORS IN GYP. BD. CEILINGS AS REQUIRED TO PROVIDE ACCESS TO ABOVE-CEILINGS VAV BOXES, DAMPERS, VALVES, EQUIPMENT, ETC. SEE MEP DRAWINGS FOR LOCATIONS AND SPECIFICATIONS, COORDINATE FINAL LOCATIONS WITH DESIGNER PRIOR TO INSTALLATION.
- S. ALL GYP. BD. CEILINGS IN WET AREAS SUCH AS TOILET ROOMS, BATHROOMS, AND JANITORS CLOSETS SHALL RECEIVE MOISTURE AND MOLD RESISTANT GYP. BD. AS PER SPECIFICATIONS.
- T. SEE SPECIFICATIONS FOR ADDITIONAL INFORMATION REGARDING CEILING TYPES.
- U. SEE A-220 SERIES DRAWINGS FOR TYPICAL CEILING DETAILS, U.O.N.
- V. ALL EXTERIOR WINDOWS WILL HAVE MANUAL ROLLER SHADES. REFER TO SPECIFICATIONS AND A-220 SERIES DRAWINGS FOR LOCATION AND DETAILS.
- W. ALL TRAINING ROOMS AND COMMISSIONER MEETING ROOM WILL HAVE POWERED ROLLER SHADES WITH BOTH SOLAR AND BLACKOUT CAPABILITY TO REFER TO SPECIFICATIONS.
- X. ALL GYP. BOARD SOFFITS AND FASCIAS TO BE PAINTED (PNT-2) U.O.N.

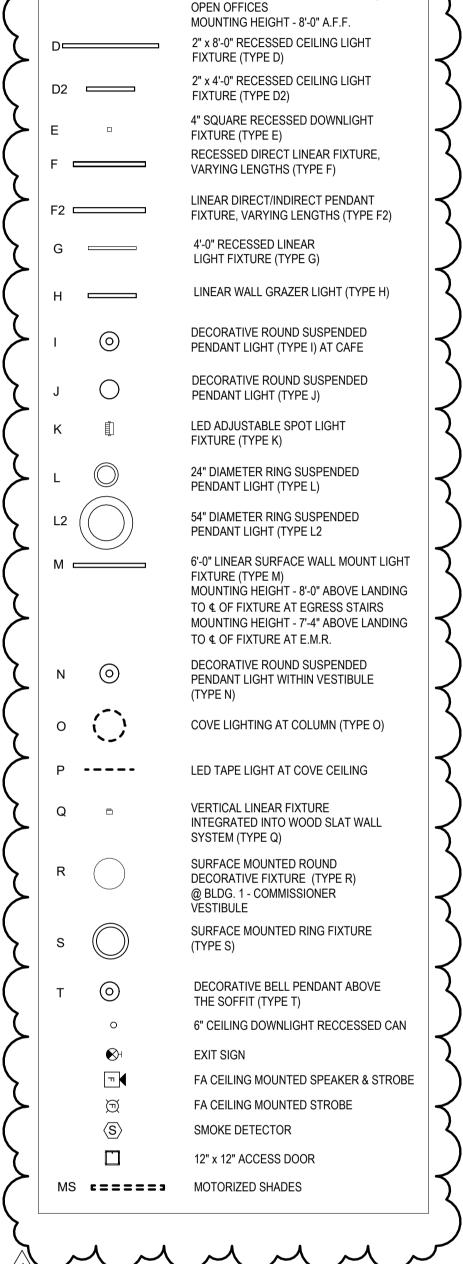

Room name — ROOM NAME

-ROOM NUMBER

—CEILING TYPE

GYPSUM BOARD CEILING

HVAC - RETURN

HVAC - SUPPLY

HVAC - LINEAR SUPPLY

PRIVATE OFFICES

HVAC - BATHROOM EXHAUST FAN

CEIING LIGHT FIXTURE (TYPE A) @

2'-0" X 2'-0" RECESSED CEIING LIGHT

2" x VARYING LENGTH CEILING HUNG

PENDANT LIGHT FIXTURE (TYPE C) @

FIXTURE (TYPE B) @ UTILITIES

2'-0" X 2'-0" RECESSED TROFFE

2' BY 2' SUSPENDED CEILING GRID, CEILING HEIGHT INDICATED ON PLANS,

4' BY 4' SUSPENDED CEILING GRID,

GRID TO BE CENTERED IN AREA U.O.N.


CEILING HEIGHT INDICATED ON PLANS, GRID TO BE CENTERED IN AREA U.O.N.

—CEILING HEIGHT

101 🚤


10'-0" -

C

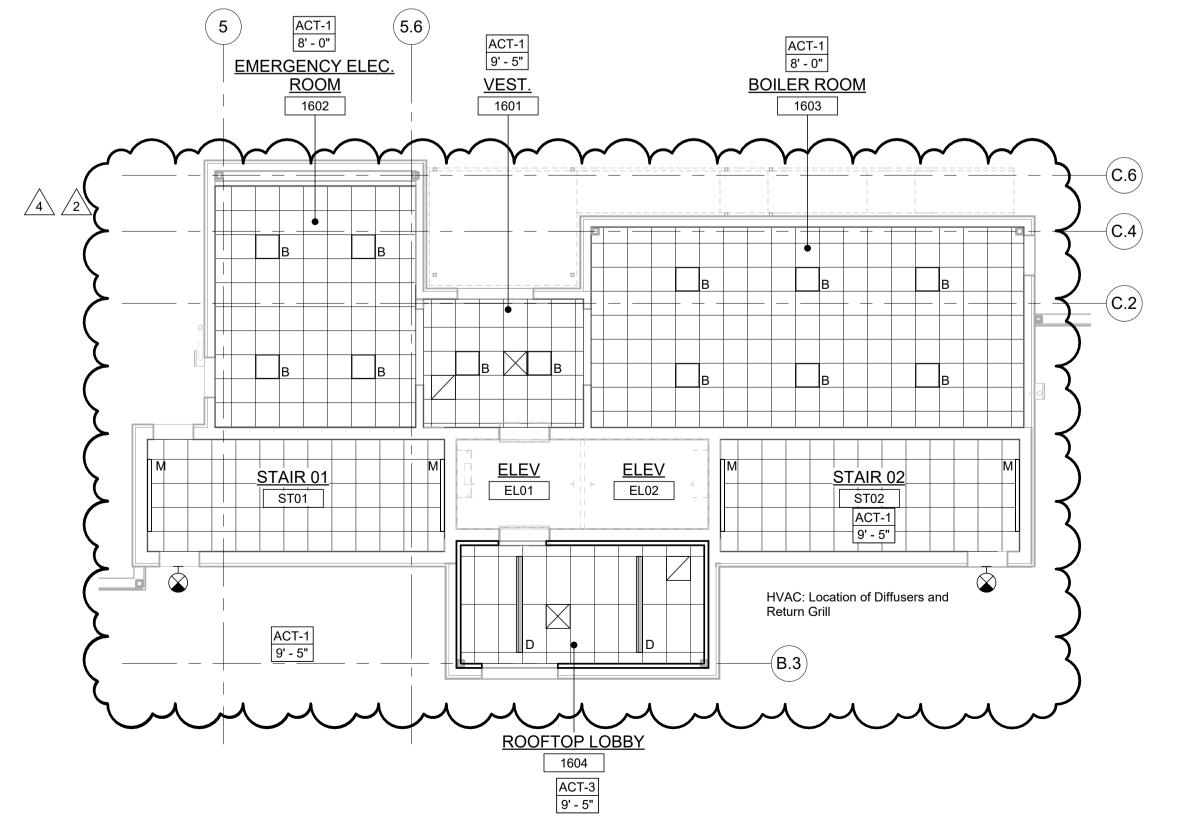

1 BLDG 1 - LEVEL 6 - PENTHOUSE REFLECTED CEILING PLAN

SCALE: 1/8" = 1'-0"

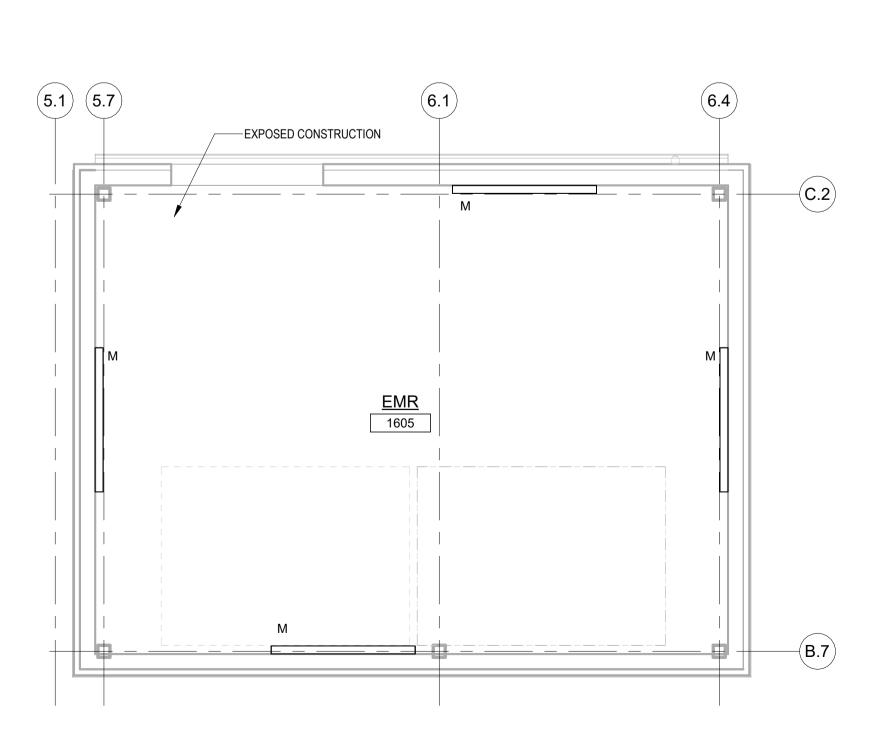

2 BLDG 1 - EMR REFLECTED CEILING PLAN

SCALE: 1/4" = 1'-0"

FINISH NOTES:

COLUMN / BEAM COVER **BASIS OF DESIGN** MANUFACTURER: CENTRIA PRODUCT: COLUMN COVERS SERIES 3000

WOOD LOOK ALUMINUM SLATS VARIED WIDTH + DEPTH BASIS OF DESIGN MANUFACTURER: CERTAINTEED PRODUCT: MULTI BOX CONTINOUS REFER TO DETAIL 2 / A1-202 FOR ADDITIONAL INFORMATION

MANUAL SHADE SYSTEMS BASIS OF DESIGN MANUFACTURER: MECHOSHADE PRODUCT: MECHO/5 SYSTEM

RESTROOMS:

TYPICAL CEILING HEIGHTS (BLDG 1): 9'-5" A.F.F. (2' x 4' ACT-3) TYPICAL OPEN OFFICE: TYPICAL PRIVATE OFFICE: 9'-5" A.F.F. (2' x 2' ACT-4) TYPICAL CONFERENCE / MEETING ROOM: 9'-5" A.F.F. TYPICAL STORAGE / FILE / COPY ROOM: 8'-0" A.F.F. (2' x 2' ACT-1) **ELEVATOR CORE:** 9'-5" / 10'-5" A.F.F.

8'-0" A.F.F. (ACT-3 OR ACT-4)

BUILDING NO. 1 - LEVEL 6 -PENTHOUSE AND EMR REFLECTED CEILING PLAN

KEY PLAN:

12.22.2023 Addendum No. 4 12.08.2023 Addendum No. 2

Description

ARCHITECTURE FOR CHANGE

15 Bethany Street • New Brunswick, NJ 08901 • T: 732.249.6242 2450 W Hunting Park Ave • Philadelphia, PA 19122 • T: 215.634.3400

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UNION COUNTY IMPROVEMENT

UNION COUNTY GOVERNMENT

81 & 93 WEST GRAND STREET

AUTHORITY

COMPLEX

CITY OF ELIZABETH

NEW JERSEY, 07202

Drawing Information:

Sheet Name:

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Project No: 20.072

Drawn By: JB / AV / PC Checked By: JM / SH

Project:

No. Date

Revisions / Issues


Jeffrey D. Venezia, AIA NJ RA AI 00827100

A1-206

MANUFACTURER: CERTAINTEED
PRODUCT: MULTI BOX CONTINUOUS ("HOTEL" PATTERN)

2. INTERGRATED LIGHT FIXTURE ONLY TO OCCUR AT DB4 LOCATIONS. REFER TO RCP FOR APPROXIMATE LOCATION AND QUANITITY.

2 SLATTED SOFFIT PATTERN TYPICAL AT LOBBY CEILING TYPE ACT-6
SCALE: 3" = 1'-0"

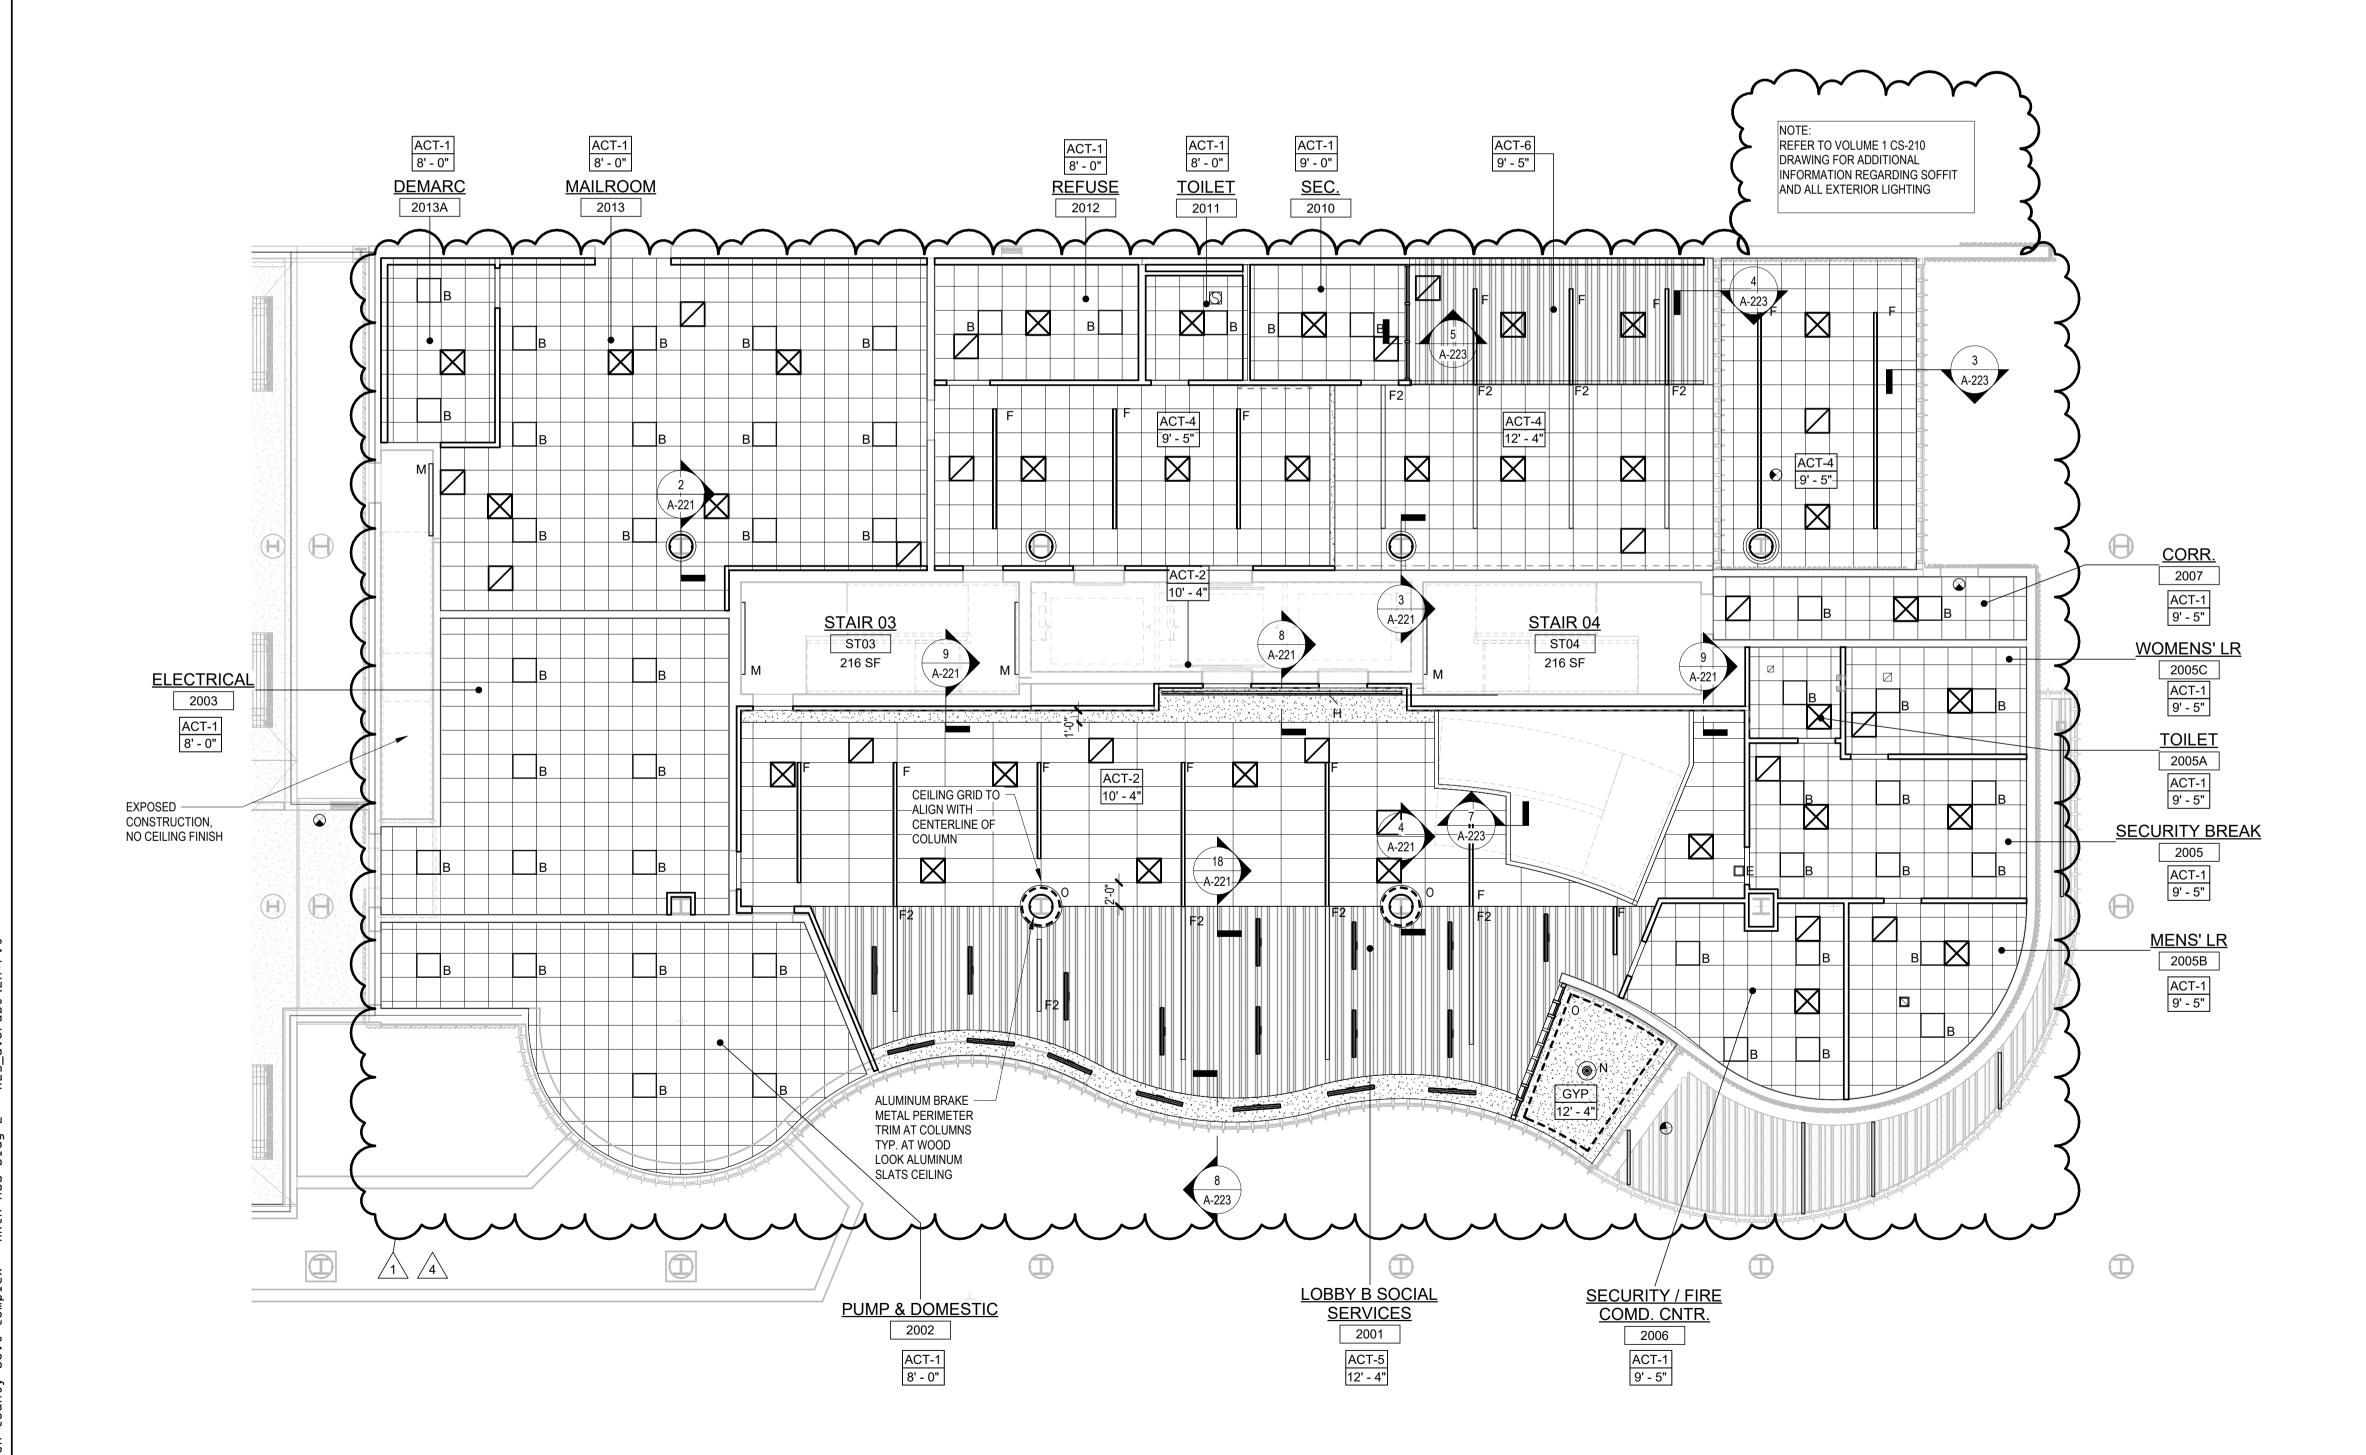

TYPICAL CEILING HEIGHTS (BLDG 2):

TYPICAL OPEN OFFICE: 9'-5" A.F.F.

TYPICAL PRIVATE OFFICE: 9'-5" A.F.F.

TYPICAL CONFERENCE / MEETING ROOM: 9'-5" A.F.F.

TYPICAL STORAGE / FILE / COPY ROOM: 8'-0" A.F.F.

ELEVATOR CORE: 9'-5" / 10'-5" A.F.F.

RESTROOMS: 8'-0" A.F.F.

FINISH NOTES:

COLUMN / BEAM COVER
BASIS OF DESIGN

MANUFACTURER: CENTRIA
PRODUCT: COLUMN COVERS SERIES 3000

WOOD LOOK ALUMINUM SLATS VARIED WIDTH + DEPTH
BASIS OF DESIGN

MANUFACTURER: CERTAINTEED
PRODUCT: MULTI BOX CONTINOUS
REFER TO DETAIL 2 / A2-210 FOR ADDITIONAL INFORMATION

MANUAL SHADE SYSTEMS
BASIS OF DESIGN
MANUFACTURER: MECHOSHADE
PRODUCT: MECHO/5 SYSTEM

REFLECTED CEILING PLAN NOTES:

- A. BORDERS AT LAY-IN ACOUSTICAL CEILING PANELS SHALL BE CUT TO MATCH FACTORY EDGE PROFILE. NO EXPOSED FASTENERS SHALL BE PERMITTED INCLUDING POP RIVETS AND TAPPETS.
- B. HEIGHT OF CEILINGS SHALL BE MEASURED FROM TOP OF SLAB TO FINISH FACE OF GWB OR FACE OF CEILING GRID AS INDICATED ON THE REFLECTED CEILING PLAN, UON.
- C. ALL LIGHT FIXTURES ARE TO BE INSTALLED IN ACCORDANCE WITH THE ARCHITECTURAL REFLECTED CEILING PLAN. ARCHITECT TO REVIEW CEILING LAYOUT INCLUDING BULKHEADS AND GRID PRIOR TO INSTALLATION.
- D. LIGHT FIXTURES TYPES SHOWN ON ARCHITECTURAL REFLECTED CEILING PLANS ARE NOTED FOR QUANTITIES AND LOCATIONS ONLY. SEE ELECTRICAL DRAWINGS FOR ADDITIONAL INFORMATION REGARDING SPECIFICATIONS, SWITCHING, EXIT LIGHTS, EMERGENCY LIGHTING, LIFE SAFETY EQUIPMENT AND CIRCUITING.
- E. MECHANICAL INFORMATION SHOWN ON THIS PLAN IS FOR REFERENCE ONLY, SEE MECHANICAL DRAWINGS FOR DIFFUSER LOCATIONS AND FOR ADDITIONAL INFORMATION REGARDING ALL HVAC EQUIPMENT INCLUDING HVAC REGISTERS, GRILLS, ETC.
- F. DIMENSIONED LIGHT FIXTURES ARE FROM FINISHED FACE OF PARTITIONS TO CENTERLINE OF FIXTURE TO CENTERLINE OF FIXTURE. ANY DISCREPANCIES WITH LOCATION OF LIGHT FIXTURES, SWITCHES, THERMOSTATS, OR DIFFUSERS BETWEEN ARCHITECTURAL AND ENGINEERING DRAWINGS SHALL BE CLARIFIED WITH THE ARCHITECT PRIOR TO INSTALLATION.
- G. THE CONTRACTOR SHALL SUBMIT COORDINATION DRAWINGS THAT INCORPORATES ALL TRADES AS REQUIRED BY THE SPECIFICATIONS.
- H. LIGHT FIXTURES, DIFFUSERS, GRILLES AND ALL OTHER SYSTEM DEVICES SHALL BE LOCATED CENTERED ON CEILING TILES, U.O.N.
- I. ALL ACOUSTICAL TILE CEILINGS SHALL BE CENTERED WITHIN EACH ROOM U.O.N.
- J. ALL FLUSH MOUNTED LIGHT FIXTURES MOUNTED WITHTIN A GYPSUM BOARD CEILING SHALL BE FITTED WITH FLUSH TRIM.

TO MATCH CEILING COLOR; SEE FINISH SCHEDULE.

WITH DESIGNER PRIOR TO INSTALLATION.

90 DEGREE BENDS.

- K. WHERE DUCTWORK, CONDUIT, AND PIPING MUST CROSS OPEN CEILINGS, ALL WORK SHALL BE EXCUTED TO PRESENT A NEAT AND MINIMAL APPREANCE:
- L. ALL EXPOSED WORK SHALL RUN PARALLEL OR PERPENDICULAR TO STRUCTURE, WITH
- M. LOCATE WORK SO AS TO MINIMIZE EXTENT EXPOSED. LOCATE WORK AS CLOSE AS POSSIBLE TO ADJACENT WALLS OR CEILINGS PLANES.
- N. PROVIDE ADDITIONAL STRUT SUPPORT SYSTEM TO SUPPORT FIXTURES WHERE LIGHT FIXTURES ARE NOT MOUNTED BELOW STRUCTURAL MEMBERS-DO NOT MOUNT TO ROOF
- DECK, TYP.

 O. WHERE EXPOSED STRUCTURE IS INDICATED, ALL EXPOSED ROOF DECK, STRUCTURAL

STEEL, CONCRETE BEAMS & DECK, PIPES, DUCTS, CONDUITS, ETC. SHALL BE PAINTED

- P. DOWNLIGHTS SHALL BE SYMMETRICALLY CENTERED IN ACOUSTICAL CEILING TILE AND GYPSUM BOARD CEILINGS U.O.N.
- Q. PROVIDE SOFFIT TRANSITIONS BETWEEN ACT CEILINGS AND GYPSUM BOARD CEILINGS
- R. FURNISH AN INSTALL ACCESS DOORS IN GYP. BD. CEILINGS AS REQUIRED TO PROVIDE ACCESS TO ABOVE-CEILINGS VAV BOXES, DAMPERS, VALVES, EQUIPMENT, ETC. SEE MEP DRAWINGS FOR LOCATIONS AND SPECIFICATIONS, COORDINATE FINAL LOCATIONS
- S. ALL GYP. BD. CEILINGS IN WET AREAS SUCH AS TOILET ROOMS, BATHROOMS, AND JANITORS CLOSTES SHALL RECIEVE MOISTURE AND MOLD RESISTANT GYP. BD. AS PER SPECIFICATIONS.
- T. SEE SPECIFICATIONS FOR ADDITIONAL INFORMATION REGARDING CEILING TYPES.
- U. SEE A-220 SERIES DRAWINGS FOR TYPICAL CEILING DETAILS, U.O.N.
- V. ALL EXTERIOR WINDOWS WILL HAVE MANUAL ROLLER SHADES. REFER TO SPECIFICATIONS AND A-220 SERIES DRAWINGS FOR LOCATION AND DETAILS.
- W. ALL TRAINING ROOMS AND COMMISSIONER MEETING ROOMS WILL HAVE POWERED ROLLER SHADES WITH BOTH SOLAR AND BLACKOUT CAPABILITY TO REFER TO SPECIFICATIONS.
- X. ALL GYP. BOARD SOFFITS AND FASCIAS TO BE PAINTED (PNT-2) U.O.N.

	TIXTORE (TTT E B)
D2	2" x 4'-0" RECESSED CEILING LIGHT FIXTURE (TYPE D2)
E o	4" SQUARE RECESSED DOWNLIGHT FIXTURE (TYPE E)
F	RECESSED DIRECT LINEAR FIXTURE, VARYING LENGTHS (TYPE F)
F2	LINEAR DIRECT/INDIRECT PENDANT FIXTURE, VARYING LENGTHS (TYPE F2)
G	4'-0" RECESSED LINEAR LIGHT FIXTURE (TYPE G)
н ====	LINEAR WALL GRAZER LIGHT (TYPE H)
ı	DECORATIVE ROUND SUSPENDED PENDANT LIGHT (TYPE I) AT CAFE
1 O	DECORATIVE ROUND SUSPENDED PENDANT LIGHT (TYPE J)
К	LED ADJUSTABLE SPOT LIGHT FIXTURE (TYPE K)
L O	24" DIAMETER RING SUSPENDED PENDANT LIGHT (TYPE L)
L2	54" DIAMETER RING SUSPENDED PENDANT LIGHT (TYPE L2
M	6'-0" LINEAR SURFACE WALL MOUNT LIGHT FIXTURE (TYPE M) MOUNTING HEIGHT - 8'-0" ABOVE LANDING TO & OF FIXTURE AT EGRESS STAIRS MOUNTING HEIGHT - 7'-4" ABOVE LANDING TO & OF FIXTURE AT E.M.R.
N ()	DECORATIVE ROUND SUSPENDED PENDANT LIGHT WITHIN VESTIBULE (TYPE N)
· ()	COVE LIGHTING AT COLUMN (TYPE O)
Р	LED TAPE LIGHT AT COVE CEILING
Q	VERTICAL LINEAR FIXTURE INTEGRATED INTO WOOD SLAT WALL SYSTEM (TYPE Q)
R	SURFACE MOUNTED ROUND DECORATIVE FIXTURE (TYPE R) @ BLDG. 1 - COMMISSIONER VESTIBULE
s O	SURFACE MOUNTED RING FIXTURE (TYPE S)
т 💿	DECORATIVE BELL PENDANT ABOVE THE SOFFIT (TYPE T)
0	6" CEILING DOWNLIGHT RECCESSED CAN
⊗ 4	EXIT SIGN
П	FA CEILING MOUNTED SPEAKER & STROBE
) (i)	FA CEILING MOUNTED STROBE
⟨S⟩	SMOKE DETECTOR
	12" x 12" ACCESS DOOR
MS [====]	MOTORIZED SHADES

RCP LEGEND

-ROOM NUMBER

—CEILING TYPE

—CEILING HEIGHT

GYPSUM BOARD CEILING

HVAC - RETURN

HVAC - SUPPLY

HVAC - LINEAR SUPPLY

PRIVATE OFFICES

OPEN OFFICES

FIXTURE (TYPE D)

HVAC - BATHROOM EXHAUST FAN

CEIING LIGHT FIXTURE (TYPE A) @

2'-0" X 2'-0" RECESSED CEIING LIGHT

2" x VARYING LENGTH CEILING HUNG

PENDANT LIGHT FIXTURE (TYPE C) @

FIXTURE (TYPE B) @ UTILITIES

MOUNTING HEIGHT - 8'-0" A.F.F. 2" x 8'-0" RECESSED CEILING LIGHT

2'-0" X 2'-0" RECESSED TROFFE

2' BY 2' SUSPENDED CEILING GRID,

CEILING HEIGHT INDICATED ON PLANS,

GRID TO BE CENTERED IN AREA U.O.N.
4' BY 4' SUSPENDED CEILING GRID.

CEILING HEIGHT INDICATED ON PLANS,


GRID TO BE CENTERED IN AREA U.O.N.

Room name -----ROOM NAME

ACT-1 **◄**

10'-0" 🔫

C

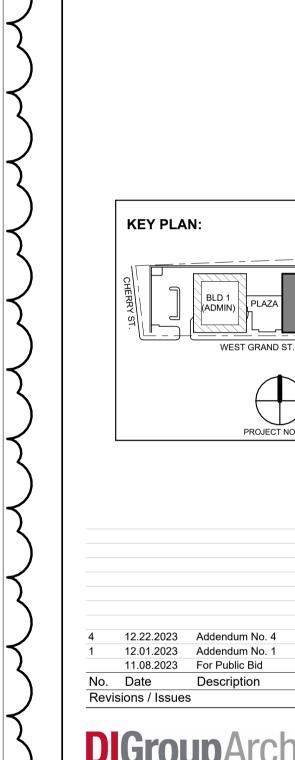

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Jeffrey D. Venezia, AIA
NJ RA AI 00827100

ARCHITECTURE FOR CHANGE

15 Bethany Street • New Brunswick, NJ 08901 • T: 732.249.6242

DO NOT SCALE. DRAWING MAY BE PRINTED AT REDUCED SCALE. CONSULT WITH ARCHITECT FOR DIMENSIONS.

UNION COUNTY IMPROVEMENT AUTHORITY

Project:

UNION COUNTY GOVERNMENT
COMPLEX - BUILDING 2
81 & 93 WEST GRAND STREET
CITY OF ELIZABETH
NEW JERSEY, 07202

Drawing Information:

Project No: 20.072
Date: 11.08.2023
Drawn By: JB / AV / PC
Checked By: JM / SH


Sheet Name:

BUILDING NO. 2 - LEVEL 0 -GROUND FLOOR REFLECTED CEILING PLAN

A2-210

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1 BLDG 2 - LEVEL 0 - GROUND FLOOR REFLECTED CEILING PLAN SCALE: 1/8" = 1'-0"

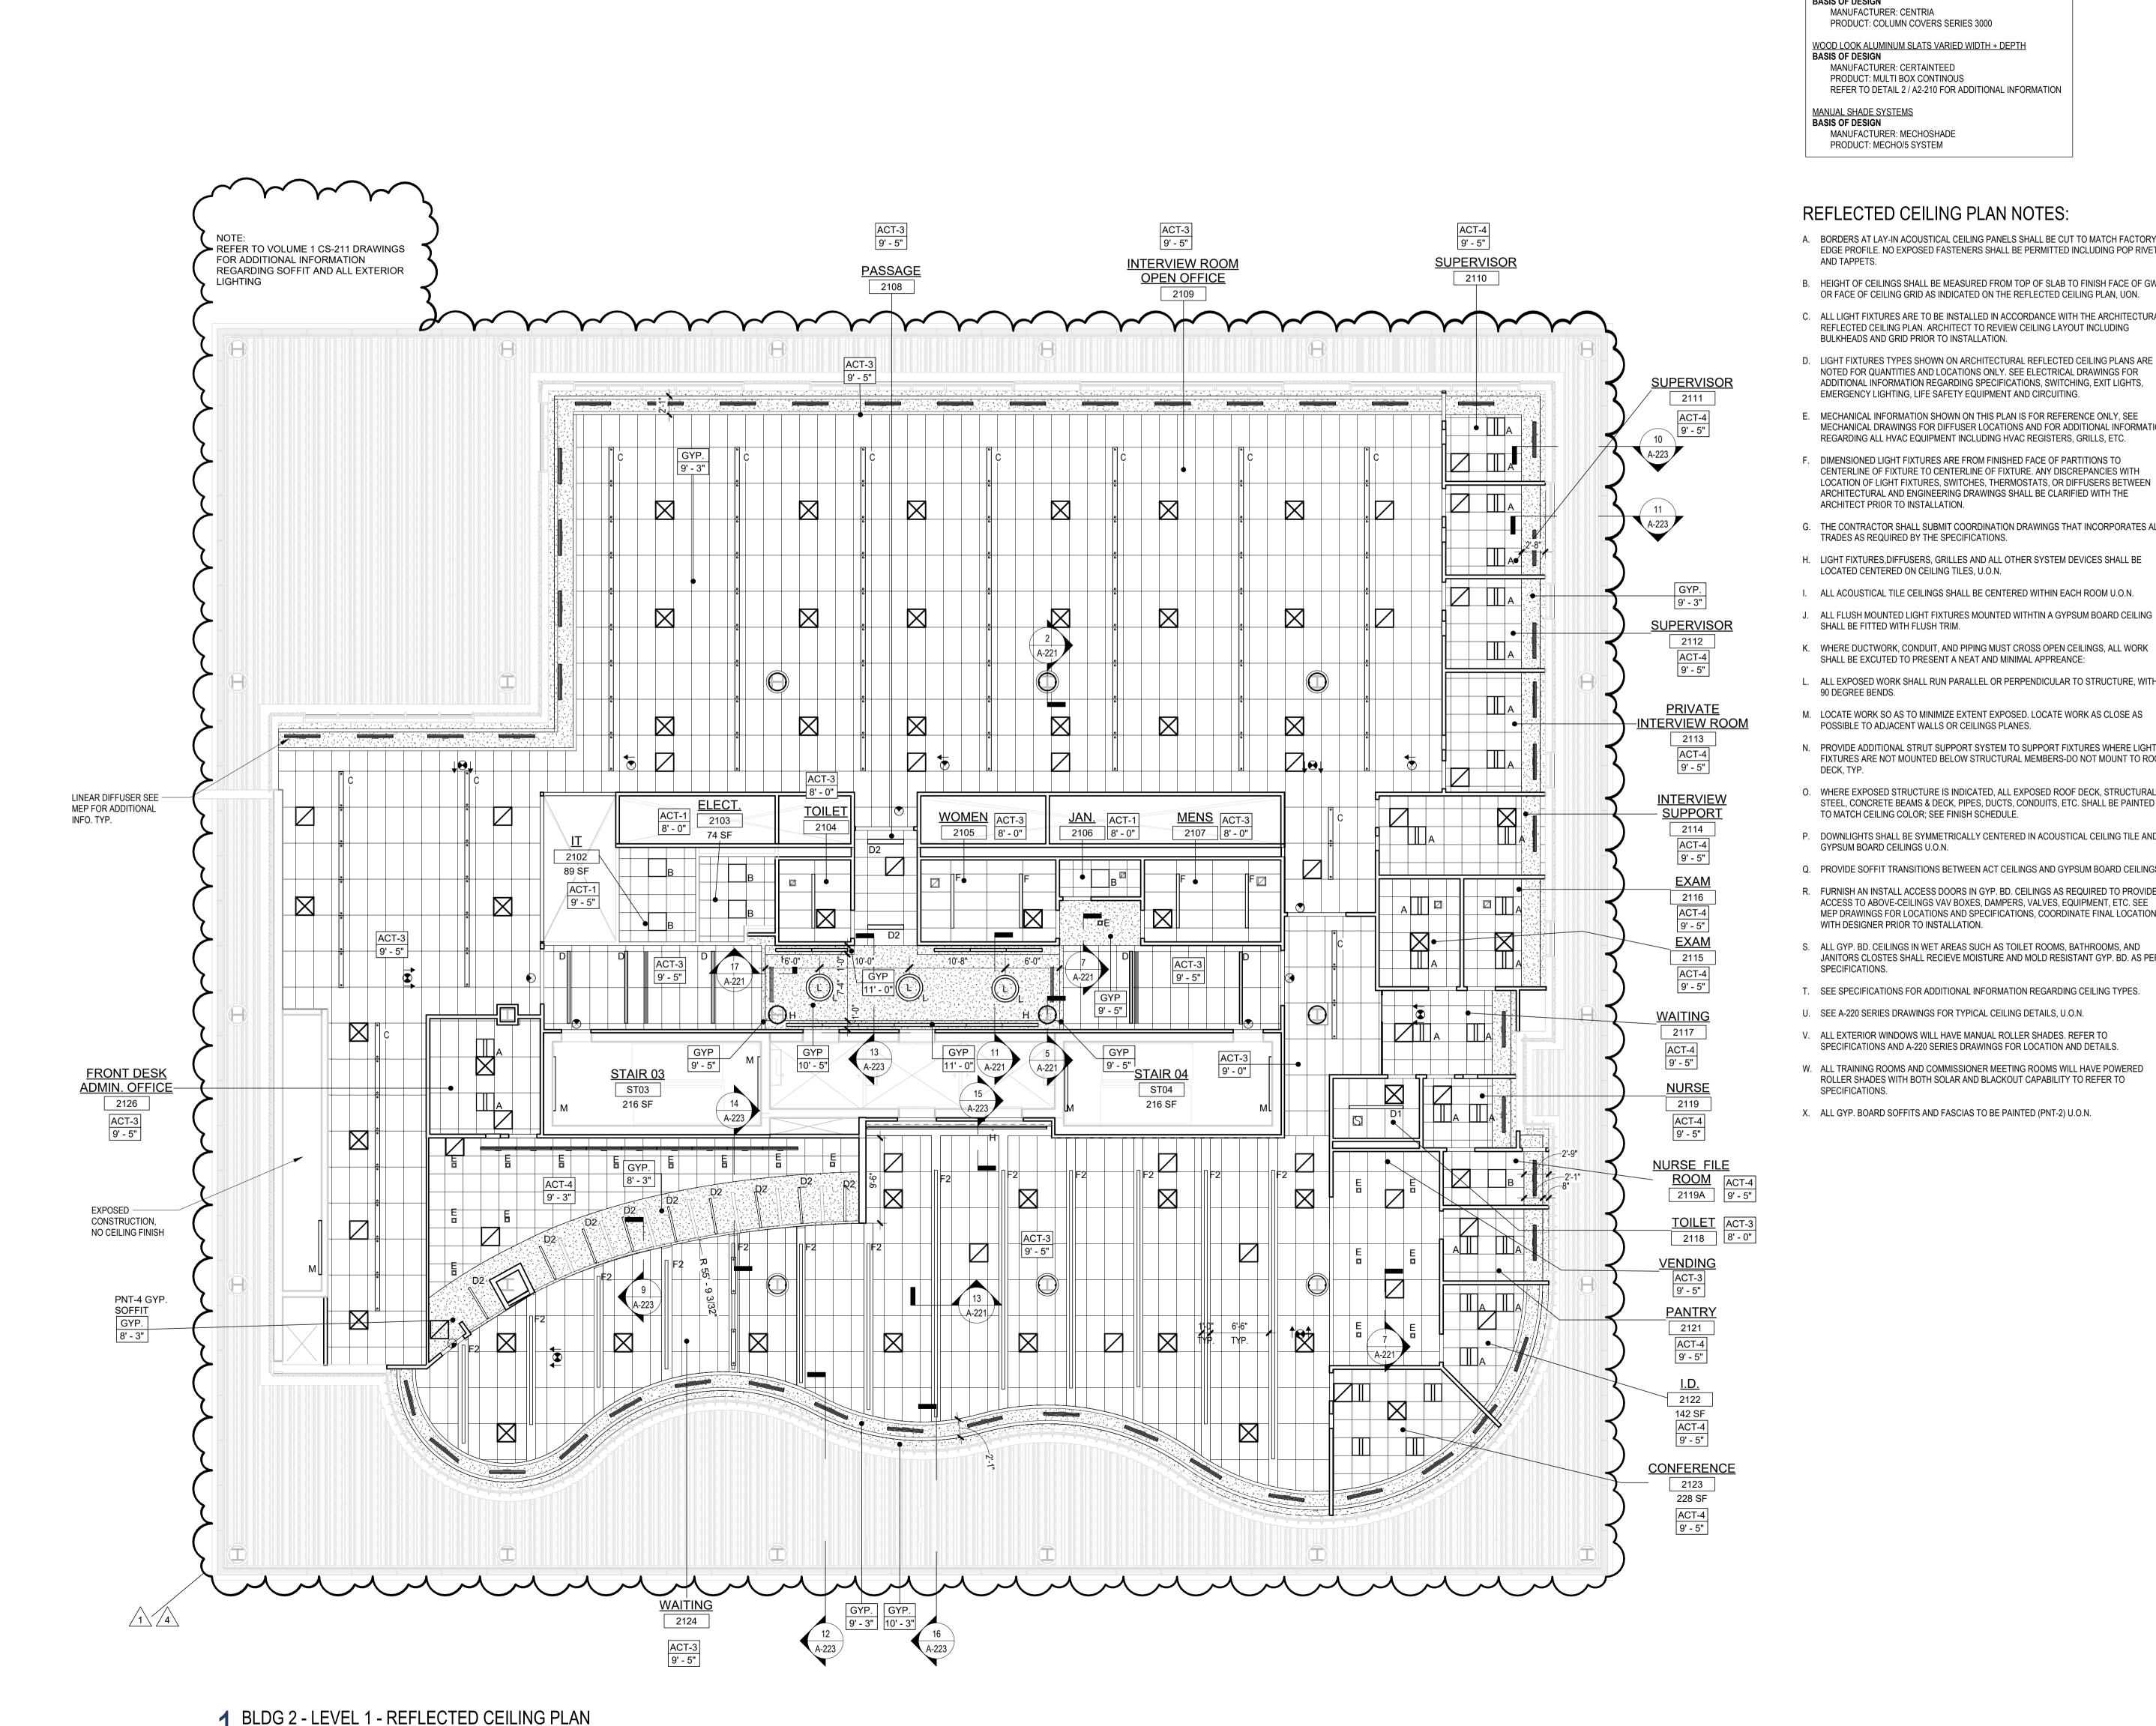

SCALE: 1/8" = 1'-0"

TYPICAL CEILING HEIGHTS (BLDG 2) TYPICAL OPEN OFFICE: TYPICAL PRIVATE OFFICE: 9'-5" A.F.F. TYPICAL CONFERENCE / MEETING ROOM: 9'-5" A.F.F. TYPICAL STORAGE / FILE / COPY ROOM: 8'-0" A.F.F. **ELEVATOR CORE:** 9'-5" / 10'-5" A.F.F. **RESTROOMS:** 8'-0" A.F.F.

FINISH NOTES:

COLUMN / BEAM COVER


BASIS OF DESIGN MANUFACTURER: CENTRIA PRODUCT: COLUMN COVERS SERIES 3000

BASIS OF DESIGN MANUFACTURER: CERTAINTEED PRODUCT: MULTI BOX CONTINOUS REFER TO DETAIL 2 / A2-210 FOR ADDITIONAL INFORMATION

MANUAL SHADE SYSTEMS BASIS OF DESIGN MANUFACTURER: MECHOSHADE PRODUCT: MECHO/5 SYSTEM

REFLECTED CEILING PLAN NOTES:

- A. BORDERS AT LAY-IN ACOUSTICAL CEILING PANELS SHALL BE CUT TO MATCH FACTORY EDGE PROFILE. NO EXPOSED FASTENERS SHALL BE PERMITTED INCLUDING POP RIVETS AND TAPPETS.
- B. HEIGHT OF CEILINGS SHALL BE MEASURED FROM TOP OF SLAB TO FINISH FACE OF GWB OR FACE OF CEILING GRID AS INDICATED ON THE REFLECTED CEILING PLAN, UON.
- C. ALL LIGHT FIXTURES ARE TO BE INSTALLED IN ACCORDANCE WITH THE ARCHITECTURAL REFLECTED CEILING PLAN. ARCHITECT TO REVIEW CEILING LAYOUT INCLUDING BULKHEADS AND GRID PRIOR TO INSTALLATION.
- D. LIGHT FIXTURES TYPES SHOWN ON ARCHITECTURAL REFLECTED CEILING PLANS ARE NOTED FOR QUANTITIES AND LOCATIONS ONLY. SEE ELECTRICAL DRAWINGS FOR ADDITIONAL INFORMATION REGARDING SPECIFICATIONS, SWITCHING, EXIT LIGHTS, EMERGENCY LIGHTING, LIFE SAFETY EQUIPMENT AND CIRCUITING.
- E. MECHANICAL INFORMATION SHOWN ON THIS PLAN IS FOR REFERENCE ONLY, SEE MECHANICAL DRAWINGS FOR DIFFUSER LOCATIONS AND FOR ADDITIONAL INFORMATION REGARDING ALL HVAC EQUIPMENT INCLUDING HVAC REGISTERS, GRILLS, ETC.
- DIMENSIONED LIGHT FIXTURES ARE FROM FINISHED FACE OF PARTITIONS TO CENTERLINE OF FIXTURE TO CENTERLINE OF FIXTURE. ANY DISCREPANCIES WITH LOCATION OF LIGHT FIXTURES. SWITCHES, THERMOSTATS, OR DIFFUSERS BETWEEN ARCHITECTURAL AND ENGINEERING DRAWINGS SHALL BE CLARIFIED WITH THE ARCHITECT PRIOR TO INSTALLATION.
- G. THE CONTRACTOR SHALL SUBMIT COORDINATION DRAWINGS THAT INCORPORATES ALL TRADES AS REQUIRED BY THE SPECIFICATIONS.
- H. LIGHT FIXTURES, DIFFUSERS, GRILLES AND ALL OTHER SYSTEM DEVICES SHALL BE LOCATED CENTERED ON CEILING TILES, U.O.N.
- I. ALL ACOUSTICAL TILE CEILINGS SHALL BE CENTERED WITHIN EACH ROOM U.O.N.
- SHALL BE FITTED WITH FLUSH TRIM. K. WHERE DUCTWORK, CONDUIT, AND PIPING MUST CROSS OPEN CEILINGS, ALL WORK
- SHALL BE EXCUTED TO PRESENT A NEAT AND MINIMAL APPREANCE:
- L. ALL EXPOSED WORK SHALL RUN PARALLEL OR PERPENDICULAR TO STRUCTURE, WITH 90 DEGREE BENDS.
- M. LOCATE WORK SO AS TO MINIMIZE EXTENT EXPOSED. LOCATE WORK AS CLOSE AS POSSIBLE TO ADJACENT WALLS OR CEILINGS PLANES.
- N. PROVIDE ADDITIONAL STRUT SUPPORT SYSTEM TO SUPPORT FIXTURES WHERE LIGHT FIXTURES ARE NOT MOUNTED BELOW STRUCTURAL MEMBERS-DO NOT MOUNT TO ROOF
- O. WHERE EXPOSED STRUCTURE IS INDICATED, ALL EXPOSED ROOF DECK, STRUCTURAL STEEL, CONCRETE BEAMS & DECK, PIPES, DUCTS, CONDUITS, ETC. SHALL BE PAINTED
- P. DOWNLIGHTS SHALL BE SYMMETRICALLY CENTERED IN ACOUSTICAL CEILING TILE AND GYPSUM BOARD CEILINGS U.O.N.
- Q. PROVIDE SOFFIT TRANSITIONS BETWEEN ACT CEILINGS AND GYPSUM BOARD CEILINGS
- R. FURNISH AN INSTALL ACCESS DOORS IN GYP. BD. CEILINGS AS REQUIRED TO PROVIDE ACCESS TO ABOVE-CEILINGS VAV BOXES, DAMPERS, VALVES, EQUIPMENT, ETC. SEE MEP DRAWINGS FOR LOCATIONS AND SPECIFICATIONS, COORDINATE FINAL LOCATIONS WITH DESIGNER PRIOR TO INSTALLATION.
- S. ALL GYP. BD. CEILINGS IN WET AREAS SUCH AS TOILET ROOMS, BATHROOMS, AND JANITORS CLOSTES SHALL RECIEVE MOISTURE AND MOLD RESISTANT GYP. BD. AS PER SPECIFICATIONS.
- T. SEE SPECIFICATIONS FOR ADDITIONAL INFORMATION REGARDING CEILING TYPES. U. SEE A-220 SERIES DRAWINGS FOR TYPICAL CEILING DETAILS, U.O.N.
- V. ALL EXTERIOR WINDOWS WILL HAVE MANUAL ROLLER SHADES. REFER TO SPECIFICATIONS AND A-220 SERIES DRAWINGS FOR LOCATION AND DETAILS.
- W. ALL TRAINING ROOMS AND COMMISSIONER MEETING ROOMS WILL HAVE POWERED
- ROLLER SHADES WITH BOTH SOLAR AND BLACKOUT CAPABILITY TO REFER TO
- X. ALL GYP. BOARD SOFFITS AND FASCIAS TO BE PAINTED (PNT-2) U.O.N.

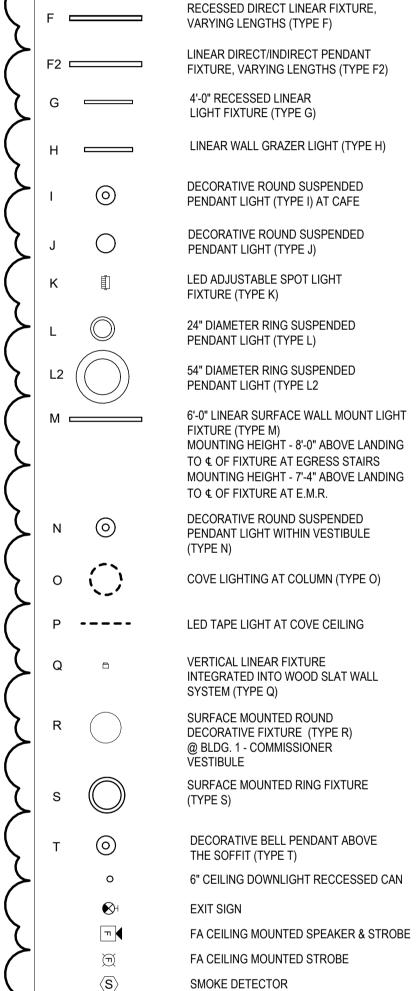

12" x 12" ACCESS DOOR

MS E==== MOTORIZED SHADES

Room name - ROOM NAME

10'-0" 🔫

C • •

-ROOM NUMBER

—CEILING TYPE

—CEILING HEIGHT

GYPSUM BOARD CEILING

HVAC - RETURN

HVAC - SUPPLY

HVAC - LINEAR SUPPLY

PRIVATE OFFICES

OPEN OFFICES

FIXTURE (TYPE D)

FIXTURE (TYPE D2)

FIXTURE (TYPE E)

HVAC - BATHROOM EXHAUST FAN

CEIING LIGHT FIXTURE (TYPE A) @

2'-0" X 2'-0" RECESSED CEIING LIGHT

PENDANT LIGHT FIXTURE (TYPE C) @

FIXTURE (TYPE B) @ UTILITIES 2" x VARYING LENGTH CEILING HUNG

MOUNTING HEIGHT - 8'-0" A.F.F.

2" x 8'-0" RECESSED CEILING LIGHT


2" x 4'-0" RECESSED CEILING LIGHT

4" SQUARE RECESSED DOWNLIGHT

2'-0" X 2'-0" RECESSED TROFFE

2' BY 2' SUSPENDED CEILING GRID, CEILING HEIGHT INDICATED ON PLANS, GRID TO BE CENTERED IN AREA U.O.N.

4' BY 4' SUSPENDED CEILING GRID. CEILING HEIGHT INDICATED ON PLANS, GRID TO BE CENTERED IN AREA U.O.N.

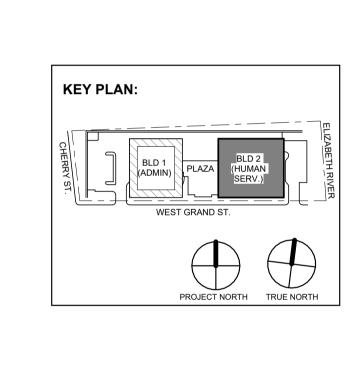

Revisions / Issues

Description

12.01.2023 Addendum No. 1 11.08.2023 For Public Bid

No. Date

ARCHITECTURE FOR CHANGE 15 Bethany Street • New Brunswick, NJ 08901 • T: 732.249.6242 2450 W Hunting Park Ave • Philadelphia, PA 19122 • T: 215.634.3400

Jeffrey D. Venezia, AIA NJ RA AI 00827100

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UNION COUNTY IMPROVEMENT AUTHORITY


UNION COUNTY GOVERNMENT COMPLEX - BUILDING 2 81 & 93 WEST GRAND STREET CITY OF ELIZABETH NEW JERSEY, 07202 Drawing Information: Project No: 20.072

Drawn By: JB / AV / PC Checked By: JM / SH Sheet Name: **BUILDING NO. 2 - LEVEL 1 -**

REFLECTED CEILING PLAN

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A2-211

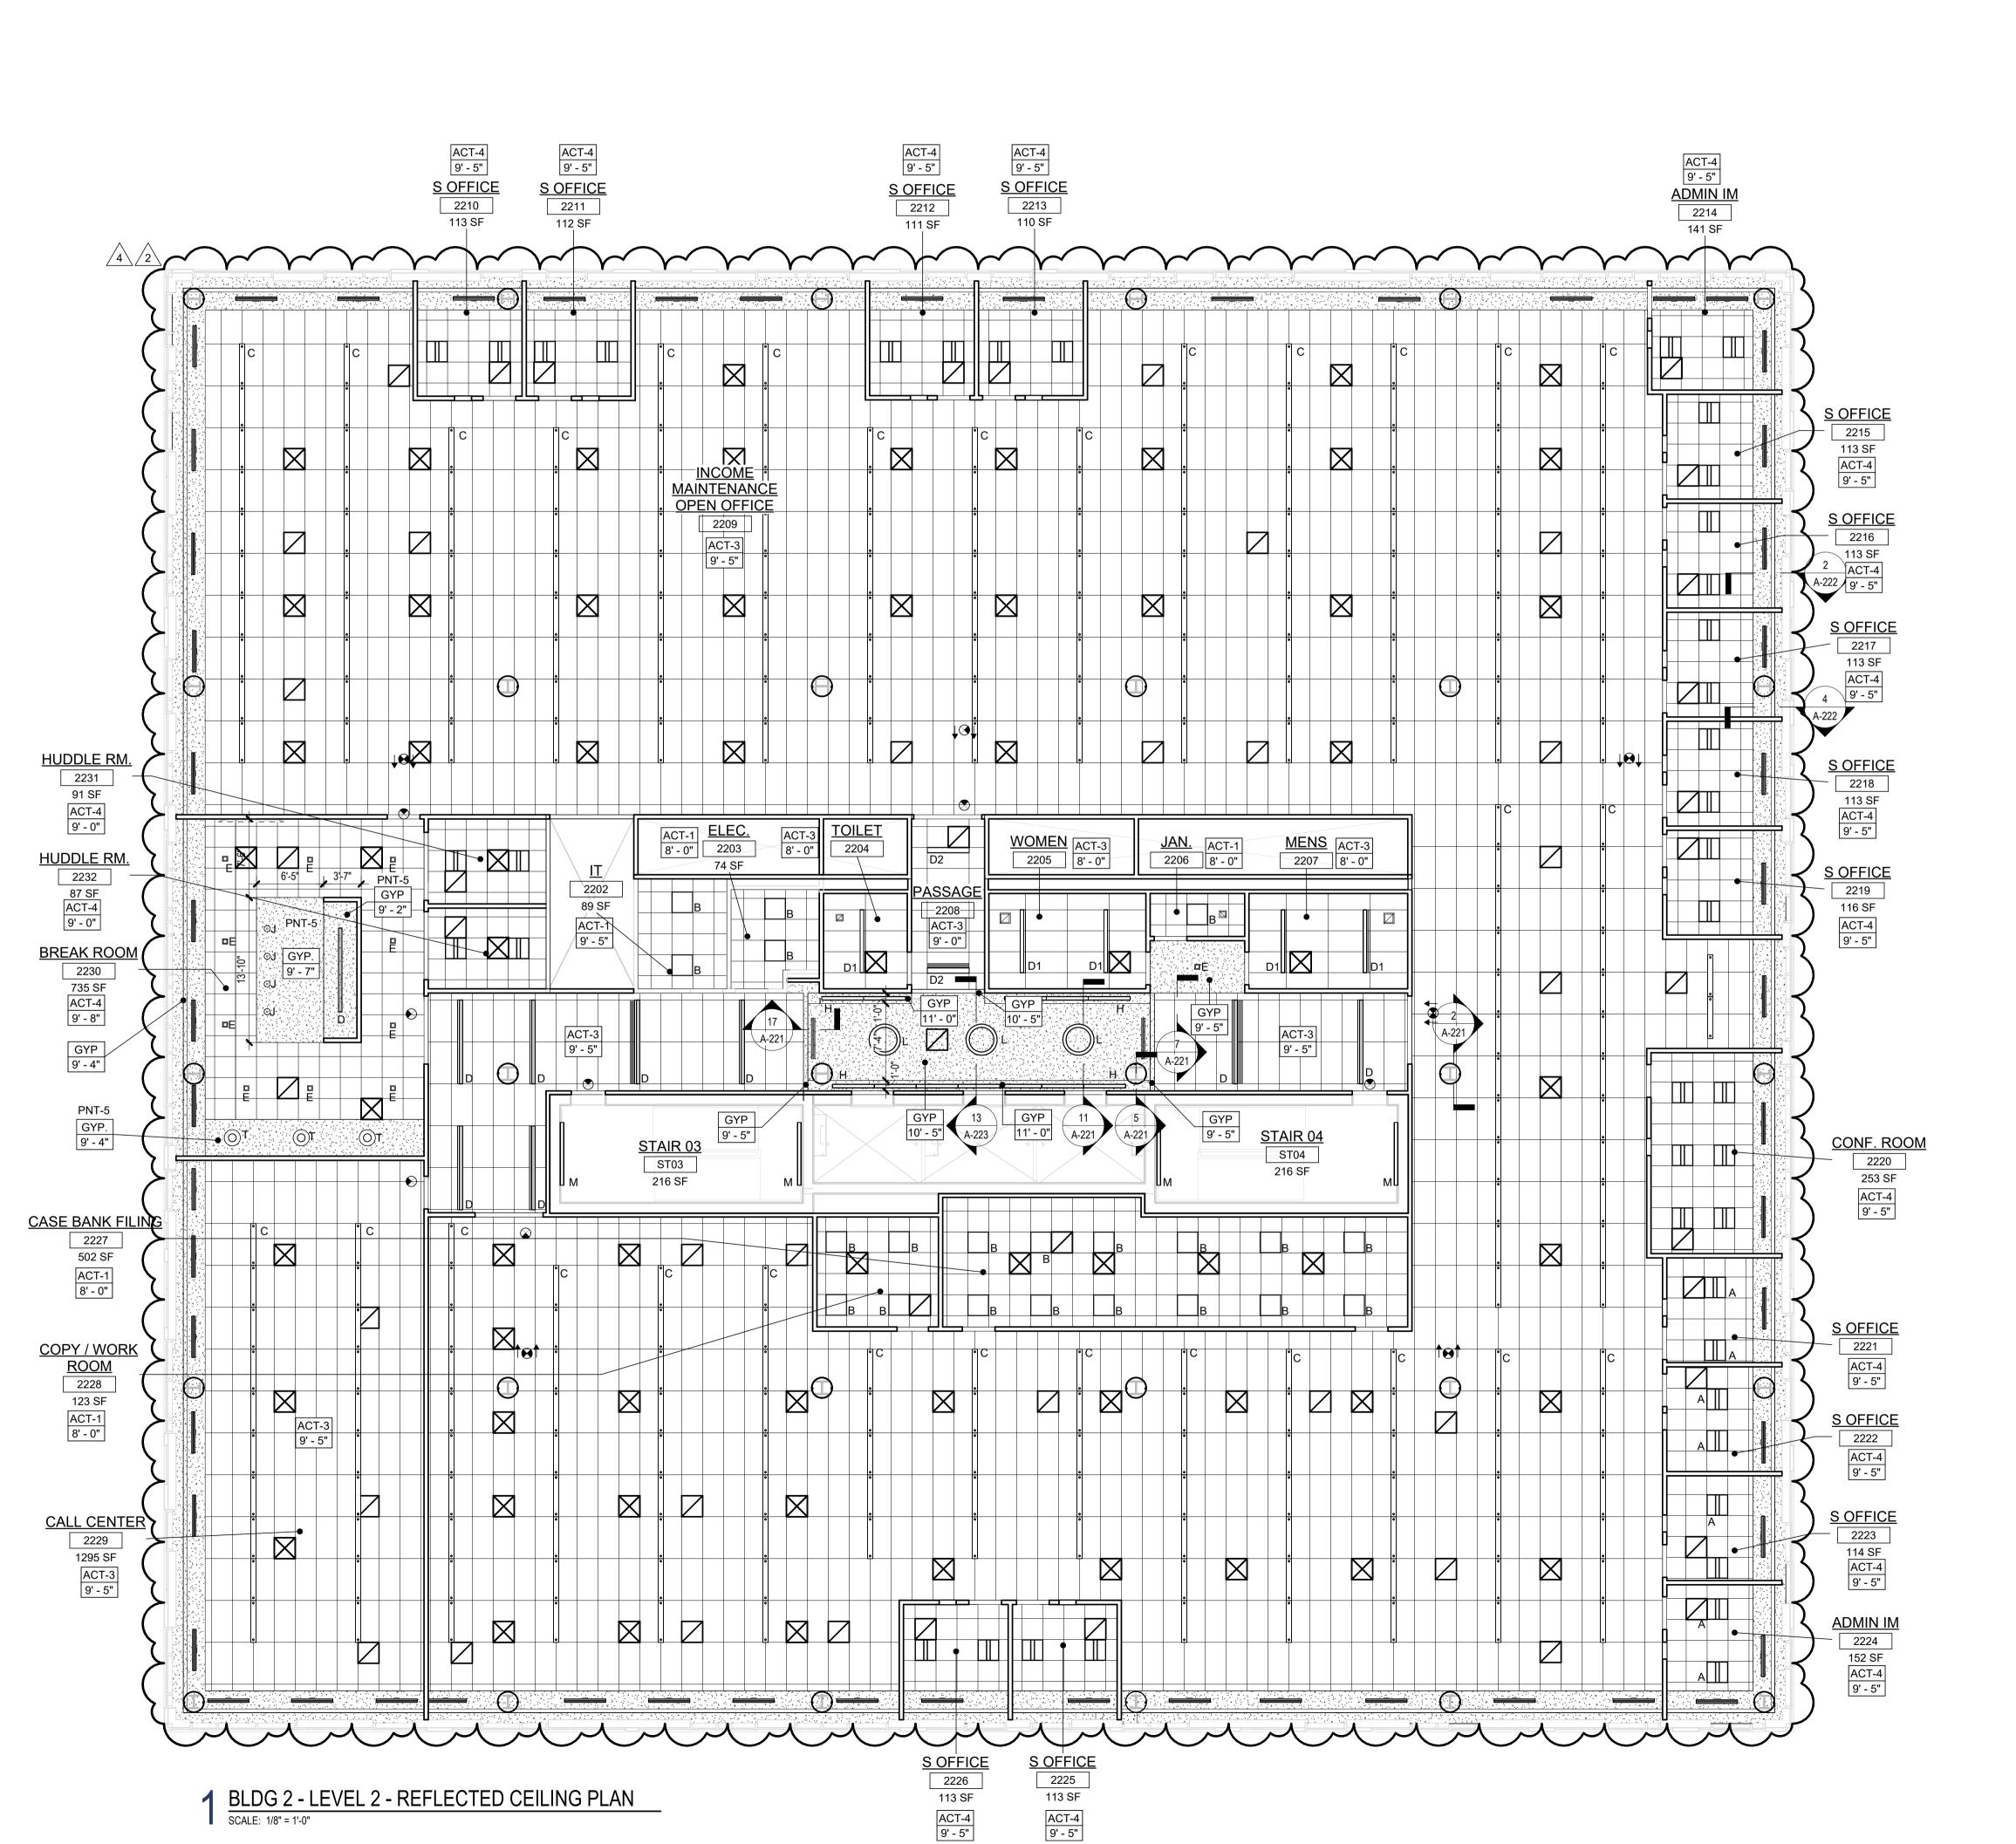

TYPICAL CEILING HEIGHTS (BLDG 2): TYPICAL OPEN OFFICE: TYPICAL PRIVATE OFFICE: 9'-5" A.F.F. TYPICAL CONFERENCE / MEETING ROOM: 9'-5" A.F.F. TYPICAL STORAGE / FILE / COPY ROOM: ELEVATOR CORE: 9'-5" / 10'-5" A.F.F. 8'-0" A.F.F. RESTROOMS:

RCP LEGEND

-ROOM NUMBER

—CEILING TYPE

—CEILING HEIGHT

GYPSUM BOARD CEILING

HVAC - RETURN

HVAC - SUPPLY

HVAC - LINEAR SUPPLY

PRIVATE OFFICES

OPEN OFFICES

FIXTURE (TYPE D)

FIXTURE (TYPE D2)

FIXTURE (TYPE E)

HVAC - BATHROOM EXHAUST FAN

2'-0" X 2'-0" RECESSED CEIING LIGHT

2" x VARYING LENGTH CEILING HUNG PENDANT LIGHT FIXTURE (TYPE C) @

2" x 4'-0" RECESSED CEILING LIGHT

4" SQUARE RECESSED DOWNLIGHT

RECESSED DIRECT LINEAR FIXTURE, VARYING LENGTHS (TYPE F)

LINEAR DIRECT/INDIRECT PENDANT FIXTURE, VARYING LENGTHS (TYPE F2)

LINEAR WALL GRAZER LIGHT (TYPE H)

DECORATIVE ROUND SUSPENDED PENDANT LIGHT (TYPE I) AT CAFE

DECORATIVE ROUND SUSPENDED

PENDANT LIGHT (TYPE J)

PENDANT LIGHT (TYPE L)

PENDANT LIGHT (TYPE L2

TO **⊈** OF FIXTURE AT E.M.R.

DECORATIVE ROUND SUSPENDED

PENDANT LIGHT WITHIN VESTIBULE

COVE LIGHTING AT COLUMN (TYPE O)

LED TAPE LIGHT AT COVE CEILING

INTEGRATED INTO WOOD SLAT WALL

VERTICAL LINEAR FIXTURE

SURFACE MOUNTED ROUND

@ BLDG. 1 - COMMISSIONER

THE SOFFIT (TYPE T)

SMOKE DETECTOR

MS E==== MOTORIZED SHADES

12" x 12" ACCESS DOOR

DECORATIVE FIXTURE (TYPE R)

SURFACE MOUNTED RING FIXTURE

DECORATIVE BELL PENDANT ABOVE

6" CEILING DOWNLIGHT RECCESSED CAN

FA CEILING MOUNTED SPEAKER & STROBE

FA CEILING MOUNTED STROBE

SYSTEM (TYPE Q)

VESTIBULE

FIXTURE (TYPE M)

FIXTURE (TYPE K)

М _____

P ----

LED ADJUSTABLE SPOT LIGHT

24" DIAMETER RING SUSPENDED

54" DIAMETER RING SUSPENDED

6'-0" LINEAR SURFACE WALL MOUNT LIGHT

MOUNTING HEIGHT - 8'-0" ABOVE LANDING

TO **€** OF FIXTURE AT EGRESS STAIRS MOUNTING HEIGHT - 7'-4" ABOVE LANDING

4'-0" RECESSED LINEAR

LIGHT FIXTURE (TYPE G)

2'-0" X 2'-0" RECESSED TROFFE CEIING LIGHT FIXTURE (TYPE A) @

FIXTURE (TYPE B) @ UTILITIES

MOUNTING HEIGHT - 8'-0" A.F.F. 2" x 8'-0" RECESSED CEILING LIGHT

2' BY 2' SUSPENDED CEILING GRID. CEILING HEIGHT INDICATED ON PLANS,

GRID TO BE CENTERED IN AREA U.O.N. 4' BY 4' SUSPENDED CEILING GRID, CEILING HEIGHT INDICATED ON PLANS, GRID TO BE CENTERED IN AREA U.O.N.

Room name Room NAME

101 🚤

10'-0"

FINISH NOTES:

COLUMN / BEAM COVER BASIS OF DESIGN MANUFACTURER: CENTRIA PRODUCT: COLUMN COVERS SERIES 3000

WOOD LOOK ALUMINUM SLATS VARIED WIDTH + DEPTH **BASIS OF DESIGN** MANUFACTURER: CERTAINTEED PRODUCT: MULTI BOX CONTINOUS REFER TO DETAIL 2 / A2-210 FOR ADDITIONAL INFORMATION

MANUAL SHADE SYSTEMS **BASIS OF DESIGN** MANUFACTURER: MECHOSHADE PRODUCT: MECHO/5 SYSTEM

REFLECTED CEILING PLAN NOTES:

- A. BORDERS AT LAY-IN ACOUSTICAL CEILING PANELS SHALL BE CUT TO MATCH FACTORY EDGE PROFILE. NO EXPOSED FASTENERS SHALL BE PERMITTED INCLUDING POP RIVETS AND TAPPETS.
- B. HEIGHT OF CEILINGS SHALL BE MEASURED FROM TOP OF SLAB TO FINISH FACE OF GWB OR FACE OF CEILING GRID AS INDICATED ON THE REFLECTED CEILING PLAN, UON.
- C. ALL LIGHT FIXTURES ARE TO BE INSTALLED IN ACCORDANCE WITH THE ARCHITECTURAL REFLECTED CEILING PLAN. ARCHITECT TO REVIEW CEILING LAYOUT INCLUDING
- D. LIGHT FIXTURES TYPES SHOWN ON ARCHITECTURAL REFLECTED CEILING PLANS ARE NOTED FOR QUANTITIES AND LOCATIONS ONLY. SEE ELECTRICAL DRAWINGS FOR ADDITIONAL INFORMATION REGARDING SPECIFICATIONS, SWITCHING, EXIT LIGHTS,
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- ARCHITECT PRIOR TO INSTALLATION.
- TRADES AS REQUIRED BY THE SPECIFICATIONS.
- H. LIGHT FIXTURES, DIFFUSERS, GRILLES AND ALL OTHER SYSTEM DEVICES SHALL BE LOCATED CENTERED ON CEILING TILES, U.O.N.
- J. ALL FLUSH MOUNTED LIGHT FIXTURES MOUNTED WITHTIN A GYPSUM BOARD CEILING

- M. LOCATE WORK SO AS TO MINIMIZE EXTENT EXPOSED. LOCATE WORK AS CLOSE AS
- O. WHERE EXPOSED STRUCTURE IS INDICATED, ALL EXPOSED ROOF DECK, STRUCTURAL
- TO MATCH CEILING COLOR; SEE FINISH SCHEDULE.
- GYPSUM BOARD CEILINGS U.O.N.
- R. FURNISH AN INSTALL ACCESS DOORS IN GYP. BD. CEILINGS AS REQUIRED TO PROVIDE
- S. ALL GYP. BD. CEILINGS IN WET AREAS SUCH AS TOILET ROOMS, BATHROOMS, AND JANITORS CLOSTES SHALL RECIEVE MOISTURE AND MOLD RESISTANT GYP. BD. AS PER
- V. ALL EXTERIOR WINDOWS WILL HAVE MANUAL ROLLER SHADES. REFER TO
- W. ALL TRAINING ROOMS AND COMMISSIONER MEETING ROOMS WILL HAVE POWERED

- BULKHEADS AND GRID PRIOR TO INSTALLATION.
- EMERGENCY LIGHTING, LIFE SAFETY EQUIPMENT AND CIRCUITING.


- SHALL BE FITTED WITH FLUSH TRIM.
- SHALL BE EXCUTED TO PRESENT A NEAT AND MINIMAL APPREANCE:
- 90 DEGREE BENDS.


- Q. PROVIDE SOFFIT TRANSITIONS BETWEEN ACT CEILINGS AND GYPSUM BOARD CEILINGS
- MEP DRAWINGS FOR LOCATIONS AND SPECIFICATIONS, COORDINATE FINAL LOCATIONS WITH DESIGNER PRIOR TO INSTALLATION.
- T. SEE SPECIFICATIONS FOR ADDITIONAL INFORMATION REGARDING CEILING TYPES.
- U. SEE A-220 SERIES DRAWINGS FOR TYPICAL CEILING DETAILS, U.O.N.
- SPECIFICATIONS.

- F. DIMENSIONED LIGHT FIXTURES ARE FROM FINISHED FACE OF PARTITIONS TO CENTERLINE OF FIXTURE TO CENTERLINE OF FIXTURE. ANY DISCREPANCIES WITH LOCATION OF LIGHT FIXTURES, SWITCHES, THERMOSTATS, OR DIFFUSERS BETWEEN ARCHITECTURAL AND ENGINEERING DRAWINGS SHALL BE CLARIFIED WITH THE
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- N. PROVIDE ADDITIONAL STRUT SUPPORT SYSTEM TO SUPPORT FIXTURES WHERE LIGHT FIXTURES ARE NOT MOUNTED BELOW STRUCTURAL MEMBERS-DO NOT MOUNT TO ROOF
- STEEL, CONCRETE BEAMS & DECK, PIPES, DUCTS, CONDUITS, ETC. SHALL BE PAINTED
- P. DOWNLIGHTS SHALL BE SYMMETRICALLY CENTERED IN ACOUSTICAL CEILING TILE AND
- ACCESS TO ABOVE-CEILINGS VAV BOXES, DAMPERS, VALVES, EQUIPMENT, ETC. SEE

- SPECIFICATIONS AND A-220 SERIES DRAWINGS FOR LOCATION AND DETAILS.
- ROLLER SHADES WITH BOTH SOLAR AND BLACKOUT CAPABILITY TO REFER TO

X. ALL GYP. BOARD SOFFITS AND FASCIAS TO BE PAINTED (PNT-2) U.O.N.

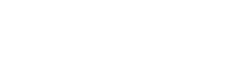

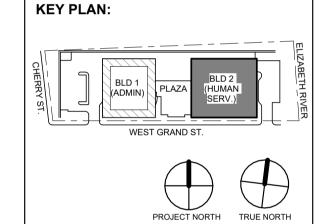

12.08.2023 Addendum No. 2 11.08.2023 For Public Bid No. Date Description Revisions / Issues

ARCHITECTURE FOR CHANGE

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UNION COUNTY IMPROVEMENT

Sheet Name:

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AUTHORITY


UNION COUNTY GOVERNMENT COMPLEX - BUILDING 2 81 & 93 WEST GRAND STREET CITY OF ELIZABETH NEW JERSEY, 07202

Drawing Information: Project No: 20.072 Date: 11.08.2023 Drawn By: JB / AV / PC Checked By: JM / SH


BUILDING NO. 2 - LEVEL 2 -REFLECTED CEILING PLAN

Sheet No:

A2-212

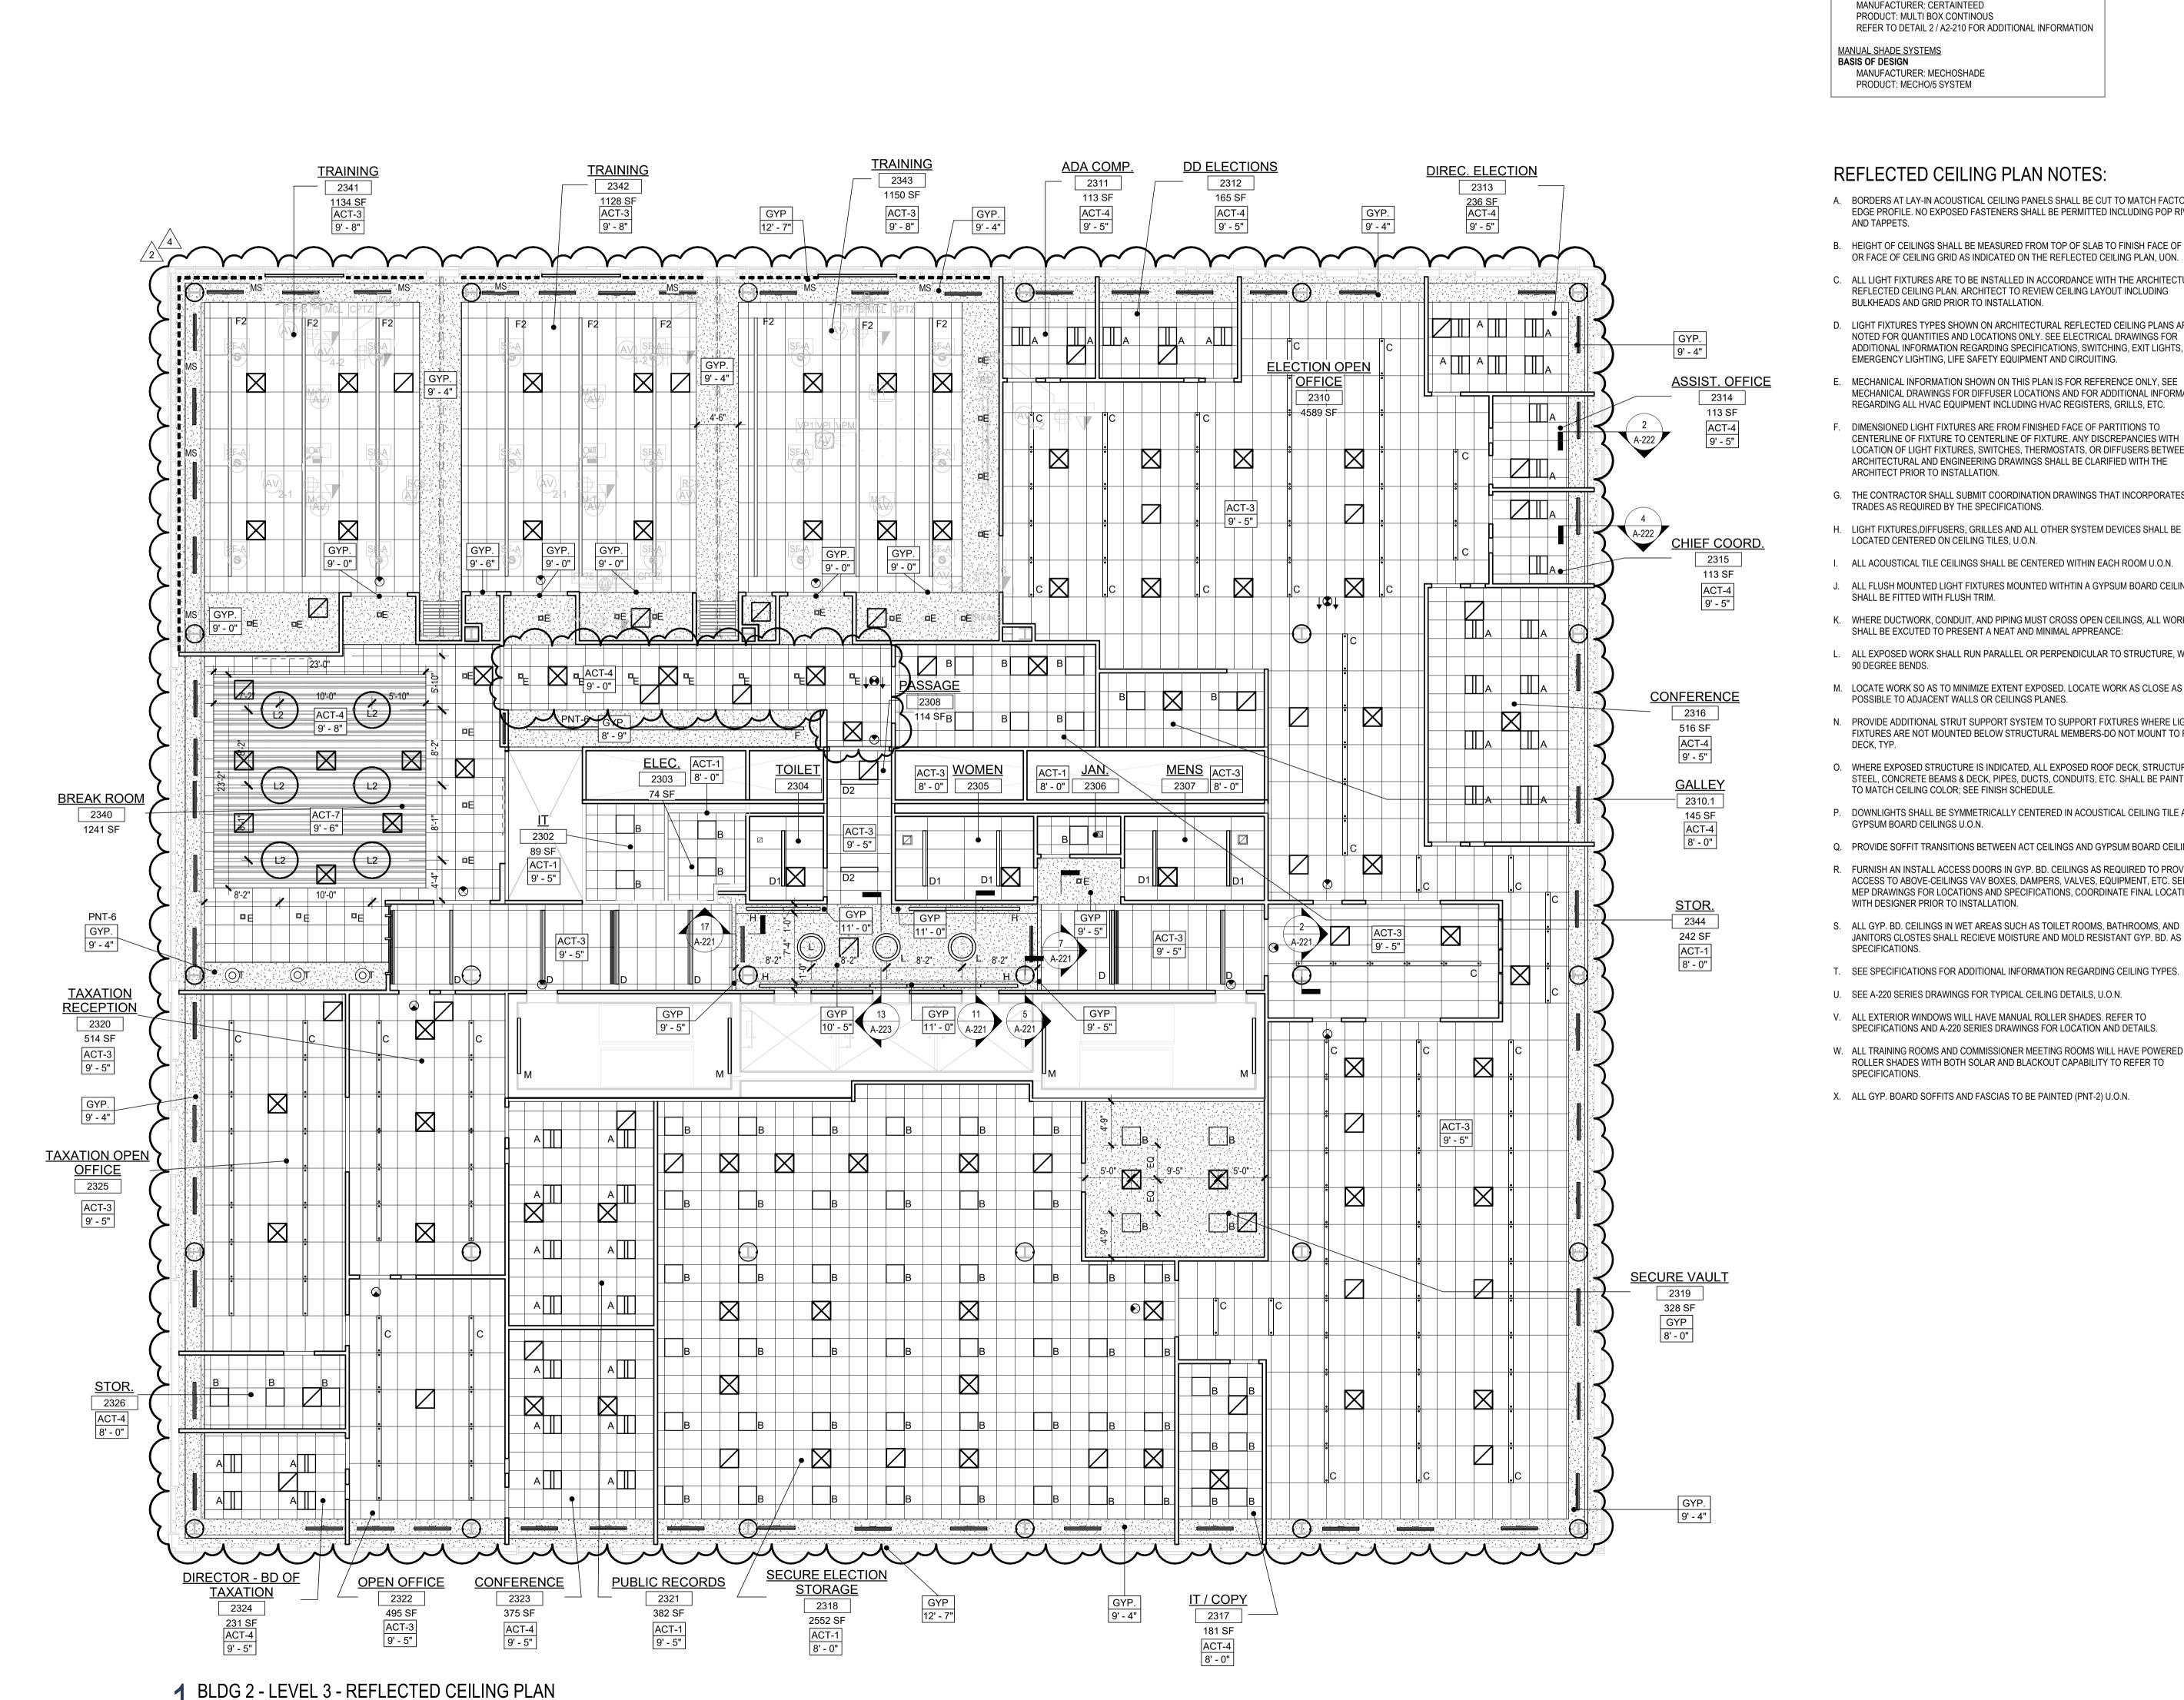

SCALE: 1/8" = 1'-0"

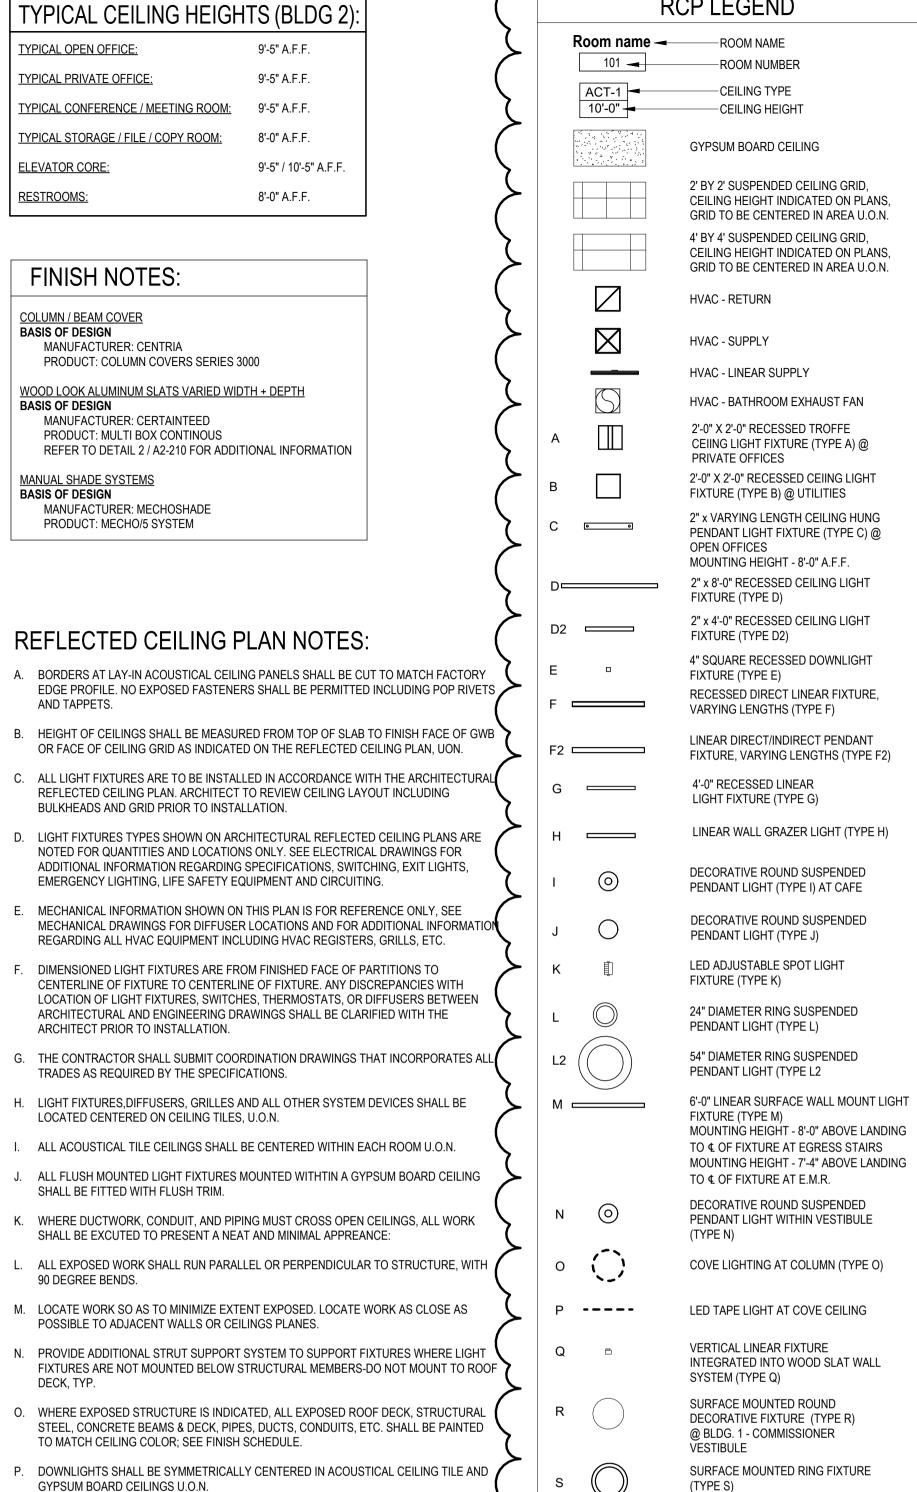

Q. PROVIDE SOFFIT TRANSITIONS BETWEEN ACT CEILINGS AND GYPSUM BOARD CEILINGS

MEP DRAWINGS FOR LOCATIONS AND SPECIFICATIONS, COORDINATE FINAL LOCATIONS

JANITORS CLOSTES SHALL RECIEVE MOISTURE AND MOLD RESISTANT GYP. BD. AS PER

R. FURNISH AN INSTALL ACCESS DOORS IN GYP. BD. CEILINGS AS REQUIRED TO PROVIDE ACCESS TO ABOVE-CEILINGS VAV BOXES, DAMPERS, VALVES, EQUIPMENT, ETC. SEE

WITH DESIGNER PRIOR TO INSTALLATION.

SPECIFICATIONS.


U. SEE A-220 SERIES DRAWINGS FOR TYPICAL CEILING DETAILS, U.O.N.

SPECIFICATIONS AND A-220 SERIES DRAWINGS FOR LOCATION AND DETAILS.

W. ALL TRAINING ROOMS AND COMMISSIONER MEETING ROOMS WILL HAVE POWERED

ROLLER SHADES WITH BOTH SOLAR AND BLACKOUT CAPABILITY TO REFER TO

RCP LEGEND

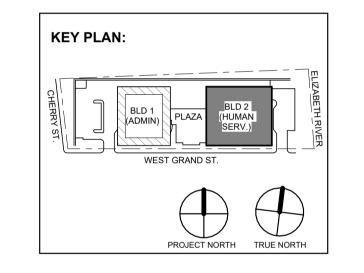

11.08.2023 For Public Bid No. Date Description Revisions / Issues

12.08.2023 Addendum No. 2

ARCHITECTURE FOR CHANGE

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Jeffrey D. Venezia, AIA NJ RA AI 00827100

DECORATIVE BELL PENDANT ABOVE

6" CEILING DOWNLIGHT RECCESSED CAN

FA CEILING MOUNTED SPEAKER & STROBE

FA CEILING MOUNTED STROBE

THE SOFFIT (TYPE T)

SMOKE DETECTOR

MS E==== MOTORIZED SHADES

12" x 12" ACCESS DOOR

DO NOT SCALE. DRAWING MAY BE PRINTED AT REDUCED SCALE. CONSULT WITH ARCHITECT FOR DIMENSIONS.

UNION COUNTY IMPROVEMENT AUTHORITY

UNION COUNTY GOVERNMENT COMPLEX - BUILDING 2 81 & 93 WEST GRAND STREET CITY OF ELIZABETH NEW JERSEY, 07202 Drawing Information: Project No: 20.072


Date: 11.08.2023 Drawn By: JB / AV / PC Checked By: JM / SH Sheet Name:

BUILDING NO.2 - LEVEL 3 -REFLECTED CEILING PLAN

Sheet No:

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A2-213

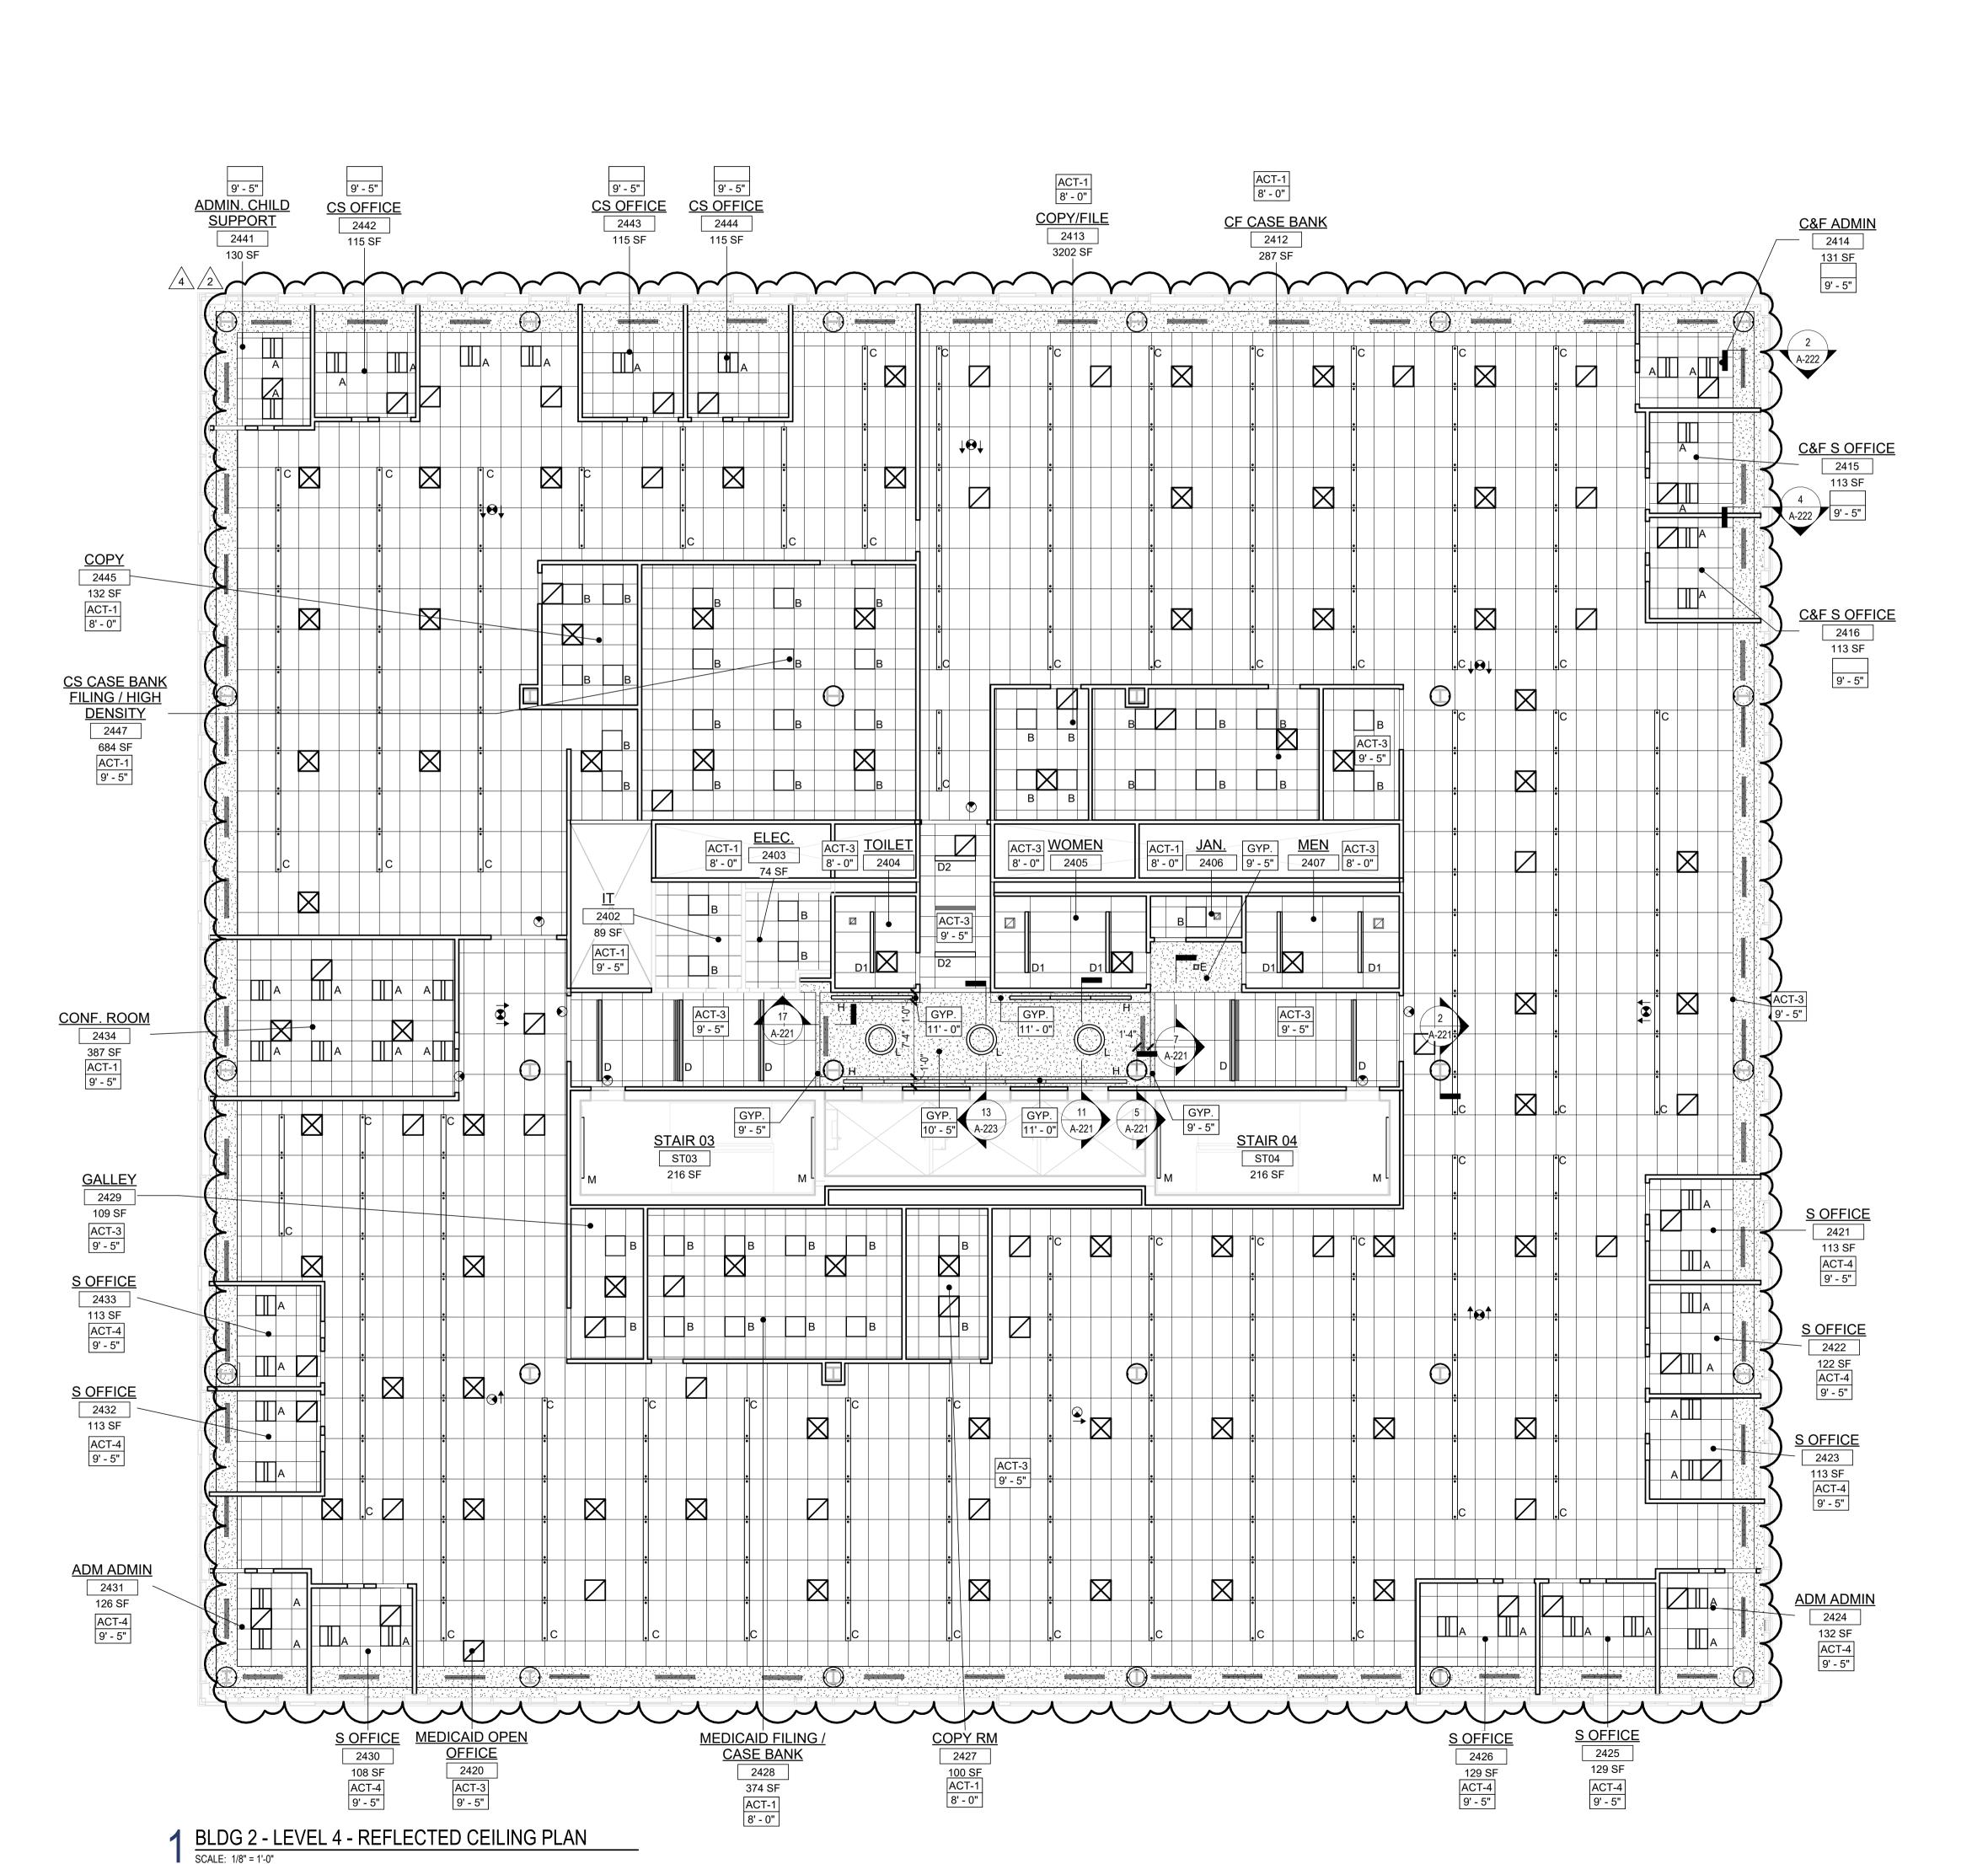

TYPICAL CEILING HEIGHTS (BLDG 2): TYPICAL OPEN OFFICE: 9'-5" A.F.F. **TYPICAL PRIVATE OFFICE:** 9'-5" A.F.F. TYPICAL CONFERENCE / MEETING ROOM: 9'-5" A.F.F. TYPICAL STORAGE / FILE / COPY ROOM: 8'-0" A.F.F. **ELEVATOR CORE:** 9'-5" / 10'-5" A.F.F. RESTROOMS: 8'-0" A.F.F.


FINISH NOTES: COLUMN / BEAM COVER BASIS OF DESIGN MANUFACTURER: CENTRIA PRODUCT: COLUMN COVERS SERIES 3000 WOOD LOOK ALUMINUM SLATS VARIED WIDTH + DEPTH **BASIS OF DESIGN** MANUFACTURER: CERTAINTEED PRODUCT: MULTI BOX CONTINOUS REFER TO DETAIL 2 / A2-210 FOR ADDITIONAL INFORMATION MANUAL SHADE SYSTEMS **BASIS OF DESIGN**

REFLECTED CEILING PLAN NOTES:

MANUFACTURER: MECHOSHADE

PRODUCT: MECHO/5 SYSTEM

- A. BORDERS AT LAY-IN ACOUSTICAL CEILING PANELS SHALL BE CUT TO MATCH FACTORY EDGE PROFILE. NO EXPOSED FASTENERS SHALL BE PERMITTED INCLUDING POP RIVETS AND TAPPETS.
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- I. ALL ACOUSTICAL TILE CEILINGS SHALL BE CENTERED WITHIN EACH ROOM U.O.N.
- J. ALL FLUSH MOUNTED LIGHT FIXTURES MOUNTED WITHTIN A GYPSUM BOARD CEILING SHALL BE FITTED WITH FLUSH TRIM.
- K. WHERE DUCTWORK, CONDUIT, AND PIPING MUST CROSS OPEN CEILINGS, ALL WORK SHALL BE EXCUTED TO PRESENT A NEAT AND MINIMAL APPREANCE:
- L. ALL EXPOSED WORK SHALL RUN PARALLEL OR PERPENDICULAR TO STRUCTURE, WITH 90 DEGREE BENDS.
- M. LOCATE WORK SO AS TO MINIMIZE EXTENT EXPOSED. LOCATE WORK AS CLOSE AS POSSIBLE TO ADJACENT WALLS OR CEILINGS PLANES.
- N. PROVIDE ADDITIONAL STRUT SUPPORT SYSTEM TO SUPPORT FIXTURES WHERE LIGHT FIXTURES ARE NOT MOUNTED BELOW STRUCTURAL MEMBERS-DO NOT MOUNT TO ROOF
- O. WHERE EXPOSED STRUCTURE IS INDICATED, ALL EXPOSED ROOF DECK, STRUCTURAL STEEL, CONCRETE BEAMS & DECK, PIPES, DUCTS, CONDUITS, ETC. SHALL BE PAINTED TO MATCH CEILING COLOR; SEE FINISH SCHEDULE.
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- T. SEE SPECIFICATIONS FOR ADDITIONAL INFORMATION REGARDING CEILING TYPES.
- U. SEE A-220 SERIES DRAWINGS FOR TYPICAL CEILING DETAILS, U.O.N.
- V. ALL EXTERIOR WINDOWS WILL HAVE MANUAL ROLLER SHADES. REFER TO
- SPECIFICATIONS AND A-220 SERIES DRAWINGS FOR LOCATION AND DETAILS.
- W. ALL TRAINING ROOMS AND COMMISSIONER MEETING ROOMS WILL HAVE POWERED ROLLER SHADES WITH BOTH SOLAR AND BLACKOUT CAPABILITY TO REFER TO SPECIFICATIONS.
- X. ALL GYP. BOARD SOFFITS AND FASCIAS TO BE PAINTED (PNT-2) U.O.N.

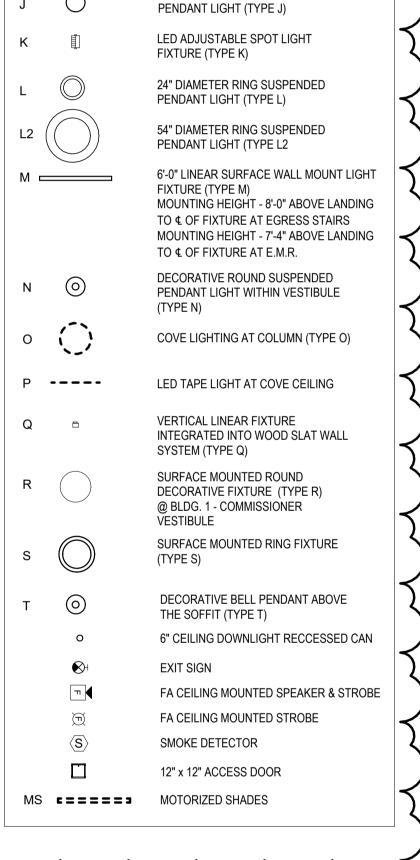

Room name - ROOM NAME

ACT-1

10'-0"

F2 _____

-ROOM NUMBER

-CEILING TYPE

—CEILING HEIGHT

GYPSUM BOARD CEILING

HVAC - RETURN

HVAC - SUPPLY

HVAC - LINEAR SUPPLY

PRIVATE OFFICES

OPEN OFFICES

FIXTURE (TYPE D)

FIXTURE (TYPE D2)

FIXTURE (TYPE E)

HVAC - BATHROOM EXHAUST FAN

CEIING LIGHT FIXTURE (TYPE A) @

2'-0" X 2'-0" RECESSED CEIING LIGHT

2" x VARYING LENGTH CEILING HUNG

PENDANT LIGHT FIXTURE (TYPE C) @

2'-0" X 2'-0" RECESSED TROFFE

FIXTURE (TYPE B) @ UTILITIES

MOUNTING HEIGHT - 8'-0" A.F.F. 2" x 8'-0" RECESSED CEILING LIGHT

2" x 4'-0" RECESSED CEILING LIGHT

4" SQUARE RECESSED DOWNLIGHT

RECESSED DIRECT LINEAR FIXTURE,

LINEAR DIRECT/INDIRECT PENDANT

FIXTURE, VARYING LENGTHS (TYPE F2)

LINEAR WALL GRAZER LIGHT (TYPE H)

DECORATIVE ROUND SUSPENDED PENDANT LIGHT (TYPE I) AT CAFE

DECORATIVE ROUND SUSPENDED


VARYING LENGTHS (TYPE F)

4'-0" RECESSED LINEAR

LIGHT FIXTURE (TYPE G)

2' BY 2' SUSPENDED CEILING GRID,

CEILING HEIGHT INDICATED ON PLANS, GRID TO BE CENTERED IN AREA U.O.N. 4' BY 4' SUSPENDED CEILING GRID, CEILING HEIGHT INDICATED ON PLANS, GRID TO BE CENTERED IN AREA U.O.N.

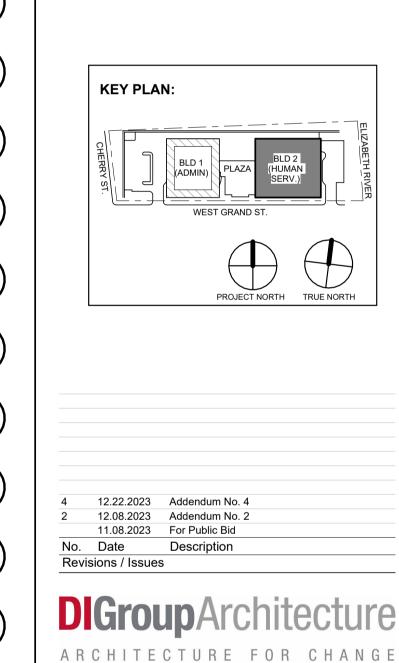

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UNION COUNTY IMPROVEMENT AUTHORITY


UNION COUNTY GOVERNMENT COMPLEX - BUILDING 2 81 & 93 WEST GRAND STREET CITY OF ELIZABETH NEW JERSEY, 07202 **Drawing Information:** Project No: 20.072


Drawn By: JB / AV / PC Checked By: JM / SH Sheet Name:

BUILDING NO.2 - LEVEL 4 -REFLECTED CEILING PLAN

A2-214

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FINISH NOTES:

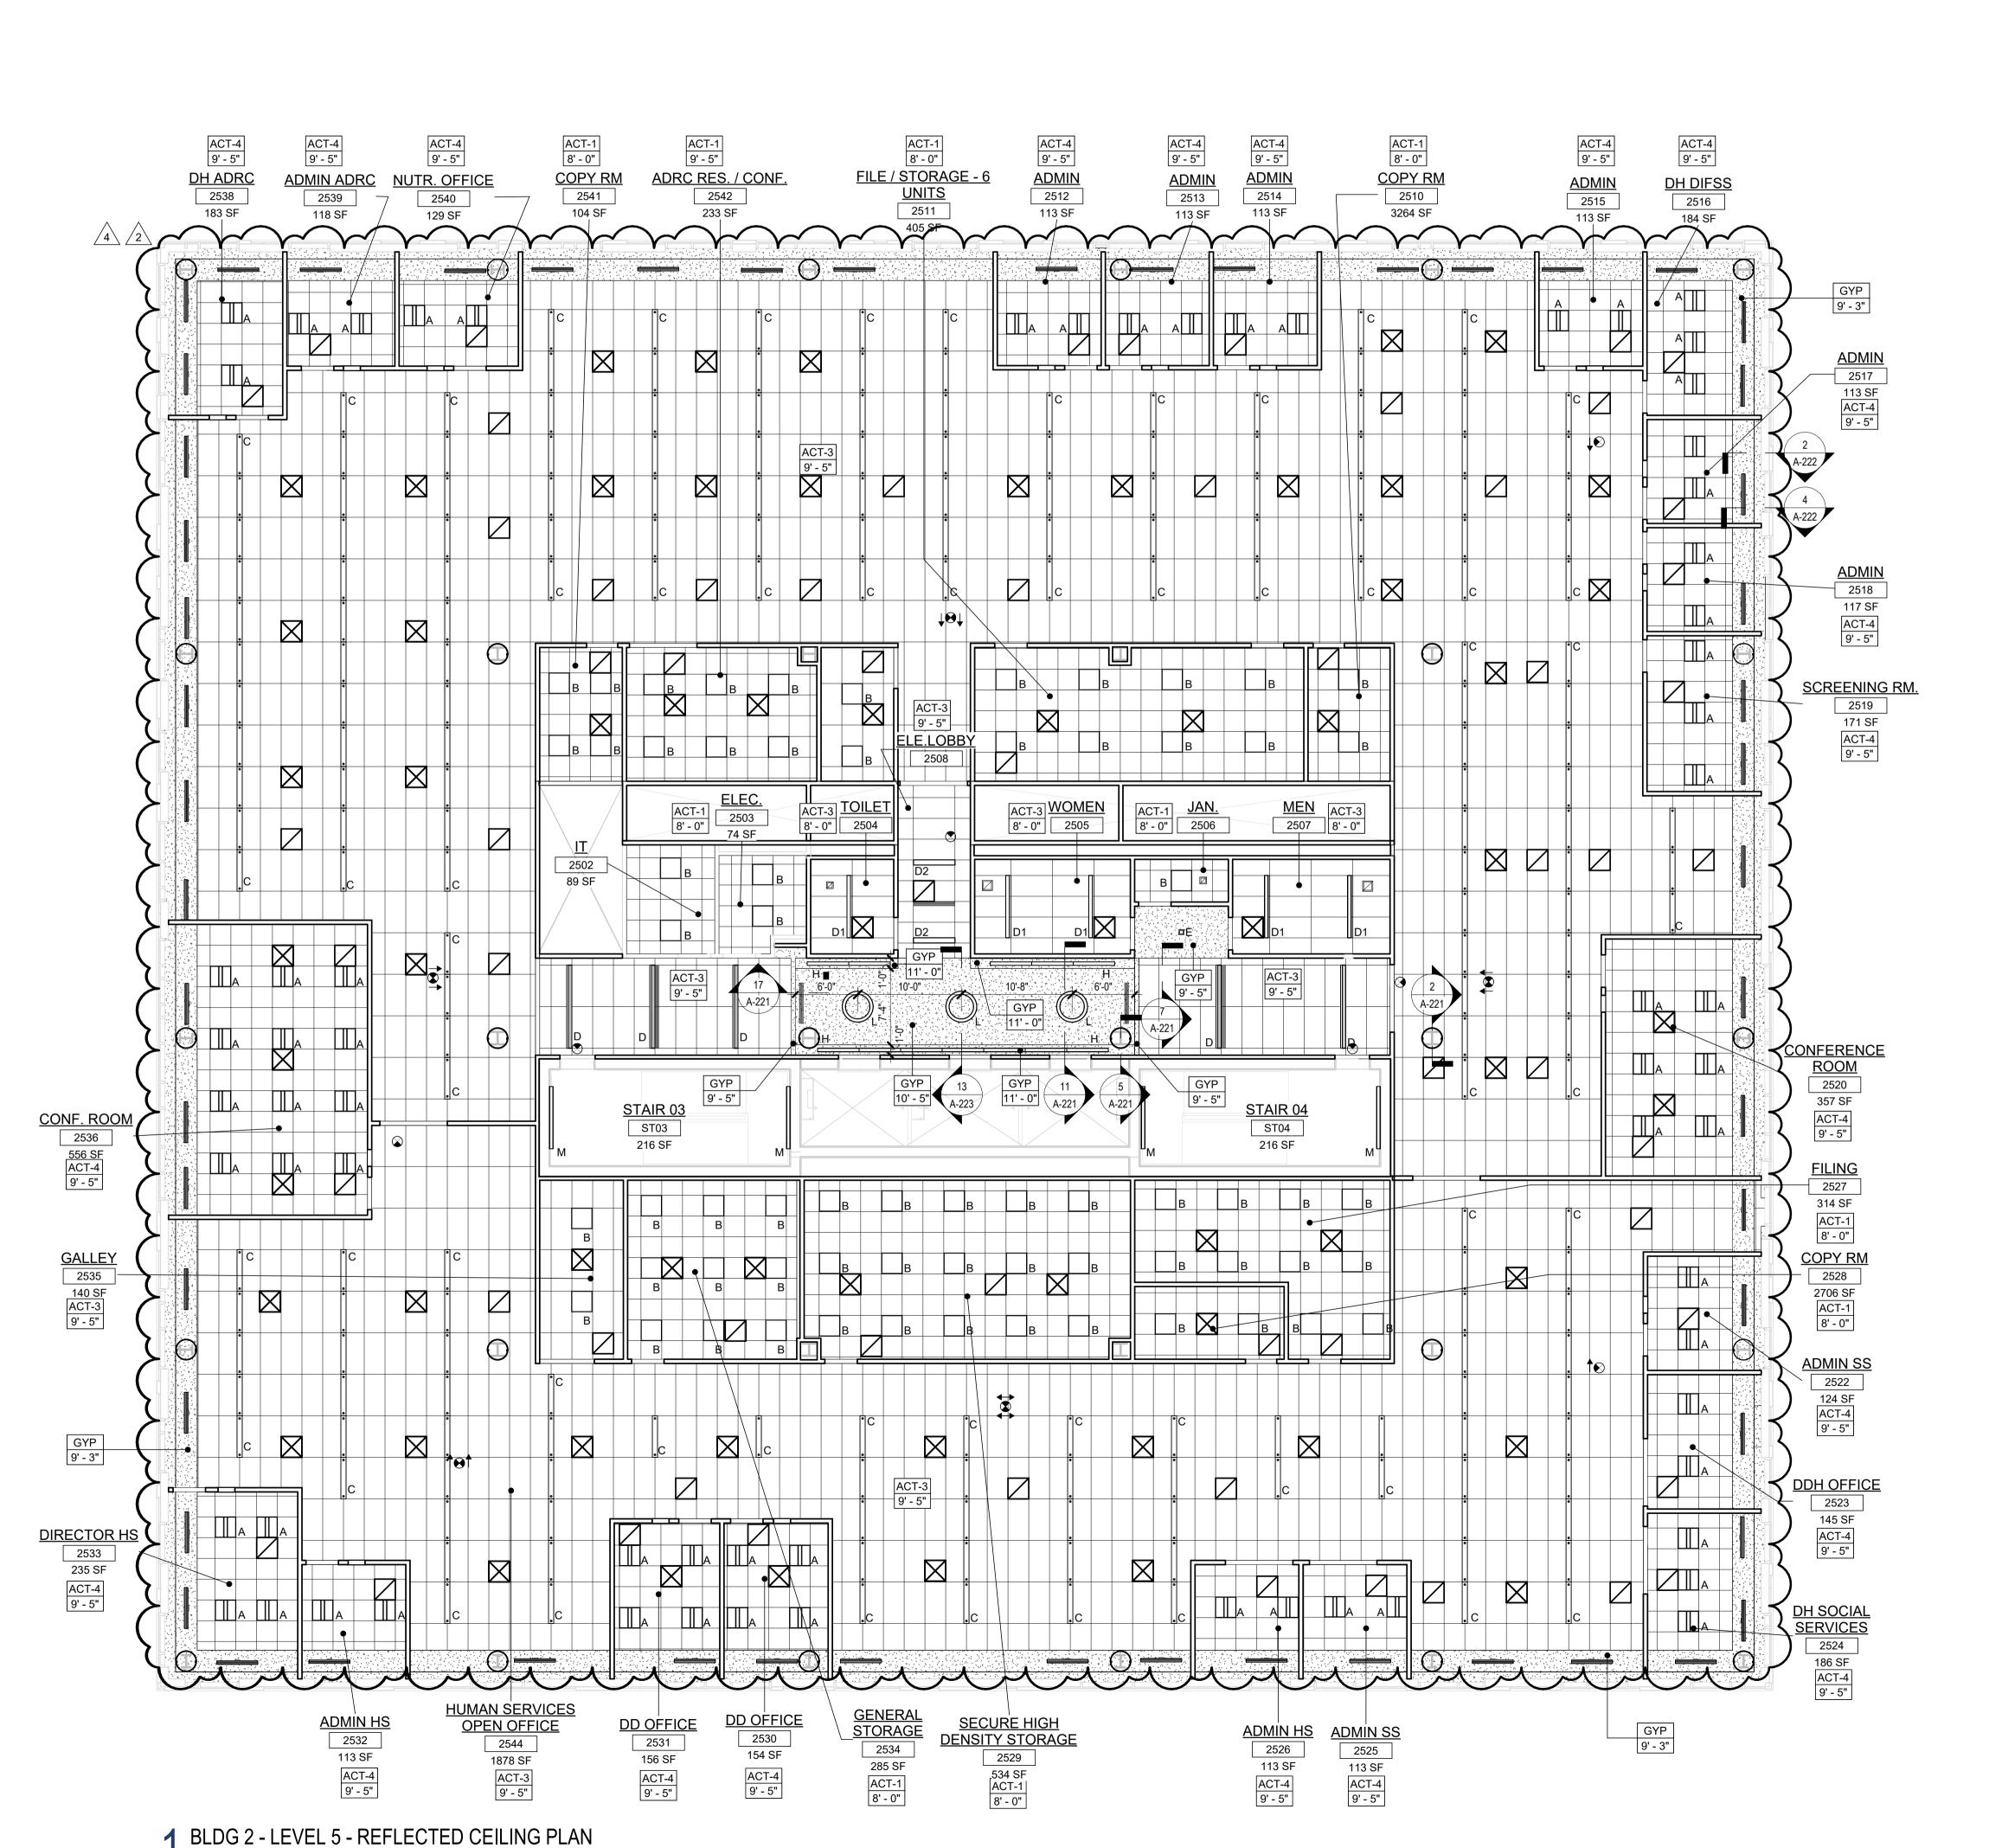COLUMN / BEAM COVER
BASIS OF DESIGN

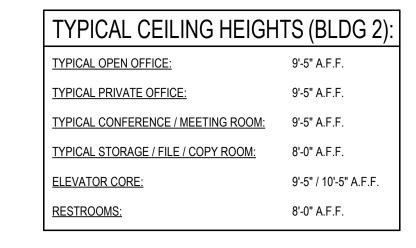MANUFACTURER: CENTRIA
PRODUCT: COLUMN COVERS SERIES 3000

WOOD LOOK ALUMINUM SLATS VARIED WIDTH + DEPTH
BASIS OF DESIGN

MANUFACTURER: CERTAINTEED
PRODUCT: MULTI BOX CONTINOUS
REFER TO DETAIL 2 / A2-210 FOR ADDITIONAL INFORMATION

MANUAL SHADE SYSTEMS

PRODUCT: MECHO/5 SYSTEM

MANUFACTURER: MECHOSHADE

BASIS OF DESIGN

A. BORDERS AT LAY-IN ACOUSTICAL CEILING PANELS SHALL BE CUT TO MATCH FACTORY EDGE PROFILE. NO EXPOSED FASTENERS SHALL BE PERMITTED INCLUDING POP RIVETS AND TAPPETS.

REFLECTED CEILING PLAN NOTES:

BULKHEADS AND GRID PRIOR TO INSTALLATION.

- B. HEIGHT OF CEILINGS SHALL BE MEASURED FROM TOP OF SLAB TO FINISH FACE OF GWB OR FACE OF CEILING GRID AS INDICATED ON THE REFLECTED CEILING PLAN, UON.
- C. ALL LIGHT FIXTURES ARE TO BE INSTALLED IN ACCORDANCE WITH THE ARCHITECTURAL REFLECTED CEILING PLAN. ARCHITECT TO REVIEW CEILING LAYOUT INCLUDING
- D. LIGHT FIXTURES TYPES SHOWN ON ARCHITECTURAL REFLECTED CEILING PLANS ARE NOTED FOR QUANTITIES AND LOCATIONS ONLY. SEE ELECTRICAL DRAWINGS FOR ADDITIONAL INFORMATION REGARDING SPECIFICATIONS, SWITCHING, EXIT LIGHTS, EMERGENCY LIGHTING, LIFE SAFETY EQUIPMENT AND CIRCUITING.
- E. MECHANICAL INFORMATION SHOWN ON THIS PLAN IS FOR REFERENCE ONLY, SEE MECHANICAL DRAWINGS FOR DIFFUSER LOCATIONS AND FOR ADDITIONAL INFORMATION REGARDING ALL HVAC EQUIPMENT INCLUDING HVAC REGISTERS, GRILLS, ETC.
- F. DIMENSIONED LIGHT FIXTURES ARE FROM FINISHED FACE OF PARTITIONS TO CENTERLINE OF FIXTURE TO CENTERLINE OF FIXTURE. ANY DISCREPANCIES WITH LOCATION OF LIGHT FIXTURES, SWITCHES, THERMOSTATS, OR DIFFUSERS BETWEEN ARCHITECTURAL AND ENGINEERING DRAWINGS SHALL BE CLARIFIED WITH THE ARCHITECT PRIOR TO INSTALLATION.
- G. THE CONTRACTOR SHALL SUBMIT COORDINATION DRAWINGS THAT INCORPORATES ALL TRADES AS REQUIRED BY THE SPECIFICATIONS.
- H. LIGHT FIXTURES, DIFFUSERS, GRILLES AND ALL OTHER SYSTEM DEVICES SHALL BE LOCATED CENTERED ON CEILING TILES, U.O.N.
- I. ALL ACOUSTICAL TILE CEILINGS SHALL BE CENTERED WITHIN EACH ROOM U.O.N.
- J. ALL FLUSH MOUNTED LIGHT FIXTURES MOUNTED WITHTIN A GYPSUM BOARD CEILING SHALL BE FITTED WITH FLUSH TRIM.
- SHALL BE EXCUTED TO PRESENT A NEAT AND MINIMAL APPREANCE:

K. WHERE DUCTWORK, CONDUIT, AND PIPING MUST CROSS OPEN CEILINGS, ALL WORK

- L. ALL EXPOSED WORK SHALL RUN PARALLEL OR PERPENDICULAR TO STRUCTURE, WITH 90 DEGREE BENDS.
- M. LOCATE WORK SO AS TO MINIMIZE EXTENT EXPOSED. LOCATE WORK AS CLOSE AS POSSIBLE TO ADJACENT WALLS OR CEILINGS PLANES.
- N. PROVIDE ADDITIONAL STRUT SUPPORT SYSTEM TO SUPPORT FIXTURES WHERE LIGHT FIXTURES ARE NOT MOUNTED BELOW STRUCTURAL MEMBERS-DO NOT MOUNT TO ROOF
- DECK, TYP.

 O. WHERE EXPOSED STRUCTURE IS INDICATED, ALL EXPOSED ROOF DECK, STRUCTURAL
- STEEL, CONCRETE BEAMS & DECK, PIPES, DUCTS, CONDUITS, ETC. SHALL BE PAINTED TO MATCH CEILING COLOR; SEE FINISH SCHEDULE.
- P. DOWNLIGHTS SHALL BE SYMMETRICALLY CENTERED IN ACOUSTICAL CEILING TILE AND GYPSUM BOARD CEILINGS U.O.N.
- Q. PROVIDE SOFFIT TRANSITIONS BETWEEN ACT CEILINGS AND GYPSUM BOARD CEILINGS
 R. FURNISH AN INSTALL ACCESS DOORS IN GYP. BD. CEILINGS AS REQUIRED TO PROVIDE ACCESS TO ABOVE-CEILINGS VAV BOXES, DAMPERS, VALVES, EQUIPMENT, ETC. SEE MEP DRAWINGS FOR LOCATIONS AND SPECIFICATIONS, COORDINATE FINAL LOCATIONS WITH DESIGNER PRIOR TO INSTALLATION.
- S. ALL GYP. BD. CEILINGS IN WET AREAS SUCH AS TOILET ROOMS, BATHROOMS, AND JANITORS CLOSTES SHALL RECIEVE MOISTURE AND MOLD RESISTANT GYP. BD. AS PER SPECIFICATIONS.
- T. SEE SPECIFICATIONS FOR ADDITIONAL INFORMATION REGARDING CEILING TYPES.
- U. SEE A-220 SERIES DRAWINGS FOR TYPICAL CEILING DETAILS, U.O.N.
- V. ALL EXTERIOR WINDOWS WILL HAVE MANUAL ROLLER SHADES. REFER TO SPECIFICATIONS AND A-220 SERIES DRAWINGS FOR LOCATION AND DETAILS.
- W. ALL TRAINING ROOMS AND COMMISSIONER MEETING ROOMS WILL HAVE POWERED ROLLER SHADES WITH BOTH SOLAR AND BLACKOUT CAPABILITY TO REFER TO SPECIFICATIONS.
- X. ALL GYP. BOARD SOFFITS AND FASCIAS TO BE PAINTED (PNT-2) U.O.N.

1 🔘	DECORATIVE ROUND SUSPENDED PENDANT LIGHT (TYPE I) AT CAFE	~
1 O	DECORATIVE ROUND SUSPENDED PENDANT LIGHT (TYPE J)	\
К	LED ADJUSTABLE SPOT LIGHT FIXTURE (TYPE K)	1
L O	24" DIAMETER RING SUSPENDED PENDANT LIGHT (TYPE L)	~
L2 ()	54" DIAMETER RING SUSPENDED PENDANT LIGHT (TYPE L2	Į
M	6'-0" LINEAR SURFACE WALL MOUNT LIGHT FIXTURE (TYPE M) MOUNTING HEIGHT - 8'-0" ABOVE LANDING TO & OF FIXTURE AT EGRESS STAIRS MOUNTING HEIGHT - 7'-4" ABOVE LANDING TO & OF FIXTURE AT E.M.R.	\\\\\\\\\\\\\\\\\\\\\\\\\\\\\\\\\\\\\\
N 🔘	DECORATIVE ROUND SUSPENDED PENDANT LIGHT WITHIN VESTIBULE (TYPE N)	
· ()	COVE LIGHTING AT COLUMN (TYPE O)	j
Р	LED TAPE LIGHT AT COVE CEILING	5
Q	VERTICAL LINEAR FIXTURE INTEGRATED INTO WOOD SLAT WALL SYSTEM (TYPE Q)	\ <
R	SURFACE MOUNTED ROUND DECORATIVE FIXTURE (TYPE R) @ BLDG. 1 - COMMISSIONER VESTIBULE	\ ~
s O	SURFACE MOUNTED RING FIXTURE (TYPE S)	Į
т 💿	DECORATIVE BELL PENDANT ABOVE THE SOFFIT (TYPE T)	1
0	6" CEILING DOWNLIGHT RECCESSED CAN	
€H	EXIT SIGN	
¬¬	FA CEILING MOUNTED SPEAKER & STROBE	\
(T)	FA CEILING MOUNTED STROBE	~
<u>(S)</u>	SMOKE DETECTOR	Į
	12" x 12" ACCESS DOOR	
MS E====	MOTORIZED SHADES	$\rfloor \chi$

Room name ------ROOM NAME

-ROOM NUMBER

— CEILING TYPE — CEILING HEIGHT

GYPSUM BOARD CEILING

HVAC - RETURN

HVAC - SUPPLY

HVAC - LINEAR SUPPLY

PRIVATE OFFICES

OPEN OFFICES

FIXTURE (TYPE D)

FIXTURE (TYPE D2)

FIXTURE (TYPE E)

F2 _____

HVAC - BATHROOM EXHAUST FAN

2'-0" X 2'-0" RECESSED TROFFE

FIXTURE (TYPE B) @ UTILITIES

MOUNTING HEIGHT - 8'-0" A.F.F. 2" x 8'-0" RECESSED CEILING LIGHT

2" x 4'-0" RECESSED CEILING LIGHT

4" SQUARE RECESSED DOWNLIGHT

VARYING LENGTHS (TYPE F)

4'-0" RECESSED LINEAR

LIGHT FIXTURE (TYPE G)

RECESSED DIRECT LINEAR FIXTURE,

LINEAR DIRECT/INDIRECT PENDANT

FIXTURE, VARYING LENGTHS (TYPE F2)

LINEAR WALL GRAZER LIGHT (TYPE H)

CEIING LIGHT FIXTURE (TYPE A) @

2'-0" X 2'-0" RECESSED CEIING LIGHT

2" x VARYING LENGTH CEILING HUNG


PENDANT LIGHT FIXTURE (TYPE C) @

2' BY 2' SUSPENDED CEILING GRID,

CEILING HEIGHT INDICATED ON PLANS,

GRID TO BE CENTERED IN AREA U.O.N.
4' BY 4' SUSPENDED CEILING GRID,
CEILING HEIGHT INDICATED ON PLANS,
GRID TO BE CENTERED IN AREA U.O.N.

101 🚤

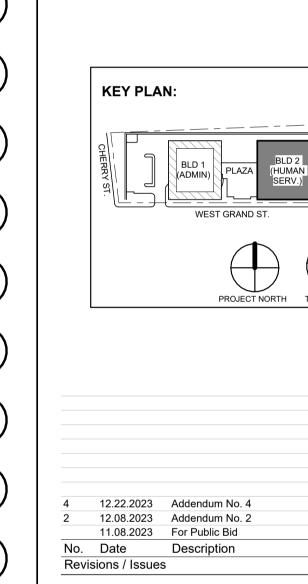

DIGroup Architectul

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UNION COUNTY IMPROVEMENT AUTHORITY

Project:

UNION COUNTY GOVERNMENT
COMPLEX - BUILDING 2
81 & 93 WEST GRAND STREET
CITY OF ELIZABETH
NEW JERSEY, 07202

Drawing Information:
Project No: 20.072
Date: 11.08.2023


Sheet Name:

BUILDING NO.2 - LEVEL 5 REFLECTED CEILING PLAN

Sheet No: **A2-215**

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TYPICAL CEILING HEIGHTS (BLDG 2):

TYPICAL OPEN OFFICE: 9'-5" A.F.F.

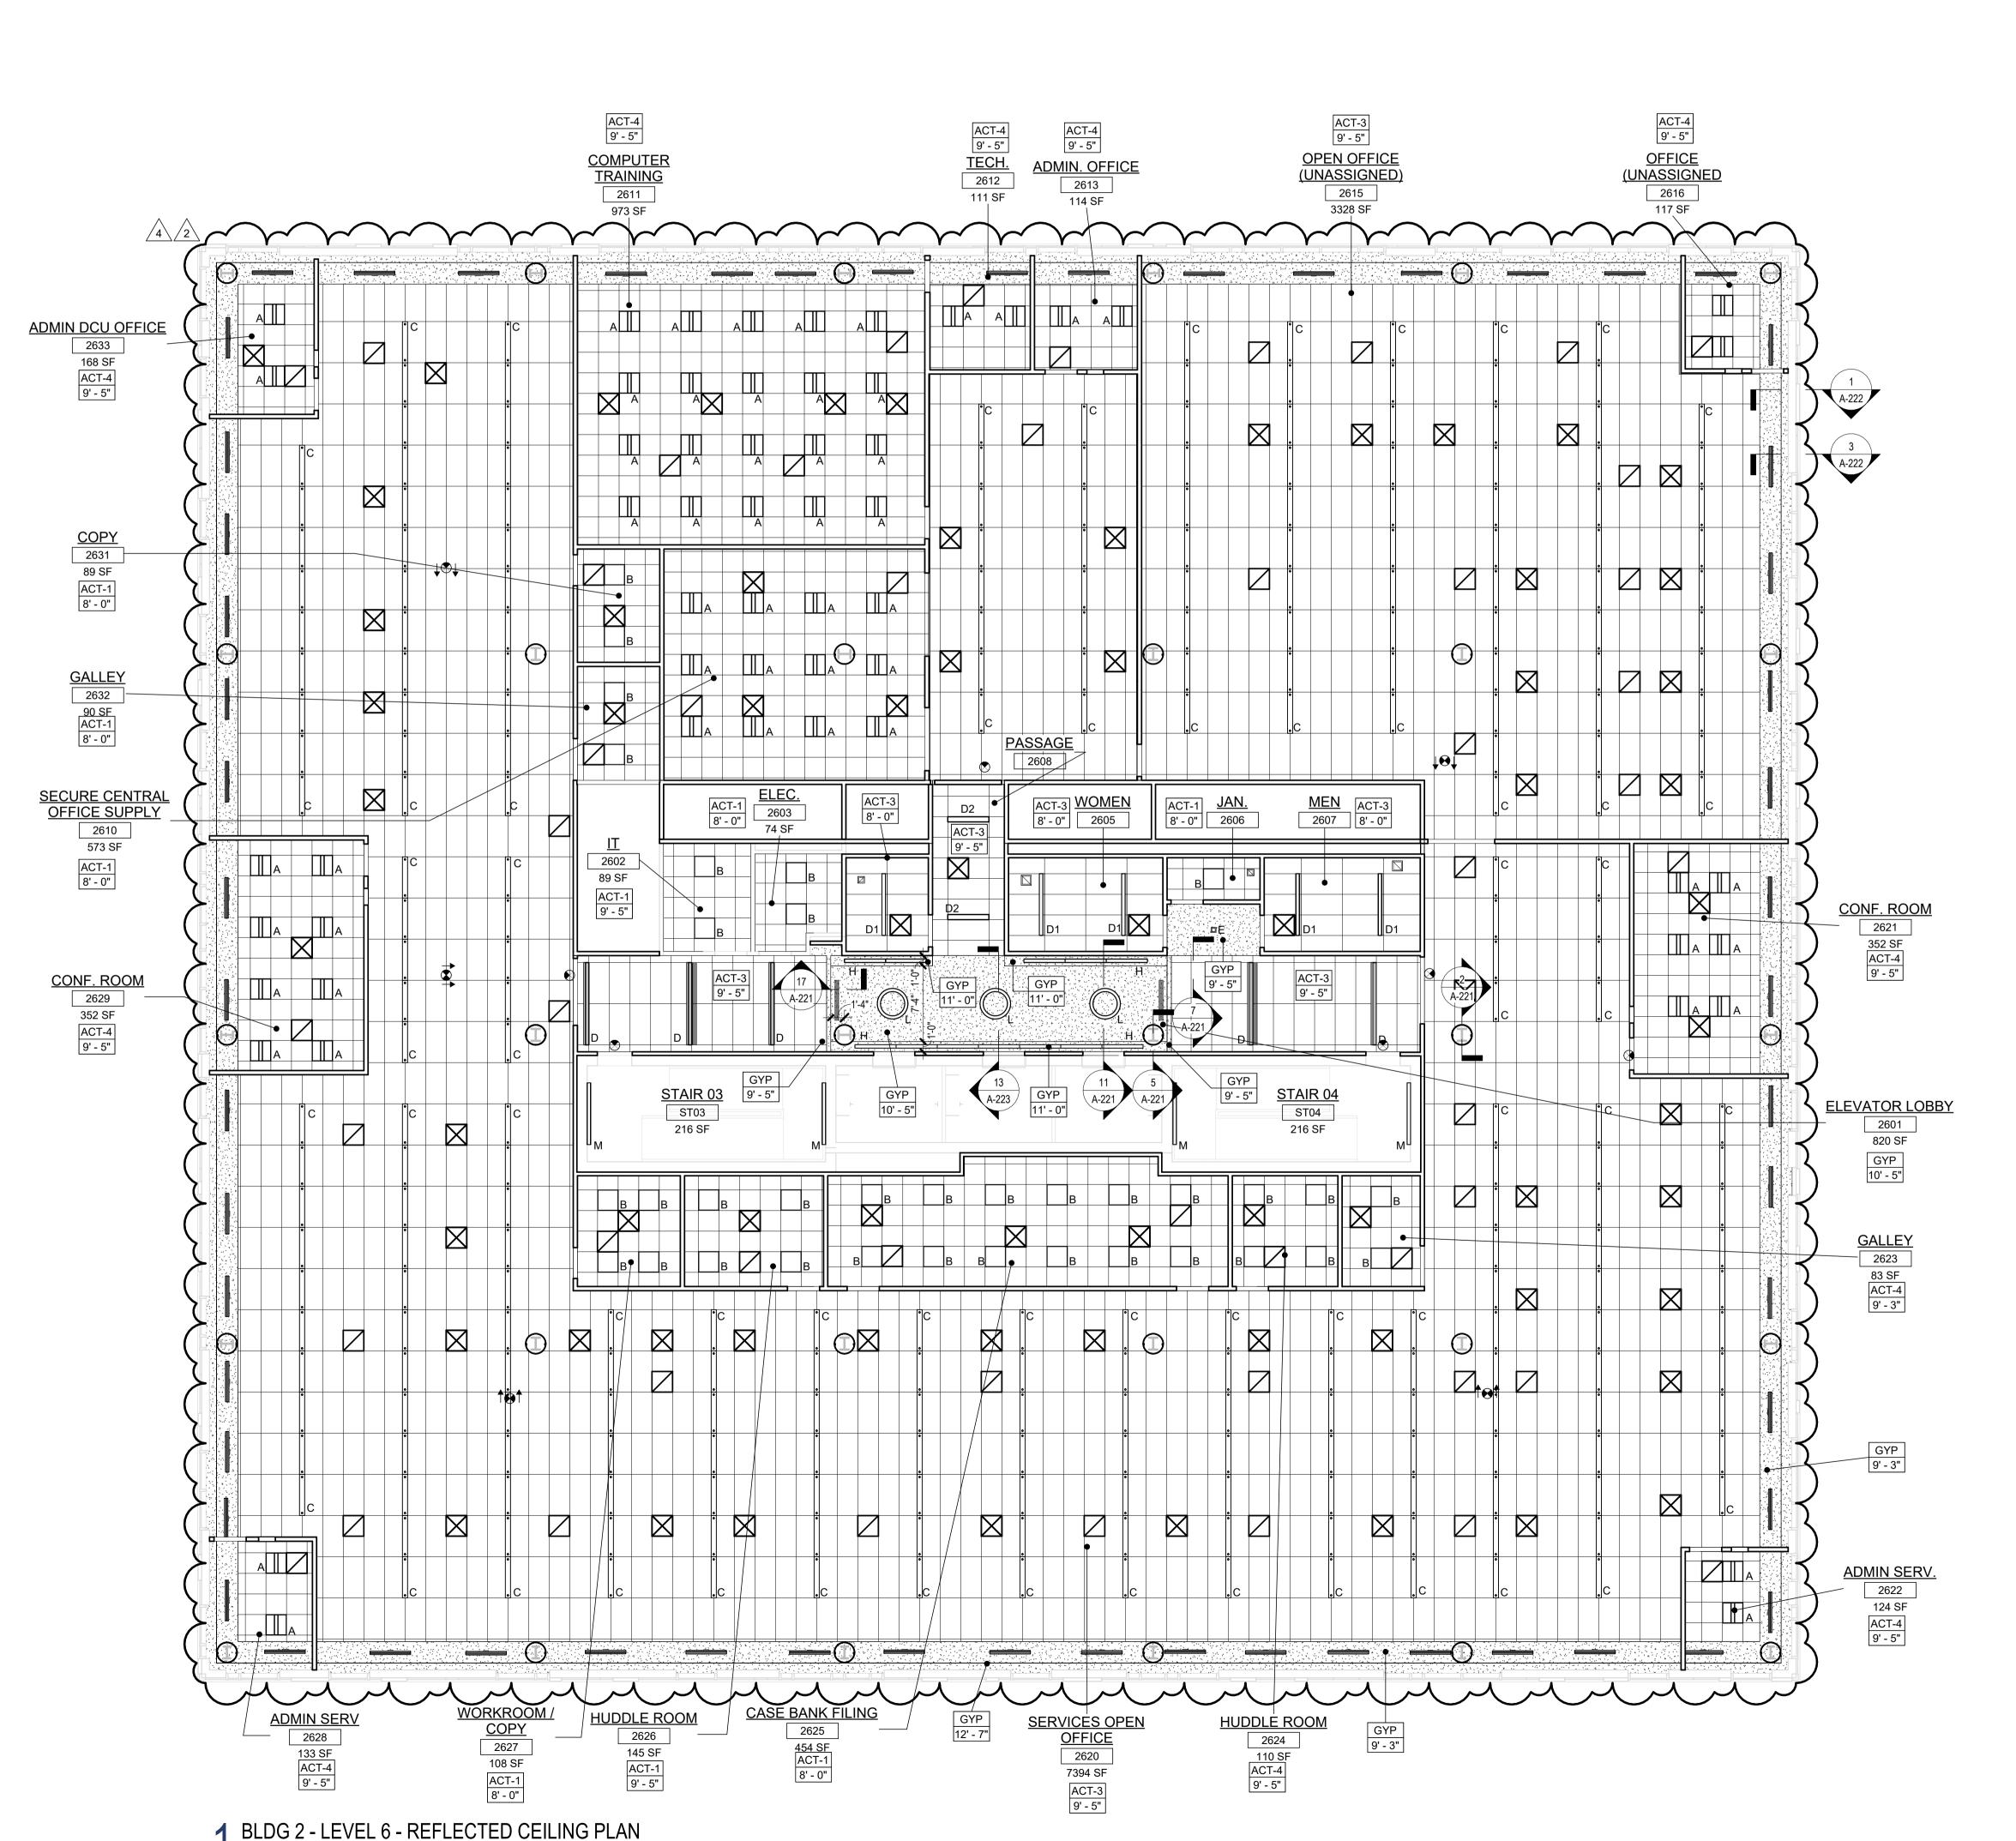TYPICAL PRIVATE OFFICE: 9'-5" A.F.F.

TYPICAL CONFERENCE / MEETING ROOM: 9'-5" A.F.F.

TYPICAL STORAGE / FILE / COPY ROOM: 8'-0" A.F.F.

ELEVATOR CORE: 9'-5" / 10'-5" A.F.F.

RESTROOMS: 8'-0" A.F.F.

COLUMN / BEAM COVER
BASIS OF DESIGN

MANUFACTURER: CENTRIA
PRODUCT: COLUMN COVERS SERIES 3000

WOOD LOOK ALUMINUM SLATS VARIED WIDTH + DEPTH
BASIS OF DESIGN

MANUFACTURER: CERTAINTEED
PRODUCT: MULTI BOX CONTINOUS
REFER TO DETAIL 2 / A2-210 FOR ADDITIONAL INFORMATION

MANUAL SHADE SYSTEMS
BASIS OF DESIGN
MANUFACTURER: MECHOSHADE

PRODUCT: MECHO/5 SYSTEM

ARCHITECT PRIOR TO INSTALLATION.

REFLECTED CEILING PLAN NOTES:

- A. BORDERS AT LAY-IN ACOUSTICAL CEILING PANELS SHALL BE CUT TO MATCH FACTORY EDGE PROFILE. NO EXPOSED FASTENERS SHALL BE PERMITTED INCLUDING POP RIVETS
- B. HEIGHT OF CEILINGS SHALL BE MEASURED FROM TOP OF SLAB TO FINISH FACE OF GWB OR FACE OF CEILING GRID AS INDICATED ON THE REFLECTED CEILING PLAN, UON.
- C. ALL LIGHT FIXTURES ARE TO BE INSTALLED IN ACCORDANCE WITH THE ARCHITECTURAL REFLECTED CEILING PLAN. ARCHITECT TO REVIEW CEILING LAYOUT INCLUDING BULKHEADS AND GRID PRIOR TO INSTALLATION.
- D. LIGHT FIXTURES TYPES SHOWN ON ARCHITECTURAL REFLECTED CEILING PLANS ARE NOTED FOR QUANTITIES AND LOCATIONS ONLY. SEE ELECTRICAL DRAWINGS FOR ADDITIONAL INFORMATION REGARDING SPECIFICATIONS, SWITCHING, EXIT LIGHTS,
- EMERGENCY LIGHTING, LIFE SAFETY EQUIPMENT AND CIRCUITING.

 E. MECHANICAL INFORMATION SHOWN ON THIS PLAN IS FOR REFERENCE ONLY, SEE MECHANICAL DRAWINGS FOR DIFFUSER LOCATIONS AND FOR ADDITIONAL INFORMATION
- REGARDING ALL HVAC EQUIPMENT INCLUDING HVAC REGISTERS, GRILLS, ETC.

 F. DIMENSIONED LIGHT FIXTURES ARE FROM FINISHED FACE OF PARTITIONS TO CENTERLINE OF FIXTURE TO CENTERLINE OF FIXTURE. ANY DISCREPANCIES WITH LOCATION OF LIGHT FIXTURES, SWITCHES, THERMOSTATS, OR DIFFUSERS BETWEEN ARCHITECTURAL AND ENGINEERING DRAWINGS SHALL BE CLARIFIED WITH THE
- G. THE CONTRACTOR SHALL SUBMIT COORDINATION DRAWINGS THAT INCORPORATES ALL TRADES AS REQUIRED BY THE SPECIFICATIONS.
- H. LIGHT FIXTURES, DIFFUSERS, GRILLES AND ALL OTHER SYSTEM DEVICES SHALL BE LOCATED CENTERED ON CEILING TILES, U.O.N.
- I. ALL ACOUSTICAL TILE CEILINGS SHALL BE CENTERED WITHIN EACH ROOM U.O.N.J. ALL FLUSH MOUNTED LIGHT FIXTURES MOUNTED WITHTIN A GYPSUM BOARD CEILING
- SHALL BE FITTED WITH FLUSH TRIM.

 K. WHERE DUCTWORK, CONDUIT, AND PIPING MUST CROSS OPEN CEILINGS, ALL WORK
- SHALL BE EXCUTED TO PRESENT A NEAT AND MINIMAL APPREANCE:

 L. ALL EXPOSED WORK SHALL RUN PARALLEL OR PERPENDICULAR TO STRUCTURE, WITH
- 90 DEGREE BENDS.

 M. LOCATE WORK SO AS TO MINIMIZE EXTENT EXPOSED. LOCATE WORK AS CLOSE AS
- POSSIBLE TO ADJACENT WALLS OR CEILINGS PLANES.
- N. PROVIDE ADDITIONAL STRUT SUPPORT SYSTEM TO SUPPORT FIXTURES WHERE LIGHT FIXTURES ARE NOT MOUNTED BELOW STRUCTURAL MEMBERS-DO NOT MOUNT TO ROOF DECK, TYP.
- O. WHERE EXPOSED STRUCTURE IS INDICATED, ALL EXPOSED ROOF DECK, STRUCTURAL STEEL CONCRETE BEAMS & DECK PIPES DUCTS CONDUITS ETC. SHALL BE PAINTED.
- STEEL, CONCRETE BEAMS & DECK, PIPES, DUCTS, CONDUITS, ETC. SHALL BE PAINTED TO MATCH CEILING COLOR; SEE FINISH SCHEDULE.
- GYPSUM BOARD CEILINGS U.O.N.

 Q. PROVIDE SOFFIT TRANSITIONS BETWEEN ACT CEILINGS AND GYPSUM BOARD CEILINGS

P. DOWNLIGHTS SHALL BE SYMMETRICALLY CENTERED IN ACOUSTICAL CEILING TILE AND

- R. FURNISH AN INSTALL ACCESS DOORS IN GYP. BD. CEILINGS AS REQUIRED TO PROVIDE ACCESS TO ABOVE-CEILINGS VAV BOXES, DAMPERS, VALVES, EQUIPMENT, ETC. SEE MEP DRAWINGS FOR LOCATIONS AND SPECIFICATIONS, COORDINATE FINAL LOCATIONS
- S. ALL GYP. BD. CEILINGS IN WET AREAS SUCH AS TOILET ROOMS, BATHROOMS, AND JANITORS CLOSTES SHALL RECIEVE MOISTURE AND MOLD RESISTANT GYP. BD. AS PER
- SPECIFICATIONS.

 T. SEE SPECIFICATIONS FOR ADDITIONAL INFORMATION REGARDING CEILING TYPES.
- U. SEE A-220 SERIES DRAWINGS FOR TYPICAL CEILING DETAILS, U.O.N.V. ALL EXTERIOR WINDOWS WILL HAVE MANUAL ROLLER SHADES. REFER TO
- SPECIFICATIONS AND A-220 SERIES DRAWINGS FOR LOCATION AND DETAILS.
- W. ALL TRAINING ROOMS AND COMMISSIONER MEETING ROOMS WILL HAVE POWERED ROLLER SHADES WITH BOTH SOLAR AND BLACKOUT CAPABILITY TO REFER TO SPECIFICATIONS.
- X. ALL GYP. BOARD SOFFITS AND FASCIAS TO BE PAINTED (PNT-2) U.O.N

WITH DESIGNER PRIOR TO INSTALLATION.

G ⊏		LIGHT FIXTURE (TYPE G)	
н =		LINEAR WALL GRAZER LIGHT (TYPE H)	•
1	o	DECORATIVE ROUND SUSPENDED PENDANT LIGHT (TYPE I) AT CAFE	•
J	0	DECORATIVE ROUND SUSPENDED PENDANT LIGHT (TYPE J)	
К		LED ADJUSTABLE SPOT LIGHT FIXTURE (TYPE K)	•
L (24" DIAMETER RING SUSPENDED PENDANT LIGHT (TYPE L)	•
L2 ((54" DIAMETER RING SUSPENDED PENDANT LIGHT (TYPE L2	
M ===		6'-0" LINEAR SURFACE WALL MOUNT LIGHT FIXTURE (TYPE M) MOUNTING HEIGHT - 8'-0" ABOVE LANDING TO & OF FIXTURE AT EGRESS STAIRS MOUNTING HEIGHT - 7'-4" ABOVE LANDING	7
N		DECORATIVE ROUND SUSPENDED PENDANT LIGHT WITHIN VESTIBULE	
o (COVE LIGHTING AT COLUMN (TYPE O)	•
Р		LED TAPE LIGHT AT COVE CEILING	•
Q	٥	VERTICAL LINEAR FIXTURE INTEGRATED INTO WOOD SLAT WALL SYSTEM (TYPE Q)	•
R (SURFACE MOUNTED ROUND DECORATIVE FIXTURE (TYPE R) @ BLDG. 1 - COMMISSIONER VESTIBULE	
s (SURFACE MOUNTED RING FIXTURE (TYPE S)	
Т	o	DECORATIVE BELL PENDANT ABOVE THE SOFFIT (TYPE T)	•
	0	6" CEILING DOWNLIGHT RECCESSED CAN	
	$\bigotimes \vdash$	EXIT SIGN	4
	¬	FA CEILING MOUNTED SPEAKER & STROBE	
	T	FA CEILING MOUNTED STROBE	
	<u>(S)</u>	SMOKE DETECTOR	•
		12" x 12" ACCESS DOOR	
MS E	====;	MOTORIZED SHADES	4
	H = 1	H	LIGHT FIXTURE (TYPE G) LINEAR WALL GRAZER LIGHT (TYPE H) DECORATIVE ROUND SUSPENDED PENDANT LIGHT (TYPE I) AT CAFE J DECORATIVE ROUND SUSPENDED PENDANT LIGHT (TYPE J) K LED ADJUSTABLE SPOT LIGHT FIXTURE (TYPE K) L 24" DIAMETER RING SUSPENDED PENDANT LIGHT (TYPE L) L2 54" DIAMETER RING SUSPENDED PENDANT LIGHT (TYPE L) M 6-0" LINEAR SURFACE WALL MOUNT LIGHT FIXTURE (TYPE M) MOUNTING HEIGHT - 8"-0" ABOVE LANDING TO 4 OF FIXTURE AT EGRESS STAIRS MOUNTING HEIGHT - 7"-4" ABOVE LANDING TO 4 OF FIXTURE AT EMR. N DECORATIVE ROUND SUSPENDED PENDANT LIGHT WITHIN VESTIBULE (TYPE N) O COVE LIGHTING AT COLUMN (TYPE O) P LED TAPE LIGHT AT COVE CEILING Q D VERTICAL LINEAR FIXTURE INTEGRATED INTO WOOD SLAT WALL SYSTEM (TYPE Q) R SURFACE MOUNTED ROUND DECORATIVE FIXTURE (TYPE R) @ BLDG. 1 - COMMISSIONER VESTIBULE S URFACE MOUNTED RING FIXTURE (TYPE S) T D DECORATIVE BELL PENDANT ABOVE THE SOFFIT (TYPE T) O 6" CEILING DOWNLIGHT RECCESSED CAN PACELING MOUNTED SPEAKER & STROBE FA CEILING MOUNTED SPEAKER & STROBE FA CEILING MOUNTED STROBE S MOKE DETECTOR 12" x 12" ACCESS DOOR

RCP LEGEND

-ROOM NUMBER

—CEILING TYPE —CEILING HEIGHT

GYPSUM BOARD CEILING

HVAC - RETURN

HVAC - SUPPLY

HVAC - LINEAR SUPPLY

PRIVATE OFFICES

OPEN OFFICES

FIXTURE (TYPE D)

FIXTURE (TYPE D2)

FIXTURE (TYPE E)

4'-0" RECESSED LINEAR

HVAC - BATHROOM EXHAUST FAN

2'-0" X 2'-0" RECESSED TROFFE

FIXTURE (TYPE B) @ UTILITIES

MOUNTING HEIGHT - 8'-0" A.F.F. 2" x 8'-0" RECESSED CEILING LIGHT

2" x 4'-0" RECESSED CEILING LIGHT

4" SQUARE RECESSED DOWNLIGHT

RECESSED DIRECT LINEAR FIXTURE, VARYING LENGTHS (TYPE F)

LINEAR DIRECT/INDIRECT PENDANT

FIXTURE, VARYING LENGTHS (TYPE F2)

CEIING LIGHT FIXTURE (TYPE A) @

2'-0" X 2'-0" RECESSED CEIING LIGHT

2" x VARYING LENGTH CEILING HUNG

PENDANT LIGHT FIXTURE (TYPE C) @

2' BY 2' SUSPENDED CEILING GRID, CEILING HEIGHT INDICATED ON PLANS,

GRID TO BE CENTERED IN AREA U.O.N.
4' BY 4' SUSPENDED CEILING GRID,
CEILING HEIGHT INDICATED ON PLANS,
GRID TO BE CENTERED IN AREA U.O.N.


Room name Room NAME

101 🚤

C • •

D2 —

F2 _____

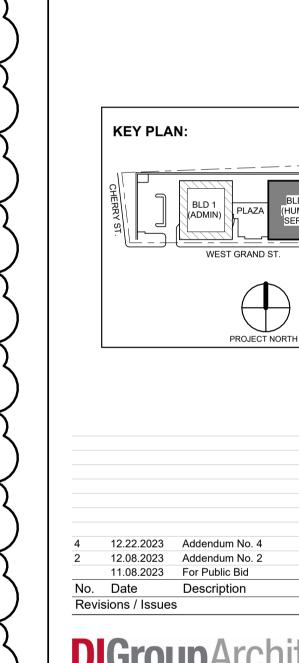

Jeffrey D. Venezia, AIA

NJ RÅ AI 00827100

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SCALE. CONSULT WITH ARCHITECT FOR DIMENSIONS.

Client:

UNION COUNTY IMPROVEMENT

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AUTHORITY

UNION COUNTY GOVERNMENT COMPLEX - BUILDING 2 81 & 93 WEST GRAND STREET CITY OF ELIZABETH NEW JERSEY, 07202 Drawing Information:

Project No: 20.072
Date: 11.08.2023
Drawn By: JB / AV / PC
Checked By: JM / SH

Sheet Name:


BUILDING NO.2 - LEVEL 6 - REFLECTED CEILING PLAN

A2-216

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EMERGENCY ELEC. STAIR 03 ST03 ST04 216 SF 216 SF CONSTRUCTION CONSTRUCTION

1 BLDG 2 - LEVEL 7 - PENTHOUSE REFLECTED CEILING PLAN SCALE: 1/8" = 1'-0"

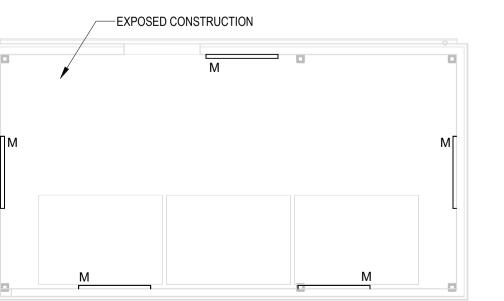

TYPICAL CEILING HEIGHTS (BLDG 2): TYPICAL OPEN OFFICE: 9'-5" A.F.F. TYPICAL PRIVATE OFFICE: 9'-5" A.F.F. TYPICAL CONFERENCE / MEETING ROOM: 9'-5" A.F.F. TYPICAL STORAGE / FILE / COPY ROOM: 8'-0" A.F.F. **ELEVATOR CORE:** 9'-5" / 10'-5" A.F.F. 8'-0" A.F.F. RESTROOMS:

FINISH NOTES:

COLUMN / BEAM COVER BASIS OF DESIGN MANUFACTURER: CENTRIA PRODUCT: COLUMN COVERS SERIES 3000

WOOD LOOK ALUMINUM SLATS VARIED WIDTH + DEPTH BASIS OF DESIGN MANUFACTURER: CERTAINTEED PRODUCT: MULTI BOX CONTINOUS REFER TO DETAIL 2 / A2-210 FOR ADDITIONAL INFORMATION

MANUAL SHADE SYSTEMS BASIS OF DESIGN MANUFACTURER: MECHOSHADE

BULKHEADS AND GRID PRIOR TO INSTALLATION.

PRODUCT: MECHO/5 SYSTEM

REFLECTED CEILING PLAN NOTES:

- A. BORDERS AT LAY-IN ACOUSTICAL CEILING PANELS SHALL BE CUT TO MATCH FACTORY EDGE PROFILE. NO EXPOSED FASTENERS SHALL BE PERMITTED INCLUDING POP RIVETS AND TAPPETS.
- B. HEIGHT OF CEILINGS SHALL BE MEASURED FROM TOP OF SLAB TO FINISH FACE OF GWB
- OR FACE OF CEILING GRID AS INDICATED ON THE REFLECTED CEILING PLAN, UON. C. ALL LIGHT FIXTURES ARE TO BE INSTALLED IN ACCORDANCE WITH THE ARCHITECTURAL REFLECTED CEILING PLAN. ARCHITECT TO REVIEW CEILING LAYOUT INCLUDING
- D. LIGHT FIXTURES TYPES SHOWN ON ARCHITECTURAL REFLECTED CEILING PLANS ARE NOTED FOR QUANTITIES AND LOCATIONS ONLY. SEE ELECTRICAL DRAWINGS FOR ADDITIONAL INFORMATION REGARDING SPECIFICATIONS, SWITCHING, EXIT LIGHTS,
- EMERGENCY LIGHTING, LIFE SAFETY EQUIPMENT AND CIRCUITING. E. MECHANICAL INFORMATION SHOWN ON THIS PLAN IS FOR REFERENCE ONLY, SEE MECHANICAL DRAWINGS FOR DIFFUSER LOCATIONS AND FOR ADDITIONAL INFORMATION
- F. DIMENSIONED LIGHT FIXTURES ARE FROM FINISHED FACE OF PARTITIONS TO CENTERLINE OF FIXTURE TO CENTERLINE OF FIXTURE. ANY DISCREPANCIES WITH LOCATION OF LIGHT FIXTURES, SWITCHES, THERMOSTATS, OR DIFFUSERS BETWEEN ARCHITECTURAL AND ENGINEERING DRAWINGS SHALL BE CLARIFIED WITH THE ARCHITECT PRIOR TO INSTALLATION.

REGARDING ALL HVAC EQUIPMENT INCLUDING HVAC REGISTERS, GRILLS, ETC.

- G. THE CONTRACTOR SHALL SUBMIT COORDINATION DRAWINGS THAT INCORPORATES ALL TRADES AS REQUIRED BY THE SPECIFICATIONS.
- H. LIGHT FIXTURES, DIFFUSERS, GRILLES AND ALL OTHER SYSTEM DEVICES SHALL BE
- LOCATED CENTERED ON CEILING TILES, U.O.N. I. ALL ACOUSTICAL TILE CEILINGS SHALL BE CENTERED WITHIN EACH ROOM U.O.N.
- J. ALL FLUSH MOUNTED LIGHT FIXTURES MOUNTED WITHTIN A GYPSUM BOARD CEILING SHALL BE FITTED WITH FLUSH TRIM.
- K. WHERE DUCTWORK, CONDUIT, AND PIPING MUST CROSS OPEN CEILINGS, ALL WORK SHALL BE EXCUTED TO PRESENT A NEAT AND MINIMAL APPREANCE:
- L. ALL EXPOSED WORK SHALL RUN PARALLEL OR PERPENDICULAR TO STRUCTURE, WITH 90 DEGREE BENDS.
- M. LOCATE WORK SO AS TO MINIMIZE EXTENT EXPOSED. LOCATE WORK AS CLOSE AS POSSIBLE TO ADJACENT WALLS OR CEILINGS PLANES.
- N. PROVIDE ADDITIONAL STRUT SUPPORT SYSTEM TO SUPPORT FIXTURES WHERE LIGHT FIXTURES ARE NOT MOUNTED BELOW STRUCTURAL MEMBERS-DO NOT MOUNT TO ROOF
- O. WHERE EXPOSED STRUCTURE IS INDICATED, ALL EXPOSED ROOF DECK, STRUCTURAL STEEL, CONCRETE BEAMS & DECK, PIPES, DUCTS, CONDUITS, ETC. SHALL BE PAINTED TO MATCH CEILING COLOR; SEE FINISH SCHEDULE.
- P. DOWNLIGHTS SHALL BE SYMMETRICALLY CENTERED IN ACOUSTICAL CEILING TILE AND
- GYPSUM BOARD CEILINGS U.O.N. Q. PROVIDE SOFFIT TRANSITIONS BETWEEN ACT CEILINGS AND GYPSUM BOARD CEILINGS
- R. FURNISH AN INSTALL ACCESS DOORS IN GYP. BD. CEILINGS AS REQUIRED TO PROVIDE ACCESS TO ABOVE-CEILINGS VAV BOXES, DAMPERS, VALVES, EQUIPMENT, ETC. SEE MEP DRAWINGS FOR LOCATIONS AND SPECIFICATIONS, COORDINATE FINAL LOCATIONS WITH DESIGNER PRIOR TO INSTALLATION.
- S. ALL GYP. BD. CEILINGS IN WET AREAS SUCH AS TOILET ROOMS, BATHROOMS, AND JANITORS CLOSTES SHALL RECIEVE MOISTURE AND MOLD RESISTANT GYP. BD. AS PER SPECIFICATIONS.
- T. SEE SPECIFICATIONS FOR ADDITIONAL INFORMATION REGARDING CEILING TYPES.
- U. SEE A-220 SERIES DRAWINGS FOR TYPICAL CEILING DETAILS, U.O.N.
- V. ALL EXTERIOR WINDOWS WILL HAVE MANUAL ROLLER SHADES. REFER TO SPECIFICATIONS AND A-220 SERIES DRAWINGS FOR LOCATION AND DETAILS.
- W. ALL TRAINING ROOMS AND COMMISSIONER MEETING ROOMS WILL HAVE POWERED ROLLER SHADES WITH BOTH SOLAR AND BLACKOUT CAPABILITY TO REFER TO SPECIFICATIONS.
- X. ALL GYP. BOARD SOFFITS AND FASCIAS TO BE PAINTED (PNT-2) U.O.N.

HVAC - SUPPLY HVAC - LINEAR SUPPLY HVAC - BATHROOM EXHAUST FAN 2'-0" X 2'-0" RECESSED TROFFE CEIING LIGHT FIXTURE (TYPE A) @ PRIVATE OFFICES 2'-0" X 2'-0" RECESSED CEIING LIGHT FIXTURE (TYPE B) @ UTILITIES 2" x VARYING LENGTH CEILING HUNG PENDANT LIGHT FIXTURE (TYPE C) @ OPEN OFFICES MOUNTING HEIGHT - 8'-0" A.F.F. 2" x 8'-0" RECESSED CEILING LIGHT FIXTURE (TYPE D) 2" x 4'-0" RECESSED CEILING LIGHT D2 _____ FIXTURE (TYPE D2) 4" SQUARE RECESSED DOWNLIGHT FIXTURE (TYPE E) RECESSED DIRECT LINEAR FIXTURE, F _____ VARYING LENGTHS (TYPE F) LINEAR DIRECT/INDIRECT PENDANT F2 _____ FIXTURE, VARYING LENGTHS (TYPE F2) 4'-0" RECESSED LINEAR LIGHT FIXTURE (TYPE G) LINEAR WALL GRAZER LIGHT (TYPE H) н — DECORATIVE ROUND SUSPENDED PENDANT LIGHT (TYPE I) AT CAFE DECORATIVE ROUND SUSPENDED PENDANT LIGHT (TYPE J) LED ADJUSTABLE SPOT LIGHT FIXTURE (TYPE K) 24" DIAMETER RING SUSPENDED PENDANT LIGHT (TYPE L) 54" DIAMETER RING SUSPENDED PENDANT LIGHT (TYPE L2 6'-0" LINEAR SURFACE WALL MOUNT LIGHT FIXTURE (TYPE M) MOUNTING HEIGHT - 8'-0" ABOVE LANDING TO € OF FIXTURE AT EGRESS STAIRS MOUNTING HEIGHT - 7'-4" ABOVE LANDING TO **€** OF FIXTURE AT E.M.R. DECORATIVE ROUND SUSPENDED PENDANT LIGHT WITHIN VESTIBULE COVE LIGHTING AT COLUMN (TYPE O)

Room name Room NAME

101 🚤

RCP LEGEND

---ROOM NUMBER

—CEILING TYPE

—CEILING HEIGHT

GYPSUM BOARD CEILING

HVAC - RETURN

2' BY 2' SUSPENDED CEILING GRID,

CEILING HEIGHT INDICATED ON PLANS, GRID TO BE CENTERED IN AREA U.O.N. 4' BY 4' SUSPENDED CEILING GRID, CEILING HEIGHT INDICATED ON PLANS,

GRID TO BE CENTERED IN AREA U.O.N.

LED TAPE LIGHT AT COVE CEILING

INTEGRATED INTO WOOD SLAT WALL

VERTICAL LINEAR FIXTURE

SURFACE MOUNTED ROUND DECORATIVE FIXTURE (TYPE R)

@ BLDG. 1 - COMMISSIONER

THE SOFFIT (TYPE T)

SURFACE MOUNTED RING FIXTURE

DECORATIVE BELL PENDANT ABOVE

6" CEILING DOWNLIGHT RECCESSED CAN

FA CEILING MOUNTED SPEAKER & STROBE

FA CEILING MOUNTED STROBE

SMOKE DETECTOR

12" x 12" ACCESS DOOR

SYSTEM (TYPE Q)

VESTIBULE

(TYPE S)

EXIT SIGN

MS E==== MOTORIZED SHADES

KEY PLAN:

12.22.2023 Addendum No. 4 12.08.2023 Addendum No. 2 11.08.2023 For Public Bid No. Date Description Revisions / Issues

ARCHITECTURE FOR CHANGE

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Jeffrey D. Venezia, AIA NJ RA AI 00827100

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UNION COUNTY IMPROVEMENT AUTHORITY

UNION COUNTY GOVERNMENT COMPLEX - BUILDING 2 81 & 93 WEST GRAND STREET CITY OF ELIZABETH NEW JERSEY, 07202 Drawing Information:


Project No: 20.072 Date: 11.08.2023 Drawn By: JB / AV / PC Checked By: JM / SH Sheet Name:

BUILDING NO.2 - LEVEL 7 -PENTHOUSE AND EMR REFLECTED CEILING PLAN

A2-217

2 BLDG 2 - EMR REFLECTED CEILING PLAN
SCALE: 1/8" = 1'-0"



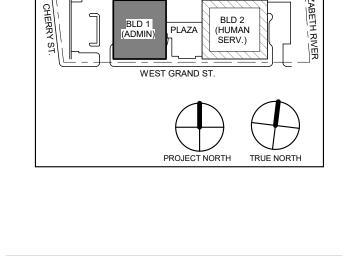

4 12.22.2023 Addendum No. 4

No. Date Description

Revisions / Issues

KEY PLAN:

A R C H I T E C T U R E F O R C H A N G E

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UNION COUNTY IMPROVEMENT AUTHORITY

UNION COUNTY GOVERNMENT

COMPLEX
81 & 93 WEST GRAND STREET
CITY OF ELIZABETH
NEW JERSEY, 07202

Drawing Information:

Project No: 20.072
Date: 01/25/21
Drawn By: Author
Checked By: Checker
Sheet Name:

FINISH SPECIFICATIONS

N 000

Sheet No:

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A-820

GARAGE VENTILATION CALCULATION (PER IMC 404.1):

GARAGE AREA: 23,000 SF

MINIMUM EXHAUST RATE: 0.05 CFM/SF 23,000 SF * 0.05 CFM/SF = 1,165 CFM

MAXIMUM EXHAUST RATE: 0.75 CFM/SF 23,000 SF * 0.75 CFM/SF = 17,475 CFM

*EF 1-1 & EF 1-2 SHALL HAVE CAPACITY TO OPERATE SIMULTANEOUSLY TO PRODUCE 17,475 CFM (EACH EF @ 8,750 CFM)


MECHANICAL SYSTEM NOTES:

1. GENERAL NOTES:

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1 BUILDING NO. 1 - LEVEL 0 - MECHANICAL DUCTWORK PLAN M-101 SCALE: 1/8" = 1'-0"



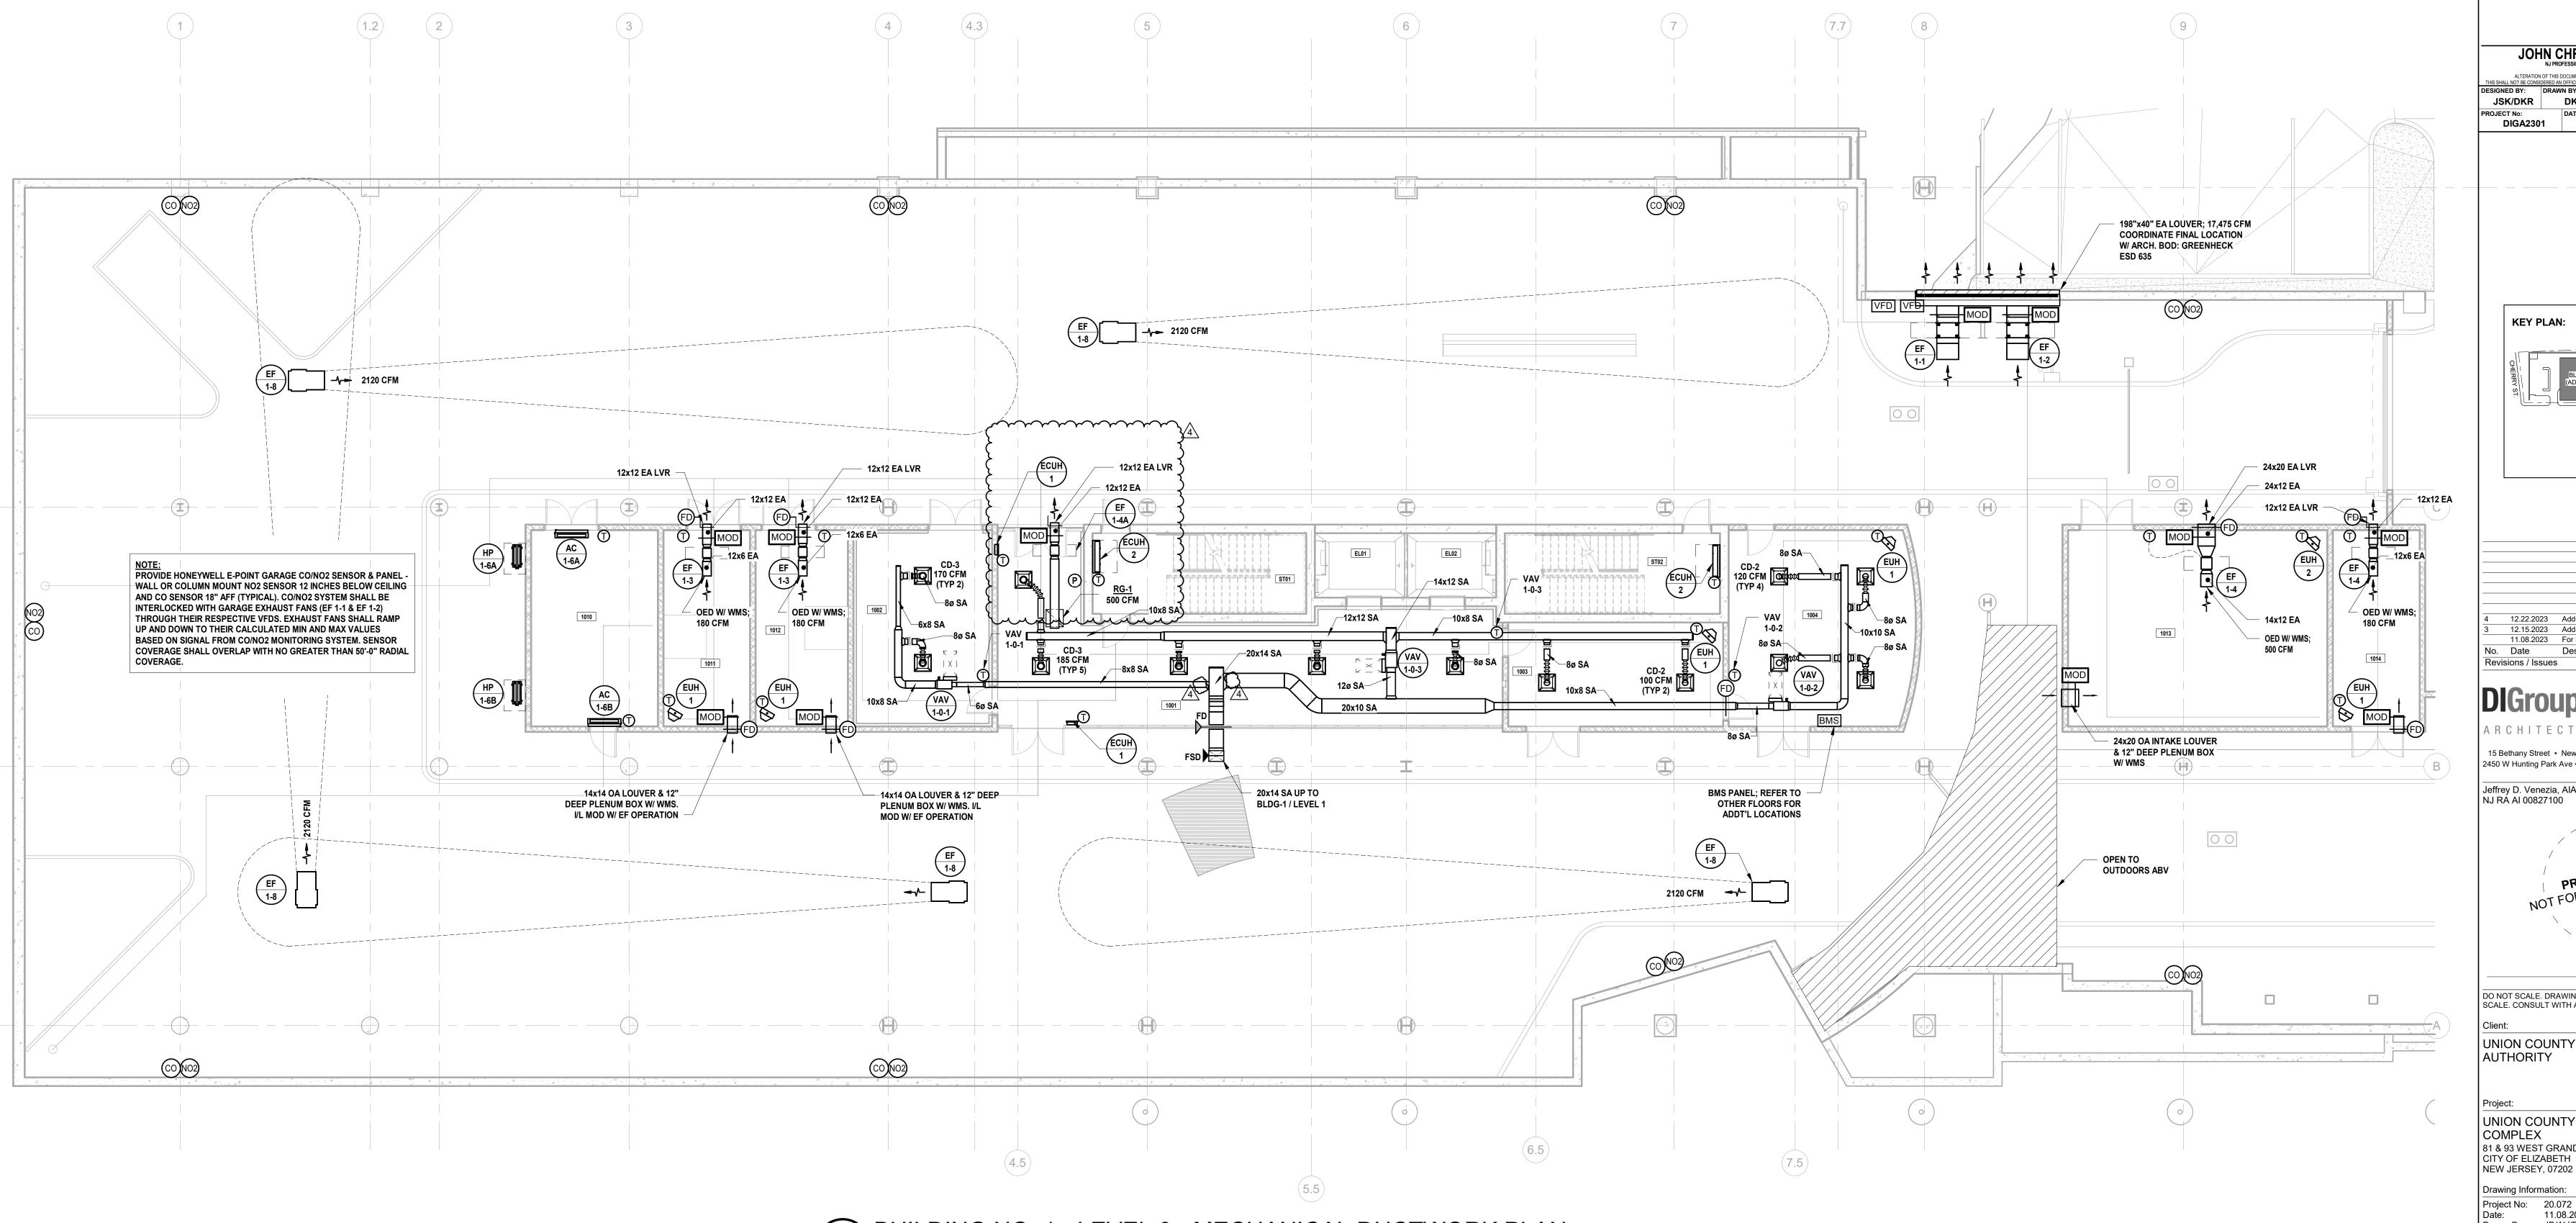

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JOHN CHRIS MORRIS III, P.E.

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DRAWN BY:

CHECKED BY:

REVIEWED BY:

JSK/DKR

DKR

DKR

JSK

JCM DIGA2301 11/08/2023 AS SHOWN

KEY PLAN:

12.22.2023 Addendum No. 4 12.15.2023 Addendum No. 3 11.08.2023 For Public Bid o. Date Description Revisions / Issues

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JNION COUNTY IMPROVEMENT AUTHORITY

> UNION COUNTY GOVERNMENT COMPLEX 81 & 93 WEST GRAND STREET CITY OF ELIZABETH

Drawing Information: Project No: 20.072 Date: 11.08.2023 Drawn By: JB/AV/PC Checked By: JM/SH

Sheet Name: BUILDING NO. 1 - LEVEL 0 -

MECHANICAL DUCTWORK PLAN

Sheet No:

MECHANICAL SYSTEM NOTES:

1. GENERAL NOTES:


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1 2 ard

engineers

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DKR


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DATE:

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SCALE:
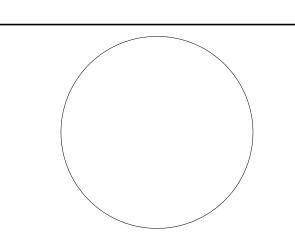
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12.22.2023 Addendum No. 4 12.15.2023 Addendum No. 3 11.08.2023 For Public Bid

No. Date Description
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roject:

UNION COUNTY GOVERNMENT COMPLEX 81 & 93 WEST GRAND STREET CITY OF ELIZABETH NEW JERSEY, 07202

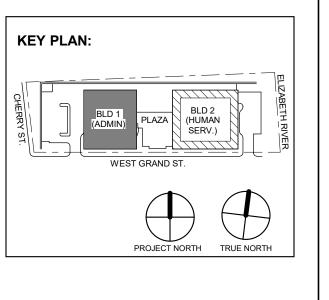Drawing Information:

Project No: 20.072

Date: 11.08.2023

Drawn By: JB/AV/PC

Checked By: JM/SH


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Sheet Name:

BUILDING NO. 1 - LEVEL 1 -

MECHANICAL DUCTWORK PLAN


Sheet No:

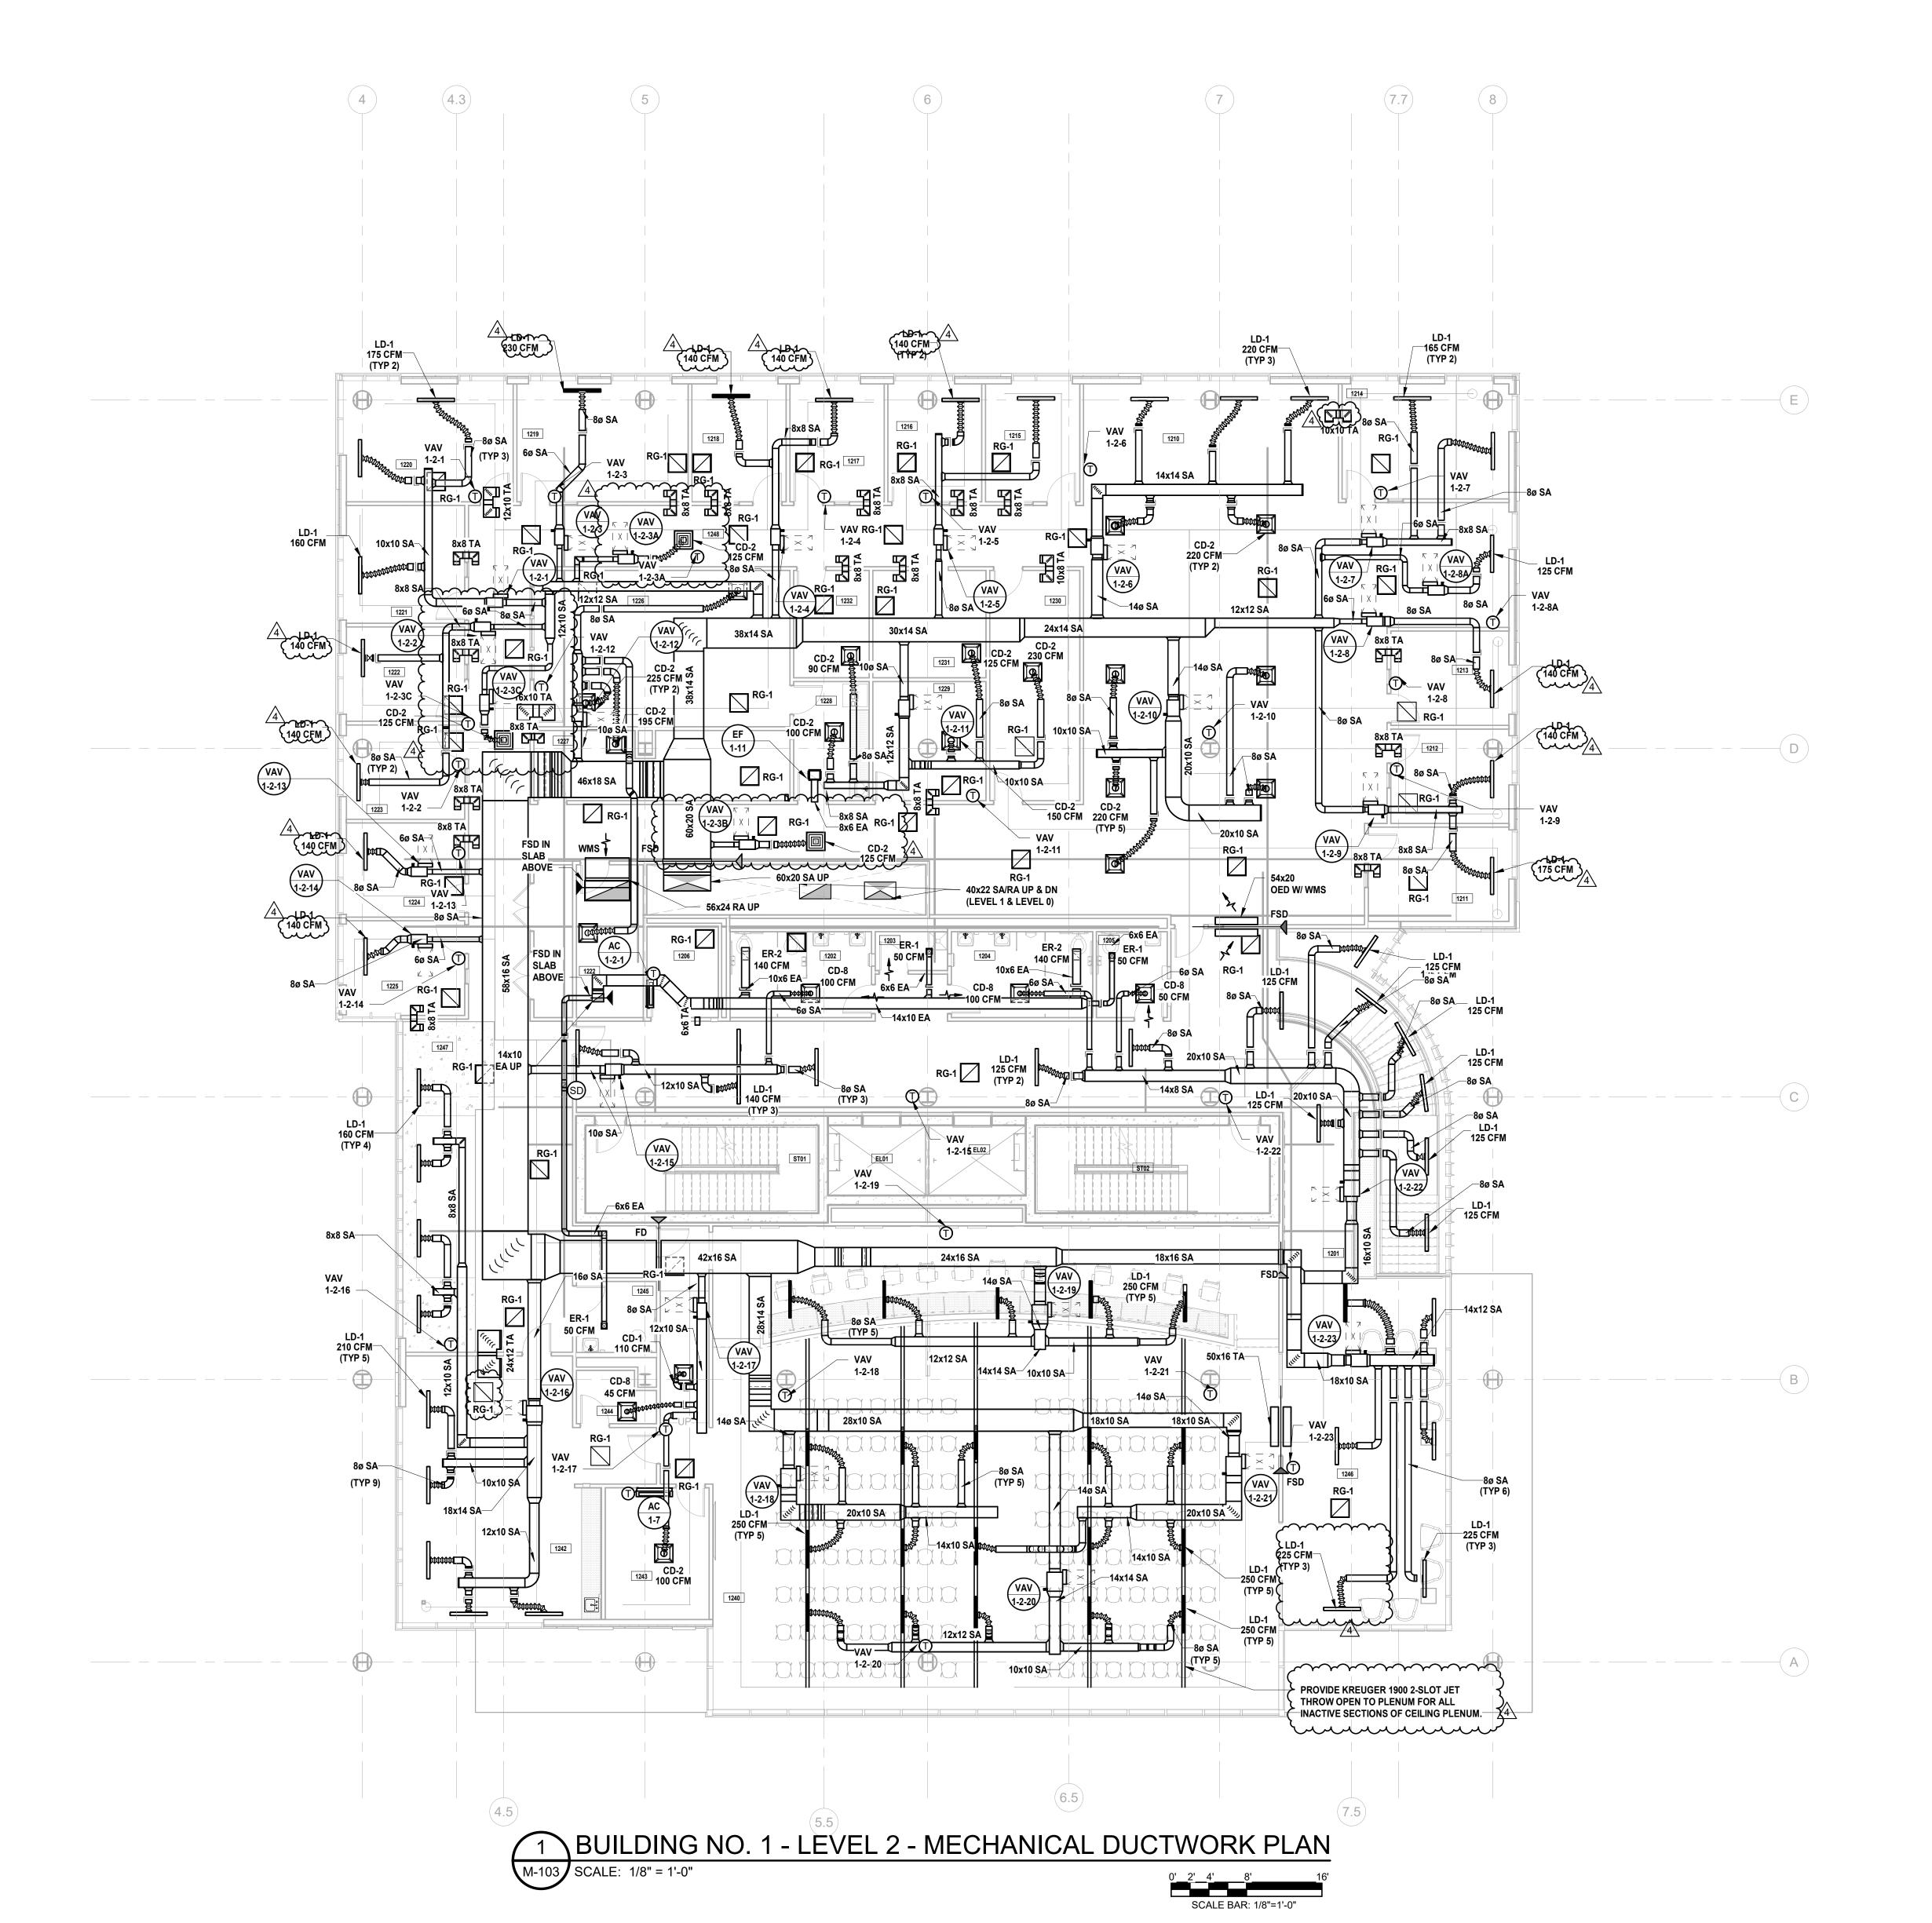

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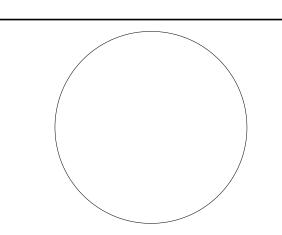




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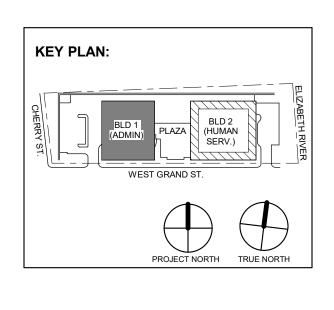
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2 12.08.2023 Addendum No. 2
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No. Date Description
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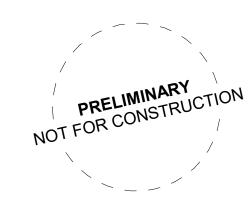
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UNION COUNTY GOVERNMENT COMPLEX 81 & 93 WEST GRAND STREET CITY OF ELIZABETH NEW JERSEY, 07202

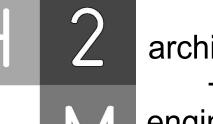Drawing Information:

Project No: 20.072
Date: 11.08.2023
Drawn By: JB/AV/PC
Checked By: JM/SH

Sheet Name:
BUILDING NO. 1 - LEVEL 2 MECHANICAL DUCTWORK PLAN

Sheet No:

1 BUILDING NO. 1 - LEVEL 4 - MECHANICAL DUCTWORK PLAN

SCALE BAR: 1/8"=1'-0"


M-105 SCALE: 1/8" = 1'-0"

MECHANICAL SYSTEM NOTES:

1. GENERAL NOTES:


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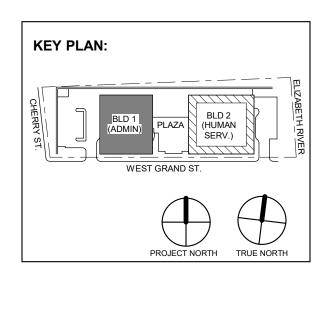


JOHN CHRIS MORRIS III, P.E.

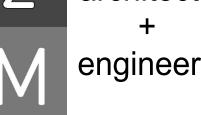DESIGNED BY: DRAWN BY:

JSK/DKR

DKR JSK DIGA2301 11/08/2023 AS SHOWN

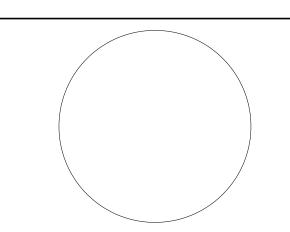


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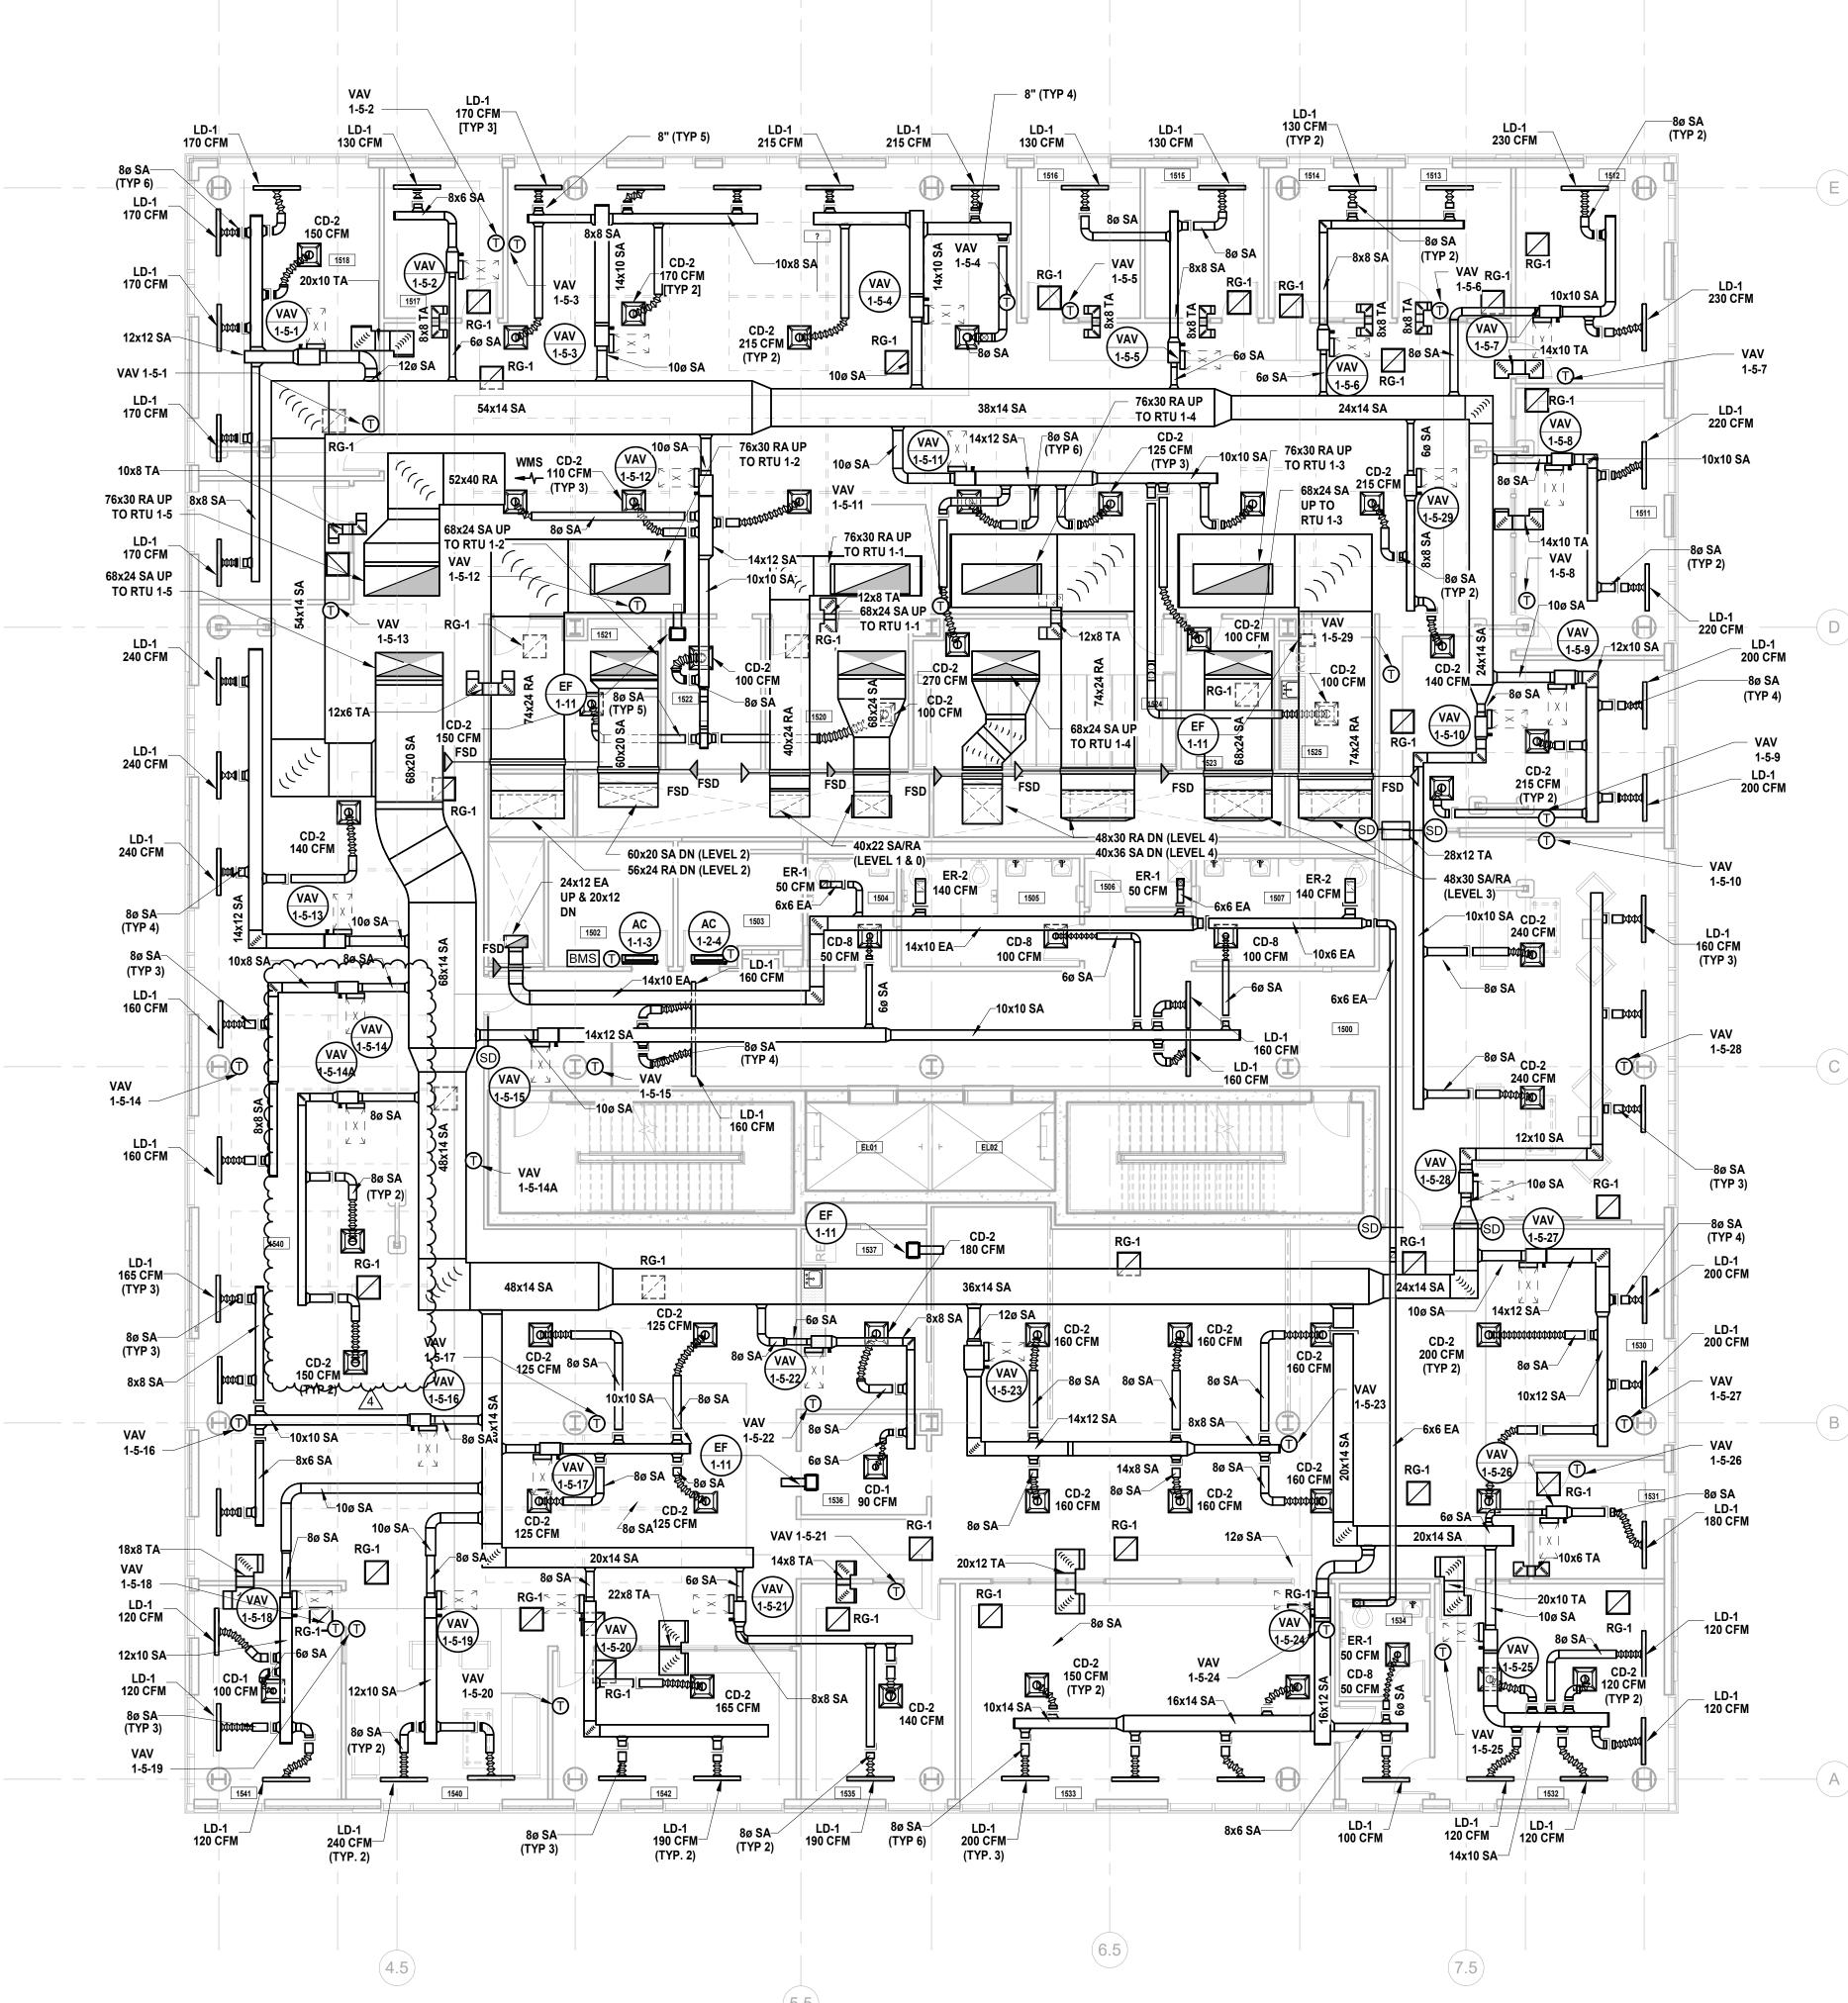
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NEW JERSEY, 07202 Drawing Information: Project No: 20.072 Date: 11.08.2023

Drawn By: JB/AV/PC Checked By: JM/SH

Sheet Name: BUILDING NO. 1 - LEVEL 4 -MECHANICAL DUCTWORK PLAN

Sheet No:

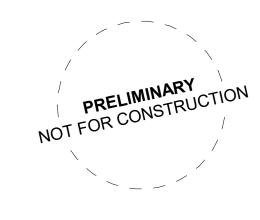

1 BUILDING NO. 1 - LEVEL 5 - MECHANICAL DUCTWORK PLAN

SCALE BAR: 1/8"=1'-0"

M-106 SCALE: 1/8" = 1'-0"

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- G. CONTRACTOR SHALL UTILIZE PLENUM RATED MATERIALS FOR ALL CEILING PLENUMS BEING UTILIZED AS RETURN AIR PLENUMS.
- H. CONTRACTOR SHALL SUPPLY 120V POWER TO ALL LOCATIONS OF BMS PANELS.


I. INTERNALLY LINE ALL SUPPLY AND RETURN DUCTWORK WITHIN 20 FEET UPSTREAM AND DOWNSTREAM OF FANS WITH 1" THICK INSULATION. INTERNALLY LINED DUCTWORK MEETING THIS REQUIREMENT SHALL ALSO BE PROVIDED WITH EXTERNALLY APPLIED INSULATION AS REQUIRED BY THE SPECIFICATIONS.



engineers

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DESIGNED BY:

JSK/DKR

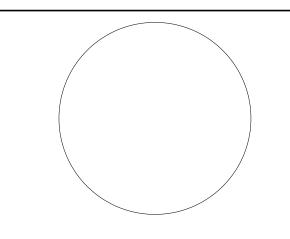DKR

DKR

JSK

JCM


PROJECT No:

DIGA2301

DATE:

SCALE:

AS SHOWN

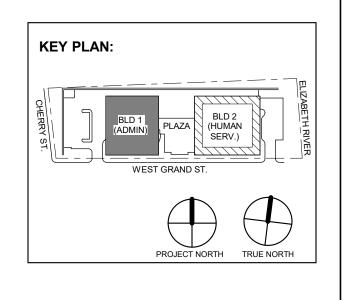

12.22.2023 Addendum No. 4 12.15.2023 Addendum No. 3

2 12.08.2023 Addendum No. 2
11.08.2023 For Public Bid
No. Date Description
Revisions / Issues

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UNION COUNTY IMPROVEMENT AUTHORITY

Project:

UNION COUNTY GOVERNMENT COMPLEX 81 & 93 WEST GRAND STREET CITY OF ELIZABETH NEW JERSEY, 07202

Drawing Information:

Project No: 20.072
Date: 11.08.2023
Drawn By: JB/AV/PC
Checked By: JM/SH

Drawn By: JB/AV/PC
Checked By: JM/SH
Sheet Name:

BUILDING NO. 1 - LEVEL 5 - MECHANICAL DUCTWORK PLAN

Sheet No:

BUILDING NO. 2 - LEVEL 0 - MECHANICAL DUCTWORK PLAN
SCALE: N.T.S.

MECHANICAL SYSTEM NOTES:

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2. DUCTWORK SYSTEM NOTES:

ADDITIONAL FIRE-STOPPING REQUIREMENTS.


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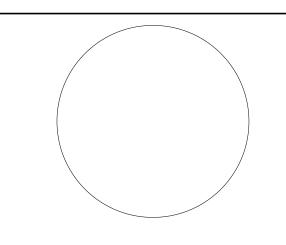


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DESIGNED BY:

JSK/DKR

DKR

DKR

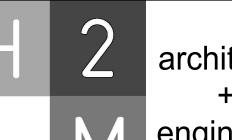JSK


JCM

PROJECT No:

DIGA2301

11/08/2023

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4 12.22.2023 Addendum No. 4
3 12.15.2023 Addendum No. 3
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Client:
UNION COUNTY IMPROVEMENT AUTHORITY

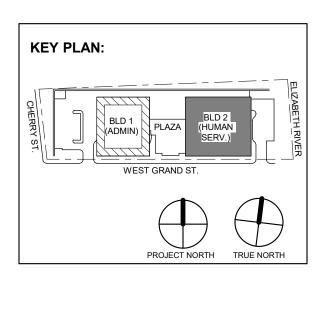Project:

UNION COUNTY GOVERNMENT COMPLEX 81 & 93 WEST GRAND STREET CITY OF ELIZABETH NEW JERSEY, 07202

Drawing Information:

Project No: 20.072
Date: 11.08.2023
Drawn By: JB/AV/PC

Date: 11.08.2023
Drawn By: JB/AV/PC
Checked By: JM/SH
Sheet Name:

BUILDING NO. 2 - LEVEL 0 - MECHANICAL DUCTWORK PLAN

Sheet No:

1 BUILDING NO. 2 - LEVEL 1 - MECHANICAL DUCTWORK PLAN M-111 SCALE: 1/8" = 1'-0"

LOUVER; 450 CFM

26x16 OA DN TO PUMP

MECHANICAL SYSTEM NOTES:

1. GENERAL NOTES:


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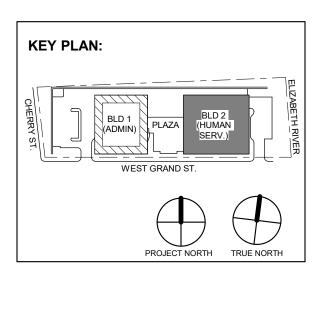


JOHN CHRIS MORRIS III, P.E.

DESIGNED BY: DRAWN BY:

JSK/DKR

DKR JSK DIGA2301 11/08/2023 AS SHOWN

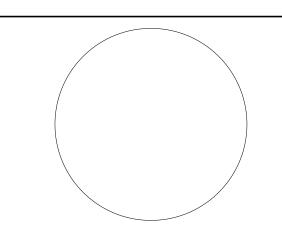


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12.08.2023 Addendum No. 2 11.08.2023 For Public Bid lo. Date Description Revisions / Issues

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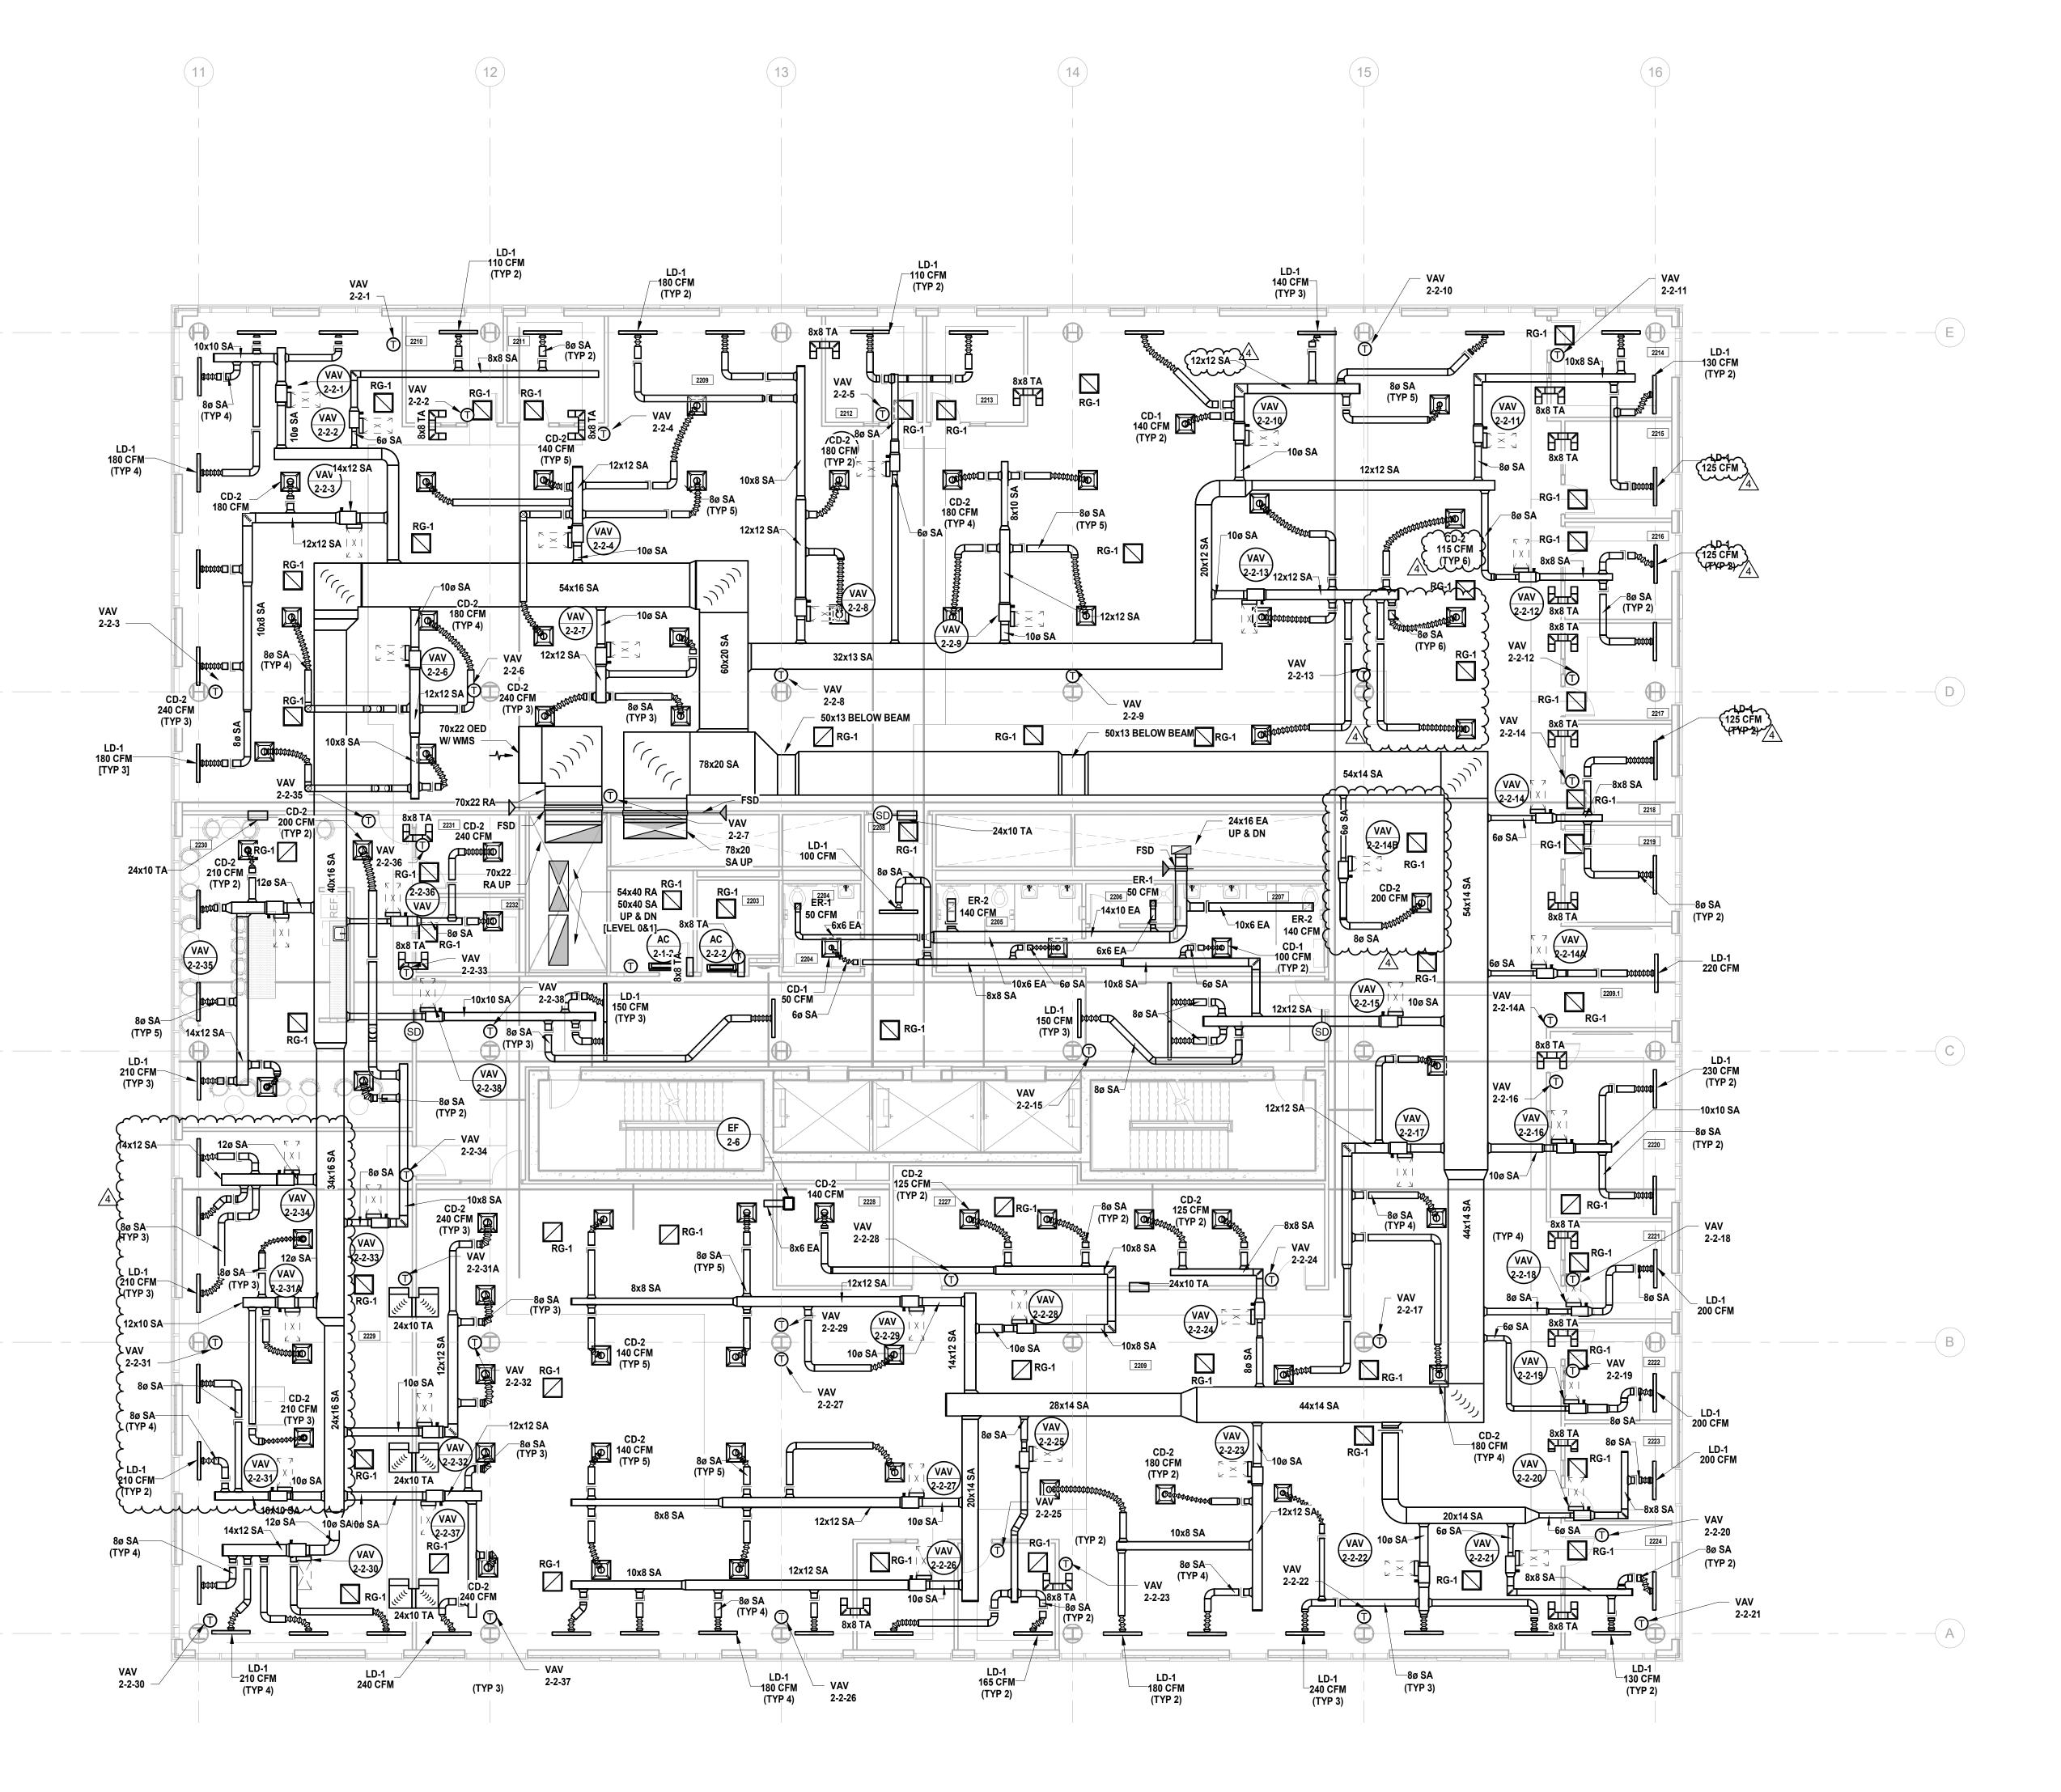
UNION COUNTY GOVERNMENT COMPLEX 81 & 93 WEST GRAND STREET CITY OF ELIZABETH

NEW JERSEY, 07202 Drawing Information:

Project No: 20.072
Date: 11.08.2023
Drawn By: JB/AV/PC
Checked By: JM/SH Sheet Name:

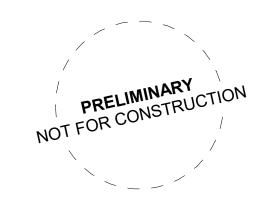BUILDING NO. 2 - LEVEL 1 -MECHANICAL DUCTWORK PLAN

Sheet No:



BUILDING NO. 2 - LEVEL 2 - MECHANICAL DUCTWORK PLAN

M-112 SCALE: 1/8" = 1'-0"

0'-2'-4'-8'-16'

MECHANICAL SYSTEM NOTES:

1. GENERAL NOTES:


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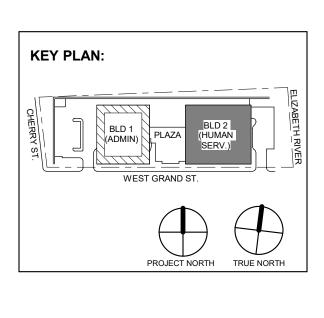
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NJ Engineering Certificate of Authorization No.: 24GA28019100



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DRAWN BY: JSK DIGA2301 11/08/2023 AS SHOWN




12.22.2023 Addendum No. 4 12.15.2023 Addendum No. 3 12.08.2023 Addendum No. 2

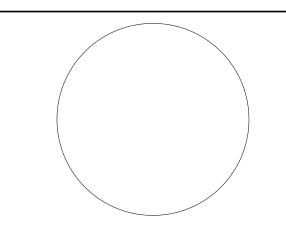11.08.2023 For Public Bid lo. Date Description Revisions / Issues

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UNION COUNTY GOVERNMENT 81 & 93 WEST GRAND STREET CITY OF ELIZABETH NEW JERSEY, 07202


Drawing Information: Project No: 20.072 Date: 11.08.2023 Drawn By: JB/AV/PC Checked By: JM/SH

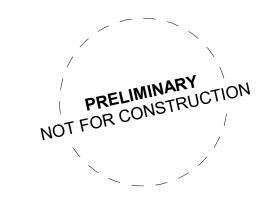BUILDING NO. 2 - LEVEL 2 -

MECHANICAL DUCTWORK PLAN

M-112

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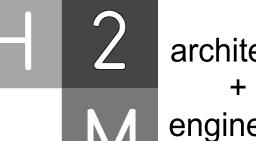


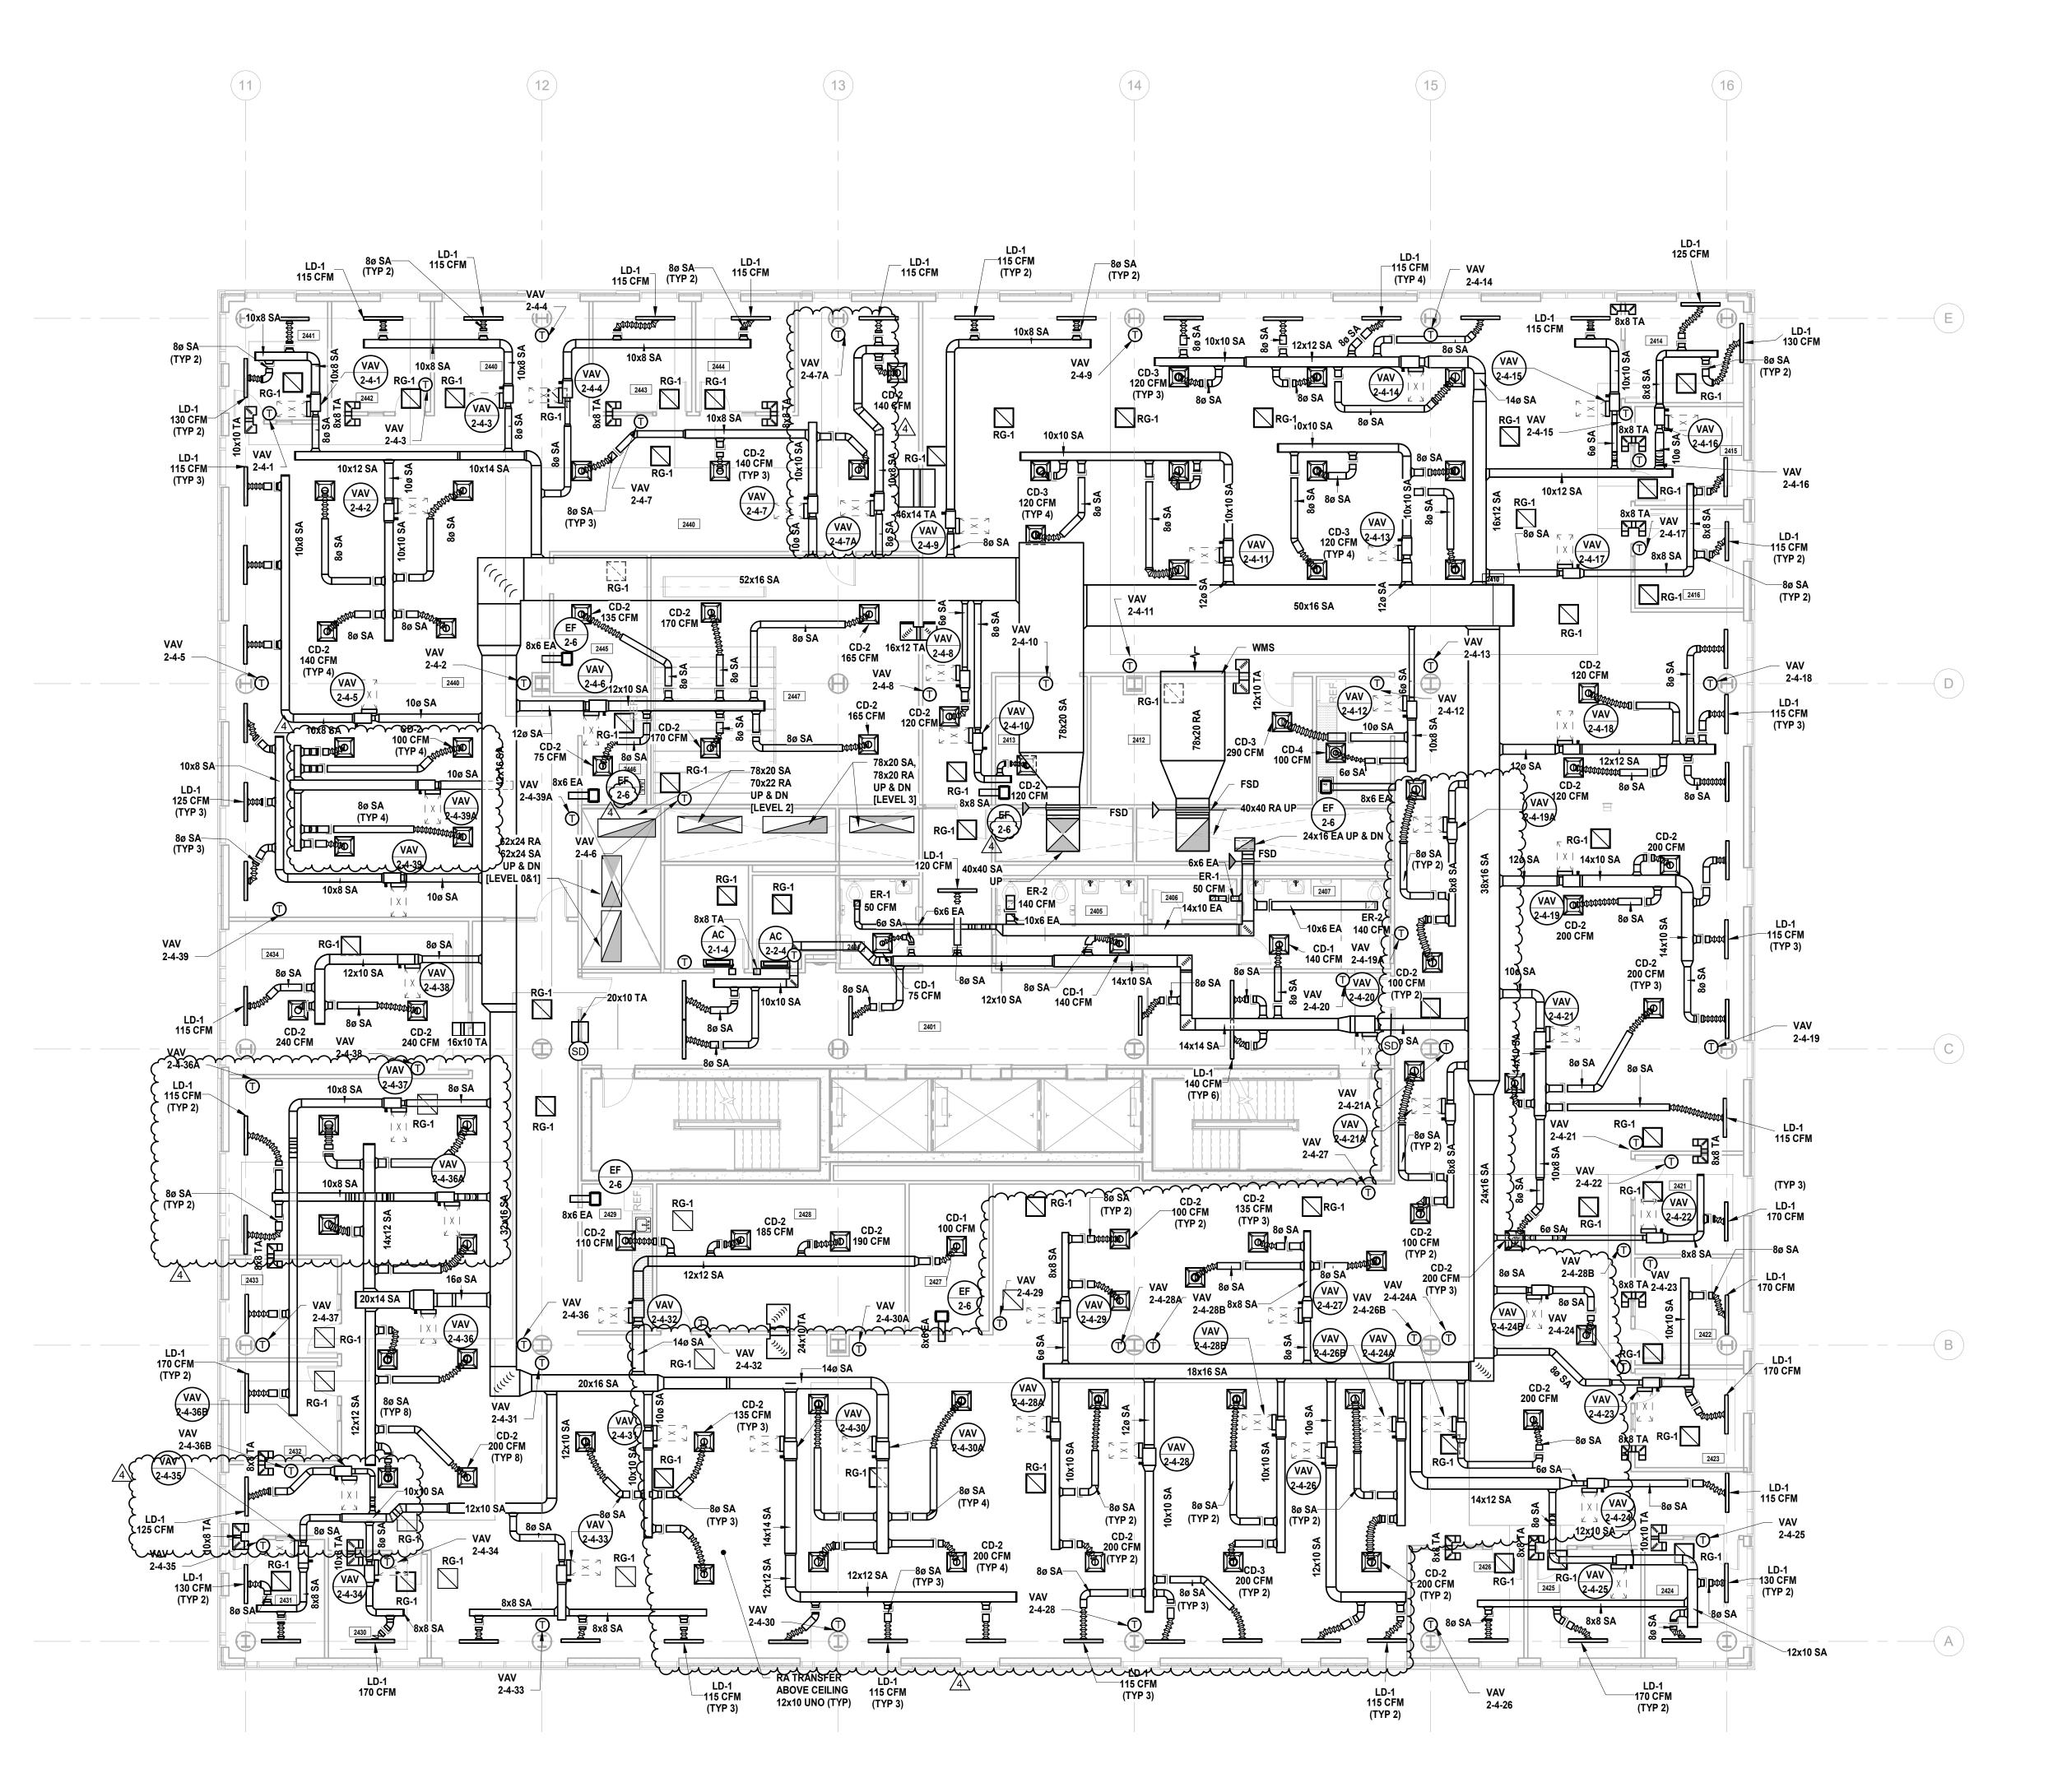BUILDING NO. 2 - LEVEL 4 - MECHANICAL DUCTWORK PLAN M-114 | SCALE: 1/8" = 1'-0" SCALE BAR: 1/8"=1'-0"

MECHANICAL SYSTEM NOTES:


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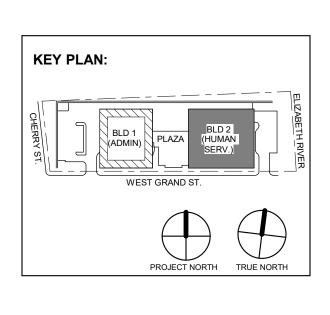
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JOHN CHRIS MORRIS III, P.E.

DESIGNED BY: DRAWN BY:

JSK/DKR DKR JSK DIGA2301 11/08/2023 AS SHOWN




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> Drawing Information: Project No: 20.072 Date: 11.08.2023 Drawn By: JB/AV/PC Checked By: JM/SH

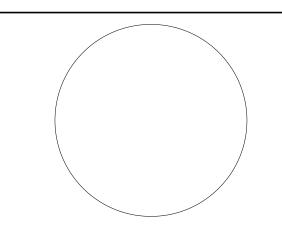Sheet Name: BUILDING NO. 2 - LEVEL 4 -

MECHANICAL DUCTWORK PLAN

Sheet No:

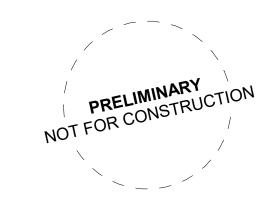M-115 SCALE: 1/8" = 1'-0"

MECHANICAL SYSTEM NOTES:

1. GENERAL NOTES:


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enginee

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DESIGNED BY:

DRAWN BY:

CHECKED BY:

REVIEWED BY:

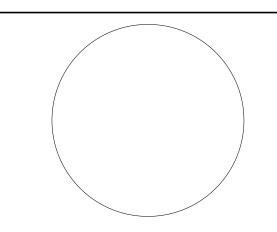
JCM
PROJECT NO:

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SCALE:

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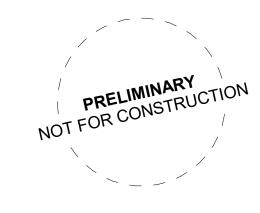
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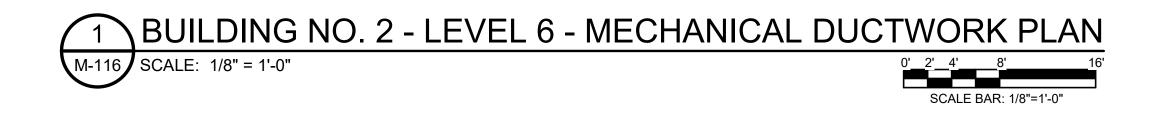
Drawing Information:

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Date: 11.08.2023
Drawn By: JB/AV/PC
Checked By: JM/SH

Drawn By: JB/AV/PC
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Sheet Name:

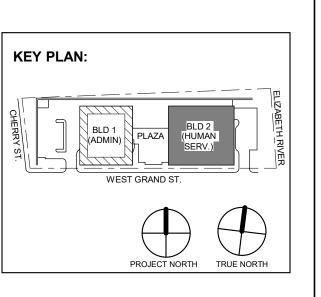BUILDING NO. 2 - LEVEL 5 - MECHANICAL DUCTWORK PLAN

Sheet No:



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- 2. DUCTWORK SYSTEM NOTES: A. CONTRACTOR SHALL FURNISH AND INSTALL ALL EQUIPMENT INDICATED ON PLAN AND AS

ADDITIONAL FIRE-STOPPING REQUIREMENTS.

UTILIZED AS RETURN AIR PLENUMS.


- SCHEDULED. B. CONTRACTOR SHALL COORDINATE ALL FRAME TYPES FOR AIR DEVICES WITH CEILING TYPES
- AS INDICATED ON THE ARCHITECTURAL DRAWINGS.
- C. ALL DUCTWORK DIMENSIONS INDICATED ON PLAN ARE INSIDE CLEAR. REFER TO SPECIFICATIONS FOR ACOUSTICAL LINING AND INSULATION REQUIREMENTS.
- D. ALL RETURN AIR OPEN END DUCTS SHALL BE FINISHED WITH 1" X 1" WIRE MESH SCREENING.
- ACCESS DOORS INSTALLED PER THE PROJECT DETAILS AND SPECIFICATIONS. F. CONTRACTOR SHALL PROVIDE FIRE-STOPPING EQUIVALVENT TO HILTI SYSTEMS OR APPROVED

E. ALL FIRE DAMPERS, SMOKE DAMPERS, AND COMBINATION FIRE/SMOKE DAMPERS SHALL HAVE

EQUIVALENT AT ALL PENETRATIONS OF WALLS AND FLOORS. REFER TO SPECIFICATIONS FOR


- G. CONTRACTOR SHALL UTILIZE PLENUM RATED MATERIALS FOR ALL CEILING PLENUMS BEING
- H. CONTRACTOR SHALL SUPPLY 120V POWER TO ALL LOCATIONS OF BMS PANELS.
- I. INTERNALLY LINE ALL SUPPLY AND RETURN DUCTWORK WITHIN 20 FEET UPSTREAM AND DOWNSTREAM OF FANS WITH 1" THICK INSULATION. INTERNALLY LINED DUCTWORK MEETING THIS REQUIREMENT SHALL ALSO BE PROVIDED WITH EXTERNALLY APPLIED INSULATION AS REQUIRED BY THE SPECIFICATIONS.



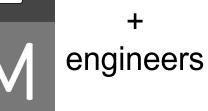


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ESIGNED BY: DRAWN BY:
JSK/DKR DKR JSK DIGA2301 11/08/2023 AS SHOWN

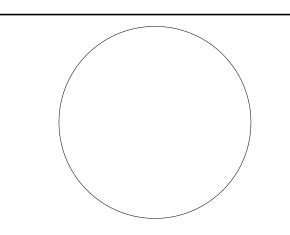


12.22.2023 Addendum No. 4 12.15.2023 Addendum No. 3

12.08.2023 Addendum No. 2 11.08.2023 For Public Bid o. Date Description Revisions / Issues

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UNION COUNTY IMPROVEMENT AUTHORITY

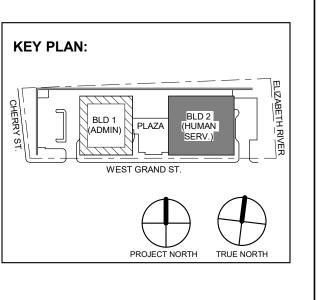UNION COUNTY GOVERNMENT COMPLEX 81 & 93 WEST GRAND STREET CITY OF ELIZABETH NEW JERSEY, 07202
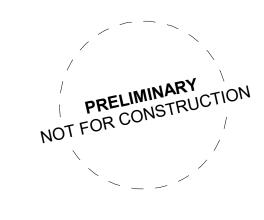
> Drawing Information: Project No: 20.072 Date: 11.08.2023 Drawn By: JB/AV/PC Checked By: JM/SH

Sheet Name: BUILDING NO. 2 - LEVEL 6 -

MECHANICAL DUCTWORK PLAN

Sheet No:

SCALE BAR: 1/8"=1'-0"

MECHANICAL SYSTEM NOTES

- SYMBOLS AND ABBREVIATIONS THAT PERTAIN TO THE SCOPE OF THIS
- THIS PROJECT.
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- BOXES. REFER TO SPECIFICATIONS FOR VALVE TYPE AND CHARACTERISTICS BASED ON PIPE SIZE.
- VALVES ON EACH FLOOR FOR "MAIN BRANCH ISOLATION."
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- PLENUMS BEING UTILZIED AS RETURN AIR PLENUMS.

- 1. GENERAL NOTES: A. REFER TO MECHANICAL LEAD SHEET, M-001 FOR GENERAL NOTES,
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- INSTRUCTIONS.



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- G. CONTRACTOR SHALL UTILIZE PLENUM RATED MATERIALS FOR ALL CEILING


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DRAWN BY:

CHECKED BY:


REVIEWED BY:

JSK/DKR

DKR

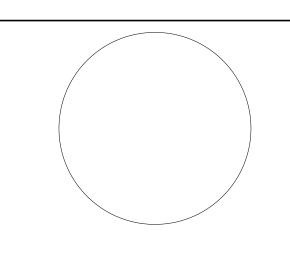JSK

JCM DJECT No: DATE: SCALE: AS SHOWN

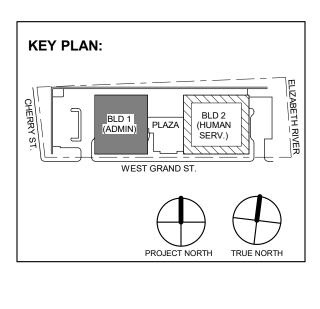


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AUTHORITY

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NEW JERSEY, 07202 Drawing Information: Project No: 20.072 Date: 11.08.2023

Drawn By: JB/AV/PC Checked By: JM/SH Sheet Name:

BUILDING NO. 1 - LEVEL 2 -MECHANICAL PIPING PLAN

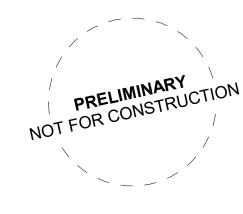Sheet No: **M-203**

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MECHANICAL SYSTEM NOTES

1. GENERAL NOTES:

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REQUIREMENTS.


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H 2 M

enginee

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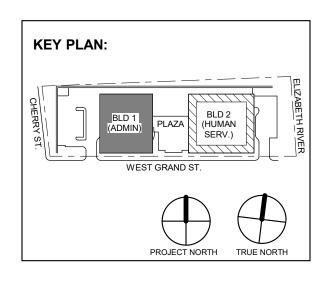
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DESIGNED BY: DRAWN BY: CHECKED BY: REVIEWED BY: JSK/DKR DKR JSK JCM

PROJECT No: DATE: SCALE:

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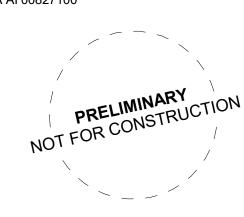
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Description
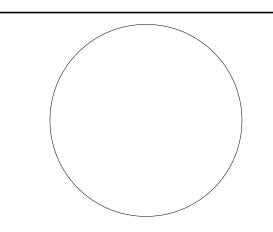
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No. Date



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UNION COUNTY IMPROVEMENT AUTHORITY

roject:

UNION COUNTY GOVERNMENT COMPLEX 81 & 93 WEST GRAND STREET CITY OF ELIZABETH

NEW JERSEY, 07202

Drawing Information:

Project No: 20.072

Date: 11.08.2023

Drawn By: JB/AV/PC

Date: 11.08.202
Drawn By: JB/AV/PC
Checked By: JM/SH
Sheet Name:

BUILDING NO. 1 - LEVEL 4 - MECHANICAL PIPING PLAN

Sheet No:

1 BUILDING NO. 1 - LEVEL 5 - MECHANICAL PIPING PLAN

SCALE BAR: 1/8"=1'-0"

M-206 SCALE: 1/8" = 1'-0"

MECHANICAL SYSTEM NOTES

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REQUIREMENTS.


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H 2 M

engineer

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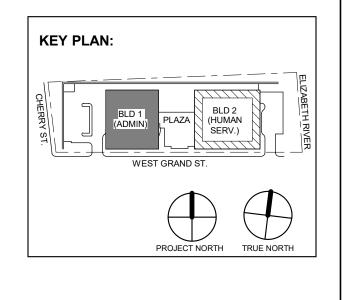
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JSK/DKR DKR JSK JCM

PROJECT NO: DATE: SCALE:

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Project:
UNION COUNTY GOVERNMENT
COMPLEX
81 & 93 WEST GRAND STREET

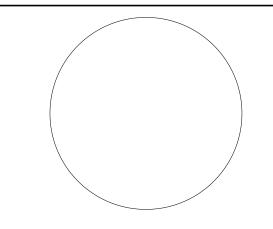CITY OF ELIZABETH
NEW JERSEY, 07202

Drawing Information:

Project No: 20.072
Date: 11.08.2023

Project No: 20.072
Date: 11.08.2023
Drawn By: JB/AV/PC
Checked By: JM/SH
Sheet Name:

BUILDING NO. 1 - LEVEL 5 - MECHANICAL PIPING PLAN

Sheet No:

1 BUILDING NO. 2 - LEVEL 0 - MECHANICAL PIPING PLAN M-210 SCALE: 1/8" = 1'-0"

MECHANICAL SYSTEM NOTES

- 1. GENERAL NOTES: A. REFER TO MECHANICAL LEAD SHEET, M-001 FOR GENERAL NOTES, SYMBOLS AND ABBREVIATIONS THAT PERTAIN TO THE SCOPE OF THIS
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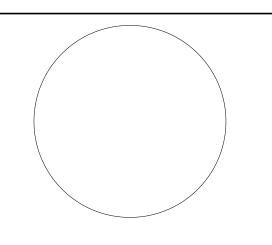
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DESIGNED BY:

JSK/DKR

DKR


DKR

DKR

DKR

JSK

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Drawing Information: Project No: 20.072 Date: 11.08.2023

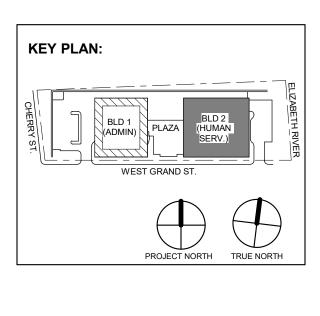NEW JERSEY, 07202

Drawn By: JB/AV/PC Checked By: JM/SH Sheet Name: BUILDING NO. 2 - LEVEL 0 -

Sheet No:

M-210

MECHANICAL PIPING PLAN

1 BUILDING NO. 2 - LEVEL 2 - MECHANICAL PIPING PLAN M-212 SCALE: 1/8" = 1'-0" SCALE BAR: 1/8"=1'-0"

3/4"HWR 3/4"HWS

3/4"HWS-

MECHANICAL SYSTEM NOTES


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DESIGNED BY:

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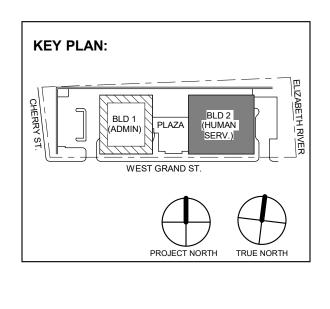
JSK/DKR

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JSK

JCM DIGA2301 11/08/2023 AS SHOWN

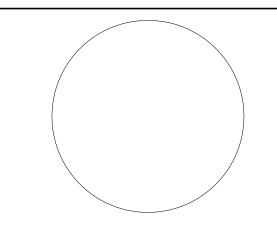

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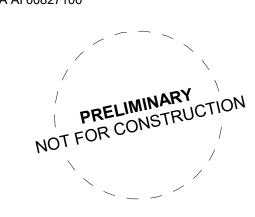
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UNION COUNTY IMPROVEMENT

UNION COUNTY GOVERNMENT COMPLEX 81 & 93 WEST GRAND STREET CITY OF ELIZABETH NEW JERSEY, 07202

Drawing Information: Project No: 20.072 Date: 11.08.2023 Drawn By: JB/AV/PC

Checked By: JM/SH

Sheet Name: BUILDING NO. 2 - LEVEL 2 -MECHANICAL PIPING PLAN

Sheet No:

BUILDING NO. 2 - LEVEL 4 - MECHANICAL PIPING PLAN

M-214 SCALE: 1/8" = 1'-0"

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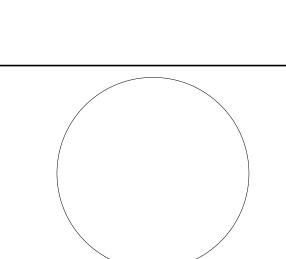
- SLOPE OF 1% IN THE DIRECTION OF DISHARGE.
- AND FLOORS. REFER TO SPECIFICATIONS FOR ADDITIONAL FIRE-STOPPING
- G. CONTRACTOR SHALL UTILIZE PLENUM RATED MATERIALS FOR ALL CEILING

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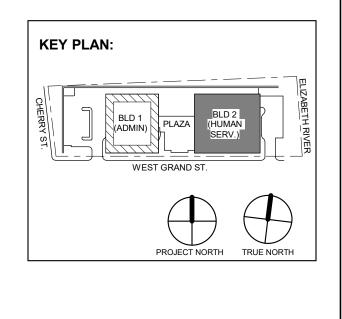
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N BY: CHECKED BY: REVIEWED BY:

DKR JSK JCM DESIGNED BY: DRAWN BY:

JSK/DKR

DKR DJECT No: DATE: SCALE: AS SHOWN



12.15.2023 Addendum No. 3 11.08.2023 For Public Bid

Description

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Jeffrey D. Venezia, AIA NJ RA AI 00827100

No. Date

Revisions / Issues



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UNION COUNTY IMPROVEMENT AUTHORITY

UNION COUNTY GOVERNMENT COMPLEX 81 & 93 WEST GRAND STREET CITY OF ELIZABETH


NEW JERSEY, 07202 Drawing Information:

Project No: 20.072 Date: 11.08.2023 Drawn By: JB/AV/PC Checked By: JM/SH

BUILDING NO. 2 - LEVEL 4 -MECHANICAL PIPING PLAN

Sheet No: **M-214**

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MECHANICAL SYSTEM NOTES

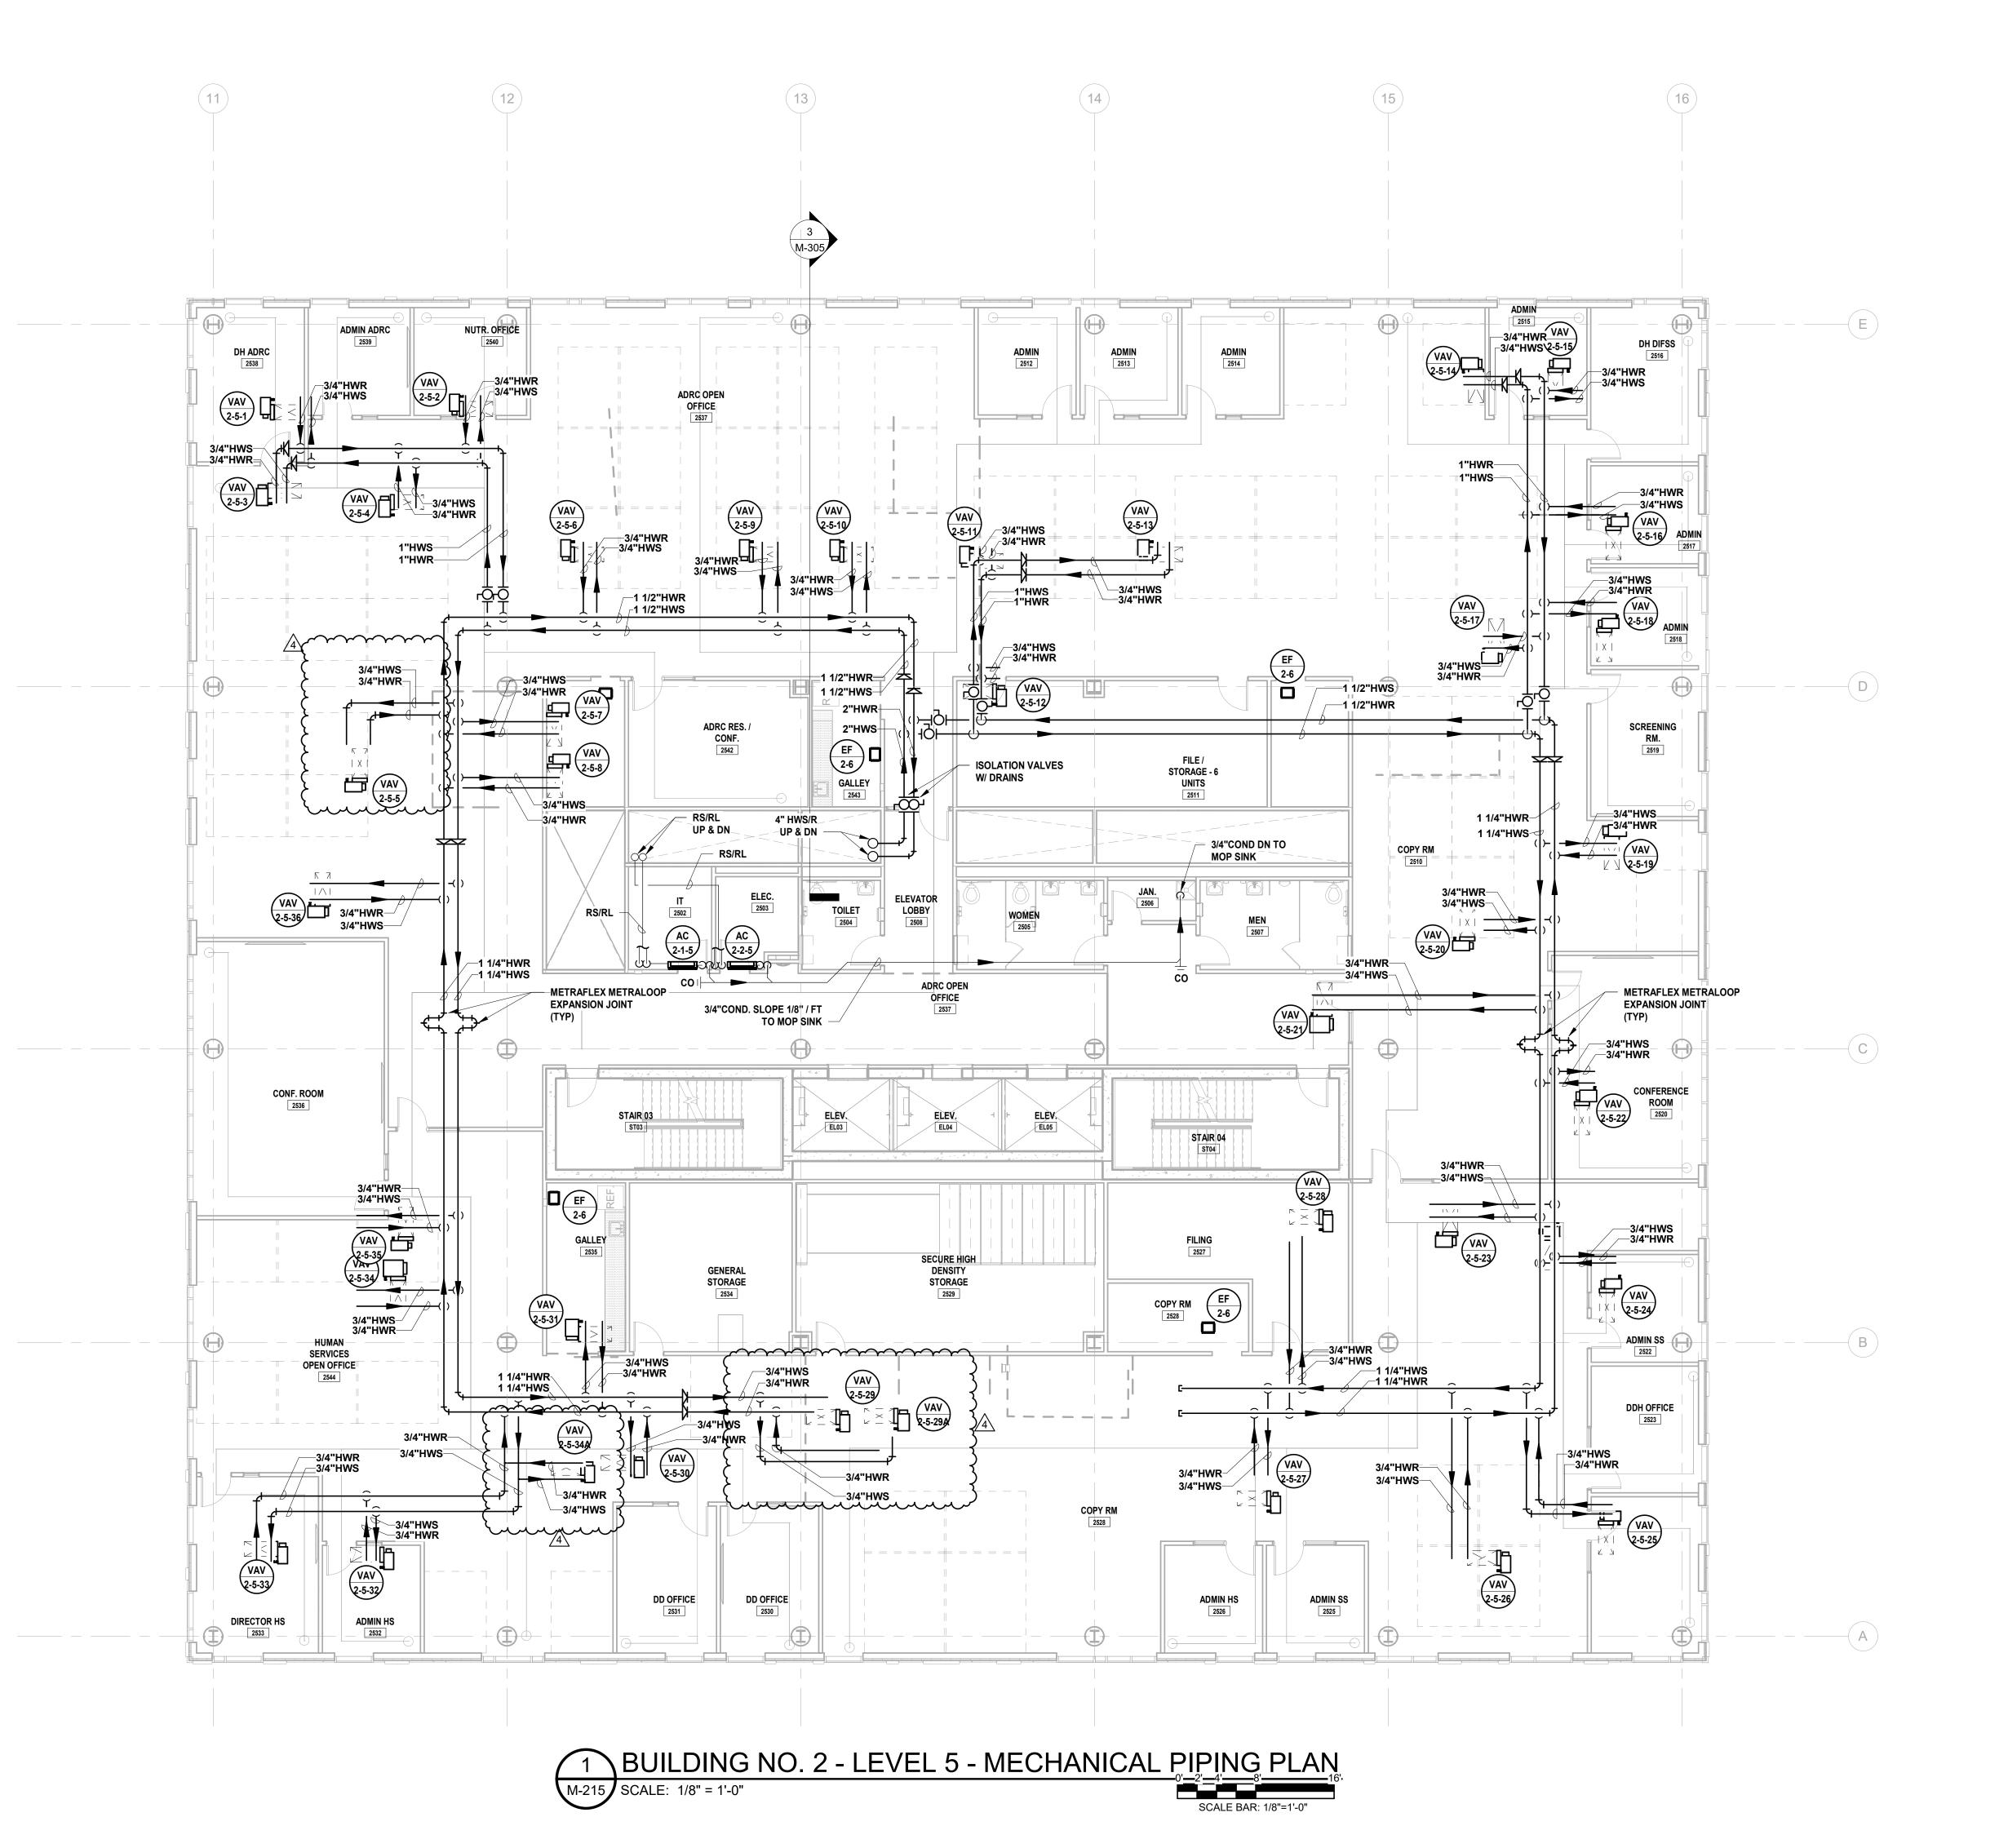- 1. GENERAL NOTES:

 A. REFER TO MECHANICAL LEAD SHEET, M-001 FOR GENERAL NOTES,
 SYMBOLS AND ABBREVIATIONS THAT PERTAIN TO THE SCOPE OF THIS
- B. REFER TO DETAIL DRAWINGS FOR MECHANICAL DETAILS PERTAINING TO
- THIS PROJECT.

 C. REFER TO BOOK SPECIFICATIONS FOR PROJECT DETAILS AND EXECUTION
- D. CONTRACTOR SHALL INSTALL ALL EQUIPMENT AND APPURTENANCES IN STRICT ACCORDANCE WITH THE MANUFACTURER'S WRITTEN INSTRUCTIONS AND SHALL MAINTAIN ALL CLEARANCES (INSTALLATION AND MAINTENANCE) AS NOTED WITHIN THE WRITTEN INSTRUCTIONS.

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- C. CONTRACTOR SHALL PROVIDE DRAIN VALVES AT MAIN BRANCH ISOLATION VALVES ON EACH FLOOR FOR "MAIN BRANCH ISOLATION."
- D. CONTRACTOR SHALL PROVIDE AIR VENTS AT ALL HIGH POINTS AND DRAIN VALVES AT ALL LOW POINTS IN THE SYSTEM.
- E. CONTRACTOR SHALL SLOPE ALL CONDENSATE AT A MINIMUM HORIZONTAL SLOPE OF 1% IN THE DIRECTION OF DISHARGE.
- F. CONTRACTOR SHALL PROVIDE FIRE-STOPPING EQUIVALVENT TO HILTI SYSTEMS OR APPROVED EQUIVALENT AT ALL PENETRATIONS OF WALLS AND FLOORS. REFER TO SPECIFICATIONS FOR ADDITIONAL FIRE-STOPPING REQUIREMENTS.
- G. CONTRACTOR SHALL UTILIZE PLENUM RATED MATERIALS FOR ALL CEILING PLENUMS BEING UTILZIED AS RETURN AIR PLENUMS.


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engineers

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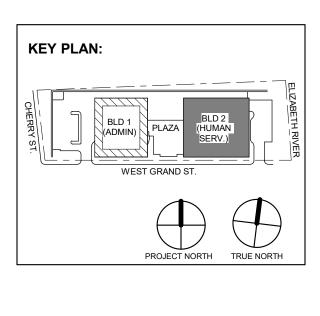
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DESIGNED BY: DRAWN BY: CHECKED BY: REVIEWED BY:

JSK/DKR DKR JSK JCM

PROJECT No: DATE: SCALE:

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No. Date Description
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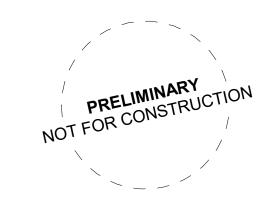
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UNION COUNTY IMPROVEMENT AUTHORITY
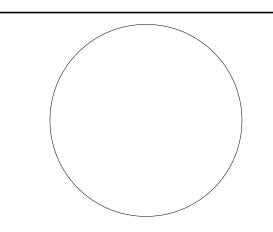
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UNION COUNTY GOVERNMENT COMPLEX 81 & 93 WEST GRAND STREET CITY OF ELIZABETH NEW JERSEY, 07202


Drawing Information:

Project No: 20.072
Date: 11.08.2023
Drawn By: JB/AV/PC
Checked By: JM/SH

Sheet Name:
BUILDING NO. 2 - LEVEL 5 -

MECHANICAL PIPING PLAN

Sheet No:

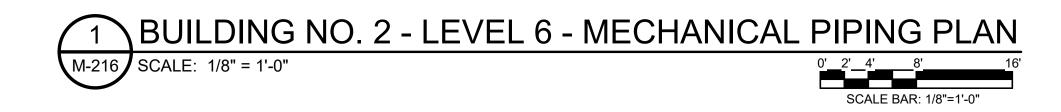

MECHANICAL SYSTEM NOTES


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JOHN CHRIS MORRIS III, P.E.

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DESIGNED BY:

DRAWN BY:

CHECKED BY:

REVIEWED BY:

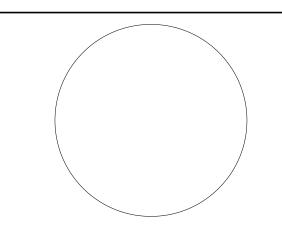
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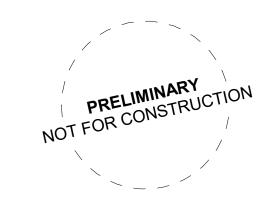
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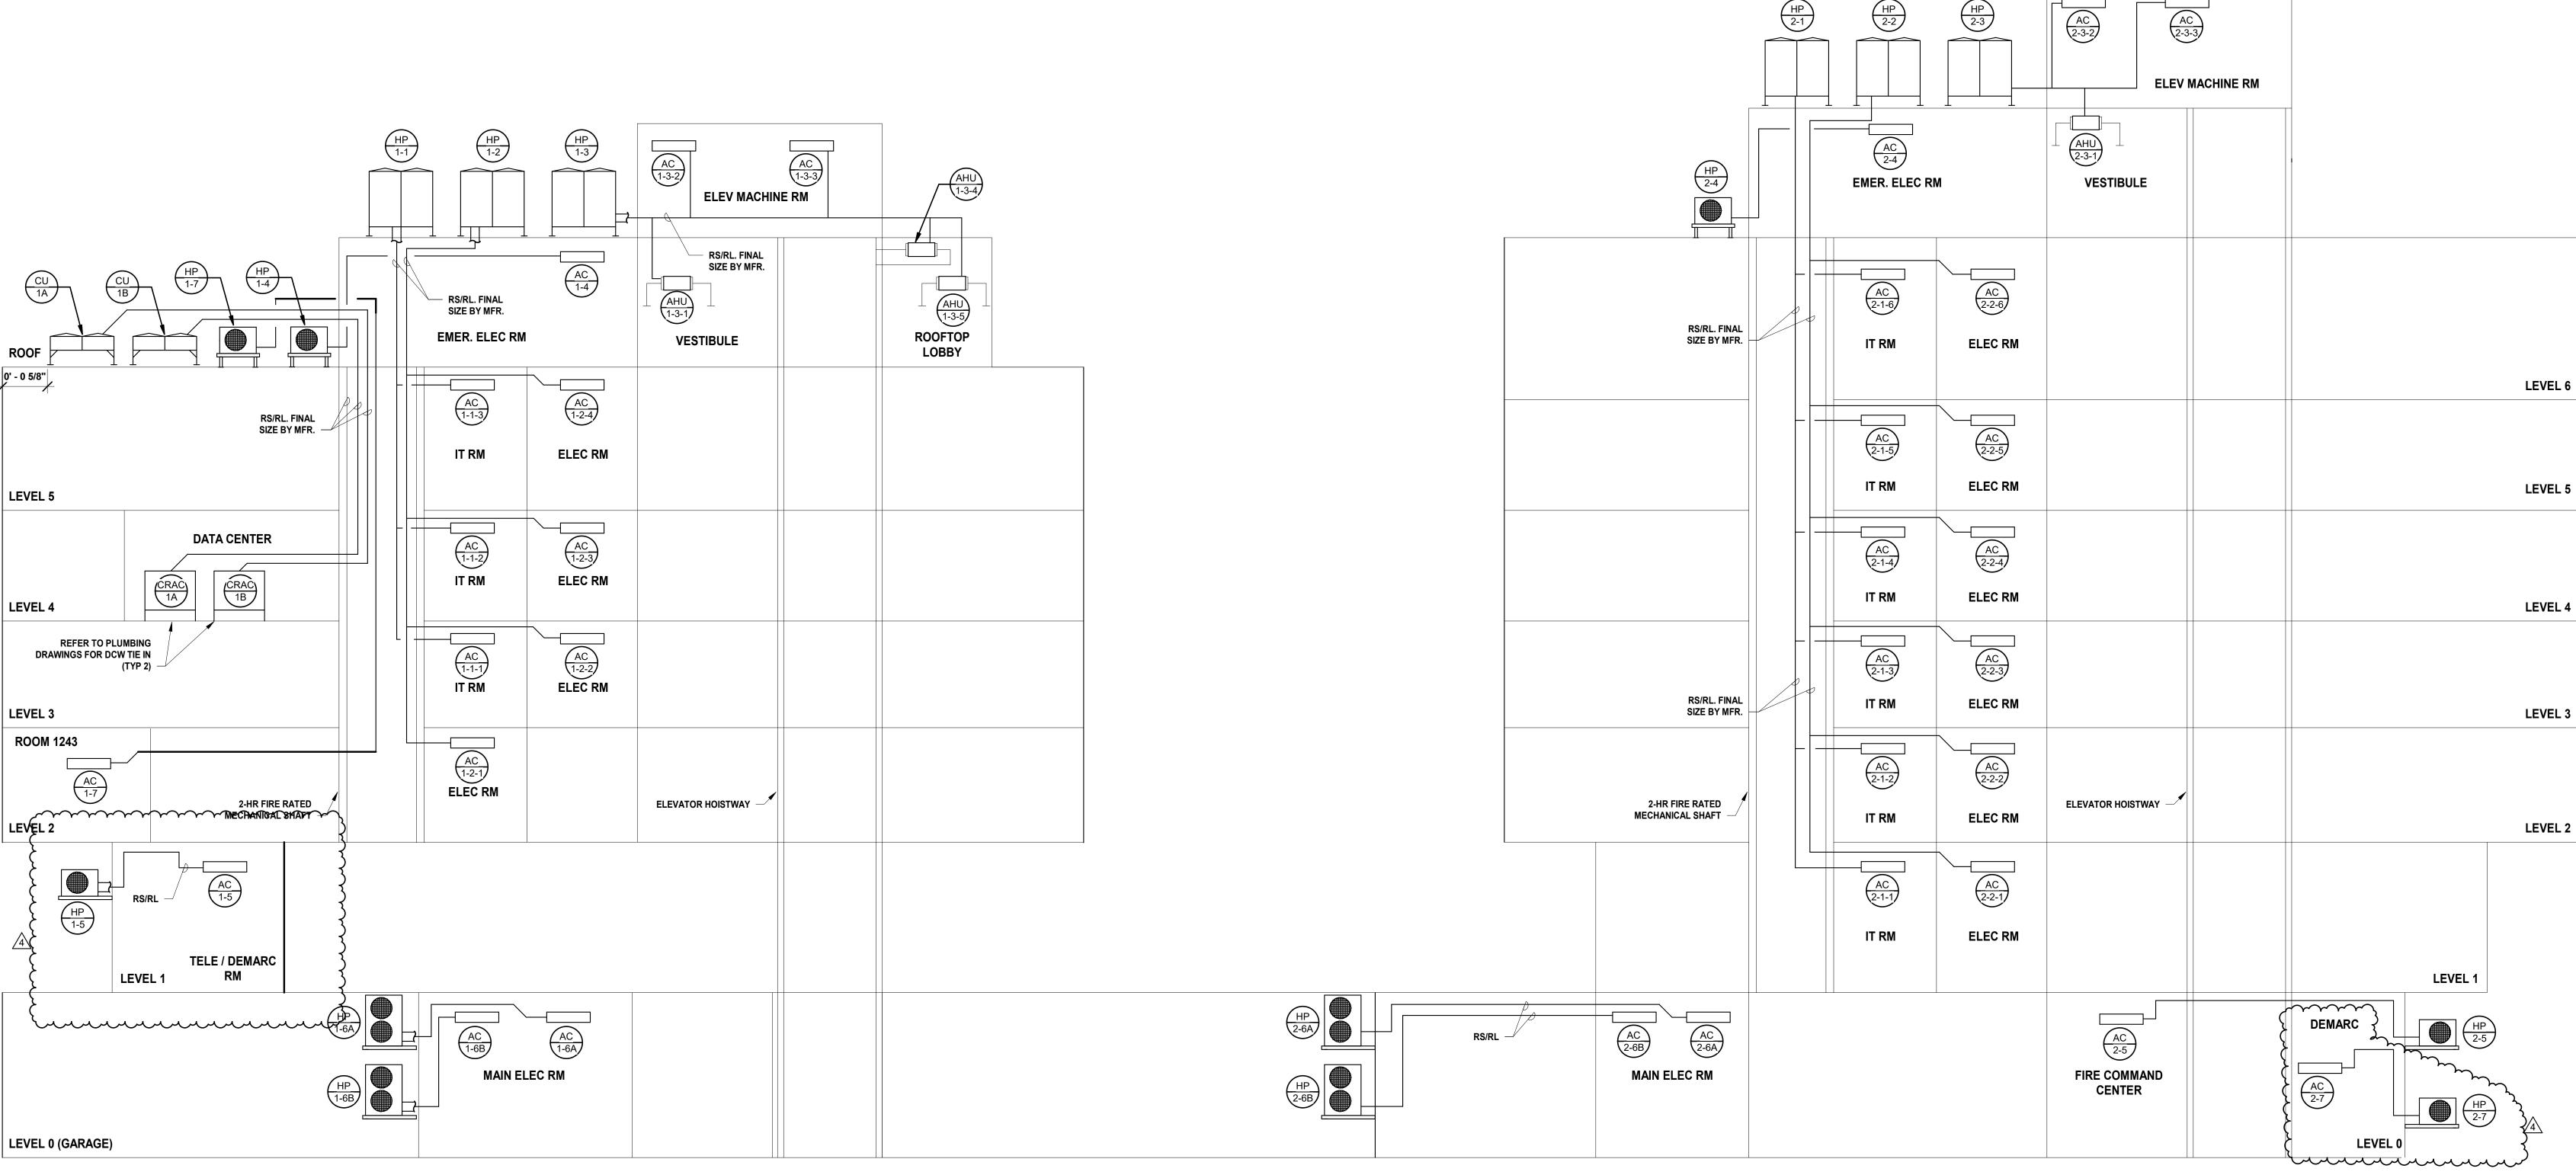
UNION COUNTY IMPROVEMENT

UNION COUNTY GOVERNMENT COMPLEX 81 & 93 WEST GRAND STREET CITY OF ELIZABETH NEW JERSEY, 07202

> Drawing Information: Project No: 20.072 Date: 11.08.2023 Drawn By: JB/AV/PC Checked By: JM/SH


Sheet Name: BUILDING NO. 2 - LEVEL 6 -MECHANICAL PIPING PLAN

Sheet No:

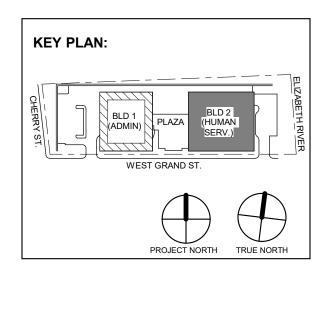

BUILDING NO .2 BUILDING NO. 1

> MECHANICAL BUILDING NO. 1 & 2
> VRF/SUPPLEMENTAL COOLING SYSTEM RISER DIAGRAM
> SCALE: N.T.S.

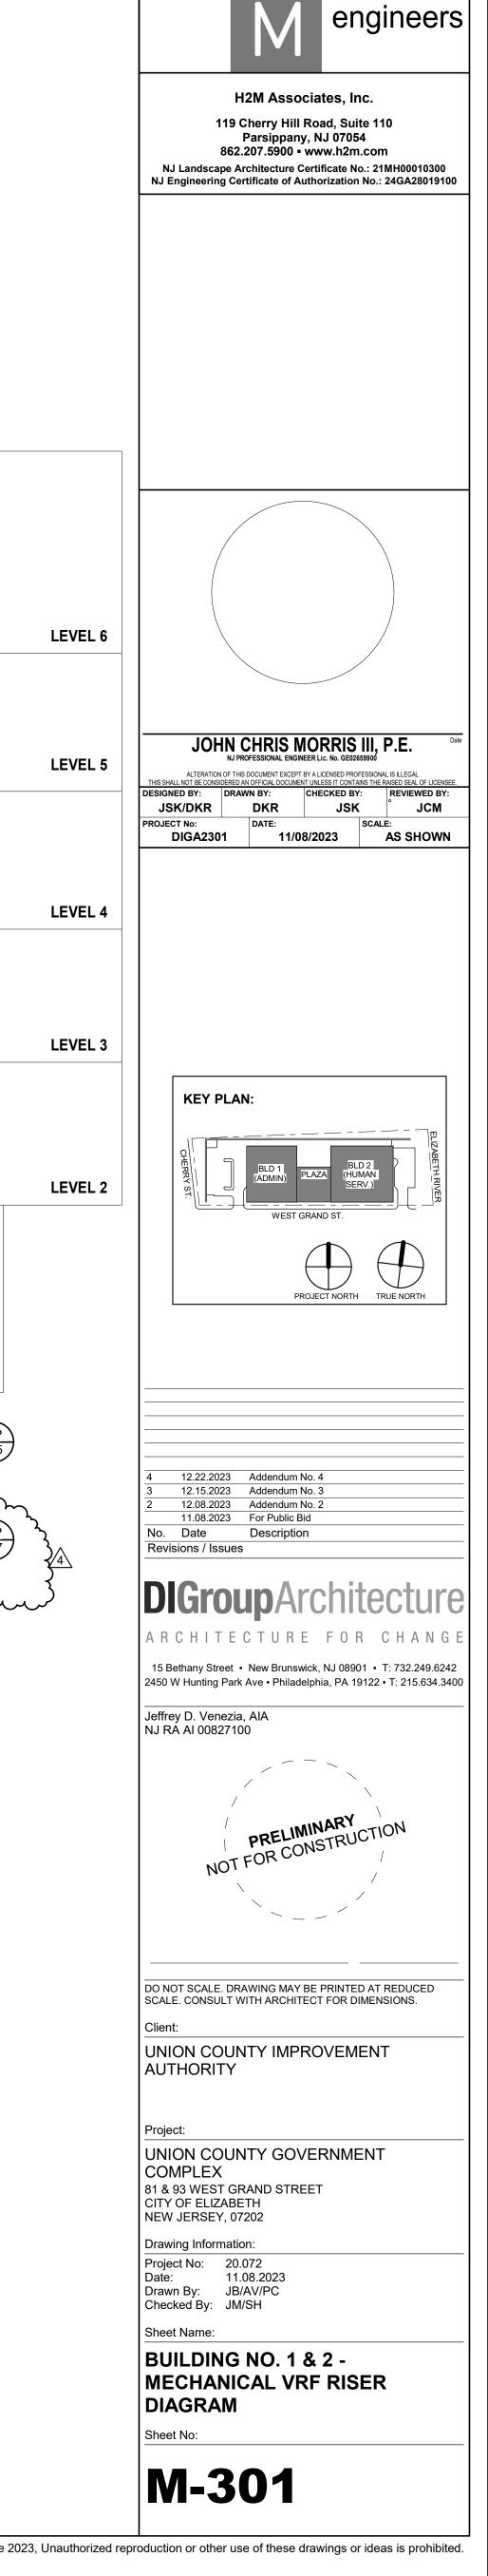

NOTES:

1. PROVIDE PREMIUM EFFICIENCY MOTORS FOR ALL FANS

2. PROVIDE 14" INSULATED ROOF CURB FOR ROOFTOP EXHAUST FANS

3. PROVIDE VCD-23 PARALLEL BLADE MOTORIZED DAMPER. DAMPER TO BE POWERED BY BMS PANL, CONTRACTOR TO PROVIDE CONTROLS SUBMITTAL.

4. PROVIDE VFD W/ INTEGRAL DISCONNECT FOR GARAGE EXHAUST FANS.

5. PROVIDE DISCONNECT FOR ALL EF'S

6. PROVIDE SPEED CONTROLLER FOR ALL DIRECT DRIVE FANS

7. MANUFACTURER PROVIDED VARI-GREEN HOA CONTROLLER

8. PROVIDE GRAVITY BACKDRAFT DAMPER

	COMPUTER	R ROOM AIR COND	ITIONING UNIT	
	SYMBOL		CRAC-1A	CRAC-1B
	LOCATION		DATA CTR RM 1442	DATA CTR RM 1442
		CFM	5200	5200
	SUPPLY AIR FAN	E.S.P. (IN.W.G.)	0.5	0.5
AIR HANDLER		HP	3.75	3.8
		VOLTS/PH/Hz	460/3/60	460/3/60
	ELECTRICAL	FLA / MCA	33.4 / 40.8	33.4 / 40.8
		MOP	45	45
	WEIGHT	LBS	1370	1370
	BASIS OF DESIGN	LIEBERT	VS035ADA1EI	VS035ADA1EI
	SYMBOL		CU-1A	CU-1B
	LOCATION		ROOF	ROOF
	REFRIG TYPE		R-407C	R-407C
	DESIGN AMBIENT	DEG F	95	95
	FAN MOTOR TYPE		VARIABLE SPEED EC	VARIABLE SPEED EC
CONDENSING	NO OF FANS	QTY	2	2
UNIT	CONDENSER CIRCUITS	QTY	2	2
		VOLTS/PH/Hz	460/3/60	460/3/60
	ELECTRICAL	FLA / MCA	2.8 / 3.3	2.8 / 3.3
		MOP	15.0	15.0
	WEIGHT	LBS	270.0	270.0
	BASIS OF DESIGN	LIEBERT	MCS056E8AD	MCS056E8AD
	МВН	TOTAL	124.7	124.7
COOLING	MBH	SENS.	110.8	110.8
AT 72 F DB	EVAP COIL ROWS	NO. OF ROWS	6	6
50%RH	MAX FACE VELOCITY	FPM	450	450
		MDU	540	F4.0
000 El E07010	CAPACITY	MBH	51.2	51.2
SCR ELECTRIC		KW	15 (3-STAGE)	15 (3-STAGE)
REHEAT COIL	FLECTRICAL	VOLTS/PH/Hz	460/3/60	460/3/60
	ELECTRICAL	FLA	NOTE 1	NOTE 1
		MOP	NOTE 1	NOTE 1
CANADOTES		LBS/HR	11	11
CANNISTER HUMIDIFIER	CAPACITY SYSTEM PWR.	COMPLIANCE	- ASME A112.1.2	- ASME A112.1.2

1. ELECTRICAL REQUIREMENTS FOR ELECTRIC REHEAT ARE INCLUDED IN MCA AND MOP FOR THE AIR HANDLING UNIT.

2. SEE SPECIFICATION SHEETS FOR EQUIPMENT SPECIFICATIONS AND ACCESSORIES.

3. UNIT SHALL BE SUPPLIED WITH INTEGRAL CONTROLLER WITH BACNET COMMUNICATION CARD. CONTRACTOR SHALL PROVIDE INTERLOCK WIRING BETWEEN CRAC UNIT AND THE CONDENSING UNIT.

4. PROVIDE 24" HIGH SUPPLY AIR DISCHARGE PLENUM WITH SUPPLY GRILLES. PROVIDE COMPRESSOR EXTENSION WITH TOP PANEL. 5. PROVIDE 65 KA SCCR RATING ON AHU AND CONDENSING UNIT.

6. PROVIDE 4" MERV 8 FILTER WITH FILTER CLOG DETECTION ALARM.

7. PROVIDE DIGITAL SCROLL COMPRESSOR WITH ROTOLOCKS, VARIABLE CAPACITY (20% MIN), CRANKCASE HEATER AND

LOW SOUND PACKAGE (COMPRESSOR SOUND JACKET AND ADDITIONAL PANEL INSULATION.)

8. PROVIDE LOCKING DISCONNECT SWITCH FOR AHU AND FUSED, LOCKABLE DISCONNECT BY UNIT MANUFACTURER.

9. PROVIDE DUAL FLOAT CONDENSATE PUMP, REMOTE SHUTDOWN TERMINAL, ALARM CONTACT, POINT LEAK SENSOR PER UNIT.

10. MANUFACTURER PROVIDED BRACING KIT.

				AIR TER	MINAL DEVI	CE SCHEDULE			
0,41501	0=0/40=	7/0-		NEOV OF			BASIS OF DESIG	GN	NOTES
SYMBOL	SERVICE	TYPE	CFM RANGE	NECK SIZE	N.C	FACE OVERALL DIMENSIONS WxL (IN.)	MANUFACTURER	MODEL	NOTES
CD-1	SUPPLY	LAY-IN	0-175	6"ø	20	24x24	KRUEGER	PLQ	1-7,12
CD-2	SUPPLY	LAY-IN	176-250	8"ø	20	24x24	KRUEGER	PLQ	1-7,12
CD-3	SUPPLY	LAY-IN	251-400	10"ø	20	24x24	KRUEGER	PLQ	1-7,12
CD-4	SUPPLY	LAY-IN	401-550	12"ø	22	24x24	KRUEGER	PLQ	1-7,12
CD-5	SUPPLY	LAY-IN	551-740	14"ø	22	24x24	KRUEGER	PLQ	1-7,12
CD-6	SUPPLY	LAY-IN	176-250	8"ø	20	24x24	KRUEGER	5PLQ	1-7,12
CD-7	SUPPLY	LAY-IN	251-400	10"ø	20	24x24	KRUEGER	5PLQ	1-7,12
CD-8	SUPPLY	LAY-IN	50-150	6"ø	20	12x12	KRUEGER	5PLQ	1-7,12
SG-4	SUPPLR	DUCT MTD	1000-4000	46x22	35	48x24	KRUEGER	880	1,2,6
LD-1	SUPPLY	SEE DWG	150-250	8"ø	28	1" SLOT WIDTH x 4' LENGTH	KRUEGER	2-SLOT 1900BOOT	1-3,5-9,12,1
LR-1	RETURN	SEE DWG	0-400	-	28	1" SLOT WIDTH x 4' LENGTH	KRUEGER	2-SLOT 1900BOOT	1,2,6-10
RG-1	RETURN	LAY-IN	0-1600	22x22	25	24x24	KRUEGER	\$80	1,2,6,7,10
RG-2	RETURN	LAY-IN	140-250	10x10	-	12x12	KRUEGER	\$80	1,2,6,7,10
RG-3	RETURN	SURFACE MTD	0-800	16x16	25	18x18	KRUEGER	\$80	1,2,6,7,10
RG-4	RETURN	SURFACE MTD	0-4500	54x24	25	56x26	KRUEGER	\$80	1,2,6,7,10
ER-1	EXHAUST	LAY-IN	0-75	6x6	-	12x12	KRUEGER	S580	1,2,6,7,11
ER-2	EXHAUST	LAY-IN	76-140	8x8	-	12x12	KRUEGER	S580	1,2,6,7,11
ER-3	EXHAUST	LAY-IN	140-250	10x10	-	12x12	KRUEGER	S580	1,2,6,7,11

1. REFER TO MECHANICAL DRAWINGS FOR LOCATIONS.

2. MOUNTING FRAME TYPE SHALL BE COORDINATED WITH THE CEILING/WALL CONSTRUCTION TYPE.

3. FLEXIBLE DUCTS CONNECTING TO THE DIFFUSERS SHALL BE FULL SIZE OF NECK DIAMETER AND NOT EXCEED 4' IN LENGTH.

4. DIFFUSERS SHALL BE 4-WAY BLOW UNLESS OTHERWISE INDICATED ON PLANS

5. PROVIDE SQUARE TO ROUND NECK ADAPTERS IF REQUIRED

6. ALL GRILLES MOUNTED IN CEILINGS, SOFFITS, OR WALLS SHALL HAVE BAKED WHITE ENAMEL FINISH OR COLOR AS SELECTED BY ARCHITECT. FINAL COLORS TO BE DETERMINED POST AWARD. ALL GRILLES MOUNTED...

7. REFER TO ARCHITECTS REFLECTED CEILING PLANS FOR ALL FINAL LOCATIONS OF DIFFUSERS AND GRILLES

8. WHERE LINEAR DIFFUSERS ARE INSTALLED END-TO-END, PROVIDE END CONNECTIONS SUCH THAT THERE IS A CONTINUOUS APPEARANCE

9. PROVIDE MUD FRAMES (TAPE & SPACKLE) FOR ALL LINEAR DIFFUSERS (LD & LR) LOCATED WITH GYP CEILING.

10. PROVIDE LIGHT SCREEN / RETURN BAFFLE

11. PROVIDE CONSTANT AIRFLOW REGISTERS ON ALL EXHAUST GRILLES AS NOTED ON PLAN. BASIS OF DESIGN: POTTORFF CAR.

12. PROVIDE ROTO-TWIST DAMPERS FOR ALL AIR DEVICES DEEMED INACCESSIBLE. REFER TO "ROTO-TWIST DETAIL"

13. PLENUM BOXES FOR LINEAR AIR DEVICES SHALL BE ACOUSTICALLY LINED. REFER TO INSULATION SCHEDULE.

STAIRWELL PRESSURIZATION FAN SCHEDULE												
CVMDOI	OED\/IOE	LOCATION	OEM.	FOD	FAN DDM	MOTOR UR	ELECTRICAL	OPER	BASIS OF DESIG	iN	NOTES	
SYMBOL	SERVICE	LOCATION	CFM	ESP	FAN RPM	MOTOR HP	V/PH/HZ	WEIGHT (LBS)	MANUFACTURER	MODEL	NOTES	
SPF 2-1	STAIR 3	BLDG 2 ROOF	8000	2	989	5	460/3/60	443	GREENHECK	USF-27	1-12	
SPF 2-2	STAIR 4	BLDG 2 ROOF	8000	2	989	5	460/3/60	443	GREENHECK	USF-27	1-12	

NOTES:

1. PROVIDE INLET SCREEN

2. MOUNT ON NEW ROOF MOUNTED EQUIPMENT SUPPORT RAILS WITH HOUSED SPRING ISOLATORS

3. PROVIDE FACTORY MOUNTED DISCONNECT SWITCH. SWITCH SHALL INCLUDE CONTACTS TO IDENTIFY SWITCH OPEN/CLOSE POSITION.

4. ALL FANS ARE TO BE INTERLOCKED INTO THE BMS. REFER TO SEQUENCE OF OPERATIONS FOR FAN OPERATION

5. PROVIDE ROTARY BELT TENSIONER

6. PROVIDE INVERTER DUTY PREMIUM EFFICIENCY MOTOR WITH SHAFT GROUNDING RING FOR USE WITH VFD'S.

7. PROVIDE 2.0 SERVICE FACTOR

8. PROVIDE CLASS 2 FAN

9. PROVIDE MOTOR COVER WITH HINGED ACCESS DOOR

10. PROVIDE STEEL DRAIN

11. PROVIDE TOP HORIZONTAL DISCHARGE

12. PROVIDE DIFFERENTIAL PRESSURE SENSORS ON LEVEL 1 & LEVEL 3.

						HEAT PUMP SCH	HEDULE											
				INDOOR UNIT	,								OUTDOOR	UNIT				
UNIT	MFR	MODEL	STYLE	SERVING	REFRIGERANT	SUPPLY AIRFLOW CFM	TOTAL COOLING			UNIT	MODEL	EFF	ICIENCY	ELE	CTRICA	L	WEIGHT	NOTES
						(H/M/L)	CAP (MBH)	CAP (MBH)	(LBS)			SEER2	HSPF2	V/PH/HZ	MCA	MOCP (A)	(LBS)	
AC 1-4	LG	LSN363HLV3	WALL MOUNTED - DUCTLESS	BLDG 1 - EMERGENCY ELEC RM	R410A	1,095 / 883 / 742 / 601	33	35.7	50	HP 1-4	LSU363HLV3	19	7.9	208-230/1/60	23	30	160	1-9
AC 1-5	LG	LSN363HLV3	WALL MOUNTED - DUCTLESS	BLDG 1 - TELE / DEMARC	R410A	1,095 / 883 / 742 / 601	33	35.7	50	HP 1-5	LSU363HLV3	19	7.9	208-230/1/60	23	30	160	1-9
AC 1-6A	LG	LSN363HLV3	WALL MOUNTED - DUCTLESS	BLDG 1 - MAIN ELEC RM	R410A	1,095 / 883 / 742 / 601	33	35.7	50	HP 1-6A	LSU363HLV3	19	7.9	208-230/1/60	23	30	160	1-9
AC 1-6B	LG	LSN363HLV3	WALL MOUNTED - DUCTLESS	BLDG 1 - MAIN ELEC RM	R410A	1,095 / 883 / 742 / 601	33	35.7	50	HP 1-6B	LSU363HLV3	19	7.9	208-230/1/60	23	30	160	1-9
AC 1-7	LG	LSN243HLV3	WALL MOUNTED - DUCTLESS	BLDG 2 - ROOM 1243	R410A	813 / 601 / 495 / 389	22	26	36	HP 2-7	LSU243HLV3	22	9.5	208-230/1/60	19	30	135	1-9
AC 2-4	LG	LSN363HLV3	WALL MOUNTED - DUCTLESS	BLDG 2 - EMER ELEC RM	R410A	1,095 / 883 / 742 / 602	33	35.7	50	HP 2-4	LSU363HLV3	19	7.9	208-230/1/61	23	30	160	1-9
AC 2-5	LG	LSN120HSV5	WALL MOUNTED - DUCTLESS	BLDG 2 - FC CENTER	R410A	459 / 338 / 317 / 194	12	13	25	HP 2-5	LSU120HSV5	22	10	208-230/1/60	10	15	80	1-9
AC 2-6A	LG	LSN363HLV3	WALL MOUNTED - DUCTLESS	BLDG 2 - MAIN ELEC RM	R410A	1,095 / 883 / 742 / 603	33	35.7	50	HP 2-6A	LSU363HLV3	19	7.9	208-230/1/62	23	30	160	1-9
AC 2-6B	LG	LSN363HLV3	WALL MOUNTED - DUCTLESS	BLDG 2 - MAIN ELEC RM	R410A	1,095 / 883 / 742 / 604	33	35.7	50	HP 2-6B	LSU363HLV3	19	7.9	208-230/1/63		30	160	1-9
AC 2-7	L FG	LSN363HLV3	WALL MOUNTED - DUCTLESS	BLDG 2 - TELE / DEMARC	R410A	1,095 / 883 / 742 / 604	33	35.7	50	HP 2-7	LSU363HLV3	19	7.9	208-230/1/63	23	30	160	1-9

1. PROVIDE ELECTRICAL DISCONNECT SWITCH - INDOOR AND OUTDOOR UNITS. INDOOR UNIT IS POWERED BY OUTDOOR UNIT.

2. PROVIDE ALL INTERCONNECTING CONTROL WIRE, REFRIGRERANT PIPING, BETWEEN INDOOR AND OUTDOOR UNITS.

3. PROVIDE INDOOR UNIT WITH WALL MOUNTED TEMPERATURE CONTROLS. PROVIDE TAMPERPROOF ENCLOSURES FOR ALL THERMOSTATS LOCATED IN HIGH TRAFFIC AREAS PRONE TO DAMAGE AND TAMPERING.

4. PROVIDE LOW AMBIENT COOLING KITS.

5. PROVIDE EQUIPMENT SUPPORTS PER OUTDOOR UNIT. REFER EQUIPMENT SUPPORT DETAIL.


6. PROVIDE WASHABLE FILTERS.

7. PROVIDE BUILT IN DRAIN PAN LEVEL SENSOR, INSTALL STAINLESS STEEL SECONDARY DRAIN PAN WITH FLOAT SWITCH UNDER AND ANY UNITS POSITIONED OVER ELECTRICAL EQUIPMENT. FLOAT SWITCH TO SHUT DOWN UNIT AND ALARM BMS UPON WATER DETECTION.


8. PROVIDE FACTORY MOUNTED BACNET CONTROLLERS PER UNIT. ALL UNITS SHALL BE TIED INTO THE BUILDING MANAGEMENT SYSTEM.

9. PROVIDE BUILT-IN CONDENSATE PUMP

H2M Associates, Inc. 119 Cherry Hill Road, Suite 110 Parsippany, NJ 07054 862.207.5900 • www.h2m.com NJ Landscape Architecture Certificate No.: 21MH00010300 NJ Engineering Certificate of Authorization No.: 24GA28019100

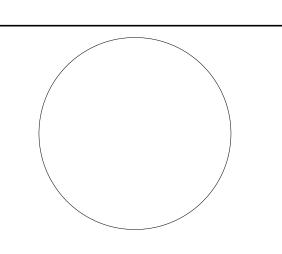

JOHN CHRIS MORRIS III, P.E. JSK/DKR DKR JSK PROJECT No: SCALE: 11/08/2023 AS SHOWN **DIGA2301**

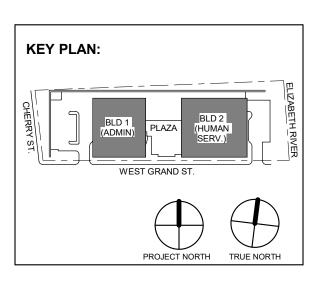


12.22.2023 Addendum No. 4 12.15.2023 Addendum No. 3 12.08.2023 Addendum No. 2 11.08.2023 For Public Bid No. Date Description

ARCHITECTURE FOR CHANGI 15 Bethany Street • New Brunswick, NJ 08901 • T: 732.249.6242 2450 W Hunting Park Ave • Philadelphia, PA 19122 • T: 215.634.3400

Jeffrey D. Venezia, AIA NJ RA AI 00827100

Revisions / Issues

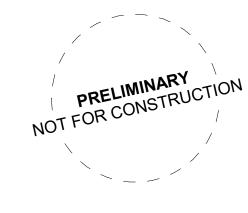

DO NOT SCALE. DRAWING MAY BE PRINTED AT REDUCED SCALE. CONSULT WITH ARCHITECT FOR DIMENSIONS.

UNION COUNTY IMPROVEMENT **AUTHORITY**

UNION COUNTY GOVERNMENT COMPLEX 81 & 93 WEST GRAND STREET CITY OF ELIZABETH NEW JERSEY, 07202 Drawing Information: Project No: 20.072

Drawn By: JB/AV/PC Checked By: JM/SH BUILDING NO. 1&2 -MECHANICAL SCHEDULES (2 OF

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SYMBOL			CFM			HO ⁻	Γ WATER (COIL			CONTROL POWER	BASIS C	OF DESIGN	
(BLDG-FLR-#)	RTU	COOL MAX	COOLING/HEATING	HEAT MAX	MIN NET CAP	EAT	LAT	GPM	EWT	LWT	V/PH/HZ	MNF	MODEL NUMBER	NOTI
		CFM	(33% MAX) CFM	(50% MAX) CFM	MBH	DEG F	DEG F		DEG F	DEG F			INUIVIDEN	
VAV 1-0-1	1-1	340	115	170	7.4	55	95	0.49	150	120	120/1/60	PRICE	SDV-6	1-5
VAV 1-0-2	1-1	480	160	240	10.4	55	95	0.69	150	120	120/1/60	PRICE	SDV-8	1-5
VAV 1-0-3	1-1	1,120	375	560	24.3	55	95	1.62	150	120	120/1/60	PRICE	SDV- 12	1-5
VAV 1-1-1	1-1	1,005	335	505	21.9	55	95	1.46	150	120	120/1/60	PRICE	SDV- 12	1-
VAV 1-1-2	1-1	570	190	285	12.4	55	95	0.82	150	120	120/1/60	PRICE	SDV-8	1-5
VAV 1-1-3	1-1	870	290	435	18.9	55	95	1.26	150	120	120/1/60	PRICE	SDV- 10	1-5
VAV 1-1-4	1-1	500	165	250	10.9	55	95	0.72	150	120	120/1/60	PRICE	SDV-6	1-4
VAV 1-1-5	1-1	930	310	465	20.2	55	95	1.35	150	120	120/1/60	PRICE	SDV- 10	1-
VAV 1-1-6	1-1	1,800	600	900	39.1	55	95	2.60	150	120	120/1/60	PRICE	SDV- 14	1-
VAV 1-1-7	1-1	930	310	465	20.2	55	95	1.35	150	120	120/1/60	PRICE	SDV- 10	1-
VAV 1-1-8	1-1	1,800	600	900	39.1	55	95	2.60	150	120	120/1/60	PRICE	SDV- 14	1-
VAV 1-1-9	1-1	500	165	250	10.9	55	95	0.72	150	120	120/1/60	PRICE	SDV-6	1-
VAV 1-2-1	~1-5~	√√514 ~~	mother the	~~~3 <u>55</u> ~~~	11:1m	<u>√55</u> ~	₩.	0.74	150	120	120/1/60	PRICE	2005E	نكسر
VAV 1-2-2	1-2	256	85	130	5.6	55	95	0.38	150	120	120/1/60	PRICE	SDV-6	1-
VAV 1-2-3	1-2	233	80	115	5.0	55	95	0.33	150	120	120/1/60	PRICE	SDV-6	1-
VAV 1-2-3A	1-2	125	40	60	2.8	55	95	0.19	150	120	120/1/60	PRICE	SDV-6	1-
VAV 1-2-3B	1-2	125	40	60	2.8	55	95	0.19	150	120	120/1/60	PRICE	SDV-6	1-
VAV 1-2-3C	1-2	125	40	60	2.8	55	95	0.19	150	120	120/1/60	PRICE	SDV-6	1-
VAV 1-2-4	1-2	280	95	140	6.1	55	95	0.41	150	120	120/1/60	PRICE	SDV-6	1-
VAV 1-2-5	1-2	280	95	140	6.1	55	95	0.41	150	120	120/1/60	PRICE	SDV-6	1-
VAV 1-2-6	1-2	1104	370	550	23.9	55	95	1.59	150	120	120/1/60	PRICE	SDV-12	1-
VAV 1-2-7	1-2	339	115	170	7.4	55	95	0.49	150	120	120/1/60	PRICE	SDV-6	1-
VAV 1-2-8	1-2	140	45	70	3.0	55	95	0.20	150	120	120/1/60	PRICE	SDV-6	1-
VAV 1-2-8A	1-2	128	45	65	2.8	55	95	0.19	150	120	120/1/60	PRICE	SDV-6	1-
VAV 1-2-9	1-2	315	105	160	6.9	55	95	0.46	150	120	120/1/60	PRICE	SDV-6	1-
VAV 1-2-10	1-2	1110	370	555	24.1	55	95	1.61	150	120	120/1/60	PRICE	SDV-12	1-
VAV 1-2-11	1-2	707	235	355	15.4	55	95	1.03	150	120	120/1/60	PRICE	SDV- 10	1-
VAV 1-2-12	1-2	646	215	325	14.1	55	95	0.94	150	120	120/1/60	PRICE	SDV- 10	1-
VAV 1-2-13	1-2	140	45	70	3.0	55	95	0.20	150	120	120/1/60	PRICE	SDV-6	1-
VAV 1-2-14	1-2	140	45	70	3.0	55	95	0.20	150	120	120/1/60	PRICE	SDV-6	1-
VAV 1-2-15	1-2	895	300	450	19.5	55	95	1.30	150	120	120/1/60	PRICE	SDV-10	1-
VAV 1-2-16	1-2	1710	570	855	37.1	55	95	2.47	150	120	120/1/60	PRICE	SDV-14	1-
VAV 1-2-17	1-2	250	85	125	5.4	55	95	0.36	150	120	120/1/60	PRICE	SDV-6	1-
VAV 1-2-18	1-2	1250	415	625	27.1	55	95	1.81	150	120	120/1/60	PRICE	SDV-14	1-
VAV 1-2-19	1-2	1250	415	625	27.1	55	95	1.81	150	120	120/1/60	PRICE	SDV-14	1-
VAV 1-2-20	1-2	1250	415	625	27.1	55	95	1.81	150	120	120/1/60	PRICE	SDV-14	1-
VAV 1-2-21	1-2	1250	415	625	27.1	55	95	1.81	150	120	120/1/60	PRICE	SDV-14	1-
VAV 1-2-22	1-2	895	300	450	19.5	55	95	1.30	150	120	120/1/60	PRICE	SDV- 10	1-
VAV 1-2-23	1-2	1358	450	680	29.5	55	95	1.97	150	120	120/1/60	PRICE	SDV-14	1-

Maren PROVIDE ALL VAV BOXES W/ CONTROLS TRANSFORMER. DDC CONTROL VIA EXISTING BMS. INTERLOCK WITH OPERATION OF EXISTING ROOFTOP UNIT.

- ELECTRICAL CONTRACTOR TO PROVIDE DISCONNECT SWITCH
- MANUFACTURER PROVIDED SOUND ATTENUATION
- 4. 2-WAY VALVE PACKAGE, MATCH EXISTING BMS MANUFACTURER AND FACTORY INSTALL ON VAV BOX.
- 5. VERIFY COIL HANDEDNESS IN FIELD

VARIABLE	VARIABLE AIR VOLUME (VAV) TERMINAL UNIT SCHEDULE													
SYMBOL			CFM			HO	T WATER	COIL			CONTROL POWER	BASIS C)F DESIGN	
(DLDC FLD #)	RTU	COOL MAX	COOLING/HEATING	HEAT MAX	MIN NET CAP	EAT	LAT	CDM	EWT	LWT	\//DU//UZ	D 4 D 1 E	MODEL	NOTES
(BLDG-FLR-#)		CFM	(33% MAX) CFM	(50% MAX) CFM	МВН	DEG F	DEG F	GPM	DEG F	DEG F	V/PH/HZ	MNF	NUMBER	
VAV 1-3-1	1-3	814	270	405	17.58	55	95	1.17	150	120	120/1/60	PRICE	SDV- 10	1-5
VAV 1-3-2	1-3	253	85	125	5.43	55	95	0.36	150	120	120/1/60	PRICE	SDV-6	1-5
VAV 1-3-3	1-3	475	160	240	10.42	55	95	0.69	150	120	120/1/60	PRICE	SDV-8	1-5
VAV 1-3-4	1-3	475	160	240	10.42	55	95	0.69	150	120	120/1/60	PRICE	SDV-8	1-5
VAV 1-3-5	1-3	475	160	240	10.42	55	95	0.69	150	120	120/1/60	PRICE	SDV-8	1-5
VAV 1-3-6	1-3	610	205	305	13.24	55	95	0.88	150	120	120/1/60	PRICE	SDV- 10	1-5
VAV 1-3-7	1-3	475	160	240	10.42	55	95	0.69	150	120	120/1/60	PRICE	SDV-8	1-5
VAV 1-3-8	1-3	1320	440	660	28.64	55	95	1.91	150	120	120/1/60	PRICE	SDV- 14	1-5
VAV 1-3-9	1-3	475	160	240	10.42	55	95	0.69	150	120	120/1/60	PRICE	SDV-8	1-5
VAV 1-3-10	1-3	714	240	355	15.41	55	95	1.03	150	120	120/1/60	PRICE	SDV- 10	1-5
VAV 1-3-11	1-3	817	270	410	17.79	55	95	1.19	150	120	120/1/60	PRICE	SDV- 10	1-5
VAV 1-3-12	1-3	630	210	315	13.67	55	95	0.91	150	120	120/1/60	PRICE	SDV- 10	1-5
VAV 1-3-13	1-3	789	265	395	17.14	55	95	1.14	150	120	120/1/60	PRICE	SDV- 10	1-5
VAV 1-3-14	1-3	720	240	360	15.62	55	95	1.04	150	120	120/1/60	PRICE	SDV- 10	1-5
VAV 1-3-15	1-3	930	310	465	20.18	55	95	1.35	150	120	120/1/60	PRICE	SDV- 10	1-5
VAV 1-3-16	1-3	2040	680	1020	44.27	55	95	2.95	150	120	120/1/60	PRICE	SDV- 16	1-5
VAV 1-3-17	1-3	915	305	460	19.96	55	95	1.33	150	120	120/1/60	PRICE	SDV- 10	1-5
VAV 1-3-18	1-3	680	225	340	14.76	55	95	0.98	150	120	120/1/60	PRICE	SDV- 10	1-5
VAV 1-3-19	1-3	574	190	285	12.37	55	95	0.82	150	120	120/1/60	PRICE	SDV-8	1-5
VAV 1-3-20	1-3	342	115	170	7.38	55	95	0.49	150	120	120/1/60	PRICE	SDV-6	1-5
VAV 1-3-21	1-3	336	110	170	7.38	55	95	0.49	150	120	120/1/60	PRICE	SDV-6	1-5
VAV 1-3-22	1-3	172	55	85	3.69	55	95	0.25	150	120	120/1/60	PRICE	SDV-6	1-5
VAV 1-3-23	1-3	631	210	315	13.67	55	95	0.91	150	120	120/1/60	PRICE	SDV- 10	1-5
VAV 1-3-24	1-3	165	55	85	3.69	55	95	0.25	150	120	120/1/60	PRICE	SDV-6	1-5
VAV 1-3-25	1-3	915	305	460	19.96	55	95	1.33	150	120	120/1/60	PRICE	SDV- 10	1-5
VAV 1-3-26	1-3	447	150	225	9.77	55	95	0.65	150	120	120/1/60	PRICE	SDV-8	1-5
VAV 1-3-27	1-3	320	105	160	6.94	55	95	0.46	150	120	120/1/60	PRICE	SDV-6	1-5

- PROVIDE ALL VAV BOXES W/ CONTROLS TRANSFORMER. DDC CONTROL VIA EXISTING BMS. INTERLOCK WITH OPERATION OF EXISTING ROOFTOP UNIT.
- ELECTRICAL CONTRACTOR TO PROVIDE DISCONNECT SWITCH MANUFACTURER PROVIDED SOUND ATTENUATION
- 4. 2-WAY VALVE PACKAGE, MATCH EXISTING BMS MANUFACTURER AND FACTORY INSTALL ON VAV BOX.
- 5. VERIFY COIL HANDEDNESS IN FIELD

RTU COOL MAX COOLING/HEATING HEAT MAX MIN NET CAP EAT LAT CFM GSM CFM (33% MAX) CFM (50% MAX) CFM MBH DEG F DEG	F MODEL NUMBER	NOTES
VAV 1-4-1	NUMBER	
VAV 1-4-2		l
VAV 1-4-2A	E SDV- 6	1-5
VAV 14-3	E SDV- 10	1-5
VAV 14-4	E SDV- 6	1-5
VAV 1-4-5	E SDV- 6	1-5
VAV 1-4-6	E SDV- 6	1-5
VAV 1-4-7	E SDV- 6	1-5
VAV 1-4-8 1-4 970 325 485 21.0 55 95 1.40 150 120 120/1/60 PRIC VAV 1-4-9 1-4 467 155 235 10.2 55 95 0.68 150 120 120/1/60 PRIC VAV 1-4-9A 1-4 256 85 130 5.6 55 95 0.88 150 120 120/1/60 PRIC VAV 1-4-10 1-4 467 155 235 10.2 55 95 0.88 150 120 120/1/60 PRIC VAV 1-4-10A 1-4 467 155 235 10.2 55 95 0.88 150 120 120/1/60 PRIC VAV 1-4-11 1-4 467 155 235 10.2 55 95 0.88 150 120 120/1/60 PRIC VAV 1-4-13 1-4 466 695 30.2 55 95 0.08 150	E SDV-8	1-5
VAV 1-4-9 1.4 467 155 235 10.2 55 95 0.68 150 120 120/1/60 PRIC VAV 1-4-9A 1.4 256 85 130 5.6 55 95 0.38 150 120 120/1/60 PRIC VAV 1-4-10 1.4 467 155 235 10.2 55 95 0.68 150 120 120/1/60 PRIC VAV 1-4-10A 1.4 256 85 130 5.6 55 95 0.68 150 120 120/1/60 PRIC VAV 1-4-11 1.4 467 155 235 10.2 55 95 0.68 150 120 120/1/60 PRIC VAV 1-4-12 1.4 1390 465 695 30.2 55 95 0.68 150 120 120/1/60 PRIC VAV 1-4-13 1.4 680 225 340 14.8 55 95 0.98	E SDV- 6	1-5
VAV 1-4-9A 1-4 256 85 130 5.6 55 95 0.38 150 120 120/1/60 PRIC VAV 1-4-10 1-4 467 155 235 10.2 55 95 0.68 150 120 120/1/60 PRIC VAV 1-4-10A 1-4 256 85 130 5.6 55 95 0.68 150 120 120/1/60 PRIC VAV 1-4-11 1-4 467 155 235 10.2 55 95 0.68 150 120 120/1/60 PRIC VAV 1-4-12 1-4 1,390 465 695 30.2 55 95 0.68 150 120 120/1/60 PRIC VAV 1-4-13 1-4 680 225 340 14.8 55 95 0.98 150 120 120/1/60 PRIC VAV 1-4-14 1-4 760 255 380 16.5 55 95 1.10 <t< td=""><td>E SDV- 12</td><td>1-5</td></t<>	E SDV- 12	1-5
VAV 14-10 1-4 467 155 235 10.2 55 95 0.68 150 120 120/1/60 PRIC VAV 1-4-10A 1-4 256 85 130 5.6 55 95 0.38 150 120 120/1/60 PRIC VAV 1-4-11 1-4 467 155 235 10.2 55 95 0.68 150 120 120/1/60 PRIC VAV 1-4-12 1-4 1,390 465 695 30.2 55 95 0.98 150 120 120/1/60 PRIC VAV 1-4-13 1-4 680 225 340 14.8 55 95 0.98 150 120 120/1/60 PRIC VAV 1-4-14 1-4 760 255 380 16.5 55 95 1.10 150 120 120/1/60 PRIC VAV 1-4-16 1-4 480 160 240 10.7 55 95 0.69 <	E SDV-8	1-5
VAV 1-4-10A 1-4 256 85 130 5.6 55 95 0.38 150 120 120/1/60 PRIC VAV 1-4-11 1-4 467 155 235 10.2 55 95 0.68 150 120 120/1/60 PRIC VAV 1-4-12 1-4 1,390 465 695 30.2 55 95 2.01 150 120 120/1/60 PRIC VAV 1-4-13 1-4 680 225 340 14.8 55 95 0.98 150 120 120/1/60 PRIC VAV 1-4-14 1-4 760 255 380 16.5 55 95 1.10 150 120 120/1/60 PRIC VAV 1-4-15 1-4 951 315 475 20.6 55 95 1.37 150 120 120/1/60 PRIC VAV 1-4-16 1-4 480 160 240 10.7 55 95 0.69	E SDV-6	1-5
VAV 1-4-11 1-4 467 155 235 10.2 55 95 0.68 150 120 120/1/60 PRIC VAV 1-4-12 1-4 1,390 465 695 30.2 55 95 2.01 150 120 120/1/60 PRIC VAV 1-4-13 1-4 680 225 340 14.8 55 95 0.98 150 120 120/1/60 PRIC VAV 1-4-14 1-4 760 255 380 16.5 55 95 1.10 150 120 120/1/60 PRIC VAV 1-4-15 1-4 951 315 475 20.6 55 95 1.37 150 120 120/1/60 PRIC VAV 1-4-16 1-4 480 160 240 10.7 55 95 0.69 150 120 120/1/60 PRIC VAV 1-4-16A 1-4 480 160 240 10.7 55 95 0.69	E SDV-8	1-5
VAV 1-4-12 1-4 1,390 465 695 30.2 55 95 2.01 150 120 120/1/60 PRIC VAV 1-4-13 1-4 680 225 340 14.8 55 95 0.98 150 120 120/1/60 PRIC VAV 1-4-14 1-4 760 255 380 16.5 55 95 1.10 150 120 120/1/60 PRIC VAV 1-4-15 1-4 951 315 475 20.6 55 95 1.37 150 120 120/1/60 PRIC VAV 1-4-16 1-4 480 160 240 10.7 55 95 0.69 150 120 120/1/60 PRIC VAV 1-4-16A 1-4 480 160 240 10.7 55 95 0.69 150 120 120/1/60 PRIC VAV 1-4-16A 1-4 520 175 260 11.3 55 95 0.75	E SDV-6	1-5
VAV 1-4-13 1-4 680 225 340 14.8 55 95 0.98 150 120 120/1/60 PRIC VAV 1-4-14 1-4 760 255 380 16.5 55 95 1.10 150 120 120/1/60 PRIC VAV 1-4-15 1-4 951 315 475 20.6 55 95 1.37 150 120 120/1/60 PRIC VAV 1-4-16 1-4 480 160 240 10.7 55 95 0.69 150 120 120/1/60 PRIC VAV 1-4-16A 1-4 520 175 260 11.3 55 95 0.75 150 120 120/1/60 PRIC VAV 1-4-16B 1-4 260 85 130 5.6 55 95 0.75 150 120 120/1/60 PRIC VAV 1-4-16B 1-4 260 85 130 5.6 55 95 0.38 <t< td=""><td>E SDV-8</td><td>1-5</td></t<>	E SDV-8	1-5
VAV 1-4-14 1-4 760 255 380 16.5 55 95 1.10 150 120 120/1/60 PRIO VAV 1-4-15 1-4 951 315 475 20.6 55 95 1.37 150 120 120/1/60 PRIO VAV 1-4-16 1-4 480 160 240 10.7 55 95 0.69 150 120 120/1/60 PRIO VAV 1-4-16A 1-4 520 175 260 11.3 55 95 0.75 150 120 120/1/60 PRIO VAV 1-4-16B 1-4 260 85 130 5.6 55 95 0.38 150 120 120/1/60 PRIO VAV 1-4-17 1-4 666 220 335 14.5 55 95 0.78 150 120 120/1/60 PRIO VAV 1-4-18 1-4 540 180 270 11.7 55 95 0.78 <	E SDV- 14	1-5
VAV 1-4-15 1-4 951 315 475 20.6 55 95 1.37 150 120 120/1/60 PRIO VAV 1-4-16 1-4 480 160 240 10.7 55 95 0.69 150 120 120/1/60 PRIO VAV 1-4-16A 1-4 520 175 260 11.3 55 95 0.75 150 120 120/1/60 PRIO VAV 1-4-16B 1-4 260 85 130 5.6 55 95 0.38 150 120 120/1/60 PRIO VAV 1-4-17 1-4 666 220 335 14.5 55 95 0.38 150 120 120/1/60 PRIO VAV 1-4-18 1-4 540 180 270 11.7 55 95 0.78 150 120 120/1/60 PRIO VAV 1-4-18A 1-4 360 120 180 7.8 55 95 0.52 <	E SDV- 10	1-5
VAV 1-4-16 1-4 480 160 240 10.7 55 95 0.69 150 120 120/1/60 PRIO VAV 1-4-16A 1-4 520 175 260 11.3 55 95 0.75 150 120 120/1/60 PRIO VAV 1-4-16B 1-4 260 85 130 5.6 55 95 0.38 150 120 120/1/60 PRIO VAV 1-4-17 1-4 666 220 335 14.5 55 95 0.97 150 120 120/1/60 PRIO VAV 1-4-18 1-4 540 180 270 11.7 55 95 0.78 150 120 120/1/60 PRIO VAV 1-4-18A 1-4 360 120 180 7.8 55 95 0.52 150 120 120/1/60 PRIO VAV 1-4-19 1-4 996 330 500 21.7 55 95 0.68 <	E SDV- 10	1-5
VAV 1-4-16A 1-4 520 175 260 11.3 55 95 0.75 150 120 120/1/60 PRIOR DESTRICT VAV 1-4-16B 1-4 260 85 130 5.6 55 95 0.38 150 120 120/1/60 PRIOR DESTRICT VAV 1-4-17 1-4 666 220 335 14.5 55 95 0.97 150 120 120/1/60 PRIOR DESTRICT VAV 1-4-18 1-4 540 180 270 11.7 55 95 0.78 150 120 120/1/60 PRIOR DESTRICT VAV 1-4-18A 1-4 360 120 180 7.8 55 95 0.52 150 120 120/1/60 PRIOR DESTRICT VAV 1-4-19 1-4 996 330 500 21.7 55 95 0.68 150 120 120/1/60 PRIOR DESTRICT VAV 1-4-20 1-4 467 155 235 10.2 <td< td=""><td>E SDV- 12</td><td>1-5</td></td<>	E SDV- 12	1-5
VAV 1-4-16B 1-4 260 85 130 5.6 55 95 0.38 150 120 120/1/60 PRIOR DESCRIPTION VAV 1-4-17 1-4 666 220 335 14.5 55 95 0.97 150 120 120/1/60 PRIOR DESCRIPTION VAV 1-4-18 1-4 540 180 270 11.7 55 95 0.78 150 120 120/1/60 PRIOR DESCRIPTION VAV 1-4-18A 1-4 360 120 180 7.8 55 95 0.52 150 120 120/1/60 PRIOR DESCRIPTION VAV 1-4-19 1-4 996 330 500 21.7 55 95 1.45 150 120 120/1/60 PRIOR DESCRIPTION VAV 1-4-20 1-4 467 155 235 10.2 55 95 0.68 150 120 120/1/60 PRIOR DESCRIPTION VAV 1-4-20A 1-4 256 85 130 5.6<	E SDV-8	1-5
VAV 1-4-17 1-4 666 220 335 14.5 55 95 0.97 150 120 120/1/60 PRIO VAV 1-4-18 1-4 540 180 270 11.7 55 95 0.78 150 120 120/1/60 PRIO VAV 1-4-18A 1-4 360 120 180 7.8 55 95 0.52 150 120 120/1/60 PRIO VAV 1-4-19 1-4 996 330 500 21.7 55 95 1.45 150 120 120/1/60 PRIO VAV 1-4-20 1-4 467 155 235 10.2 55 95 0.38 150 120 120/1/60 PRIO VAV 1-4-20A 1-4 256 85 130 5.6 55 95 0.38 150 120 120/1/60 PRIO	E SDV-8	1-5
VAV 1-4-18 1-4 540 180 270 11.7 55 95 0.78 150 120 120/1/60 PRIO VAV 1-4-18A 1-4 360 120 180 7.8 55 95 0.52 150 120 120/1/60 PRIO VAV 1-4-19 1-4 996 330 500 21.7 55 95 1.45 150 120 120/1/60 PRIO VAV 1-4-20 1-4 467 155 235 10.2 55 95 0.68 150 120 120/1/60 PRIO VAV 1-4-20A 1-4 256 85 130 5.6 55 95 0.38 150 120 120/1/60 PRIO	E SDV- 6	1-5
VAV 1-4-18A 1-4 360 120 180 7.8 55 95 0.52 150 120 120/1/60 PRIO VAV 1-4-19 1-4 996 330 500 21.7 55 95 1.45 150 120 120/1/60 PRIO VAV 1-4-20 1-4 467 155 235 10.2 55 95 0.68 150 120 120/1/60 PRIO VAV 1-4-20A 1-4 256 85 130 5.6 55 95 0.38 150 120 120/1/60 PRIO	E SDV- 10	1-5
VAV 1-4-19 1-4 996 330 500 21.7 55 95 1.45 150 120 120/1/60 PRIO VAV 1-4-20 1-4 467 155 235 10.2 55 95 0.68 150 120 120/1/60 PRIO VAV 1-4-20A 1-4 256 85 130 5.6 55 95 0.38 150 120 120/1/60 PRIO	E SDV-8	1-5
VAV 1-4-20 1-4 467 155 235 10.2 55 95 0.68 150 120 120/1/60 PRIO VAV 1-4-20A 1-4 256 85 130 5.6 55 95 0.38 150 120 120/1/60 PRIO	E SDV-8	
VAV 1-4-20A 1-4 256 85 130 5.6 55 95 0.38 150 120 120/1/60 PRIC	E SDV- 12	1-5
	E SDV-8	1-5
VAV 1-4-21 1-4 540 180 270 11.7 55 95 0.78 150 120 120/1/60 PRIC	E SDV-6	1-5
	E SDV-8	1-5
VAV 1-4-21A 1-4 360 120 180 7.8 55 95 0.52 150 120 120/1/60 PRIC	E SDV-8	1-5
VAV 1-4-22	E SDV- 6	1-5
VAV 1-4-23 1-4 456 150 230 10.0 55 95 0.67 150 120 120/1/60 PRIC	E SDV-8	1-5
VAV 1-4-24 1-4 173 55 85 3.7 55 95 0.25 150 120 120/1/60 PRIC	E SDV- 6	1-5
VAV 1-4-25	E SDV- 10	1-5
VAV 1-4-26	E SDV-8	1-5

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- PROVIDE ALL VAV BOXES W/ CONTROLS TRANSFORMER. DDC CONTROL VIA EXISTING BMS. INTERLOCK WITH OPERATION OF EXISTING ROOFTOP UNIT. ELECTRICAL CONTRACTOR TO PROVIDE DISCONNECT SWITCH
- MANUFACTURER PROVIDED SOUND ATTENUATION
- 2-WAY VALVE PACKAGE, MATCH EXISTING BMS MANUFACTURER AND FACTORY INSTALL ON VAV BOX. 5. VERIFY COIL HANDEDNESS IN FIELD

V	ARIABLE AIR VOLUME	(VAV)	TERMINAL	UNIT S	CHEDULE


SYMBOL			CFM			НО	T WATER	COIL			CONTROL POWER	BASIS C	F DESIGN	
(BLDG-FLR-#)	RTU	COOL MAX	COOLING/HEATING	HEAT MAX	MIN NET CAP	EAT	LAT	GPM	EWT	LWT	V/PH/HZ	MNF	MODEL	NOTES
(=== = : ::,		CFM	(33% MAX) CFM	(50% MAX) CFM	МВН	DEG F	DEG F		DEG F	DEG F	.,,		NUMBER	
VAV 1-5-1	1-5	952	315	475	20.62	55	95	1.37	150	120	120/1/60	PRICE	SDV 12	1-5
VAV 1-5-2	1-5	130	45	65	2.82	55	95	0.19	150	120	120/1/60	PRICE	SDV 6	1-5
VAV 1-5-3	1-5	859	285	430	18.66	55	95	1.24	150	120	120/1/60	PRICE	SDV 10	1-5
VAV 1-5-4	1-5	859	285	430	18.66	55	95	1.24	150	120	120/1/60	PRICE	SDV 10	1-5
VAV 1-5-5	1-5	251	85	125	5.43	55	95	0.36	150	120	120/1/60	PRICE	SDV 6	1-5
VAV 1-5-6	1-5	263	90	130	5.64	55	95	0.38	150	120	120/1/60	PRICE	SDV 6	1-5
VAV 1-5-7	1-5	464	155	230	9.98	55	95	0.67	150	120	120/1/60	PRICE	SDV 8	1-5
VAV 1-5-8	1-5	435	145	220	9.55	55	95	0.64	150	120	120/1/60	PRICE	SDV 8	1-5
VAV 1-5-9	1-5	859	285	430	18.66	55	95	1.24	150	120	120/1/60	PRICE	SDV 10	1-5
VAV 1-5-10	1-5	485	160	245	10.63	55	95	0.71	150	120	120/1/60	PRICE	SDV 8	1-5
VAV 1-5-11	1-5	859	285	430	18.66	55	95	1.24	150	120	120/1/60	PRICE	SDV 10	1-5
VAV 1-5-12	1-5	859	285	430	18.66	55	95	1.24	150	120	120/1/60	PRICE	SDV 10	1-5
VAV 1-5-13	1.5	~~ ⁸⁵⁹ ~~	~~~285~~~	430	18,66	~55~	95~	124	150	~120~	120/1/60	PRICE	SDV 10	1-5
VAV 1-5-14	1-5	320	105	160	6.94	55	95	0.46	150	120	120/1/60	PRICE	SDV-6	1-5
VAV 1-5-14A	1-5	300	100	150	6.5	55	95	0.43	150	120	120/1/60	PRICE	SDV-6	1-5
MANY 5451	~ <u>45</u> 4	Mess	mogsm.	mays m	Meer	Mgg	MEN	رويريه	4394	1201	120/4/60	YPRICEY	\\$D\10~	Cherry 1
VAV 1-5-16	1-5	500	165	250	10.85	55	95	0.72	150	120	120/1/60	PRICE	SDV 8	1-5
VAV 1-5-17	1-5	500	165	250	10.85	55	95	0.72	150	120	120/1/60	PRICE	SDV 8	1-5
VAV 1-5-18	1-5	458	155	230	9.98	55	95	0.67	150	120	120/1/60	PRICE	SDV 8	1-5
VAV 1-5-19	1-5	500	165	250	10.85	55	95	0.72	150	120	120/1/60	PRICE	SDV 8	1-5
VAV 1-5-20	1-5	548	180	275	11.94	55	95	0.80	150	120	120/1/60	PRICE	SDV 8	1-5
VAV 1-5-21	1-5	328	110	165	7.16	55	95	0.48	150	120	120/1/60	PRICE	SDV 6	1-5
VAV 1-5-22	1-5	274	90	135	5.86	55	95	0.39	150	120	120/1/60	PRICE	SDV 6	1-5
VAV 1-5-23	1-5	975	325	490	21.27	55	95	1.42	150	120	120/1/60	PRICE	SDV 12	1-5
VAV 1-5-24	1-5	1076	360	540	23.44	55	95	1.56	150	120	120/1/60	PRICE	SDV 12	1-5
VAV 1-5-25	1-5	726	240	365	15.84	55	95	1.06	150	120	120/1/60	PRICE	SDV 10	1-5
VAV 1-5-26	1-5	173	60	85	3.69	55	95	0.25	150	120	120/1/60	PRICE	SDV 6	1-5
VAV 1-5-27	1-5	800	265	400	17.36	55	95	1.16	150	120	120/1/60	PRICE	SDV 10	1-5
VAV 1-5-28	1-5	485	160	245	10.63	55	95	0.71	150	120	120/1/60	PRICE	SDV 8	1-5
VAV 1-5-29	1-5	355	120	180	7.81	55	95	0.52	150	120	120/1/60	PRICE	SDV 6	1-5
NOTEC:	1		I	I	1	1		1	1		· •	<u> </u>		

- 1. PROVIDE ALL VAV BOXES W/ CONTROLS TRANSFORMER. DDC CONTROL VIA EXISTING BMS. INTERLOCK WITH OPERATION OF EXISTING ROOFTOP UNIT.
- 2. ELECTRICAL CONTRACTOR TO PROVIDE DISCONNECT SWITCH MANUFACTURER PROVIDED SOUND ATTENUATION
- . 2-WAY VALVE PACKAGE, MATCH EXISTING BMS MANUFACTURER AND FACTORY INSTALL ON VAV BOX.
- 5. VERIFY COIL HANDEDNESS IN FIELD

Н	2	architect + engineer
	V	<u> </u>

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H2M Associates, Inc. 119 Cherry Hill Road, Suite 110

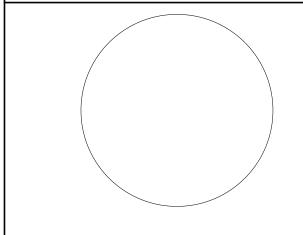


JOHN CHRIS MORRIS III, P.E.
NJ PROFESSIONAL ENGINEER LIC. No. GE02659900

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DESIGNED BY: DRAWN BY: CHECKED BY: REVIEWED BY:

JSK/DKR DKR JSK JCM PROJECT No: DATE: SCALE: AS SHOWN

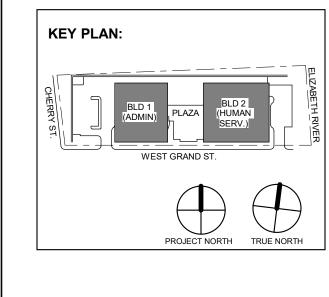


12.22.2023 Addendum No. 4 12.15.2023 Addendum No. 3 12.08.2023 Addendum No. 2 11.08.2023 For Public Bid No. Date Description

Revisions / Issues

15 Bethany Street • New Brunswick, NJ 08901 • T: 732.249.6242 2450 W Hunting Park Ave • Philadelphia, PA 19122 • T: 215.634.3400

ARCHITECTURE FOR CHANGI

Jeffrey D. Venezia, AIA NJ RA AI 00827100

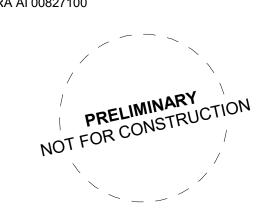

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UNION COUNTY IMPROVEMENT AUTHORITY

> UNION COUNTY GOVERNMENT COMPLEX 81 & 93 WEST GRAND STREET CITY OF ELIZABETH NEW JERSEY, 07202

Drawing Information: Project No: 20.072
Date: 11.08.2023
Drawn By: JB/AV/PC
Checked By: JM/SH

Sheet Name: BUILDING NO. 1&2 -

MECHANICAL SCHEDULES (3 OF

M-403

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SYMBOL			CFM			HO.	T WATER	COIL			CONTROL POWER	BASIS C	OF DESIGN	
(BLDG-FLR- #)	RTU	COOL MAX	COOLING/HEATING	HEAT MAX	MIN NET CAP	EAT	LAT	GPM	EWT	LWT	V/PH/HZ	MNF	MODEL	NO
,		CFM	(33% MAX) CFM	(50% MAX) CFM	МВН	DEG F	DEG F		DEG F	DEG F	, ,		NUMBER	{
VAV 2-0-1	2-1	1,270	425	635	27.6	55	95	1.84	150	120	120/1/60	PRICE	SDV- 14	1-
VAV 2-0-2	2-1	685	230	345	15.0	55	95	1.00	150	120	120/1/60	PRICE	SDV- 10	1-
VAV 2-0-3	2-1	205	70	105	4.6	55	95	0.30	150	120	120/1/60	PRICE	SDV- 6	1
VAV 2-0-4	2-1	130	45	65	2.8	55	95	0.19	150	120	120/1/60	PRICE	SDV- 6	1
VAV 2-0-5	2-1	1,140	380	570	24.7	55	95	1.65	150	120	120/1/60	PRICE	SDV- 12	
VAV 2-0-6	2-1	1,115	370	560	24.3	55	95	1.62	150	120	120/1/60	PRICE	SDV- 12	
VAV 2-0-7	2-1	980	325	490	21.3	55	95	1.42	150	120	120/1/60	PRICE	SDV- 12	
VAV 2-0-8	2-1	560	185	280	12.2	55	95	0.81	150	120	120/1/60	PRICE	SDV- 8	
VAV 2-0-9	2-1	355	120	180	7.8	55	95	0.52	150	120	120/1/60	PRICE	SDV- 6	
VAV 2-0-10	2-1	615	205	310	13.5	55	95	0.90	150	120	120/1/60	PRICE	SDV- 10	
VAV 2-1-1	2-1	880	295	440	19.1	55	95	1.27	150	120	120/1/60	PRICE	SDV- 10	
VAV 2-1-2	2-1	160	55	80	3.5	55	95	0.23	150	120	120/1/60	PRICE	SDV- 6	
VAV 2-1-3	2-1	1,100	365	550	23.9	55	95	1.59	150	120	120/1/60	PRICE	SDV- 12	
VAV 2-1-4	<u>1-5</u>	\sim	~~~	450	19.5 19.5	~-55~~	195m	0.97	150	120	120/1/60	PRICE	SDV-10	~~
VAV 2-1-5	2-1	721	240	360	16	55	95	1.04	150	120	120/1/60	PRICE	SDV- 10	
VAV 2-1-6	2-1	900	300	450	19.5	55	95	0.97	150	120	120/1/60	PRICE	SDV- 10	
VAV 2-1-7	2-1	721	240	360	16	55	95	1.04	150	120	120/1/60	PRICE	SDV- 10	
VAV 2-1-8	2-1	900	300	450	19.5	55	95	0.97	150	120	120/1/60	PRICE	SDV- 10	
VAV 2-1-9	2-1	721	240	360	16	55	95	1.04	150	120	120/1/60	PRICE	SDV- 10	
VAY 2-1-10-1	سير			1	w _{s.} gw		Uggu	~ _{8.33} ~	450~	120	~420/H/60~	PRICE	SPATO	~
VAV 2-1-11	2-1	115	40	60	2.6	55	95	0.17	150	120	120/1/60	PRICE	SDV- 6	
VAV 2-1-12	2-1	115	40	60	2.6	55	95	0.17	150	120	120/1/60	PRICE	SDV- 6	
VAV 2-1-13	2-1	230	75	115	5.0	55	95	0.33	150	120	120/1/60	PRICE	SDV- 6	
VAV 2-1-14	2-1	165	55	85	3.7	55	95	0.25	150	120	120/1/60	PRICE	SDV- 6	
VAV 2-1-15	2-1	435	145	220	9.5	55	95	0.64	150	120	120/1/60	PRICE	SDV- 8	
VAV 2-1-16	2-1	690	230	345	15.0	55	95	1.00	150	120	120/1/60	PRICE	SDV- 10	
VAV 2-1-17	2-1	375	125	190	8.2	55	95	0.55	150	120	120/1/60	PRICE	SDV- 6	
VAV 2-1-18	2-1	~~ ⁴⁰⁰ ~~	~~~ ¹³⁵ ~~~	~~~200~~~	~~~~~~~~~~~~~~~~~~~~~~~~~~~~~~~~~~~~~~	~~ ⁵⁵ ~~	95~	0.58	150	120	120/1/60	PRICE	SDV-8	~~
VAV 2-1-19	2-1	650	215	530	14.1	55	95	0.94	150	120	120/1/60	PRICE	SDV- 12	
VAV2-1-20	سيهد	~~, 350~			29.3	~~~~	Lygger 1	4.95	-150-C	~120~	120/1/60	PRICE	SDV-14	\leftarrow
VAV 2-1-21	2-1	705	235	470	15.4	55	95	1.03	150	120	120/1/60	PRICE	SDV- 10	
VAV 2-1-22	2-1	1,175	355	585	25.4	55	95	1.69	150	120	120/1/60	PRICE	SDV- 14	
VAV 2-1-23	2-1	810	390	405	17.6	55	95	1.17	150	120	120/1/60	PRICE	SDV- 12	
VAV 2-1-24	2-1	1,160	270	580	25.2	55	95	1.68	150	120	120/1/60	PRICE	SDV- 14	
VAV 2-1-25	2-1	555	185	280	12	55	95	0.81	150	120	120/1/60	PRICE	SDV- 8	

1. PROVIDE ALL VAV BOXES W/ CONTROLS TRANSFORMER. DDC CONTROL VIA EXISTING BMS. INTERLOCK WITH OPERATION OF EXISTING ROOFTOP UNIT.

2. ELECTRICAL CONTRACTOR TO PROVIDE DISCONNECT SWITCH

3. MANUFACTURER PROVIDED SOUND ATTENUATION 4. 2-WAY VALVE PACKAGE, MATCH EXISTING BMS MANUFACTURER AND FACTORY INSTALL ON VAV BOX.

5. VERIFY COIL HANDEDNESS IN FIELD

1/ADIADIE A	IR VOLUME (VAV	/\ TEDRAINIAI IINI	IT CCHEDI II E
VARIADLE A	IR VULUIVIE IVAV	/) IERIVIINAL UN	II SCHEDULE

SYMBOL			CFM			HO	Γ WATER (COIL			CONTROL POWER	BASIS C	F DESIGN	
(BLDG-FLR-#)	RTU	COOL MAX	COOLING/HEATING	HEAT MAX	MIN NET CAP	EAT	LAT	GPM	EWT	LWT	V/PH/HZ	MNF	MODEL	NOTES
(5250 12.1 11)		CFM	(33% MAX) CFM	(50% MAX) CFM	МВН	DEG F	DEG F	GI IVI	DEG F	DEG F	V/111/112		NUMBER	
VAV 2-3-1	2-3	818	270	410	18	55	95	1.19	150	120	120/1/60	PRICE	SDV- 10	1-5
VAV 2-3-2	2-3	818	270	410	18	55	95	1.19	150	120	120/1/60	PRICE	SDV- 10	1-5
VAV 2-3-3	2-3	818	270	410	18	55	95	1.19	150	120	120/1/60	PRICE	SDV- 10	1-5
VAV 2-3-4	2-3	818	270	410	18	55	95	1.19	150	120	120/1/60	PRICE	SDV- 10	1-5
VAV 2-3-5	2-3	900	300	450	20	55	95	1.3	150	120	120/1/60	PRICE	SDV- 10	1-5
VAV 2-3-6	2-3	776	260	390	17	55	95	1.13	150	120	120/1/60	PRICE	SDV- 10	1-5
VAV 2-3-7	2-3	1800	600	900	39	55	95	2.6	150	120	120/1/60	PRICE	SDV- 14	1-5
VAV 2-3-8	2-3	776	260	390	17	55	95	1.13	150	120	120/1/60	PRICE	SDV- 10	1-5
VAV 2-3-9	2-3	461	155	230	10	55	95	0.67	150	120	120/1/60	PRICE	SDV- 8	1-5
VAV 2-3-10	2-3	277	90	140	6	55	95	0.41	150	120	120/1/60	PRICE	SDV- 6	1-5
VAV 2-3-11	2-3	461	155	230	10	55	95	0.67	150	120	120/1/60	PRICE	SDV- 8	1-5
VAV 2-3-12	2-3	461	155	230	10	55	95	0.67	150	120	120/1/60	PRICE	SDV- 8	1-5
VAV 2-3-13	2-3	348	115	175	8	55	95	0.51	150	120	120/1/60	PRICE	SDV- 6	1-5
VAV 2-3-14	2-3	222	75	110	5	55	95	0.32	150	120	120/1/60	PRICE	SDV- 6	1-5
VAV 2-3-15	2-3	461	155	230	10	55	95	0.67	150	120	120/1/60	PRICE	SDV- 8	1-5
VAV 2-3-16	2-3	533	175	265	12	55	95	0.77	150	120	120/1/60	PRICE	SDV- 8	1-5
VAV 2-3-17	2-3	461	155	230	10	55	95	0.67	150	120	120/1/60	PRICE	SDV- 8	1-5
VAV 2-3-18	2-3	1324	440	660	29	55	95	1.91	150	120	120/1/60	PRICE	SDV- 14	1-5
VAV 2-3-19	2-3	461	155	230	10	55	95	0.67	150	120	120/1/60	PRICE	SDV- 8	1-5
VAV 2-3-20	2-3	461	155	230	10	55	95	0.67	150	120	120/1/60	PRICE	SDV- 8	1-5
VAV 2-3-21	2-3	461	155	230	10	55	95	0.67	150	120	120/1/60	PRICE	SDV- 8	1-5
VAV 2-3-22	2-3	461	155	230	10	55	95	0.67	150	120	120/1/60	PRICE	SDV- 8	1-5
VAV 2-3-23	2-3	461	155	230	10	55	95	0.67	150	120	120/1/60	PRICE	SDV- 8	1-5
VAV 2-3-24	2-3	460	155	230	10	55	95	0.67	150	120	120/1/60	PRICE	SDV- 8	1-5
VAV 2-3-25	2-3	328	110	165	7	55	95	0.48	150	120	120/1/60	PRICE	SDV- 6	1-5
VAV 2-3-26	2-3	460	155	230	10	55	95	0.67	150	120	120/1/60	PRICE	SDV- 8	1-5
VAV 2-3-27	2-3	460	155	230	10	55	95	0.67	150	120	120/1/60	PRICE	SDV- 8	1-5
VAV 2-3-28	2-3	460	155	230	10	55	95	0.67	150	120	120/1/60	PRICE	SDV- 8	1-5
VAV 2-3-29	2-3	460	155	230	10	55	95	0.67	150	120	120/1/60	PRICE	SDV- 8	1-5
VAV 2-3-30	2-3	460	155	230	10	55	95	0.67	150	120	120/1/60	PRICE	SDV- 8	1-5
VAV 2-3-31	2-3	395	130	195	8	55	95	0.56	150	120	120/1/60	PRICE	SDV- 8	1-5
VAV 2-3-32	2-3	515	170	260	11	55	95	0.75	150	120	120/1/60	PRICE	SDV- 8	1-5
VAV 2-3-33	2-3	567	190	285	12	55	95	0.82	150	120	120/1/60	PRICE	SDV- 8	1-5
VAV 2-3-34	2-3	497	165	250	11	55	95	0.72	150	120	120/1/60	PRICE	SDV- 8	1-5
VAV 2-3-35	2-3	591	195	295	13	55	95	0.85	150	120	120/1/60	PRICE	SDV- 8	1-5
VAV 2-3-36	2-3	1088	360	545	24	55	95	1.58	150	120	120/1/60	PRICE	SDV- 12	1-5
VAV 2-3-37	2-3	925	310	465	20	55	95	1.35	150	120	120/1/60	PRICE	SDV- 10	1-5
VAV 2-3-38	2-3	500	165	250	11	55	95	0.72	150	120	120/1/60	PRICE	SDV- 8	1-5

- PROVIDE ALL VAV BOXES W/ CONTROLS TRANSFORMER. DDC CONTROL VIA EXISTING BMS. INTERLOCK WITH OPERATION OF EXISTING ROOFTOP UNIT.
- ELECTRICAL CONTRACTOR TO PROVIDE DISCONNECT SWITCH MANUFACTURER PROVIDED SOUND ATTENUATION
- 4. 2-WAY VALVE PACKAGE, MATCH EXISTING BMS MANUFACTURER AND FACTORY INSTALL ON VAV BOX.
- 5. VERIFY COIL HANDEDNESS IN FIELD

	Alf														
SYMBOL			CFM			HO	T WATER (COIL			CONTROL POWER	BASIS O	F DESI	GN	
(BLDG-FLR-#)	RTU	COOL MAX	COOLING/HEATING	HEAT MAX	MIN NET CAP	EAT	LAT	GPM	EWT	LWT	V/PH/HZ	MNF	МО		NOTES
,		CFM	(33% MAX) CFM	(50% MAX) CFM	MBH	DEG F	DEG F		DEG F	DEG F	, ,		NUM	IBEK	
VAV 2-2-1	2-2	721	240	360	15.6	55	95	1.04	150	120	120/1/60	PRICE	SDV-	10	1-5
VAV 2-2-2	2-2	222	75	110	4.8	55	95	0.32	150	120	120/1/60	PRICE	SDV-	6	1-5
VAV 2-2-3	2-2	721	240	360	15.6	55	95	1.04	150	120	120/1/60	PRICE	SDV-	10	1-5
VAV 2-2-4	2-2	721	240	360	15.6	55	95	1.04	150	120	120/1/60	PRICE	SDV-	10	1-5
VAV 2-2-5	2-2	220	75	110	4.8	55	95	0.32	150	120	120/1/60	PRICE	SDV-	6	1-5
VAV 2-2-6	2-2	721	240	360	15.6	55	95	1.04	150	120	120/1/60	PRICE	SDV-	10	1-5
VAV 2-2-7	2-2	340	115	170	7.4	55	95	0.49	150	120	120/1/60	PRICE	SDV-	6	1-5
VAV 2-2-8	2-2	721	240	360	15.6	55	95	1.04	150	120	120/1/60	PRICE	SDV-	10	1-5
VAV 2-2-9	2-2	721	240	360	15.6	55	95	1.04	150	120	120/1/60	PRICE	SDV-	10	1-5
VAV 2-2-10	2-2	721	240	360	15.6	55	95	1.04	150	120	120/1/60	PRICE	SDV-	10	1-5
VAV 2-2-11	2-2	385	125	190	8.2	55	95	0.55	150	120	120/1/60	PRICE	SDV-	8	1-5
VAV 2-2-12	2-2	250	85	125	5.4	55	95	0.36	150	120	120/1/60	PRICE	SDV-	6	1-5
VAV 2-2-13	2-2	721	240	360	15.6	55	95	1.04	150	120	120/1/60	PRICE	SDV-	10	1-5
VAV 2-2-14	2-2	250	***************************************	125	54~~	55	95~	0.36	150	120	120/1/60	PRICE	SDV-	6	~1 - 5~
VAV 2-2-14A	2-2	226	75 T5	115		55	95	0.33	150	120	120/1/60	PRICE	SDV-	${{\sim}}$	1-5
VAV 2-2-14A VAV 2-2-14B	2-2	200	65	100	4.3	55	95	0.29	150	120	120/1/60	PRICE	SDV-	-	1-5
VAV 2-2-146 VAV 2-2-15	مريك				4.3		سيُّون	U.29 		-\\\\\\\\\\\\\\\\\\\\\\\\\\\\\\\\\\\\\	120/1/60	PRICE	SDV-		سليك
VAV 2-2-16	2-2	466	155	235	10.2	55	95	0.68	150	120	120/1/60	PRICE	SDV-	8	1-5
VAV 2-2-17	2-2	721	240	360	15.6	55	95	1.04	150	120	120/1/60	PRICE	SDV-	10	1-5
VAV 2-2-18	2-2	167	55	85	3.7	55	95	0.25	150	120	120/1/60	PRICE	SDV-	6	1-5
VAV 2-2-19	2-2	167	55	85	3.7	55	95	0.25	150	120	120/1/60	PRICE	SDV-	6	1-5
VAV 2-2-20	2-2	168	55	85	3.7	55	95	0.25	150	120	120/1/60	PRICE	SDV-		1-5
VAV 2-2-21	2-2	266	90	135	5.9	55	95	0.39	150	120	120/1/60	PRICE	SDV-	6	1-5
VAV 2-2-22	2-2	721	240	360	15.6	55	95	1.04	150	120	120/1/60	PRICE	SDV-	10	1-5
VAV 2-2-23	2-2	721	240	360	15.6	55	95	1.04	150	120	120/1/60	PRICE	SDV-	10	1-5
VAV 2-2-24	2-2	251	85	125	5.4	55	95	0.36	150	120	120/1/60	PRICE	SDV-	6	1-5
VAV 2-2-25	2-2	338	110	170	7.4	55	95	0.49	150	120	120/1/60	PRICE	SDV-	6	1-5
VAV 2-2-26	2-2	721	240	360	15.6	55	95	1.04	150	120	120/1/60	PRICE	SDV-	10	1-5
VAV 2-2-27	2-2	721	240	360	15.6	55	95	1.04	150	120	120/1/60	PRICE	SDV-	10	1-5
VAV 2-2-28	2-2	391	130	195	8.5	55	95	0.56	150	120	120/1/60	PRICE	SDV-	8	1-5
VAV 2-2-29	2-2	721	240	360	15.6	55	95	1.04	150	120	120/1/60	PRICE	SDV-	10	1-5
VAV 2-2-30	2-2~	~~ ⁸⁴⁷ ~~	~~~ ²⁸⁰ ~~~	425	184-0-	~55 ~	95~	123	150	120~	120/1/60	PRICE	SDV-	_10_	~1 - 5~
VAV 2-2-31	2-2	420	140	280	9.2	55	95	0.61	150	120	120/1/60	PRICE	SDV-	8	1-5
VAV 2-2-31A	2-2	630	210	315	13.7	55	95	0.91	150	120	120/1/60	PRICE	SDV-	10	1-5
~~~~~~~~~~~~~~~~~~~~~~~~~~~~~~~~~~~~~~	سميوسر	myghm	······································	my my	~~~~~~~~~~~~~~~~~~~~~~~~~~~~~~~~~~~~~~	<del></del>	Mgs-	~~~	-150~	4204	120/1/60	PRICE	SDV-	484	~~ <u>~</u>
VAV 2-2-33	2-2	400	135	200	8.7	55 -	95	0.58	150	120	120/1/60	PRICE	SDV-	8_	~1 <del>-</del> 5~
VAV 2-2-34	2-2	630	210	315	13.7	55	95	0.91	150	120	120/1/60	PRICE	SDV-	10	1-5
VAV 2-2-35	سيير	l	سسيتسس	<del>~~~~~~~~~~~~~~~~~~~~~~~~~~~~~~~~~~~~~</del>	<del>~~~~~~</del>	سييّب	سټّس	حبيب		~\\\\\\\\\\\\\\\\\\\\\\\\\\\\\\\\\\\\\	120/1/60	PRICE	SDV-		حنيت
VAV 2-2-35 VAV 2-2-36	2-2	258	85	130	5.6	55	95	0.38	150	120	120/1/60	PRICE	SDV-	6	1-5
													SDV-	-	
VAV 2-2-37	2-2	721	240	360	15.6	55	95	1.04	150	120	120/1/60	PRICE		10	1-5
VAV 2-2-38	2-2	460	155	230	10	55	95	0.67	150	120	120/1/60	PRICE	SDV-	8	1-5

- 1. PROVIDE ALL VAV BOXES W/ CONTROLS TRANSFORMER. DDC CONTROL VIA EXISTING BMS. INTERLOCK WITH OPERATION OF EXISTING ROOFTOP UNIT. 2. ELECTRICAL CONTRACTOR TO PROVIDE DISCONNECT SWITCH
- MANUFACTURER PROVIDED SOUND ATTENUATION
- 4. 2-WAY VALVE PACKAGE, MATCH EXISTING BMS MANUFACTURER AND FACTORY INSTALL ON VAV BOX.
- VERIFY COIL HANDEDNESS IN FIELD

VARIABLE	AIF	VOLUME (VAV) TERMINAL UNIT	SCHEDULE


SYMBOL			CFM			НОТ	Γ WATER (	COIL			CONTROL POWER	BASIS C	F DESIGN	
(BLDG-FLR-#)	RTU	COOL MAX	COOLING/HEATING (33% MAX) CFM	HEAT MAX (50% MAX) CFM	MIN NET CAP	EAT DEG F	LAT DEG F	GPM	EWT DEG F	LWT DEG F	V/PH/HZ	MNF	MODEL NUMBER	NOTES
VAV 2-4-1	2-4	260	85	130	5.6	55	95	0.38	150	120	120/1/60	PRICE	SDV- 6	1-5
VAV 2-4-1 VAV 2-4-2	2-4	560	185	280	12.2	55	95	0.30	150	120	120/1/60	PRICE	SDV- 8	1-5
VAV 2-4-2 VAV 2-4-3	2-4	230	75	115	5.0	55	95	0.33	150	120	120/1/60	PRICE	SDV-6	1-5
VAV 2-4-3 VAV 2-4-4	2-4	230	75	115	5.0	55	95	0.33	150	120	120/1/60	PRICE	SDV-6	1-5
VAV 2-4-4 VAV 2-4-5	2-4	345	115	175	7.6	55	95	0.53	150	120	120/1/60	PRICE	SDV-6	1-5
VAV 2-4-6~~	2-4	~~~~	295	440	19.1 19.1	~55~	95~	127	150	120	120/1/60	PRICE	SDV-10	~ ¹⁵ ~
VAV 2-4-7	2-4	420	140	210	9.1	55	95	0.61	150	120	120/1/60	PRICE	SDV-8	1-5
VAV 2-4-7A	2-4	255	85	130	5.6	55	95	0.38	150	120	120/1/60	PRICE	SDV- 6	1-5
~~~~~~~~~~~~~~~~~~~~~~~~~~~~~~~~~~~~~~	سيت	ستهتس	my m	minu	سيتس	ستتج	سيُّوس	سراب		- 120	120/1/60	MPRICE	SOVIEW	المستثب
VAV 2-4-9	2-4	230	75	115	5.0	55	95	0.33	150	120	120/1/60	PRICE	SDV- 6	1-5
VAV 2-4-10	2-4	120	40	60	2.6	55	95	0.17	150	120	120/1/60	PRICE	SDV- 6	1-5
VAV 2-4-11	2-4	480	160	240	10.4	55	95	0.69	150	120	120/1/60	PRICE	SDV- 8	1-5
VAV 2-4-12	2-4	390	130	195	8.5	55	95	0.56	150	120	120/1/60	PRICE	SDV- 8	1-5
VAV 2-4-13	2-4	480	160	240	10.4	55	95	0.69	150	120	120/1/60	PRICE	SDV- 8	1-5
VAV 2-4-14	2-4	820	275	410	17.8	55	95	1.19	150	120	120/1/60	PRICE	SDV- 10	1-5
VAV 2-4-15	2-4	115	40	60	2.6	55	95	0.17	150	120	120/1/60	PRICE	SDV- 6	1-5
VAV 2-4-16	2-4	255	85	130	5.6	55	95	0.38	150	120	120/1/60	PRICE	SDV- 6	1-5
VAV 2-4-17	2-4	230	75	115	5.0	55	95	0.33	150	120	120/1/60	PRICE	SDV- 6	1-5
VAV 2-4-18	2-4	585	195	295	12.8	55	95	0.85	150	120	120/1/60	PRICE	SDV- 8	1-5
VAV 2-4-19	24	745	~~~ ²⁵⁰ ~~~	375	~~163~~~	~ ⁵⁵ ~	~ ⁹⁵ ~	109	150	120	120/1/60	PRICE	SDV-10	715
VAV 2-4-19A	2-4	200	65	100	4.3	55	95	0.29	150	120	120/1/60	PRICE	SDV- 6	1-5
VAY24-24~	~24	~~~7\5~~~	~~~~~~~~~~~~~~~~~~~~~~~~~~~~~~~~~~~~~~	~~~266~~~	~~\\\\\\\\\\\\\\\\\\\\\\\\\\\\\\\\\\\\	√ 55 √	~~\$5~	1.04	~15P~	~~~~~	~12Q/1/6Q~~	~\p\6\mathcal{E}_	~SBY=18~	~45~
VAV 2-4-21A	2-4	200	65	100	4.3	55	95	0.29	150	120	120/1/60	PRICE	SDV- 6	1-5
VAV 2-4-22	2-4	170	55	85	3.7	55	95	0.25	150	120	120/1/60	PRICE	SDV-6	1-5
VAV 2-4-23	2-4	340	115	170	7.4	55	95	0.49	150	120	120/1/60	PRICE	SDV- 6	1-5
VAV 2-4-24~~	~2 4 ~	~~ ³¹⁵ ~~	~~~ ¹⁰⁵ ~~~	~~ ¹⁶⁰ ~~~	~~64~~	~~ ⁵⁵ ~~	~ ⁹⁵ ~	~046~	150	~ ¹²⁰ ~	120/1/60	PRICE	~\$ ^V -\$~	75
VAV 2-4-24A	2-4	200	65	100	4.3	55	95	0.29	150	120	120/1/60	PRICE	SDV- 6	1-5
VAV 2-4-24B	2-4	200	65	100	4.3	55	95	0.29	150	120	120/1/60	PRICE	SDV- 6	1-5
	~~~~			~~~~~									*****	
VAV 2-4-26	2-4	230	75	115	5.0	55	95	0.33	150	120	120/1/60	PRICE	SDV- 6	1-5
VAV 2-4-26A	2-4	400	135	200	8.7	55	95	0.58	150	120	120/1/60	PRICE	SDV- 8	1-5
VAV 2-4-26B	2-4	400	135	200	8.7	55	95	0.58	150	120	120/1/60	PRICE	SDV-8	1-5
	\\frac{1}{2}\rightarrow\rightarrow\rightarrow\rightarrow\rightarrow\rightarrow\rightarrow\rightarrow\rightarrow\rightarrow\rightarrow\rightarrow\rightarrow\rightarrow\rightarrow\rightarrow\rightarrow\rightarrow\rightarrow\rightarrow\rightarrow\rightarrow\rightarrow\rightarrow\rightarrow\rightarrow\rightarrow\rightarrow\rightarrow\rightarrow\rightarrow\rightarrow\rightarrow\rightarrow\rightarrow\rightarrow\rightarrow\rightarrow\rightarrow\rightarrow\rightarrow\rightarrow\rightarrow\rightarrow\rightarrow\rightarrow\rightarrow\rightarrow\rightarrow\rightarrow\rightarrow\rightarrow\rightarrow\rightarrow\rightarrow\rightarrow\rightarrow\rightarrow\rightarrow\rightarrow\rightarrow\rightarrow\rightarrow\rightarrow\rightarrow\rightarrow\rightarrow\rightarrow\rightarrow\rightarrow\rightarrow\rightarrow\rightarrow\rightarrow\rightarrow\rightarrow\rightarrow\rightarrow\rightarrow\rightarrow\rightarrow\rightarrow\rightarrow\rightarrow\rightarrow\rightarrow\rightarrow\rightarrow\rightarrow\rightarrow\rightarrow\rightarrow\rightarrow\rightarrow\rightarrow\rightarrow\rightarrow\rightarrow\rightarrow\rightarrow\rightarrow\rightarrow\rightarrow\rightarrow\rightarrow\rightarrow\rightarrow\rightarrow\rightarrow\rightarrow\rightarrow\rightarrow\rightarrow\rightarrow\rightarrow\rightarrow\rightarrow\rightarrow\rightarrow\rightarrow\rightarrow\rightarrow\rightarrow\rightarrow\rightarrow\rightarrow\rightarrow\rightarrow\rightarrow\rightarrow\rightarrow\rightarrow\rightarrow\rightarrow\rightarrow\rightarrow\rightarrow\rightarrow\rightarrow\rightarrow\rightarrow\rightarrow\rightarrow\rightarrow\rightarrow\rightarrow\rightarrow\rightarrow\rightarrow\rightarrow\rightarrow\rightarrow\rightarrow\rightarrow\rightarrow\rightarrow\rightarrow\rightarrow\rightarrow\rightarrow\rightarrow\rightarrow\rightarrow\rightarrow\rightarrow\rightarrow\rightarrow\rightarrow\rightarrow\rightarrow\rightarrow\rightarrow\rightarrow\rightarrow\rightarrow\rightarrow\rightarrow\rightarrow\rightarrow\rightarrow\rightarrow\rightarrow\rightarrow\rightarrow\rightarro			$\sim\sim\sim\sim$	$\gamma \gamma $	$\sim$	<b>∼</b>	<b>╱</b> ╨╬╱			~~~~~~~~~~~~~~~~~~~~~~~~~~~~~~~~~~~~~~		$\sim\sim$	$\sim\sim$
VAV 2-4-28	2-4	1145	380	575	25.0	55	95	1.66	150	120	120/1/60	PRICE	SDV- 12	1-5
VAV 2-4-28A	2-4	400	135	200	8.7	55	95	0.58	150	120	120/1/60	PRICE	SDV- 8 SDV- 6	1-5
VAV 2-4-28B	2-4	200	65	100	4.3	55	95	0.29	150	120	120/1/60	PRICE	2DV-0	1-5
VAV 2-4-30	2-4	445	150	225	~~~~~	~~~~	~~~~~~~~~~~~~~~~~~~~~~~~~~~~~~~~~~~~~~	~~~~		120	120/1/60	PRICE	SDV- 8	1-5
VAV 2-4-30 VAV 2-4-30A	2-4	800	265	400	9.8 17.4	55 55	95 95	0.65 1.16	150 150	120	120/1/60	PRICE	SDV- 0	1-5
VAV 2-4-30A VAV 2-4-31	~2-4 ~2 <u>-4</u> ~				~~~~~~~~~~~~~~~~~~~~~~~~~~~~~~~~~~~~~~	سيتب	سيس	0.58	4500	120 120	120/1/60	PRICE	3DV= 10	السيبيرير
			105	200	0.7	55	95	1 11						1-0
VAV 2-4-32 VAV 2-4-33	2-4 2-4	585 345	195 115	295 175	12.8 7.6	55 55	95 95	0.85 0.51	150 150	120	120/1/60 120/1/60	PRICE PRICE	SDV- 8 SDV- 6	1-5 1-5
VAV 2-4-33 VAV 2-4-34	2-4	170	55	85	3.7	55 55	95 95	0.51	150	120 120	120/1/60	PRICE	SDV- 6	1-5
			95 85	- 130	3.7			0.25				PRICE	SDV-6	1-5
VAV 2-4-35 VAV 2-4-36	2-4 2-4	260 1600	535	800	34.7	55 55	95 95	2.31	150 150	120	120/1/60 120/1/60	PRICE	SDV- 16	1-5
	2-4	230	75	115		55 55		0.33	150	120	120/1/60	PRICE	SDV- 16	1-5
VAV 2-4-36A	2-4				5.0		95			120		PRICE	SDV- 6	——————————————————————————————————————
VAV 2-4-36B	2-4	125	40	65	2.8	-55 	95	0.19	150	120	120/1/60	PRICE	2DV- 6	1-5
		545	000	200	7.6	55	95						SDV- 8	1.5
VAV 2-4-38	2-4	595	200	300	13.0	55	95	0.87	150	120	120/1/60	PRICE	SDV- 8	1-5
VAV 2-4-39	2-4	375	125	190	8.2	55	95	0.55	150	120	120/1/60	PRICE		1-5
VAV 2-4-39A	2-4	400	135	200	8.7	55	95	0.58	150	120	120/1/60	PRICE	SDV-8	1-5

1. PROVIDE ALL VAV BOXES W/ CONTROLS TRANSFORMER. DDC CONTROL VIA EXISTING BMS. INTERLOCK WITH OPERATION OF EXISTING ROOFTOP UNIT.

- 2. ELECTRICAL CONTRACTOR TO PROVIDE DISCONNECT SWITCH 3. MANUFACTURER PROVIDED SOUND ATTENUATION
- 4. 2-WAY VALVE PACKAGE, MATCH EXISTING BMS MANUFACTURER AND FACTORY INSTALL ON VAV BOX.
- 5. VERIFY COIL HANDEDNESS IN FIELD

119 Cherry Hill Road, Suite 110 Parsippany, NJ 07054 862.207.5900 • www.h2m.com NJ Landscape Architecture Certificate No.: 21MH00010300
NJ Engineering Certificate of Authorization No.: 24GA28019100

H2M Associates, Inc.

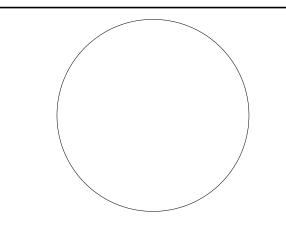


JOHN CHRIS MORRIS III, P.E.

THIS SHALL NOT BE CONSIDERED AN OFFICIAL DOCUMENT UNLESS IT CONTAINS THE RAISED SEAL OF LICENSEE.

DESIGNED BY: DRAWN BY: CHECKED BY: REVIEWED BY:

JSK/DKR DKR JSK JCM DJECT No: DATE: SCALE: AS SHOWN

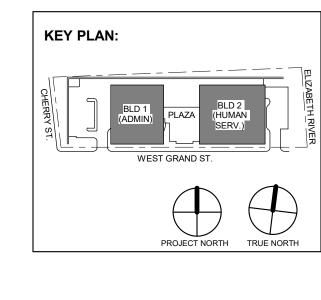


12.22.2023 Addendum No. 4 12.15.2023 Addendum No. 3 11.08.2023 For Public Bid No. Date Description

ARCHITECTURE FOR CHANGI 15 Bethany Street • New Brunswick, NJ 08901 • T: 732.249.6242 2450 W Hunting Park Ave • Philadelphia, PA 19122 • T: 215.634.3400

Jeffrey D. Venezia, AIA NJ RA AI 00827100

Revisions / Issues

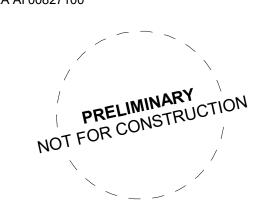

DO NOT SCALE. DRAWING MAY BE PRINTED AT REDUCED SCALE. CONSULT WITH ARCHITECT FOR DIMENSIONS.

UNION COUNTY IMPROVEMENT AUTHORITY

UNION COUNTY GOVERNMENT COMPLEX 81 & 93 WEST GRAND STREET CITY OF ELIZABETH NEW JERSEY, 07202

Drawing Information:

Project No: 20.072
Date: 11.08.2023
Drawn By: JB/AV/PC
Checked By: JM/SH Sheet Name:

BUILDING NO. 1&2 -MECHANICAL SCHEDULES (4 OF

SYMBOL			CFM			HO	T WATER	COIL			CONTROL POWER	BASIS C	F DESIGN	
(BLDG-FLR- 5)	RTU	COOL MAX	COOLING/HEATING	HEAT MAX	MIN NET CAP	EAT	LAT	GPM	EWT	LWT	V/PH/HZ	MNF	MODEL	NOTES
,		CFM	(33% MAX) CFM	(50% MAX) CFM	MBH	DEG F	DEG F		DEG F	DEG F	, ,		NUMBER	
VAV 2-5-1	~ ² -5~	360	~~~ ¹²⁰ ~~~	180	78~~	~55~	~ ⁹⁵ ~~	~0.52 ~	150	120~	120/1/60	PRICE	SDV-6	~15~
VAV 2-5-2	2-5	254	85	125	5.4	55	95	0.36	150	120	120/1/60	PRICE	SDV- 6	1-5
VAV 2-5-3	2-5	750	250	375	18.4	55	95	1.09	150	120	120/1/60	PRICE	SDV- 10	1-5
VAV 2-5-4	2-5	800	265	400	17.4	55	95	1.16	150	120	120/1/60	PRICE	SDV- 10	1-5
VAV2-5-5	سييد					~~ <u>5</u> 5~	MgC	0.87	-150m	120	120/1/60	PRICE	SDAT	
VAV 2-5-6	2-5	570	190	285	12.4	55	95	0.82	150	120	120/1/60	PRICE	SDV- 8	1-5
VAV 2-5-7	2-5	195	65	100	4.3	55	95	0.29	150	120	120/1/60	PRICE	SDV- 6	1-5
VAV 2-5-8	2-5	325	110	165	7.2	55	95	0.48	150	120	120/1/60	PRICE	SDV- 6	1-5
VAV 2-5-9	2-5	570	190	285	12.4	55	95	0.82	150	120	120/1/60	PRICE	SDV- 8	1-5
VAV 2-5-10	~~ ² ~~	600	~~~200~~~	~~ ³⁰⁰ ~~	~~13Q~~	~~ ⁵⁵ ~~	~ ⁹⁵ ~~	~0.87~	150	120~	120/1/60	PRICE	SDV-8	~15~
VAV 2-5-11	2-5	375	125	190	8.2	55	95	0.55	150	120	120/1/60	PRICE	SDV- 6	1-5
~~~~~~~~~~~~~~~~~~~~~~~~~~~~~~~~~~~~~~	سميم	~~\$H		255		~55~	wight.	4.74~	-150m	120	120/1/60	PRICE	SDAT	
VAV 2-5-13	2-5	600	200	300	13.0	55	95	0.87	150	120	120/1/60	PRICE	SDV- 8	1-5
VAV 2-5-14	2-5	700	235	350	15.2	55	95	1.01	150	120	120/1/60	PRICE	SDV- 10	1-5
VAV 2-5-15	2-5	470	155	235	10.2	55	95	0.68	150	120	120/1/60	PRICE	SDV- 8	1-5
VAV 2-5-16	2-5	120	40	60	2.6	55	95	0.17	150	120	120/1/60	PRICE	SDV- 6	1-5
VAV 2-5-17	2-5	1000	335	500	21.7	55	95	1.45	150	120	120/1/60	PRICE	SDV- 12	1-5
VAV 2-5-18	2-5	370	125	185	8.0	55	95	0.54	150	120	120/1/60	PRICE	SDV- 6	1-5
VAV 2-5-19	2-5	500	165	250	10.9	55	95	0.72	150	120	120/1/60	PRICE	SDV- 8	1-5
VAV 2-5-20	2-5	400	135	200	8.7	55	95	0.58	150	120	120/1/60	PRICE	SDV- 8	1-5
VAV 2-5-21	2-5	1405	470	705	30.6	55	95	2.04	150	120	120/1/60	PRICE	SDV- 14	1-5
VAV 2-5-22	2-5	630	210	315	13.7	55	95	0.91	150	120	120/1/60	PRICE	SDV- 10	1-5
VAV 2-5-23	~2-5~	~~ ⁹⁵⁰ ~~	~~~ ³¹⁵ ~~~	475~~~	~~ ²⁰⁶ ~~	~55~	~~ ⁹⁵ ~~	~137~	~ ¹⁵⁰ ~	~12D~	120/1/60	~PRICE~	~SDV-19~	~~ ¹ 5~
VAV 2-5-23A	2-5 2-5	167	55	85	3.7	55	95 95	0.25	150 150	120	120/1/60	PRICE	SDV- 6	1-5
VAV 2-5-25	2-5	360	120	180	7.8	55	95	0.52	150	120	120/1/60	PRICE	SDV- 6	1-5
VAV 2-5-26	2-5	500	165	250	10.9	55	95	0.72	150	120	120/1/60	PRICE	SDV- 8	1-5
VAV 2-5-27	2-5	300	100	150	6.5	55	95	0.43	150	120	120/1/60	PRICE	SDV- 6	1-5
VAV 2-5-28	2-5	415	140	210	9.1	55	95	0.61	150	120	120/1/60	PRICE	SDV- 8	1-5
VAV 2-5-29	2-5	450	150	230	10	55	95	0.67	150	120	120/1/60	PRICE	SDV- 8	1-5
VAV 2-5-29A	2-5	800	265	400	17.4	55	95	1.16	150	120	120/1/60	PRICE	SDV- 10	1-5
VAV 2-5-30	2-5	460	155	230	10.0	55	95	0.67	150	120	120/1/60	PRICE	SDV- 8	1-5
VAV 2-5-31	2-5	1020	340	510	22.1	55	95	1.48	150	120	120/1/60	PRICE	SDV- 12	1-5
VAV 2-5-32	2-5	175	60	90	3.9	55	95	0.26	150	120	120/1/60	PRICE	SDV- 6	1-5
VAV 2-5-33	275~	460	155	~~~230~~~	100~~	~55~	~95~~	~067 <u>~</u>	150	120	120/1/60	PRICE	SDV-8	~15~
VAV 2-5-34	2-5	1,200	400	600	25.7	55	95	1.72	150	120	120/1/60	PRICE	SDV- 14	1-5
VAV 2-5-34A	2-5	300	100	150	6.5	55	95	0.43	150	120	120/1/60	PRICE	SDV- 6	1-5
VAV 2-5-35	سييد	~~300~~~	mayor market and the same and t	mospun		~~ <u>55</u> ~	~95~	0.43	-150m	120	120/1/60	PRICE	SDV-6	<u> </u>
		1110	1	†		—	 		+				 	+

PROVIDE ALL VAV BOXES W/ CONTROLS TRANSFORMER. DDC CONTROL VIA EXISTING BMS. INTERLOCK WITH OPERATION OF EXISTING ROOFTOP UNIT.

VAV 2-5-36 | 2-5 | 1110 | 370 | 555 | 24.1 | 55 | 95 | 1.61 | 150 | 120 | 120/1/60 | PRICE | SDV- 12 | 1-5

ELECTRICAL CONTRACTOR TO PROVIDE DISCONNECT SWITCH

MANUFACTURER PROVIDED SOUND ATTENUATION 4. 2-WAY VALVE PACKAGE, MATCH EXISTING BMS MANUFACTURER AND FACTORY INSTALL ON VAV BOX.

5. VERIFY COIL HANDEDNESS IN FIELD

SYMBOL			CFM			HO	T WATER (COIL			CONTROL POWER	BASIS O	F DESIGN	
(BLDG-FLR- 6)	RTU	COOL MAX	COOLING/HEATING (33% MAX) CFM	HEAT MAX (50% MAX) CFM	MIN NET CAP	EAT DEG F	LAT DEG F	GPM	EWT DEG F	LWT DEG F	V/PH/HZ	MNF	MODEL NUMBER	NOTES
\/A\/ 0 0 4	0.0		,	,				0.40			400/4/00	DDIOE	001/ 0	4.5
VAV 2-6-1	2-6	334	110	165	7.2	55	95	0.48	150	120	120/1/60	PRICE	SDV- 6	1-5
VAV 2-6-2	2-6	747	250	375	16.3	55	95	1.09	150	120	120/1/60	PRICE	SDV- 10	1-5
VAV 2-6-3	2-6	178	60	90	3.9	55	95	0.26	150	120	120/1/60	PRICE	SDV- 6	1-5
VAV 2-6-4 VAV 2-6-5	2-6 2-6	962 500	320 165	480 250	20.8	55	95 95	1.39	150 150	120	120/1/60 120/1/60	PRICE PRICE	SDV- 12 SDV- 8	1-5
		962	320			55		0.72		120		PRICE	SDV- 6	1-5
VAV 2-6-6	2-6 2-6	962	315	480 475	20.8	55	95	1.39	150 150	120	120/1/60 120/1/60	PRICE	SDV- 12	1-5
VAV 2-6-7 VAV 2-6-8	2-6	112	35		20.6	55 55	95 95	1.37 0.16	150	120 120	120/1/60	PRICE	SDV- 10	1-5 1-5
				55										
VAV 2-6-9 VAV 2-6-10	2-6 2-6	110 469	35 155	55 235	2.4	55 55	95 95	0.16 0.68	150 150	120 120	120/1/60 120/1/60	PRICE PRICE	SDV- 6 SDV- 8	1-5 1-5
VAV 2-6-10 VAV 2-6-11	2-6	469	155	235	10.2	55 55	95 95	0.68	150	120	120/1/60	PRICE	SDV- 8	1-5
VAV 2-6-11	2-6	469	155	235	10.2	55	95	0.68	150	120	120/1/60	PRICE	SDV- 8	1-5
VAV 2-6-12 VAV 2-6-13	2-6	228	75	115	5	55	95	0.00	150	120	120/1/60	PRICE	SDV- 6	1-5
	2-6	469					95	0.55	150	120	120/1/60	PRICE	SDV-8	
VAV 2-6-14 VAV 2-6-15 VAV 2-6-16	2-6	920	305 305	460	20	55 55 	95	1.33	150	120	120/1/60	PRICE	SDV- 12	1-5 1-5
VAV 2-6-10	2-6	257	85	130	5.6	55	95	0.38	150	120	120/1/60	PRICE	SDV- 6	1-5
VAV 2-6-18	2-6	257	85	130	5.6	55	95	0.38	150	120	120/1/60	PRICE	SDV- 6	1-5
VAV 2-6-19	2-6	708	235	355	15.4	55	95	1.03	150	120	120/1/60	PRICE	SDV- 10	1-5
VAV 2-6-20	2-6	607	200	305	13.2	55	95	0.88	150	120	120/1/60	PRICE	SDV- 10	1-5
VAV 2-6-21	2-6	607	200	305	13.2	55	95	0.88	150	120	120/1/60	PRICE	SDV- 10	1-5
VAV 2-6-22	2-6	607	200	305	13.2	55	95	0.88	150	120	120/1/60	PRICE	SDV- 10	1-5
VAV 2-6-23	2-6	607	200	305	13.2	55	95	0.88	150	120	120/1/60	PRICE	SDV- 10	1-5
VAV 2-6-24	2-6	250	85	125	5.4	55	95	0.36	150	120	120/1/60	PRICE	SDV- 6	1-5
VAV 2-6-25	2-6	607	200	305	13.2	55	95	0.88	150	120	120/1/60	PRICE	SDV- 10	1-5
VAV 2-6-26	2-6	200	65	100	4.3	55	95	0.29	150	120	120/1/60	PRICE	SDV- 6	1-5
VAV 2-6-27	2-6	607	200	305	13.2	55	95	0.88	150	120	120/1/60	PRICE	SDV- 10	1-5
VAV 2-6-28	2-6	607	200	305	13.2	55	95	0.88	150	120	120/1/60	PRICE	SDV- 10	1-5
VAV 2-6-29	2-6	607	200	305	13.2	55	95	0.88	150	120	120/1/60	PRICE	SDV- 10	1-5
VAV 2-6-30	2-6	700	235	350	15.2	55	95	1.01	150	120	120/1/60	PRICE	SDV- 10	1-5
VAV 2-6-31	2-6	607	200	305	13.2	55	95	0.88	150	120	120/1/60	PRICE	SDV- 10	1-5
VAV 2-6-32	2-6	607	200	305	13.2	55	95	0.88	150	120	120/1/60	PRICE	SDV- 10	1-5
VAV 2-6-33	2-6	607	200	305	13.2	55	95	0.88	150	120	120/1/60	PRICE	SDV- 10	1-5
VAV 2-6-34	2-6	607	200	305	13.2	55	95	0.88	150	120	120/1/60	PRICE	SDV- 10	1-5
VAV 2-6-35	2-6	607	200	305	13.2	55	95	0.88	150	120	120/1/60	PRICE	SDV- 10	1-5
VAV 2-6-36	2-6	254	85	125	5.4	55	95	0.36	150	120	120/1/60	PRICE	SDV- 6	1-5
VAV 2-6-37	2-6	607	200	305	13.2	55	95	0.88	150	120	120/1/60	PRICE	SDV- 10	1-5
VAV 2-6-38	2-6	458	150	230	10	55	95	0.67	150	120	120/1/60	PRICE	SDV- 8	1-5
VAV 2-6-39	2-6	~~ ⁵²⁵ ~~	~~~ ¹⁷⁵ ~~~	~~ ²⁶⁵ ~~~	~~ ¹¹ 5~~	~~ ⁵⁵ ~~	95~	~D77~	150	120	120/1/60	PRICE	SDV-8~	~15~
VAV 2-6-40	2-6	450	150	230	10	55	95	0.67	150	120	120/1/60	PRICE	SDV- 8	1-5
VAV 2-6-40A	2-6	300	100	150	6.5	55	95	0.43	150	120	120/1/60	PRICE	SDV- 6	1-5
VAV 2-6-41	2-6	450	150	230	10	55	95	0.67	150	120	120/1/60	PRICE	SDV- 8	1-5
	2-6	300	100	150	6.5	55	95	0.43	150	120	120/1/60	PRICE	SDV- 6	1-5

VAV NOTES:

1. PROVIDE ALL VAV BOXES W/ CONTROLS TRANSFORMER. DDC CONTROL VIA EXISTING BMS. INTERLOCK WITH OPERATION OF EXISTING ROOFTOP UNIT.

ELECTRICAL CONTRACTOR TO PROVIDE DISCONNECT SWITCH MANUFACTURER PROVIDED SOUND ATTENUATION

2-WAY VALVE PACKAGE, MATCH EXISTING BMS MANUFACTURER AND FACTORY INSTALL ON VAV BOX.

VERIFY COIL HANDEDNESS IN FIELD

								VRF SYS	STEM - HEA	T PUMP SCH	EDULE																
					INDOOR UNIT														OUTE	DOOR UNIT							
UNIT	MFR	MODEL	STYLE	SERVING	SUPPLY AIRFLOW CFI		EXTERNAL STATIC	TOTAL COOLING	SENSIBLE COOLING CAP	TOTAL HEATING	ELE	CTRICAL	WF	EIGHT (LBS) UN	T MODEL	REFR	RATED COOLING	RATED HEATING		EFFICIE	NCY	,	El	LECTRICAL		WEIGHT (LBS)	NOTES
OMI	WIIK	MODEL	OTTEE	CERTIFIC	(H/M/L)	AIRFLOW CFM	PRESSURE (IN W.C.)	CAP (MBH)	(MBH)	CAP (MBH)	V/PH/HZ	MCA	МОСР	.ioiii (LDO)	MODEL	CHARGE	CAPACITY (MBH)	CAPACITY (MBH)	EER	IEER	СОР	COP17	V/PH/HZ	MCA	MOCP (A)	/LIGITI (LDO)	
AC 1-1-1	DAIKIN	FXAQ18	WALL MOUNTED - DUCTLESS	BLDG 1 - LEVEL 3 IDF	500/400	-	-	18	13.3	20	208-230/1/60	0.4	15	31													
AC 1-1-2	DAIKIN	FXAQ18	WALL MOUNTED - DUCTLESS	BLDG 1 - LEVEL 4 IDF	500/400	-	-	18	13.3	20	208-230/1/60	0.4	15	31 HP	-1 RXYQ72	17.7	72	71.5	15.2	27	4	2.5	460/3/60	12.4	15	507	1-10
AC 1-1-3	DAIKIN	FXAQ18	WALL MOUNTED - DUCTLESS	BLDG 1 - LEVEL 5 IDF	500/400	-	-	18	13.3	20	208-230/1/60	0.4	15	31													
AC 1-2-1	DAIKIN	FXAQ18	WALL MOUNTED - DUCTLESS	BLDG 1 - LEVEL 2 ELEC	500/400	-	-	18	13.3	20	208-230/1/60	0.4	15	31													
AC 1-2-2	DAIKIN	FXAQ18	WALL MOUNTED - DUCTLESS	BLDG 1 - LEVEL 3 ELEC	500/400	-	-	18	13.3	20	208-230/1/60	0.4	15	31	DVV070	40.0	70	74.5	45.0	27		2.5	400/0/00	40.4	45	507	4.40
AC 1-2-3	DAIKIN	FXAQ18	WALL MOUNTED - DUCTLESS	BLDG 1 - LEVEL 4 ELEC	500/400	-	-	18	13.3	20	208-230/1/60	0.4	15	31 HP	RXYQ72	18.3	72	71.5	15.2	21	4	2.5	460/3/60	12.4	15	507	1-10
AC 1-2-4	DAIKIN	FXAQ18	WALL MOUNTED - DUCTLESS	BLDG 1 - LEVEL 5 ELEC	500/400	-	-	18	13.3	20	208-230/1/60	0.4	15	31													
AHU 1-3-1	DAIKIN	FXMQ07	CONCEALED - DUCTED	BLDG 1 - ROOF VESTIBULE	317 / 264 / 229	30	0.2 / 0.4	7.5	6.4	8.5	208-230/1/60	0.6	15	55													
AC 1-3-2	DAIKIN	FXAQ24	WALL MOUNTED - DUCTLESS	BLDG 1 - ELEV MACHINE RM	635 / 470	-	-	24	17.1	26.5	208-230/1/60	0.6	15	31													
AC 1-3-3	DAIKIN	FXAQ24	WALL MOUNTED - DUCTLESS	BLDG 1 - ELEV MACHINE RM	635 / 470	-	-	24	17.1	26.5	208-230/1/60	0.6	15	31 HP	-3 RXYQ72	18.5	76.1	72.1	13	21.4	3.5	2.4	460/3/60	12.4	15	507	1-10
AHU 1-3-4	DAIKIN	FXMQ24	CONCEALED - DUCTED	BLDG 1 - ELEV HOISTWAY	688 / 618 / 565	-	0.4 / 0.8	24	18.3	27	208-230/1/60	1.8	15	80													
AHU 1-3-5	DAIKIN	FXMQ07	CONCEALED - DUCTED	BLDG 1 - ROOFTOP LOBBY	317 / 264 / 229	30	0.2 / 0.4	7.5	6.4	8.5	208-230/1/60	0.6	15	55													
AC 2-1-1	DAIKIN	FXAQ18	WALL MOUNTED - DUCTLESS	BLDG 2 - LEVEL 1 IDF	500/400	-	-	18	13.3	20	208-230/1/60	0.4	15	31													
AC 2-1-2	DAIKIN	FXAQ18	WALL MOUNTED - DUCTLESS	BLDG 2 - LEVEL 2 IDF	500/400	-	-	18	13.3	20	208-230/1/60	0.4	15	31													
AC 2-1-3	DAIKIN	FXAQ18	WALL MOUNTED - DUCTLESS	BLDG 2 - LEVEL 3 IDF	500/400	-	-	18	13.3	20	208-230/1/60	0.4	15	31	DVV0400		444	400	40.0	00.0	0.7	0.5	400/0/00	47.0	00	00.4	4.40
AC 2-1-4	DAIKIN	FXAQ18	WALL MOUNTED - DUCTLESS	BLDG 2 - LEVEL 4 IDF	500/400	-	-	18	13.3	20	208-230/1/60	0.4	15	31 HP	2-1 RXYQ120	31.2	114	129	12.6	26.6	3.7	2.5	460/3/60	17.2	20	694	1-10
AC 2-1-5	DAIKIN	FXAQ18	WALL MOUNTED - DUCTLESS	BLDG 2 - LEVEL 5 IDF	500/400	-	-	18	13.3	20	208-230/1/60	0.4	15	31													
AC 2-1-6	DAIKIN	FXAQ18	WALL MOUNTED - DUCTLESS	BLDG 2 - LEVEL 6 IDF	500/400	-	-	18	13.3	20	208-230/1/60	0.4	15	31													
AC 2-2-1	DAIKIN	FXAQ18	WALL MOUNTED - DUCTLESS	BLDG 2 - LEVEL 1 ELEC	500/400	-	-	18	13.3	20	208-230/1/60	0.4	15	31													
AC 2-2-2	DAIKIN	FXAQ18	WALL MOUNTED - DUCTLESS	BLDG 2 - LEVEL 2 ELEC	500/400	-	-	18	13.3	20	208-230/1/60	0.4	15	31													
AC 2-2-3	DAIKIN	FXAQ18	WALL MOUNTED - DUCTLESS	BLDG 2 - LEVEL 3 ELEC	500/400	-	-	18	13.3	20	208-230/1/60	0.4	15	31	DVVO400		444	400	40.0	20.0	0.7	0.5	400/0/00	47.0	00	604	4.40
AC 2-2-4	DAIKIN	FXAQ18	WALL MOUNTED - DUCTLESS	BLDG 2 - LEVEL 4 ELEC	500/400	-	-	18	13.3	20	208-230/1/60	0.4	15	31 HP	2-2 RXYQ120	31.3	114	129	12.6	26.6	3.7	2.5	460/3/60	17.2	20	694	1-10
AC 2-2-5	DAIKIN	FXAQ18	WALL MOUNTED - DUCTLESS	BLDG 2 - LEVEL 5 ELEC	500/400	-	-	18	13.3	20	208-230/1/60	0.4	15	31													
AC 2-2-6	DAIKIN	FXAQ18	WALL MOUNTED - DUCTLESS	BLDG 2 - LEVEL 6 ELEC	500/400	-	-	18	13.3	20	208-230/1/60	0.4	15	31													
AHU 2-3-1	DAIKIN	FXMQ07	CONCEALED - DUCTED	BLDG 1 - ROOF VESTIBULE	317 / 264 / 229	30	0.2 / 0.4	7.2	6.4	8.5	208-230/1/60	0.6	15	55													
AC 2-3-2	DAIKIN	FXAQ24	WALL MOUNTED - DUCTLESS	BLDG 1 - ELEV MACHINE RM	635 / 470	-	-	24	17.1	26.5	208-230/1/60	0.6	15	31 НР	2-3 RXYQ72	17.7	69	77	13	21.4	3.5	2.4	460/3/60	12.4	15	507	1-10
AC 2-3-3	DAIKIN	FXAQ24	WALL MOUNTED - DUCTLESS	BLDG 1 - ELEV MACHINE RM	635 / 470	_	-	24	17.1	26.5	208-230/1/60	0.6	15	31													

1. PROVIDE ELECTRICAL DISCONNECT SWITCH - INDOOR AND OUTDOOR UNITS

2. PROVIDE ALL INTERCONNECTING CONTROL WIRE, REFRIGRERANT PIPING, AND OUTDOOR UNITS.

3. PROVIDE INDOOR UNIT WITH WALL MOUNTED TEMPERATURE CONTROLS. PROVIDE TAMPERPROOF ENCLOSURES FOR ALL THERMOSTATS LOCATED IN HIGH TRAFFIC AREAS PRONE TO DAMAGE AND TAMPERING.

4. PROVIDE LOW AMBIENT COOLING KITS.

5. PROVIDE EQUIPMENT SUPPORTS PER OUTDOOR UNIT. REFER EQUIPMENT SUPPORT DETAIL.

6. ALL DUCTED UNITS SHALL BE PROVIDED WITH MERV 8 FILTERS W/ REPLACEMENT FILTERS PER UNIT. PROVIDE WASHABLE FILTERS FOR WALL MOUNT TYPE UNITS

7. PROVIDE DRAIN PAN LEVEL SENSORS IN EVAPORATOR DRAIN PANS. INSTALL STAINLESS STEEL SECONDARY DRAIN PAN WITH FLOAT SWITCH UNDER ALL DUCTED UNITS, AND ANY UNITS POSITIONED OVER ELECTRICAL EQUIPMENT. FLOAT SWITCH TO SHUT DOWN UNIT AND ALARM BMS UPON WATER DETECTION.

8. PROVIDE FACTORY MOUNTED BACNET CONTROLLERS PER UNIT. ALL UNITS SHALL BE TIED INTO THE BUILDING MANAGEMENT SYSTEM.

9. REFRIGERANT CHARGE SHOWN IS BASED ON DAIKIN SELECTION SOFTWARE. PROVIDE TOTAL REFRIGERANT CHARGE OF SYSTEM ON SUBMITTAL


10. PROVIDE BUILT IN CONDENSATE PUMP FOR ALL EVAPORATING UNITS

	RE	FRIGERA	NT DENSITY	CALCULATION		
SYSTEM	REFR. TYPE	TOTAL REFR. AMOUNT (LBS)	SMALLEST ROOM ZONE	ZONE SMALLEST SPACE, TOTAL AREA (SQFT.)	ZONE SMALLEST SPACE, TOTAL	REFR. DENSITY (LB/1000FT ³)
CU-1-1, CU-1-2	R410A	36.1	1401, 1402, 1403	970	8533	4.23
CU-1-3	R410A	18.5	1604	143	949	19.49
HP-1-4	R410A	5.3	1602	200	2240	2.37
HP-1-5	R410A	5.3	1120	166	1496	3.54
HP-1-6A, HP-1-6B	R410A	10.6	1010	334	2673	3.97
CU-2-1, CU-2-2	R410A	62.5	2201, 2202, 2203	967	7738	8.08
CU-2-3	R410A	17.7	2701	257	1671	10.59
HP-2-4	R410A	5.3	2702	330	2134	2.48
HP-2-5	R410A	2.5	2005c	128	1024	2.44
HP-2-6A, HP-2-6B	R410A	106	2003	626	4940	2.15
HP-2-7	R410A	5.3	2013a	133	1197	4.43

1. LINE LENGTHS ARE ESTIMATED BY MANUFACTURER VRF DESIGN SOFTWARE. REFRIGERANT LINE LENGTHS,

SIZES & CHARGES TO BE VERIFIED BY EQUIPMENT MANUFACTURER.

2. CONTRACTOR TO NOTIFY ENGINEER IF ADDITIONAL SYSTEM CHARGE IS REQUIRED.

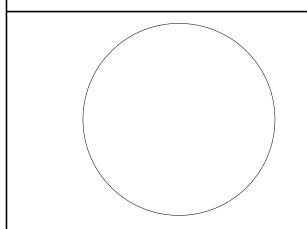

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NJ Landscape Architecture Certificate No.: 21MH00010300 NJ Engineering Certificate of Authorization No.: 24GA28019100

JOHN CHRIS MORRIS III, P.E.
NJ PROFESSIONAL ENGINEER LIC. NO. GE02659900


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JSK/DKR DKR JSK JCM

PROJECT No: DATE: SCALE:

DIGA2301 11/08/2023 AS SHOWN




12.22.2023 Addendum No. 4 12.15.2023 Addendum No. 3

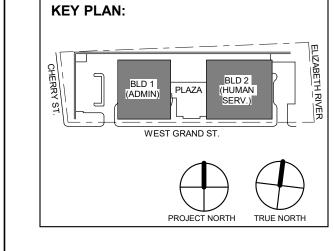12.08.2023 Addendum No. 2 No. Date Description Revisions / Issues

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Jeffrey D. Venezia, AIA NJ RA AI 00827100



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UNION COUNTY IMPROVEMENT AUTHORITY
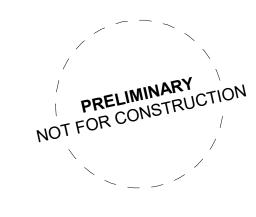
> UNION COUNTY GOVERNMENT COMPLEX

81 & 93 WEST GRAND STREET CITY OF ELIZABETH NEW JERSEY, 07202 Drawing Information:

Project No: 20.072 Date: 11.08.2023 Drawn By: JB/AV/PC Checked By: JM/SH Sheet Name:

BUILDING NO. 1&2 -MECHANICAL SCHEDULES (5 OF

Sheet No:

ROOM #	OCCUPANCY CLASSIFICATION	FLOOR AREA (SF)	NUMBER OF OCCUPANTS	OCCUPANT BASED OA RATE (CFM/OCCUPANT)	AREA BASED OUTSIDE AIR RATE (CFM/SF)	ZONE AIR DISTRIBUTION EFFECTIVENESS (Ez)	TOTAL UNCORRECTED OA REQUIRED (CFM)	TOTAL CORRECTED OA REQUIRED (CFM)	AREA BASED EXHAUST RATE (CFM/ FIXTURE)	REQUIRED EXHAUST (CFM)	NOTES
1001	LOUNGE	817	10	5	0.06	0.8	99	124			
1002	STORAGE	339	0	0	0.12	0.8	41	51			
1003	STORAGE	300	0	0	0.12	0.8	36	45			
1004	STORAGE	480	0	0	0.12	0.8	58	72			
1013	STORAGE	683	0	0	0.12	0.8	82	102			
1014	UTILITY	229	0	0	0.12	0.8	27	34			
1100	LOBBY	3398	15	5	0.06	0.8	279	349			
1101	VESTIBULE	84	0	0	0.06	0.8	5	6			
1102	TOILET	48	-	-	-	-	0	0	50	50	
1103	TOILET	48	-	-	-	-	0	0	50	50	
~11Q4~	~~~QEECE~~~	100~	~~1~~	~~~ ⁵ ~~~	~~ ^{1.0} 6~	~~~~	~~4~~	~~ 14 ~~	~~~	~~~~	~~~
1110	CAFETERIA	953	27	8	0.18	0.8	374	468			
1111	TOILET	60	-	-	-	-			50	50	
1112	STORAGE	73		0	0.12	0.8	9	11	~~~	~~~~	~~-
T	1 1 1 1 1 1 1 1 1 1 1 1 1 1 1 1 1 1 1	Y Y Y	7 7 7 7	7 7 7 7 Y Y	Y - Y - Y	7 7 7 7	7 7 7 7 7	7 7 7 7	7 7 7	7 Y Y Y Y	7 · 7 · Y

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ROOM #	OCCUPANCY CLASSIFICATION	FLOOR AREA (SF)	NUMBER OF OCCUPANTS	OCCUPANT BASED OA RATE (CFM/OCCUPANT)	AREA BASED OUTSIDE AIR RATE (CFM/SF)	ZONE AIR DISTRIBUTION EFFECTIVENESS (Ez)	TOTAL UNCORRECTED OA REQUIRED (CFM)	TOTAL CORRECTED OA REQUIRED (CFM)	AREA BASED EXHAUST RATE (CFM/ FIXTURE)	REQUIRED EXHAUST (CFM)	NOTES
1201	LOBBY	1449	5	5	0.06	0.8	112	140	-	-	-
1202	TOILET	137	-	-	-	-	0	0	50	100	-
1203	JANITORS CLOSET	37	-	-	-	-	0	0	50	50	
1204	TOILET	137	-	-	-	-	0	0	50	100	-
1205	TOILET	67	-	-	-	-	0	0	50	50	-
1210	OFFICE	2208	16	5	0.06	0.8	212	266	-	-	-
1211	OFFICE	160	1	5	0.06	0.8	15	18	-	-	-
1212	OFFICE	128	1	5	0.06	0.8	13	16	-	-	-
1213	OFFICE	128	1	5	0.06	0.8	13	16	-	-	-
1214	OFFICE	226	2	5	0.06	0.8	24	29	-	-	-
1215	OFFICE	125	1	5	0.06	0.8	13	16	-	-	-
1216	OFFICE	127	1	5	0.06	0.8	13	16	-	-	-
1217	OFFICE	128	1	5	0.06	0.8	13	16	-	-	-
1218	OFFICE	132	1	5	0.06	0.8	13	16	-	-	-
1219	OFFICE	233	2	5	0.06	0.8	24	30	-	-	-
1220	OFFICE	233	2	5	0.06	0.8	24	30	-	-	-
1221	OFFICE	164	1	5	0.06	0.8	15	19	-	-	-
1222	OFFICE	126	1	5	0.06	0.8	13	16			
1223	OFFICE	130	1	5	0.06	0.8	13	16			
1224	OFFICE	129	1	5	0.06	0.8	13	16			
1225	OFFICE	126	1	5	0.06	0.8	13	16			
1226	BREAK ROOM	451	8	5	0.06	0.8	67	84			
1227	STORAGE	195	0	0	0.12	0.8	23	29			
1228	STORAGE	101	0	0	0.12	0.8	12	15			
1229	STORAGE	152	0	0	0.12	0.8	18	23			
1230	OFFICE	233	0	0	0.12	0.8	28	35			
1231	OFFICE	138	1	5	0.06	0.8	13	17			
1232	STORAGE	93	0		0.12	0.8	11	14	~~~	~~~	2-0-0-
1240	CONFERENCE	3123	157	5	0.06	0.8	872	1090	y - y - y -		~~~
1242	CONFERENCE	621	32	5	0.06	0.8	137	172			
1242.1	STORAGE	93	0	0	0.12	0.8	11	14			
1243	RECORDING	118	0	10	0.12	0.8	18	23			
1244	STORAGE	43	0	0	0.12	0.8	5	6			
1245	TOILET	64	سسس					مدد	50	50	
1246	LOBBY	663	6	5	0.06	0.8	70	87	~ ~ ~ `	rrrr	rrr


NOTE: ALL OCCUPANCIES PROVIDED ARE BASED ON ARCHITECURAL FURNITURE PLANS

1113 VENDING 208 0 0

1120 STORAGE | 166 | 0 | 0

1120.1 STORAGE 164 0 0

1121 STORAGE 138 0 0

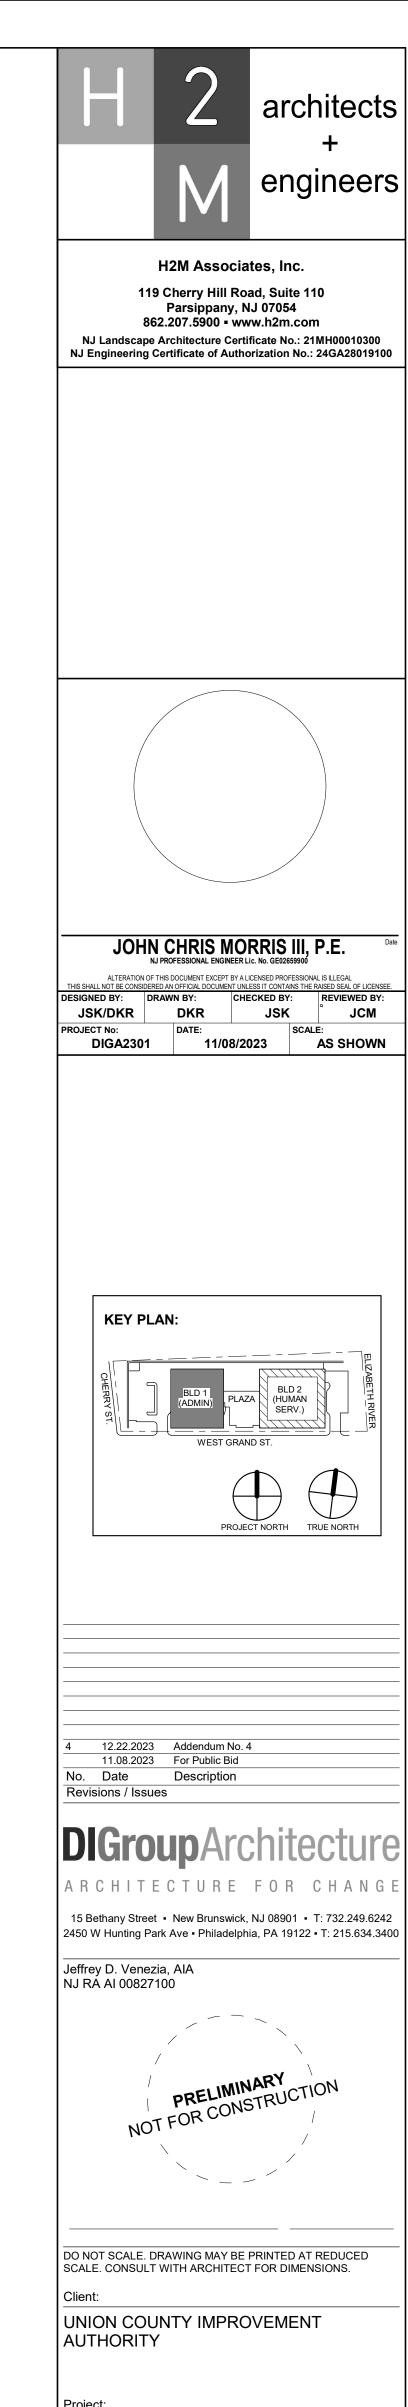

M-406

UNION COUNTY GOVERNMENT

BUILDING NO. 1 - MECHANICAL

81 & 93 WEST GRAND STREET CITY OF ELIZABETH NEW JERSEY, 07202

SCHEDULES (1 OF 3)

COMPLEX

Drawing Information:

Sheet Name:

Sheet No:


Project No: 20.072
Date: 11.08.2023
Drawn By: JB/AV/PC
Checked By: JM/SH

ROOM #	OCCUPANCY CLASSIFICATION	FLOOR AREA (SF)	NUMBER OF OCCUPANTS	OCCUPANT BASED OA RATE (CFM/OCCUPANT)	AREA BASED OUTSIDE AIR RATE (CFM/SF)	ZONE AIR DISTRIBUTION EFFECTIVENESS (Ez)	TOTAL UNCORRECTED OA REQUIRED (CFM)	TOTAL CORRECTED OA REQUIRED (CFM)	AREA BASED EXHAUST RATE (CFM/ FIXTURE)	REQUIRED EXHAUST (CFM)	NOTES
1301	LOBBY	894	1	5	0.06	0.8	59	73	-	-	-
1304	TOILET	68	-	-	-	-	0	0	50	50	-
1305	TOILET	137	-	-	-	-	0	0	50	100	-
1306	JANITORS CLOSET	37	-	-	-	-	0	0	50	50	-
307	TOILET	137	~~~~~~~~~~~~~~~~~~~~~~~~~~~~~~~~~~~~~~	~~~~~~~~~~~~~~~~~~~~~~~~~~~~~~~~~~~~~~	~~~	~~~~~~~~~~~~~~~~~~~~~~~~~~~~~~~~~~~~~~			50	100	~~~~
1310	OFFICE	4510	36	5	0.06	0.8	451	563	-	-	-
311	OFFICE	242	$\frac{1}{2}$	$\frac{1}{5}$	0.06	0.8	25	31		<u> </u>	سيس
312	OFFICE	128	1	5	0.06	0.8	13	16	-	-	-
313	OFFICE	126	1	5	0.06	0.8	13	16	-	-	-
314	OFFICE	127	1	5	0.06	0.8	13	16	-	-	-
315	CONFERENCE	407	8	5	0.06	0.8	64	81	-	-	-
1316	STORAGE	295	0	0	0.12	0.8	35	44	-	-	-
1317	OFFICE	154	1	5	0.06	0.8	14	18			
1318	STORAGE	368	0	0	0.12	0.8	44	55	-	-	-
1319	BREAK RM	101	1	5	0.06	0.8	11	14	-	-	-
1320	OFFICE	3466	21	5	0.06	0.8	313	391	-	-	-
1321	CONFERENCE	162	4	~~~~~ 5	0.06	0.8	30	37	-	-	<u>.</u>
1322	OFFICE	269	9	5	0.06	0.8	61	76	-	-	_
1323	OFFICE	109	سيس	~~~~~~~~~~~~~~~~~~~~~~~~~~~~~~~~~~~~~~	0.06	0.8	12	14	سيس	سيس	سيب
1324	OFFICE	203	2	5	0.06	0.8	22	28	-	-	_
1325	OFFICE	114	~~~~	$\frac{1}{5}$	0.06	0.8	12	15	ستس	<u> </u>	سم
1326	OFFICE	126	1	5	0.06	0.8	13	16	<u>_</u>	<u> </u>	_
1327	OFFICE	m	····	my "	~ ~ ~	mym	13 ~~~~~~~~~~~~~~~~~~~~~~~~~~~~~~~~~~~~	,,,,,,,,,,,,,,,,,,,,,,,,,,,,,,,,,,,,,,	سبب	mun	w
		111	1	5	0.06	0.8	12	15	-	-	<u>-</u>
1328	OFFICE	113	~~~~	$\overline{\cdots}_{\overline{2}}$	0.06	0.8	12	15	~~~~	m-	~~~
1329	LIBRARY	216	6	سىئىس	0.06	······································	43	54	·····	·····	
1330	OFFICE	108	1	5	0.06	0.8	11	14	-	-	-
1331	OFFICE	110	1	5	0.06	0.8	12	15	-	-	-
1332	OFFICE	110	$\frac{1}{1}$	$\phantom{aaaaaaaaaaaaaaaaaaaaaaaaaaaaaaaaaaa$	0.06	0.8	12	15	~~~~	m-	~~~
1333	OFFICE	129		⁵	0.06		13	16	-	·····	-
1334	OFFICE	231	2	5	0.06	0.8	24	30	-	-	-
1335	OFFICE	115	1	5	0.06	0.8	12	15	-	-	-
1336	OFFICE	113	1	5	0.06	0.8	12	15	-	-	-
1337	OFFICE	111	1	5	0.06	0.8	12	15	-	-	-
1338	OFFICE	113	1	5	0.06	0.8	12	15	-	-	-
1339	OFFICE	115	1	5	0.06	0.8	12	15	-	-	-
1340	BREAK RM	113	1	5	0.06	0.8	12	15	-	-	-
1341	STORAGE	176	0	0	0.12	0.8	21	26	-	-	-
1342	STORAGE	285	0	0	0.12	0.8	34	43	-	-	-
1343	OFFICE	68	1	~~~ ⁵ ~~~	0.06	0.8	9	11	~~~~~	~~~~	~~~


NOTE: ALL OCCUPANCIES PROVIDED ARE BASED ON ARCHITECURAL FURNITURE PLANS

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1401	LOBBY	770	1	5	0.06	0.8	51	64	-	-	-
1404	TOILET	68	-	-	-	-	8	10	50	50	-
1405	TOILET	137	-	-	-	-	16	21	50	100	-
1406	JANITORS CLOSET	37	-	-	-	-	0	0	50	50	-
1407	TOILET	137			-0-0-0	-0-0-0-0-0	16	21	50	100	
1410	OFFICE	5171	14	5	0.06	0.8	380	475	-	-	-
1411	OFFICE	130	my 1		0.06	0.8	13	16	سيس	سيس	سيس
1412	OFFICE	130	1	5	0.06	0.8	13	16	-	-	-
1413	OFFICE	243	2	5	0.06	0.8	25	31	-	-	-
1414	OFFICE	130	1	5	0.06	0.8	13	16	-	-	-
1415	OFFICE	116	1	5	0.06	0.8	12	15	-	-	-
1416	OFFICE	115	1	5	0.06	0.8	12	15	-	-	-
1417	OFFICE	115	1	5	0.06	0.8	12	15	-	-	-
1418	STORAGE	117	0	0	0.06	0.8	7	9			
1419	OFFICE	94	1	5	0.06	0.8	11	13	- * * * * * * * * * * * * * * * * * * *	- ** ** ***	-
1420	CONFERENCE	114	4	5	0.06	0.8	27	34	-	-	-
1421	STORAGE	143	mym	mym	0.12	0.8	17	21	سيس	سيس	سيسا
1422	BREAK ROOM	90	1	5	0.06	0.8	10	13	-	-	-
1423	CONFERENCE	421	18	5	0.06	0.8	115	144		-	
- 1430	OFFICE	2416	46	2	0.06	0.8	375	469	- -	-	-
1431	OFFICE	116	1		0.06	0.8	12	15		- -	
1432	OFFICE	228	2	5	0.06	0.8	24	30	-	-	-
1433	OFFICE	115	1	5	0.06	0.8	12	15	-	-	-
1434	BREAK ROOM	124	1	5	0.06	0.8	12	16	-	-	-
1435	CONFERENCE	436	18	5	0.06	0.8	116	145	-	-	-
1436	STORAGE	221	0	0	0.12	0.8	27	33	-	-	-
1437	CONFERENCE	161	5	5	0.06	0.8	35	43	-	-	-
1438	OFFICE	123	_ 1	5	0.06	0.8	12	15			
1440	OFFICE	1960	16	5	0.06	0.8	198	247	~~~~ -	-	-
1441	OFFICE	137	win		0.06	0.8	13	17	~~~		uu

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NJ PROFESSIONAL ENGINEER LIC. No. GE02659900
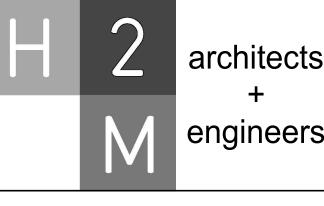
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PROJECT No: DATE: SCALE:
DIGA2301 11/08/2023 AS SHOWN

KEY PLAN:

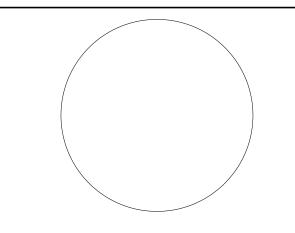4 12.22.2023 Addendum No. 4 11.08.2023 For Public Bid No. Date Description

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Drawing Information: Project No: 20.072
Date: 11.08.2023
Drawn By: JB/AV/PC
Checked By: JM/SH

Sheet Name: BUILDING NO. 1 - MECHANICAL SCHEDULES (2 OF 3)


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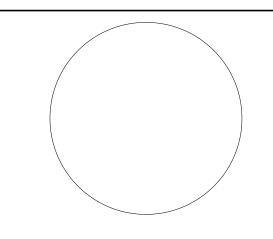
BUILDING-1 VENTILATION SCHEDULE (RTU1-5)

ROOM #	OCCUPANCY CLASSIFICATION	FLOOR AREA (SF)	NUMBER OF OCCUPANTS	OCCUPANT BASED OA RATE (CFM/OCCUPANT)	AREA BASED OUTSIDE AIR RATE (CFM/SF)	ZONE AIR DISTRIBUTION EFFECTIVENESS (Ez)	TOTAL UNCORRECTED OA REQUIRED (CFM)	TOTAL CORRECTED OA REQUIRED (CFM)	AREA BASED EXHAUST RATE (CFM/ FIXTURE)	REQUIRED EXHAUST (CFM)	NOTES	
1500	LOBBY	1518	1	5	0.06	0.8	96	120	-	-	-	
1501	LOUNGE	803	12	5	0.06	0.8	108	135	~~~	~~~~	$\sim\sim$	
1504	TOILET	68	-	-	-	-	8	10	50	50	· · ·	_} _}
1505	TOILET	137	-	-	-	-	16	21	50	100		
1506	JANITORS CLOSET	37	-	-	-	-	0	0	50	50	-	
1507	TOILET	137	-	-	-	-	16	21	50	100	-	
1510	OFFICE	4516	24	5	0.06	0.8	391	488	····	···	~~~~	
1511	CONFERENCE	290	9	5	0.06	0.8	62	78	-		-	}
1512	OFFICE	232	2	5	0.06	0.8	24	30		-	-	7
1513	OFFICE	130	1	5	0.06	0.8	13	16	-	-	-	
1514	OFFICE	133	1	5	0.06	0.8	13	16	-	-	-	
1515	OFFICE	130	1	5	0.06	0.8	13	16	-	-	-	
1516	OFFICE	121	1	5	0.06	0.8	12	15	<u>-</u>	<u>.</u>	~~~~	
1517	OFFICE	1	1	5	0.06	0.8	13	16	-	-	-	$\frac{1}{2}$
1518	OFFICE	411	12	5	0.06	0.8	85	106	-	-	-	3
1519	OFFICE	130	1	5	0.06	0.8	13	16	-	-	-	-\{ \}
1520	STORAGE	149			0.12	0.8	18	22		<u> </u>	-	
1521	STORAGE	181	5	5	0.06	0.8	36	45	-	-	-	
1522	OFFICE	103	1	5	0.06	0.8	11	14	-	-	-	
1523	STORAGE	96	0	0	0.12	0.8	12	14	-	-	-	
1524	STORAGE	279	0	0	0.12	0.8	33	42	-	-	-	
1525	BREAK ROOM	100	1	5	0.06	0.8	11	14	-	-	-	
1530	OFFICE	1775	7	5	0.06	0.8	142	177	-	-	-	
1531	OFFICE	115	1	5	0.06	0.8	12	15	-	-	-	
1532	OFFICE	363	2	5	0.06	0.8	32	40	-	-	-	
1533	CONFERENCE	603	20	5	0.06	0.8	136	170	-	-	-	
1534	TOILET	61	-	-	-	-	-	-	50	-	-	
1534a	TOILET VESTIBULE	74	0	0	0.12	0.8	9	11	-	-	-	
1535	OFFICE	219	2	5	0.06	0.8	23	29	-	-	-	
1536	OFFICE	90	1	5	0.06	0.8	10	13	-	-	-	7
1537	BREAK ROOM	184_	2	5	0.06	0.8	21	26	-	-	<u>-</u>	
1540	OFFICE	2014	22		0.06	0.8	231	287	-	-	-	}
1541	OFFICE	229			0.06	0.8	24	30	سيس	سيس	سيسد	7
1542	CONFERENCE	274	11	5	0.06	0.8	71	89				\dashv

NOTE: ALL OCCUPANCIES PROVIDED ARE BASED ON ARCHITECURAL FURNITURE PLANS



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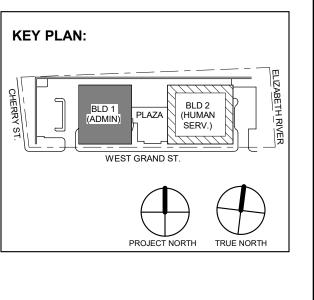
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UNION COUNTY IMPROVEMENT AUTHORITY

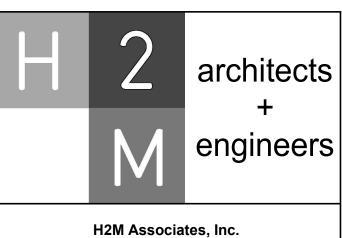Project:

UNION COUNTY GOVERNMENT COMPLEX 81 & 93 WEST GRAND STREET CITY OF ELIZABETH NEW JERSEY, 07202

Drawing Information:

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Drawn By: JB/AV/PC

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Sheet Name:
BUILDING NO. 1 - MECHANICAL
SCHEDULES (3 OF 3)

Sheet No:


ROOM # 2000											
u m	ROOM DESCRIPTION	FLOOR AREA (SQFT)	TOTAL OCCUPANTS	PEOPLE OA RATE (CFM/PERSON)	AREA OUTDOOR AIR RATE (CFM/SQFT)	EZ	UNCORR. CFM	DESIGN CFM	AREA BASED EXHAUST RATE (CFM/ FIXTURE)	REQUIRED EXHAUST (CFM)	NOTES
بببر	VESTIBULE	161		~~~~~~~~~~~~~~~~~~~~~~~~~~~~~~~~~~~~~~	0.06	0.8	10	12	<u>.</u>	<u> </u>	<u>.</u>
2001	LOBBY	2203	30	~~~~~~~~~~~~~~~~~~~~~~~~~~~~~~~~~~~~~~	0.06	<u> </u>	282	353	muyum	wyw	سيس
2001A	VESTIBULE	161	0	5	0.06	0.8	10	12	-	-	-
2004	OFFICE	128	1	5	0.06	0.8	13	16	-	-	-
2005	BREAK RM	276	2	5	0.12	0.8	43	54	-	-	-
2005A	TOILET	58	0	0	0.00	0.8	0	0	50	50	-
2005B	LOCKER	187		\dots	0.00	0.8	, O		0.25 CFM/SF	37	<u>-</u>
2005C	LOCKER	135	my m	mym	0.00	<u>0.8</u>	nyu	سيس	0.25 CFM/SF		سبسا
2006	OFFICE	225	2	~~~~~~~~~~~~~~~~~~~~~~~~~~~~~~~~~~~~~~	0.06	0.8	24	29	-	-	-
2007	CORR	137	ستس	Luiuu	0.06	0.8		10	<u>.</u>		
2008	VESZTIBULE	438	سپ	٠٠٠٠٠٠٠٠٠٠٠٠٠٠٠٠٠٠٠٠٠٠٠٠٠٠٠٠٠٠٠٠٠٠٠٠٠	0.06	0.8	26	33	-	-	
2009	LOBBY	1246	30	5	0.06	0.8	225	281	-	-	- 1
2009		126	ستس	سسيسسا	0.00	0.0	13	16	······································	min	لسيا
2010	TOILET	71	0	سئس	0.00	0.8	المراب	0	50	50	~~~
<u> </u>	STO	163								30	
2012			0	0	0.00	0.8	0	0	-	-	- 3
2013	OFFICE	1034 	6	⁵	0.00	0.8	30	38	······		-
2101	LOBBY	946	0	5	0.06	0.8	57	71	-	-	-
2104	TOILET	73	0	0	0.00	0.8	0	0	50	50	-
2105	TOILET	137	0	0	0.00	0.8	0	0	50	100	-
2106	JC	37	0	0	0.00	0.8	0	0	50	50	-
2107	TOILET	138	0	0	0.00	0.8	0	0	50	100	-
2108	CORR	95	~~~~~	~~~~~~~~~~~~~~~~~~~~~~~~~~~~~~~~~~~~~~	0.06	0.8	6	7~~~	· · · · · · · · · · · · · · · · · · ·		- -
2109	OFFICE	5767	150	5	0.06	0.8	1096	1370	-	-	-
2110	OFFICE	114	1	5	0.06	0.8	12	15	-	-	-
2111	OFFICE	112	1	5	0.06	0.8	12	15	-	-	-
2112	OFFICE	112	1	5	0.06	0.8	12	15	-	-	-
2113	CONFERENCE	149	4	5	0.06	0.8	29	36	-	-	-
2114	OFFICE*	164	0	0	0.12	0.8	20	25	-	-	-
2115	OFFICE	108	1	5	0.06	0.8	11	14	-	-	-
2116	OFFICE	110	1	5	0.06	0.8	12	15	-	-	-
2117	LOBBY	141	2	5	0.06	0.8	18	23	-	-	-
2118	TOILET	64	0	0	0.00	0.8	0	0	50	50	-
2119	OFFICE	89	1	5	0.06	0.8	10	13	-	-	-
2119a	STO	72	0	0	0.12	0.8	9	11	-	-	-
2121	STO	97	0	0	0.12	0.8	12	15	-	_	-
2122	OFFICE	142	2	5	0.06	0.8	19	23	-	_	-
<u>2122</u>		228	9	5	0.06	_0.8_	59	_ 73		_	_
2124	WAITING	3097	71	5 5	0.06	0.8	541	676	······································	·····	<u> </u>
	OFFICE	664							-	-	-
2125 2126	OFFICE	156 O	9	5	0.06	0.8 	85 	106 	•••••	·······································	ر ا

NOTE: ALL OCCUPANCIES PROVIDED ARE BASED ON ARCHITECURAL FURNITURE PLANS www.www.www

ROOM #	OCCUPANCY CLASSIFICATION	FLOOR AREA (SF)	NUMBER OF OCCUPANTS	OCCUPANT BASED OA RATE (CFM/OCCUPANT)	AREA BASED OUTSIDE AIR RATE (CFM/SF)	ZONE AIR DISTRIBUTION EFFECTIVENESS (Ez)	TOTAL UNCORRECTED OA REQUIRED (CFM)	TOTAL CORRECTED OA REQUIRED (CFM)	AREA BASED EXHAUST RATE (CFM/ FIXTURE)	REQUIRED EXHAUST (CFM)	NOTES
2201	LOBBY	806	0	5	0.06	0.8	48	60	-	-	-
2204	TOILET	73	-	-	-	-	0	0	50	50	-
2205	TOILET	137	-	-	-	-	0	0	50	100	-
2206	JANITORS CLOSET	37	-	-	-	-	0	0	50	50	-
2207	TOILET	138	-	-	-	-	0	0	50	100	-
2208	CORRIDOR	116	0	0	0.06	0.8	7	9			
2209	OFFICE	12516	123	5	0.06	0.8	1366	1707	-	-	-
2210	OFFICE	110	1	5	0.06	0.8	12	15	-	-	
2211	OFFICE	112	1	5	0.06	0.8	12	15	-	-	-
2212	OFFICE	110	1	5	0.06	0.8	12	15	-	-	-
2213	OFFICE	110	1	5	0.06	0.8	12	15	-	-	-
2214	OFFICE	132	1	5	0.06	0.8	13	16	-	-	-
2215	OFFICE	114	1	5	0.06	0.8	12	15	-	-	-
2216	OFFICE	113	1	5	0.06	0.8	12	15	-	-	-
2217	OFFICE	111	1	5	0.06	0.8	12	15	-	-	-
2218	OFFICE	113	1	5	0.06	0.8	12	15	-	-	-
2219	OFFICE	113	1	5	0.06	0.8	12	15	-	-	-
2220	CONFERENCE	253	10		0.06	0.8	65	81	- -	- محمحم	<u>-</u>
ىرىر 2221	OFFICE	4	mym	$\frac{1}{5}$	0.06	0.8	~~~~~~~~~~~~~~~~~~~~~~~~~~~~~~~~~~~~~~	15 T	سيس	سىيىس	سيس
2222	OFFICE	111	1	5	0.06	0.8	12	15	-	-	-
2223	OFFICE	112	1-0-1-0-0	5-0-0	0.06	0.8	12	15			-
2224	OFFICE	152	1	5	0.06	0.8	14	18	-	-	-
2225	OFFICE	112	1	5	0.06	0.8	12	15	-	- -	
2226	OFFICE	113	1	5	0.06	0.8	12	15	-	-	-
2227	STORAGE	502	0 0		0.12	0.8	60	75	-	-0-0-0-0-1	-
2228	OFFICE	122	1	5 5	0.06	0.8	12	15	-	- -	-
2229	OFFICE	1295	16	5	0.06	0.8	158	197	-	-	-
2230	OFFICE	735	18	5	0.06	0.8	134	168	-	-	-
ىپىر 2231	OFFICE	91	$\frac{1}{2}$		0.06	0.8	15	19	سيس	سيس	سيس
2232	OFFICE	81	2	5	0.06	0.8	15	19	_	-	_

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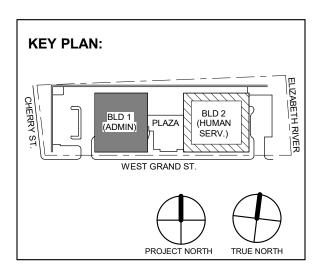
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JSK/DKR DKR JSK JCM

PROJECT No: DATE: SCALE:
DIGA2301 11/08/2023 AS SHOWN

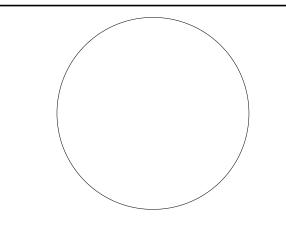

4 12.22.2023 Addendum No. 4
3 12.15.2023 Addendum No. 3
11.08.2023 For Public Bid
No. Date Description

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Jeffrey D. Venezia, AIA NJ RA AI 00827100



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Drawing Information: Project No: 20.072
Date: 11.08.2023
Drawn By: JB/AV/PC
Checked By: JM/SH

Sheet Name: BUILDING NO. 2 - MECHANICAL SCHEDULES (1 OF 4)


Sheet No:

ROOM #	OCCUPANCY CLASSIFICATION	FLOOR AREA (SF)	NUMBER OF OCCUPANTS	OCCUPANT BASED OA RATE (CFM/OCCUPANT)	AREA BASED OUTSIDE AIR RATE (CFM/SF)	ZONE AIR DISTRIBUTION EFFECTIVENESS (Ez)	TOTAL UNCORRECTED OA REQUIRED (CFM)	TOTAL CORRECTED OA REQUIRED (CFM)	AREA BASED EXHAUST RATE (CFM/ FIXTURE)	REQUIRED EXHAUST (CFM)	NOTES
2301	LOBBY	862	0	5	0.06	0.8	52	65	-	-	-
2304	TOILET	73	-	-	-	-	0	0	50	50	-
2305	TOILET	137	-	-	-	-	0	0	50	100	-
2306	JANITORS CLOSET	37	-	-	-	-	0	0	50	50	-
2307	TOILET	138	-	-	-	-	0	0	50	100	-
2308	CORRIDOR	114	0	·····	~~~~	0.8				<u>.</u>	
2309	CORRIDOR	309	0	-	-	0.8	0	0	-	-	-
2310	OFFICE	4589	24	5	0.06	0.8	395	494	-	-	-
2310	BREAK ROOM	145	1	$\frac{1}{5}$	0.06	0.8	14	17	····	<u> </u>	
2311	OFFICE	112	1	5	0.06	0.8	12	15	-	-	-
2312	OFFICE	165	1	5	0.06	0.8	15	19	-	-	-
2313	OFFICE	232	2	5	0.06	0.8	24	30	-	-	-
2314	OFFICE	110	1	5	0.06	0.8	12	15	-	-	-
2315	OFFICE	112	1	5	0.06	0.8	12	15			
2316	CONFERENCE	516	16	5	0.06	0.8	111	139	-	-	-
كىپ 2317	OFFICE	176	1	$\frac{1}{5}$	0.06	0.8	16	19	سيس	<u> </u>	
2318	STORAGE	2552		0	0.12	0.8	306	383	-	-	-
2319	STORAGE	~~~~~~~~~~~~~~~~~~~~~~~~~~~~~~~~~~~~~~	uyu	····	0.12	William	wyw.	49	nin	سيس	سيس
2320	OFFICE	515	9	5	0.06	0.8	76	95	-	-	-
2320	OFFICE	586	1	5	0.06	0.8	40	50	-	-	-
2321	STORAGE	382	0	0	0.12	0.8	46	57	-	-	-
2322	OFFICE	497	2	5	0.06	0.8	40	50	-	-	-
2323	CONFERENCE	378	13	5	0.06	0.8	88	110	-	-	-
2324	OFFICE	243	2	5	0.06	0.8	25	31	-	-	-
2325	OFFICE	725	4	5	0.06	0.8	64	79	-	-	-
2326	STORAGE	151	0	0	0.12	0.8	18	23	-	-	-
2340	BREAK ROOM	1241	35	8	0.18	0.8	486	607	-	-	- }~~~
2341 2341	OFFICE	1087	~~~~~~~~~~~~~~~~~~~~~~~~~~~~~~~~~~~~~~	my the	0.06		255	319	سيس	سيسا	سيس
2342	OFFICE	1136	38	5	0.06	0.8	258	323	-	-	<u> </u>
2343	OFFICE	1159	38	5	0.06	0.8	260	324	-	-	-
2344	STORAGE	203	0	0	0.12	0.8	24	30	_	_	


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2401	LOBBY	814	0	5	0.06	0.8	49	61	-	-	-
2404	TOILET	73	-	-	-	-	0	0	50	50	-
2405	TOILET	137	-	-	-	-	0	0	50	100	-
2406	JANITORS CLOSET	37	-	-	-	-	0	0	50	50	-
2407	TOILET	138	-	-	-	-	0	0	50	100	-
2408	CORRIDOR	116	0	0	0.06	0.8	7	9	-	-	-
2410	OFFICE	3086	21	5	0.06	0.8	290	363	-	-	-
2411	BREAK ROOM	98	1	5	0.06	0.8	11	14	-	-	-
2412	STORAGE	287	0	0	0.12	0.8	34	43	-	-	-
2413	OFFICE	117	1	5	0.06	0.8	12	15	-	-	-
2414	OFFICE	127	1	5	0.06	0.8	13	16	-	-	-
2415	OFFICE	114	1	5	0.06	0.8	12	15	-	-	-
2416	OFFICE	113	1 0	5	0.06	0.8	2 2 2	15		· · · · · · · · · · · · · · · · · · ·	
2420	OFFICE	7712	64	5	0.06	0.8	783	978	-	-	<u> </u>
2421 2422 2423	OFFICE OFFICE	122 111	1	5	0.06	0.8	12	15	-		
2424	OFFICE	130	1 0	5 0 0	0.06	0.8	13	16	-		-
2425	OFFICE	129	1	5	0.06	0.8	13	16	-	-	<u> </u>
2426	OFFICE	129	1	5	0.06	0.8	13	16	-	-	-
2427	OFFICE	98	1	$\frac{1}{5}$	0.06	0.8	11	14	<u> </u>	سيس	سيد
2428	STORAGE	374	0	0	0.12	0.8	45	56	-	-	-
2429	BREAK ROOM	109	1	5	0.06	0.8	12	14	-	-	-
2430	OFFICE	111	1	5	0.06	0.8	12	15	-	-	-
2431	OFFICE	129	1	5	0.06	0.8	13	16	-	-	-
2432	OFFICE	115	1	5	0.06	0.8	12	15	-	-	-
2433	OEFICE	111	~~ ¹ ~~	\sim 5	~ ¹ 6~	~~ ¹⁸ ~~	~~ ¹² ~~~	~~ ¹⁵ ~~~	~~~~	~~~~	~~~~
2434	CONFERENCE	395	16	5	0.06	0.8	104	130	-	-	-
2440	OFFICE	2454	20	5	0.06	0.8	247	309	-		-
2441	OFFICE	130	1	5	0.06	0.8	13	16	-	<u> </u>	-
2442	OFFICE	115	1	5	0.06	0.8	12	15	-	-	-
2443	OFFICE	114	1	5	0.06	0.8	12	15	-	-	-
2444	OFFICE	111	1	5	0.06	0.8	12	15	-	-	-
2445	OFFICE	131	1	5	0.06	0.8	13	16	-	-	-
2446	BREAK ROOM	74	1	5	0.06	0.8	9	12	-	-	-
2447	STORAGE	673	0	0	0.12	0.8	81	101	_	_	_

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JSK/DKR DKR JSK

PROJECT No: DATE: SCALE:

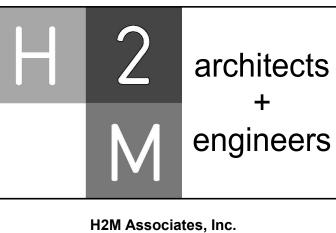DIGA2301 11/08/2023 AS SHOWN

KEY PLAN:

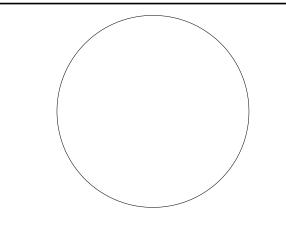CHERRY OT.

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(ADMIN)
PLAZA
(HUMAN SERV.)

WEST GRAND ST.

PROJECT NORTH
TRUE NORTH

4 12.22.2023 Addendum No. 4 11.08.2023 For Public Bid No. Date Description

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Drawing Information:

Project No: 20.072

Date: 11.08.2023

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Checked By: JM/SH


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BUILDING NO. 2 - MECHANICAL
SCHEDULES (2 OF 4)


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2501	LOBBY	946	0	5	0.06	0.8	57	71	-	-	-
2504	TOILET	73	-	-	-	-	0	0	50	50	-
2505	TOILET	137	-	-	-	-	0	0	50	100	-
2506	JANITORS CLOSET	37	-	-	-	-	0	0	50	50	-
2507	TOILET	138	-	-	-	-	0	0	50	100	-
2508	CORRIDOR	95	0		0.06	0.8	6	7		····	·-
2509	OFFICE	3161	21	~~~5~~~	- بالاس ساكات	millin	295	368			
2510	OFFICE	102	1	5	0.06	0.8	11	14	-	-	-
2511	OFFICE	405	3	5	0.06	0.8	24	30	-	-	-
2512	OFFICE	113	1	5	0.06	0.8	12	15	-	-	-
2513	OFFICE	110	1	5	0.06	0.8	12	15	-	-	-
2514	OFFICE	113	1	5	0.06	0.8	12	15	-	-	-
2515	OFFICE	112	1	5	0.06	0.8	12	15	-	-	-
2516	OFFICE	178	1	5	0.06	0.8	16	20	-	-	-
2517	OFFICE	115	1	5	0.06	0.8	12	15	-	-	-
2518	OFFICE	112	1	5	0.06	0.8	12	15	-	-	-
2519	CONFERENCE	169	4	5 0 0	0.06	0.8	30	38			<u>.</u>
2520	CONFERENCE	357	14	5	0.06	0.8	91	114	-	-	<u>~ ~ ~</u>
2521	OFFICE	2604	8	5	0.06	0.8	196	245	-	-	-
2522	OFFICE	124	1	5	0.06	0.8	12	16	-	-	-
ىر 2523	OFFICE	155	1	$\frac{1}{5}$	0.06	0.8	14	18	·····	سيس	سيس
2524	OFFICE	179	1	5	0.06	0.8	16	20	-	-	-
2525	OFFICE	112	1	5	0.06	0.8	12	15	-	-	-
2526	OFFICE	115	1	5	0.06	0.8	12	15	-	-	-
2527	STORAGE	314	0	0	0.12	0.8	38	47	-	-	-
2528	OFFICE	101	1	5	0.06	0.8	11	14	-	-	-
2529	STORAGE	534	mon	man of the second	0.12	0.8	64	80	<u>-</u> مرمم	···	<u>.</u> مئیر
2530	OFFICE	152	1	~~~~~~~~~~~~~~~~~~~~~~~~~~~~~~~~~~~~~~	0.06	0.8	14	18	-	<u> </u>	<u> </u>
2531	OFFICE	153	1	5	0.06	0.8	14	18	-	-	-
2532	OFFICE	114	1	5	0.06	0.8	12	15	-	-	-
2533	OFFICE	230	2	5	0.06	0.8	24	30	-	-	-
2534	STORAGE	286	0	0	0.12	0.8	34	43	-	-	-
2535	BREAK ROOM	139	1	5	0.06	0.8	13	17	<u> </u>	-	<u> </u>
2536	CONFERENCE	548	14	5	0.06	0.8	103	129	<u>-</u>	-	-
2537	OFFICE	4770	16	5	0.06	0.8	366	458	-	-	
2538	OFFICE	177	<u> </u>	$\frac{1}{5}$	0.06	0.8	16	20	سيس	سيس	سيب
2539	OFFICE	117	1	5	0.06	0.8	12	15	-	-	-
2540	OFFICE	129	1		~~~~~~~~~~~~~~~~~~~~~~~~~~~~~~~~~~~~~~	~~~~~~~~~~~~~~~~~~~~~~~~~~~~~~~~~~~~~~	13 ···	16	<u>.</u> -	ستس	<u> </u>
2541	OFFICE	102	<u> </u>	~~~~~~~~~~~~~~~~~~~~~~~~~~~~~~~~~~~~~~	0.06	0.8	11	14	سبب	سيسا	سيس
2542	STORAGE	322	0	•	0.12	0.8	39	48	-	-	-
2543	BREAK ROOM	90	1	5	0.06	0.8	10	13	-	_	-
2544	OFFICE	1878	mgm,	$\frac{1}{\sqrt{1+\frac{1}{2}}}$	0.06	~~~~~	~~~~	197	~~~	~~~~	~~~

NOTE: ALL OCCUPANCIES PROVIDED ARE BASED ON ARCHITECURAL FURNITURE PLANS



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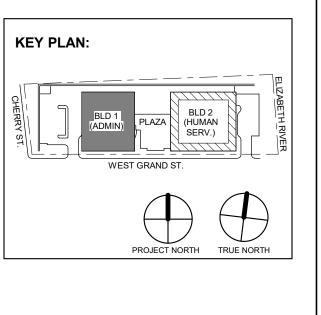
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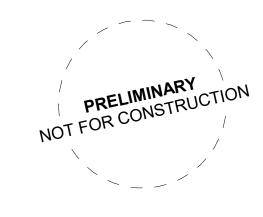
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UNION COUNTY IMPROVEMENT AUTHORITY
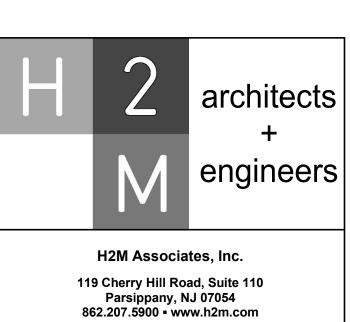
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Drawing Information:

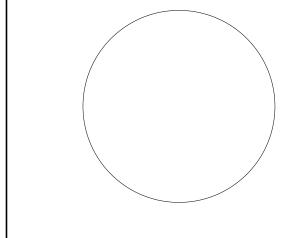Project No: 20.072
Date: 11.08.2023
Drawn By: JB/AV/PC
Checked By: JM/SH

Sheet Name: **BUILDING NO. 2 - MECHANICAL** SCHEDULES (3 OF 4)


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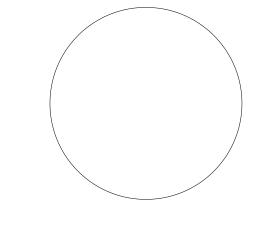
BUILDING-2 VENTILATION SCHEDULE (RTU 2-6)

ROOM #	OCCUPANCY CLASSIFICATION	FLOOR AREA (SF)	NUMBER OF OCCUPANTS	OCCUPANT BASED OA RATE (CFM/OCCUPANT)	AREA BASED OUTSIDE AIR RATE (CFM/SF)	ZONE AIR DISTRIBUTION EFFECTIVENESS (Ez)	TOTAL UNCORRECTED OA REQUIRED (CFM)	TOTAL CORRECTED OA REQUIRED (CFM)	AREA BASED EXHAUST RATE (CFM/ FIXTURE)	REQUIRED EXHAUST (CFM)	NOTES
2601	LOBBY	817	0	5	0.06	0.8	49	61	-	-	-
2604	TOILET	73	-	-	-	-	0	0	50	50	-
2605	TOILET	137	-	-	-	-	0	0	50	100	-
2606	JANITORS CLOSET	37	-	-	-	-	0	0	50	50	-
2607	TOILET	138	-	-	-	-	0	0	50	100	-
2609	OFFICE	802	4	5	0.06	0.8	68	85	····	···	·····
2610	OFFICE	573	9	5	0.06	0.8	79	99	-	-	-
2611	CONFERENCE	973	31	5	0.06	0.8	213	267	-	-	-
2612	OFFICE	112	1	5	0.06	0.8	12	15	<u> </u>	<u></u>	<u> </u>
2613	OFFICE	110	1	5	0.06	0.8	12	15	-	-	-
2614	OFFICE	114	1	5	0.06	0.8	12	15	~~~~	···-	·····
2615	OFFICE	3328	24	5	0.06	0.8	320	400	-	-	-
2620	OFFICE	7394	63	5	0.06	0.8	759	948	-	-	-
2621	CONFERENCE	343	10	5	0.06	0.8	71	88	<u> </u>	<u> </u>	•
2622	OFFICE	125	1	5	0.06	0.8	13	16	-	-	-
2623	BREAK ROOM	83	1	5	0.06	0.8	10	12	~~~~~	····	····
2624	STORAGE	110	1	5	0.06	0.8	12	15	-	-	-
2625	STORAGE	454	0	0	0.12	0.8	0	0	-	-	-
2626	OFFICE	145	1	5	0.06	0.8	14	17	-	-	-
2627	OFFICE	108	1	5	0.06	0.8	11	14	-	-	-
2628	OFFICE	127	1	5	0.06	0.8	13	16			
2629	CONFERENCE	350	10	5	0.06	0.8	71	89	····		·····
2629	OFFICE	350	14	5	0.06	0.8	91	114	-	-	-
2630	OFFICE	2301	9	5	0.06	0.8	183	229	-	-	
2631	OFFICE	88	1	5	0.06	0.8	10	13	-	-	-
2632	BREAK ROOM	90	1	5	0.06	0.8	10	13	-	-	-

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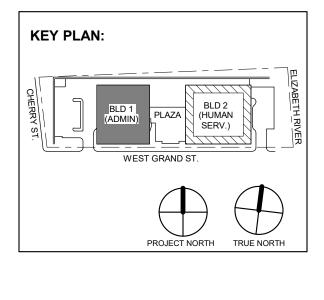
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3 12.15.2023 Addendum No. 3
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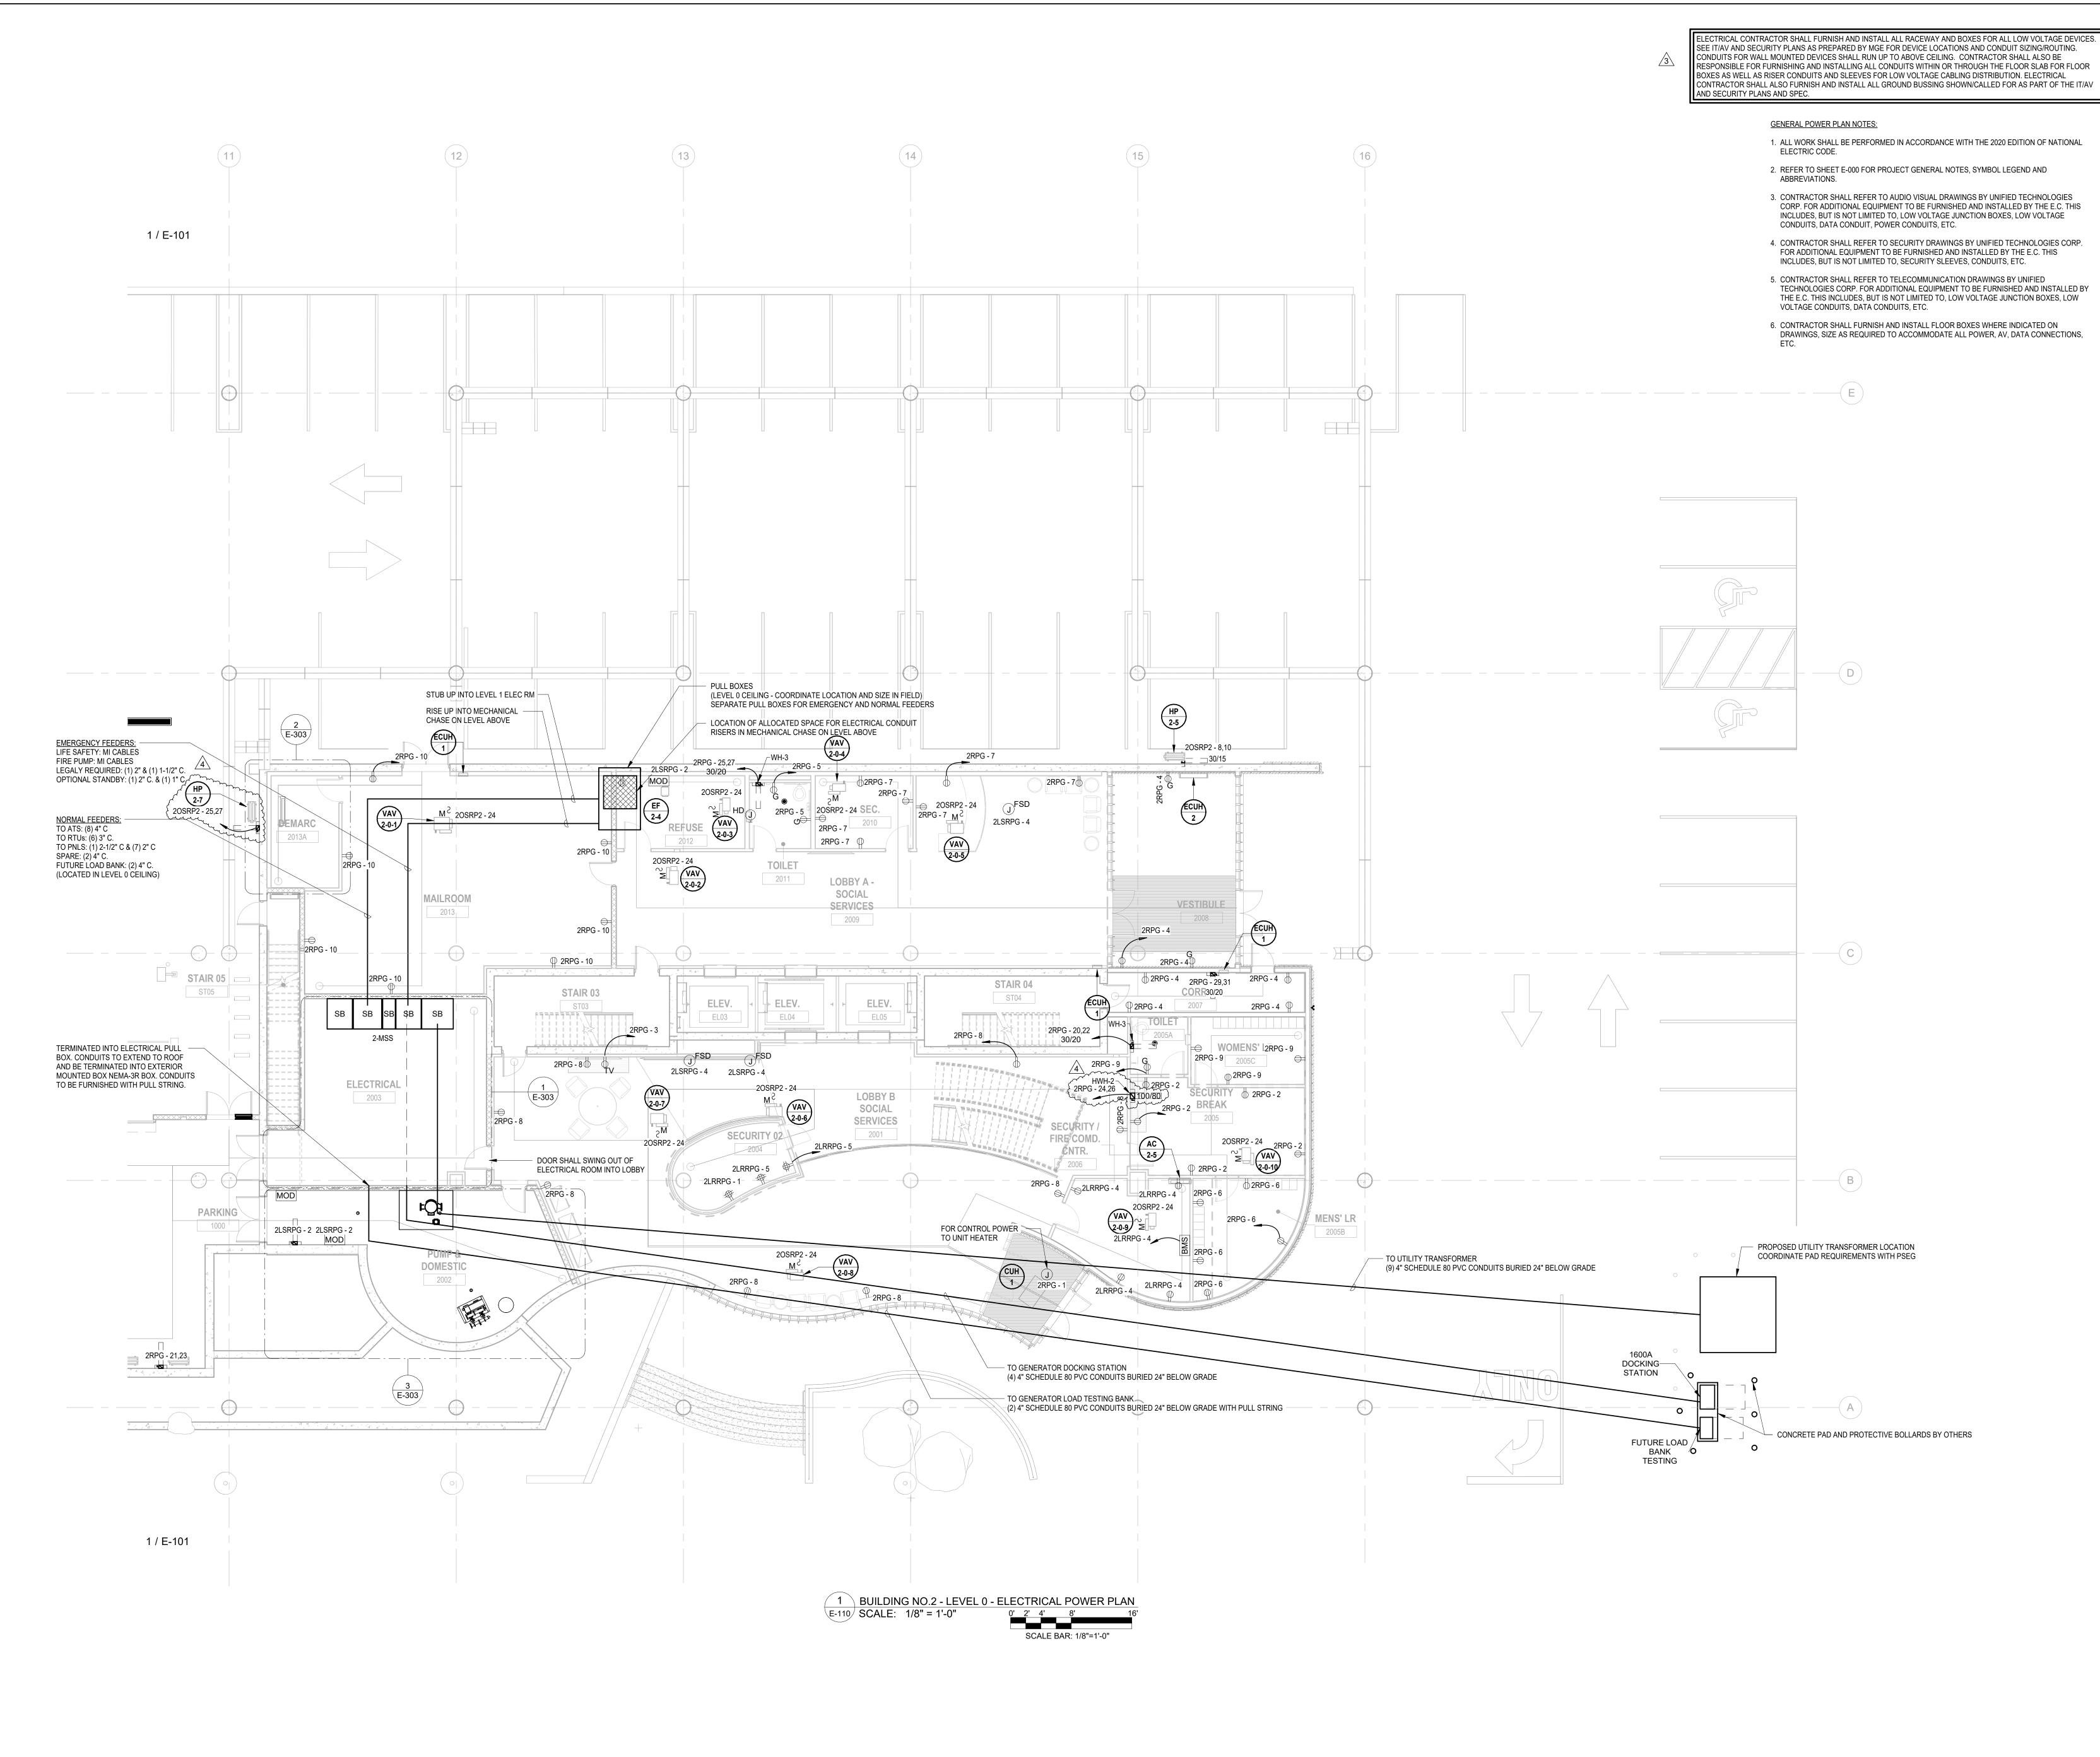
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Sheet Name: **BUILDING NO. 2 - MECHANICAL**

SCHEDULES (4 OF 4)

Sheet No:
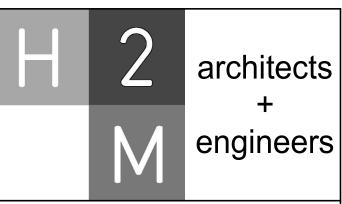
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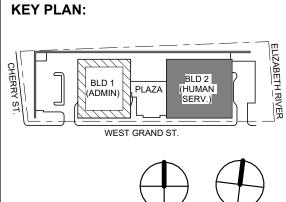
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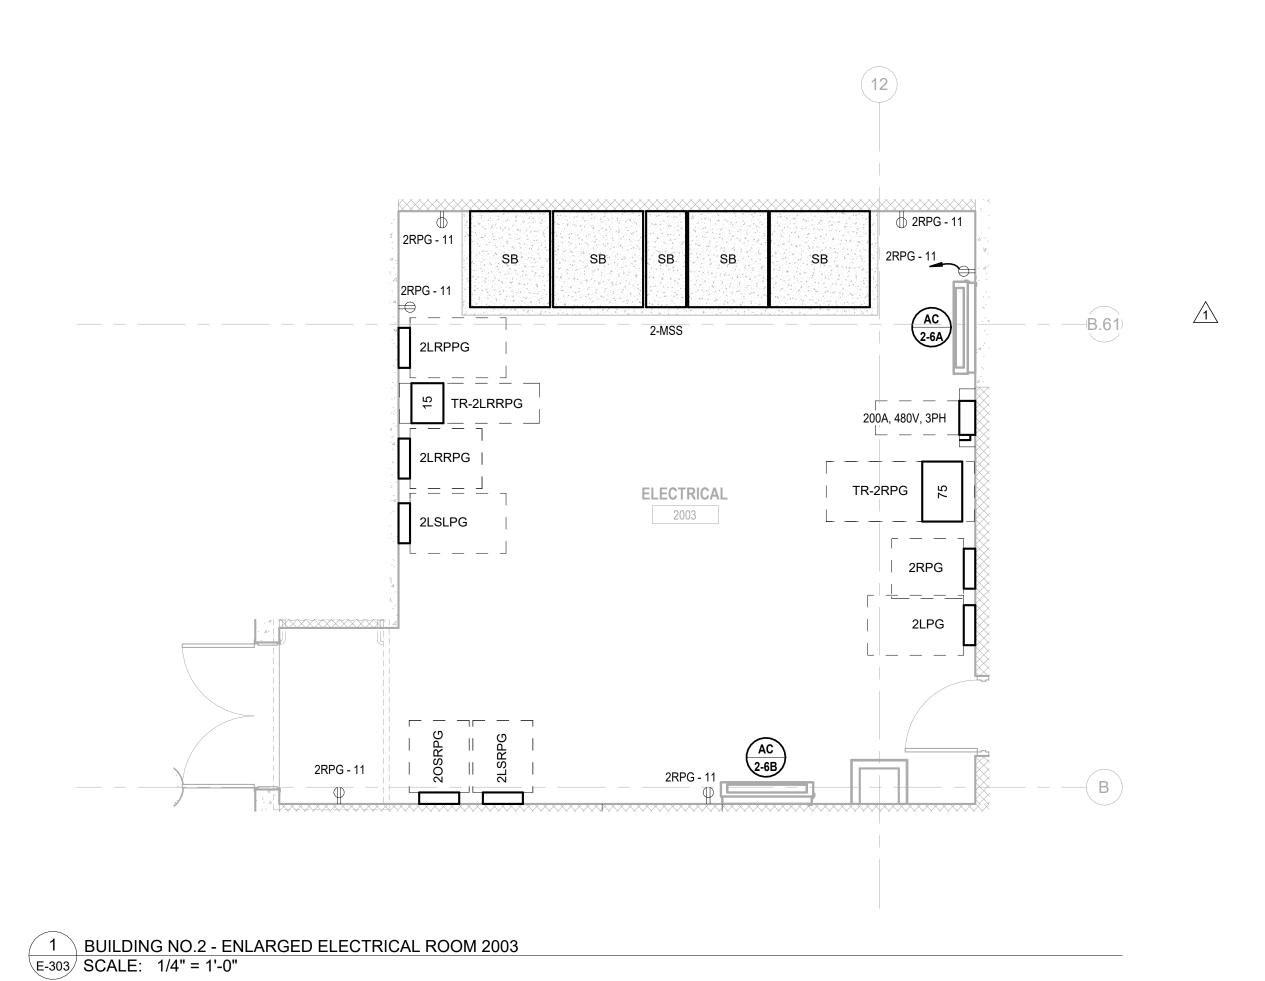
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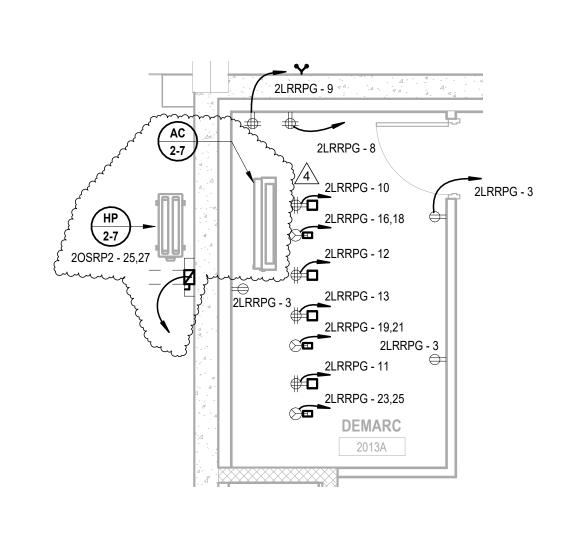
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BUILDING NO. 2 - LEVEL 0 -**ELECTRICAL POWER PLAN**


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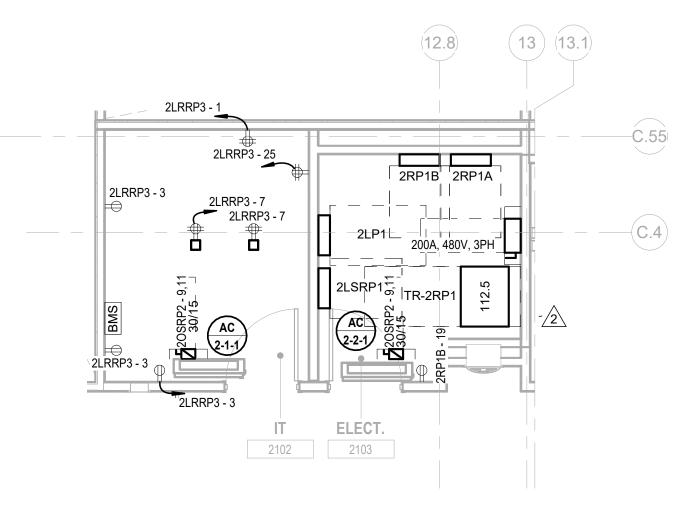





BUILDING NO.2 - LEVEL 0 - ELECTRICAL POWER PLAN - DEMARC. ROOM SCALE: 1/4" = 1'-0"





BUILDING NO.2 - ENLARGED GARAGE LEVEL PUMP ROOM SCALE: 1/4" = 1'-0"

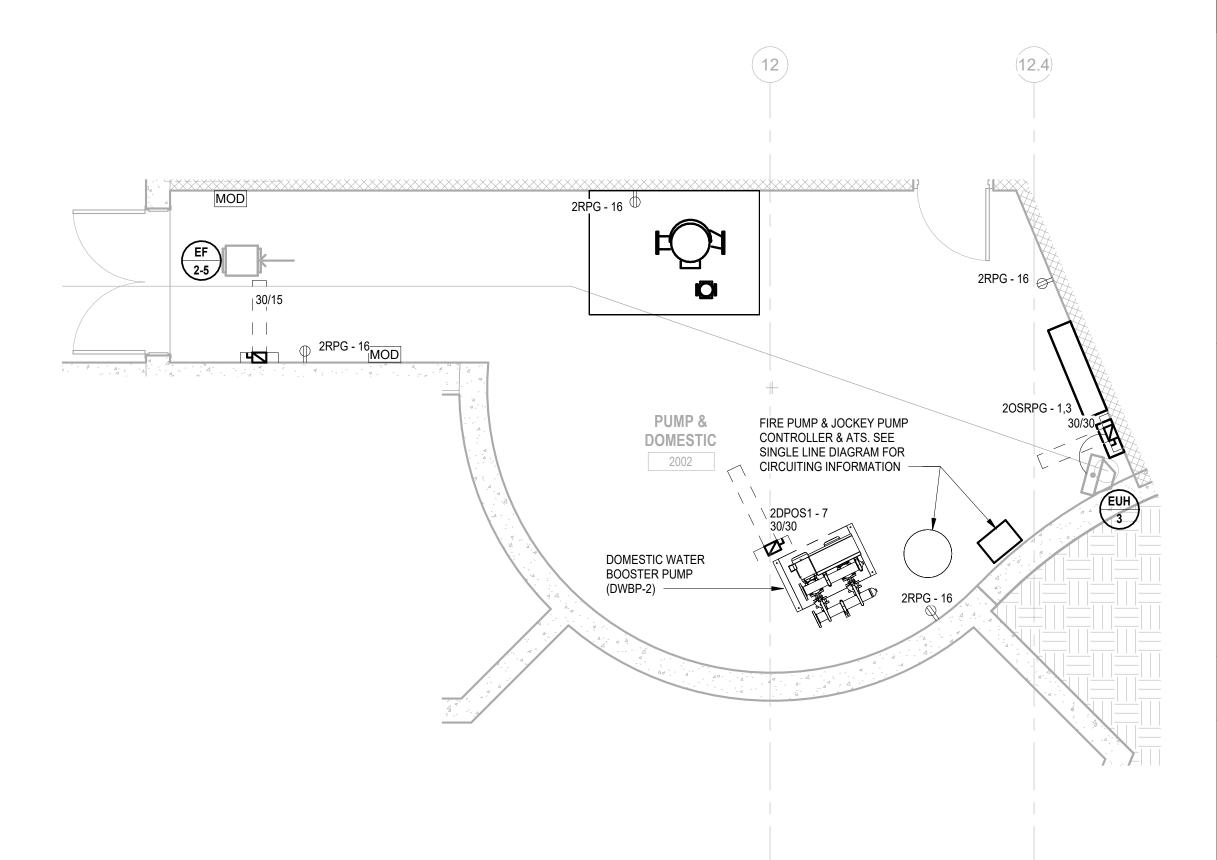

4 BUILDING NO.2 - ENLARGED ELEC 2103 & IT 2102 E-303 SCALE: 1/4" = 1'-0"

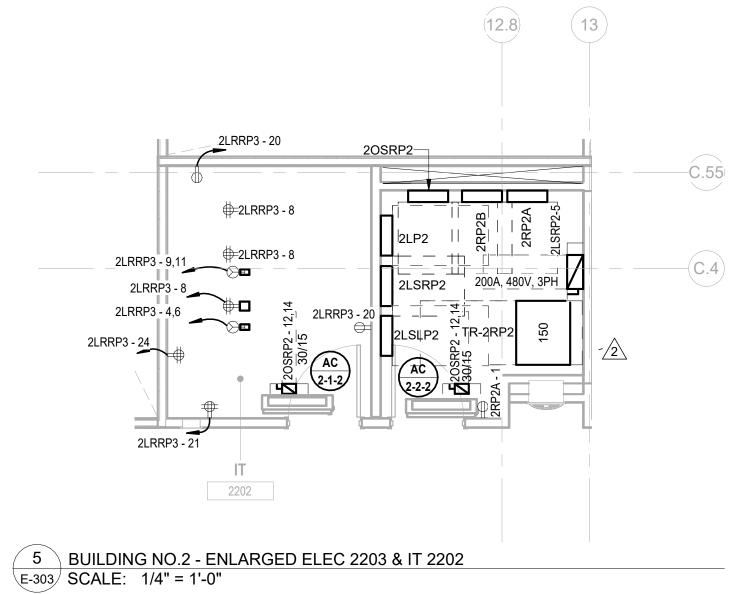

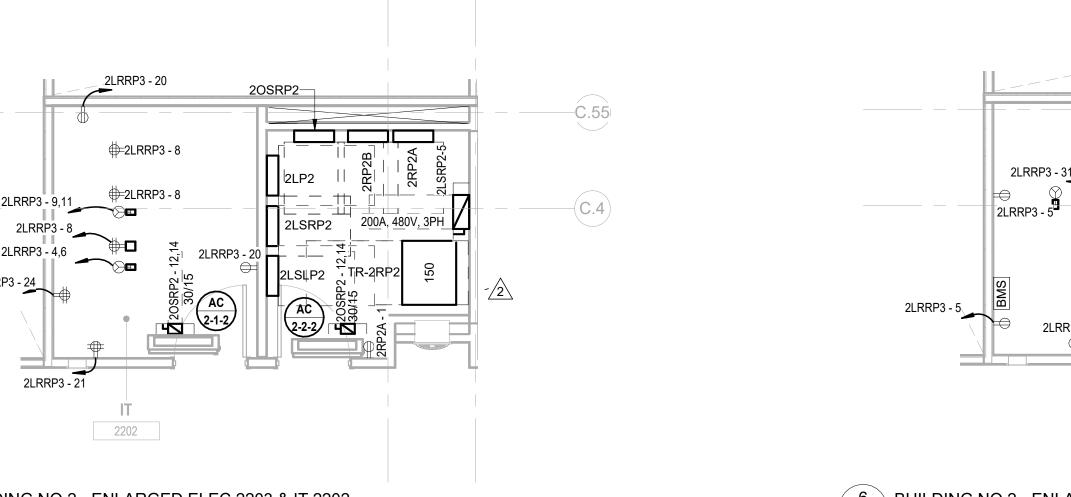

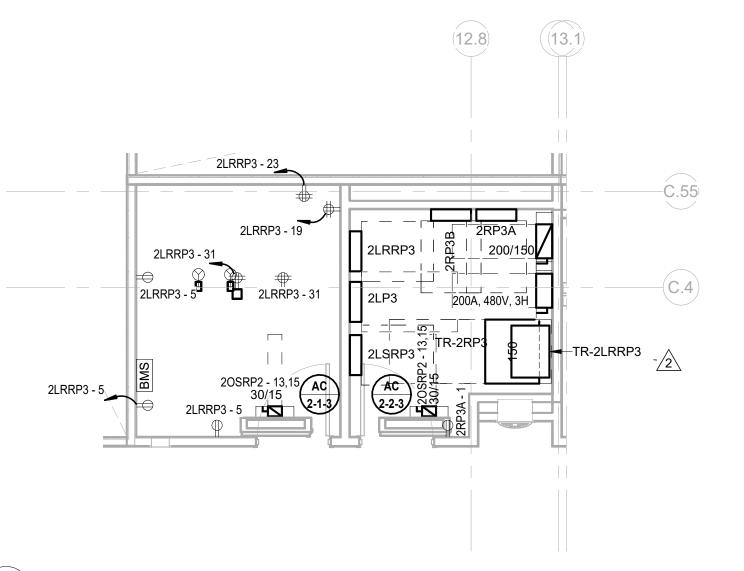

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Project No: 20.072
Date: 11.08.2023
Drawn By: JB/AV/PC
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ENLARGED PLANS

E-303

BUILDING NO. 2 - ELECTRICAL

Sheet Name:

Sheet No:

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	Location: ELECTRICA Supply From: Mounting: Enclosure:	AL 2003		Volts: 480/27 Phases: 3 Wires: 4	7 Wye		Mains Ty Mains Rat	ing: 100kA ype: MCB ing: 3500 A ing: 3500 A	
СКТ	Circuit Description	# of Poles	Trip Rating	Wire Size (H,N,0	G)	Conduit Size	Load		Remarks
1	2-ATS-LS	3	250 A	3-#250, 1-#250, 1	-#4	3"	33024 VA		
2	2-ATS-LR	3	400 A	3-#600, 1-#600, 1		4"	66417 VA		
3	2-ATS-OS1	3	800 A	2 runs of 3-#600, 1-#60		(2) 4"	462616 VA		
4	2-ATS-OS2	3	800 A	2 runs of 3-#600, 1-#60		(2) 4"	256779 VA		
5	2LPG	3	50 A	3-#6, 1-#6, 1-#1		1-1/4"	2802 VA		
6	2LP1, 2LP2, 2LP3, 2LP4, 2LP5 & 2LP6	3	250 A	3-#250, 1-#250, 1		3"	71587 VA		
7	TR-2RPG	3	125 A	3-#1/0, 1-#1/0, 1-		2"	43030 VA		
8	TR-2RP1	3	125 A	3-#1/0, 1-#1/0, 1-		2"	94420 VA		
9	TR-2RP2	3	125 A	3-#1/0, 1-#1/0, 1-		2"	117926 VA		
10	TR-2RP3	3	125 A	3-#1/0, 1-#1/0, 1-		2"	97183 VA		
11	TR-2RP4	3	175 A	3-#2/0, 1-#2/0, 1-		2"	130718 VA		
12	TR-2RP5	3	125 A	3-#1/0, 1-#1/0, 1-		2"	92094 VA		
13	TR-2RP6	3	125 A	3-#1/0, 1-#1/0, 1-		2"	143144 VA		
14	FIRE & JOCKEY PUMP	3	600 A	2 runs of 3-#350, 1-#3		(2) 4"	79776 VA		
15	TR-SP-2	3	150 A	3-#1/0, 1-#1/0, 1-		2"	0 VA		
16	RTU-2-6	3	150 A	3-#1/0, 1-#1/0, 1-		2"	103004 VA		
17	RTU-2-5	3	150 A	3-#1/0, 1-#1/0, 1-		2"	103004 VA		
18	RTU-2-4	3	150 A	3-#1/0, 1-#1/0, 1-		2"	103004 VA		
19	RTU-2-3	3	150 A	3-#1/0, 1-#1/0, 1-		2"	103004 VA		
20	RTU-2-2	3	150 A	3-#1/0, 1-#1/0, 1-		2"	103004 VA		
21	RTU-2-1	3	150 A	3-#1/0, 1-#1/0, 1-		2"	103044 VA		
22	SPARE	3	200 A				0 VA		
23	SPARE	3	400 A				0 VA		
24	SPARE	3	150 A				0 VA		
25	SPACE	1							
							2308020 VA 2776 A		
ad Clas	sification		Connected Load	Demand Factor	Estimate	ed Demand		Panel	Totals
/AC			1216944 VA	100.00%	1216	944 VA			
eating			31000 VA	100.00%	310	00 VA	Total (Conn. Load:	2308020 VA
ghting - [Owelling Unit		48836 VA	38.99%	190	43 VA	Total E	st. Demand:	2078613 VA
otor			174981 VA	111.40%	1949	925 VA		Total Conn.:	2776 A
ther			86999 VA	100.00%	869	99 VA	Total E	st. Demand:	2500 A
wer - G	eneral		35520 VA	100.00%	355	20 VA			
eceptacle	•		433530 VA	51.15%	2217	765 VA			
ghting			33285 VA	100.00%	332	85 VA			
mputer			26624 VA	100.00%	266	24 VA			
on-Conti	nuous		196292 VA	100.00%	1962	292 VA			
otes:									

	Locati Supply Fr Mounti Enclose	om: TF ing: Sເ	R-2RPG ırface	CAL 2003		Feed ⁻		Volts: Phases: Wires: n Lugs:	4	8 Wye			Mai Main	ins Typ s Ratin	g: 22kA e: MCB g: 250 A g: 250 A			
кт	Circuit Description	Trip	Poles	Wire Size (H,N,G)	Conduit Size	,	A	ı	3	(C	Conduit Size	Wire Size (H,N,G)	Poles	Trip	Circuit Description	скт	/
1	UNIT HEATER (CUH-1) - LOBBY B - SOCIAL SERVICE	15 A	1	1-#12, 1-#12, 1-#12	3/4"	50 VA	900 VA					3/4"	1-#10, 1-#10, 1-#10	1	20 A	REC SECURITY BREAK 2005	2	
3	TV'S - LOBBY A - SOCIAL SERVICES 2015	20 A	1	1-#12, 1-#12, 1-#12	3/4"			250 VA	1260 VA			3/4"	1-#8, 1-#8, 1-#8	1	20 A	REC GENERAL	4	
5	REC TOILET 2011	20 A	1	1-#12, 1-#12, 1-#12	3/4"					360 VA	900 VA	3/4"	1-#10, 1-#10, 1-#10	1	20 A	REC MENS' LR 2005B	6	
7	REC SEC. 2010	20 A	1	1-#10, 1-#10, 1-#10	3/4"	1260 VA	1440 VA					3/4"	1-#10, 1-#10, 1-#10	1	20 A	REC LOBBY B - SOCIAL SERVICES 2001	8	
9	REC WOMENS' LR 2005C	20 A	1	1-#12, 1-#12, 1-#12	3/4"			720 VA	1260 VA			3/4"	1-#12, 1-#12, 1-#12	1	20 A	REC MAIL 2013	10	
11	REC ELECTRICAL 2003	20 A	1	1-#12, 1-#12, 1-#12	3/4"			.,.	.,.	1080 VA	2392 VA		2-#10, 1-#10,		SI	PLIT SYS HEAT PUMP (HP	12	
13	EXHAUST FAN (EF 2-5) -			2-#12, 1-#12,		0 VA	2392 VA			.,,	,,,	3/4"	1-#10	2	30 A	2-6A) - PARKING 1000	14	
15	PUMP & DOMESTIC 2002	15 A	2	1-#12	3/4"		VA	0 VA	720 VA			3/4"	1-#12, 1-#12, 1-#12	1	20 A	REC PUMP & DOMESTIC 2002	16	
17				2 #12 1 #12					VA	475 VA			1-#12			2002	18	
19	HAND DRYER	20 A	2	2-#12, 1-#12, 1-#12	3/4"	475 VA	1500 VA			VA			0 #40 4 #40				20	
21				0 1140 4 1140		VA	VA	2392 VA	1500 VA			3/4"	2-#12, 1-#12, 1-#12	2	20 A	HWH-3 - TOILET 2005A	22	
23	SPLIT SYS HEAT PUMP (HP 2-6B) - PARKING 1000	30 A	2	2-#10, 1-#10, 1-#10	3/4"			VA	VA	2392	6656					MALO OF OUR TYPE AV	24	
25						1500	6656			VA	VA	1-1/2"	2-#3, 1-#3, 1-#8	2	80 A H	WH-2 - SECURITY BREAK 2005	26	
27	HWH-3	20 A	2	2-#12, 1-#12, 1-#12	3/4"	VA	VA	1500									28	
29								VA		1500							30	
31	UNIT HEATER (ECUH-1) - CORR. 2007	20 A	2	2-#10, 1-#10, 1-#10	3/4"	1500				VA							32	
33						VA											34	
35																	36	
37																	38	
39																	40	
11																	42	
					tal Load:		3 VA		2 VA		55 VA						\\\\\\\\\\\\\\\\\\\\\\\\\\\\\\\\\\\\\\	
				Tot	al Amps:	15	5 A	80) A	139	9 A						}	
oad VAC	Classification				ected Lo	ad		nand Fa		Esti	mated 9568	Demand VA			Panel	Totals	\longrightarrow	
eati	ng				8000 VA		,	100.00%			3000	VA				43030 VA		
ther owe	r - General				0 VA 50 VA			0.00% 100.00%)		0 V/ 50 V		То		. Demand: otal Conn.:	43030 VA 119 A	 {	
	otacle				900 VA			100.00%			9900		Тс		. Demand:		\	
on-(Continuous			20	0512 VA			100.00%)		20512	VA					}	

	Locati Supply Fr Mount Enclosi	om: 2- ing: Si	MSS urface	CAL 2003		Feed		Volts: Phases: Wires: h Lugs:	3 4	7 Wye			Ma Main	ins Typ is Ratin	ng: 65kA ne: MCB ng: 100 A ng: 50 A		
СКТ	Circuit Description	Trip	Poles	Wire Size (H,N,G)	Conduit Size		A	E	3	(C	Conduit Size	Wire Size (H,N,G)	Poles	Trip	Circuit Description	СКТ
1	Room 2008, 2009, 2010, 2011	20 A	1	1-#12, 1-#12, 1-#12		330 VA	609 VA						1-#12, 1-#12, 1-#12	1	20 A	Room 2013, 2003, 2002	2
3	Outdoor Plaza	20 A	1	1-#12, 1-#12, 1-#12				1073 VA									4
5	Room 2001, 2006, 2005, 2005B, 2005C, 2005A, 2007	20 A	1	1-#12, 1-#12, 1-#12	3/4"					794 VA							6
7																	8
9																	10
11																	12
13																	14
15																	16
17																	18
19																	20
21																	22
23																	24
25																	26
27																	28
29																	30
					tal Load: al Amps:		9 VA B A	1073			VA A						•
	Classification ng - Dwelling Unit				ected Lo	ad		nand Fa		Esti	mated 100 \	Demand VA			Panel	Totals	
Other					630 VA		,	100.00%			630 \	VA			onn. Load:		
Lighti	ng			2	2079 VA			100.00%			2079	VA	Te		. Demand: otal Conn.:		
													To		. Demand:		


	Supply Fr	rom: 20 ting: Si	OPLS urface	CAL 2003		Feed	F Througl	Phases: Wires:	4	7 Wye			Ma Main	ins Typ ıs Ratin	ng: 65kA ne: MCB ng: 100 A ng: 50 A		
СКТ	Circuit Description	Trip	Poles	Wire Size (H,N,G)	Conduit Size		A	i	3	(Conduit Size	Wire Size (H,N,G)	Poles	Trip	Circuit Description	С
1	Exterior Emergency Lighting	20 A	1	1-#12, 1-#12, 1-#12		189 VA	108 VA					3/4"	1-#12, 1-#12, 1-#12	1	20 A	Lighting ELEV1 EL04-1	
3	Level 0 Emergency Lighting	20 A	1	1-#12, 1-#12, 1-#12				424 VA									
5	Level 1 Emergency Lighting	20 A	1	1-#12, 1-#12, 1-#12				V/\		1567 VA							
7				1-π12						VA							
9																	
11																	
13																	
15																	
17																	
19																	2
21																	2
23																	
25																	
27																	
29																	
					tal Load: al Amps:		7 VA A		VA A	156	7 VA A						
	Classification				ected Lo	ad		nand Fa		Esti	mated	Demand			Pane	el Totals	
Lighti Other	ng - Dwelling Unit -				640 VA 359 VA			100.00% 100.00%			640 \ 359 \			Fotal C	onn Load	I: 2283 VA	
Lighti					307 VA			100.00%			1307					I: 2283 VA	
															otal Conn.		
													To	otal Est	t. Demand	I: 3 A	

PANEL SCHEDULE NOTES:


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 (G) = GFI CIRCUIT BREAKER
- (L) = LOCK-ON DEVICE • (T) = CIRCUIT CONTROLLED THROUGH TIMECLOCK AND PHOTOCELL. EXAMPLE: "POWER OUTLET (G) (L)" REQUIRES A GFI CIRCUIT BREAKER WITH A LOCK-ON DEVICE.
- 2. ROOFTOP UNIT CIRCUIT BREAKERS SHALL BE HACR RATED. 3. WIRE SIZE OF BRANCH CIRCUITS SHALL BE MINIMUM #12 AWG, BUT NO LESS THAN PERMITTED BY THE NATIONAL ELECTRICAL CODE (NEC) FOR SPECIFIED OVERCURRENT PROTECTION. ANY DISCREPANCY MUST BE BROUGHT TO THE ATTENTION OF THE
- ENGINEER PRIOR TO BID. 4. ALL CIRCUITS TO BE RUN WITH COPPER WIRE. ALUMINUM OR COPPER CLAD WIRE WILL NOT BE ACCEPTED. CONDUIT IS NOT ACCEPTABLE AS A GROUND.
- 5. ALL MATERIALS SHALL BE UL LABELED. 6. CIRCUIT BREAKERS FOR FLOOR RECEPTACLES SHALL BE GFCI PROTECTED. 7. EC TO COORDINATE PANEL SHORT CIRCUIT RATING WITH AVAILABLE SHORT CIRCUIT
- CURRENT FROM UTILITY TRANSFORMER. 8. INSTALL NO MORE THAN THE EQUIVALENT OF (4) 90 DEGREE BENDS IN ANY CONDUIT RUN BETWEEN JUNCTION BOX OR PULL POINTS. 9. TANDEM AND HALF SPACE CIRCUIT BREAKER WILL NOT BE APPROVED.

PANEL SCHEDULE KEYED NOTES:

1) PROVIDE (3) PHASE CONDUCTORS, (3) NEUTRAL CONDUCTORS, (1) GROUND CONDUCTOR & (1) ISOLATED GROUND CONDUCTOR PER THE SIZE SHOWN FOR 3 PHASE FURNITURE FEED. COORDINATE FINAL POWER REQUIREMENTS WITH FURNITURE MANUFACTURER.

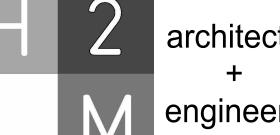

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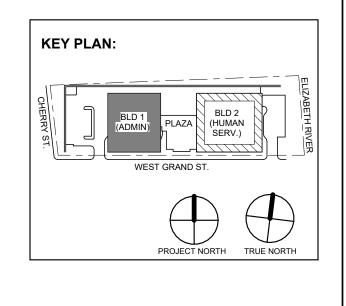


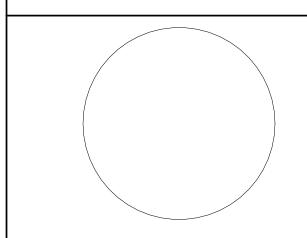JOHN CHRIS MORRIS III, P.E.
NJ PROFESSIONAL ENGINEER LIC. NO. GE02659900

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DESIGNED BY: DRAWN BY: CHECKED BY: REVIEWED BY:
NJA NJA SGS JCM

PROJECT No: DATE: SCALE:
DIGA2301 11/08/2023 AS SHOWN



12.22.2023 Addendum No. 04 12.01.2023 Addendum No. 01 11.08.2023 For Public Bid

No. Date Description

ARCHITECTURE FOR CHANGI 15 Bethany Street • New Brunswick, NJ 08901 • T: 732.249.6242 2450 W Hunting Park Ave • Philadelphia, PA 19122 • T: 215.634.3400

Jeffrey D. Venezia, AIA NJ RA AI 00827100

Revisions / Issues



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UNION COUNTY IMPROVEMENT AUTHORITY

UNION COUNTY GOVERNMENT 81 & 93 WEST GRAND STREET CITY OF ELIZABETH NEW JERSEY, 07202

Drawing Information:

Project No: 20.072
Date: 11.08.2023
Drawn By: JB/AV/PC
Checked By: JM/SH

Sheet Name: **BUILDING NO. 2 - ELECTRICAL** SCHEDULES

Sheet No:

	Branch Pan	tion: El						Volter	120/20	8 W/va			Λ 1 /	: Ratin	ng: 22kA			
	Supply F			P	hases:	3	o vvye		Ма	ins Typ	e: MCB							
	Mour Enclo			Feed ²	Througl	Wires: n Lugs:						ng: 100 A ng: 100 A						
СКТ	Circuit Description	Trip	Poles	Wire Size (H,N,G)	Conduit Size	,	4	ı	В		3	Conduit Size	Wire Size (H,N,G)	Poles	Trip	Circuit Description	CK.	
1	ELEV SMOKE CURTAIN	20 A	1	1-#12, 1-#12, 1-#12	3/4"	500 VA	500 VA					3/4"	1-#12, 1-#12, 1-#12	1	20 A	ELEV SMOKE CURTAIN	2	
3	ELEV SMOKE CURTAIN	20 A	1	1-#12, 1-#12, 1-#12	34"			500 VA	150 VA			3/4"	1-#12, 1-#12, 1-#12	1	20 A	FIRE SMOKE DAMPERS	4	
5											0 VA			1	0 A	SPARE	6	
7	SPARE	0 A	1			0 VA	0 VA							1	0 A	SPARE	8	
9	SPARE	0 A	1					0 VA	0 VA					1	0 A	SPARE	10	
11	SPARE	0 A	1							0 VA	0 VA			1	0 A	SPARE	12	
13	SPARE	0 A	1			0 VA	0 VA							1	0 A	SPARE	14	
15	SPARE	0 A	1					0 VA	0 VA					1	0 A	SPARE	16	
17	SPARE	0 A	1							0 VA	0 VA			1	0 A	SPARE	18	
19	SPACE		1											1		SPACE	20	
21	SPACE		1											1		SPACE	22	
23	SPACE		1											1		SPACE	24	
25	SPACE		1											1		SPACE	26	
27	SPACE		1											1		SPACE	28	
29	SPACE		1											1		SPACE	30	
'			tal Load: al Amps:	0 VA A		VA A		VA A										
Load Classification					ected Lo	ad	Dem	nand Fa	ctor	Esti	mated l	Demand			Panel	Totals		
lon-C	Continuous			1	650 VA			100.00%	Ď		1650 \	VA	-	Fotal C	onn. Load:	1650 VA		
															. Demand:			
													_		otal Conn.:			
													10	otal Est	. Demand:	5 A		

CKT Circuit Description Trip Poles Wire Size (H,N,G) Conduit Size 1 3RD FLOOR VAVs (NORTH 20 A 1 1-#10, 1-#10, 3/4"								Volts: Phases: Wires: h Lugs:	4	8 Wye	Ma Main	I.C. Rating: 22kA Mains Type: MCB iins Rating: 100 A ICB Rating: 50 A						
скт	Circuit Description	Trip	Poles				A	В		С		Conduit Size	Wire Size (H,N,G)	Poles	Trip	Circuit Description	C	
1	3RD FLOOR VAVs (NORTH SIDE)	20 A	1	1-#10, 1-#10, 1-#10	3/4"	900 VA	1000 VA					3/4"	1-#10, 1-#10, 1-#10	1	20 A	3RD FLOOR VAVs (SOUTH SIDE)		
3	2ND FLOOR VAVs (NORTH SIDE)	20 A	1	1-#12, 1-#12, 1-#12	3/4"			800 VA	1100 VA			3/4"	1-#10, 1-#10, 1-#10	1	20 A	2ND FLOOR VAVs (SOUTH SIDE)		
5	1ST FLOOR VAVs (NORTH SIDE)	20 A	1	1-#12, 1-#12, 1-#12	3/4"					700 VA	550 VA	3/4"	1-#12, 1-#12, 1-#12	1	20 A	1ST FLOOR VAVs (SOUTH SIDE)		
7	GROUND FLOOR VAVs	20 A 1 1-#12		1-#12, 1-#12, 1-#12	3/4"	500 VA	1040 VA					3/4"	2-#12, 1-#12,	2	15 A	SPLIT SYS. HEAT PUMP (HP		
9	ΔC-2-1-1 & ΔC-2-2-1 15 Δ 2 2-#12,		2-#12, 1-#12,	3/4"			104 VA	1040 VA			0/4	1-#12		107	2-5) - BUILDING EXTERIOR			
11	AC-2-1-1 & AC-2-2-1	15 A	2	1-#12	3/4					104 VA	104 VA	3/4"	2-#12, 1-#12,		15 A	AC 24 28 AC 22 2	,	
13	LIV/A C D 0000 0000	00.4	0	2-#12, 1-#12,	3/4"	104 VA	104 VA					3/4	1-#12	2	15 A	AC-2-1-2 & AC-2-2-2	,	
15	HVAC Room 2302, 2303	20 A	2	1-#12	3/4*			104 VA	600 VA			3/4"	1-#12, 1-#12, 1-#12	1	15 A	Power - General YOUTH SERVICES OPEN OFFICE	,	
17	Power - General YOUTH SERVICES OPEN OFFICE	15 A	1	1-#12, 1-#12, 1-#12						600 VA	600 VA	3/4"	1-#12, 1-#12, 1-#12	1	15 A	Power - General YOUTH SERVICES OPEN OFFICE		
19	Power - General	15 A	1	1-#12, 1-#12, 1-#12	3/4"	50 VA	100 VA						1-#12, 1-#12, 1-#12	1	15 A	Power - General TECH STORAGE 2211	2	
21	Power - General INTERVIEW ROOM OPEN OFFICE 2120	15 A	1	1-#12, 1-#12, 1-#12	3/4"			600 VA	600 VA				1-#12, 1-#12, 1-#12	1	15 A	Power - General PASSAGE 2108	2	
23	Power - General INTERVIEW ROOM OPEN OFFICE 2120	15 A	1	1-#12, 1-#12, 1-#12	3/4"					50 VA	500 VA		1-#12, 1-#12, 1-#12	1	15 A	Power - General MAIL 2010	2	
25	HP 2-7 / AC 2-7	30 A	2	2-#10, 1-#10,	3/4"	1976 VA											2	
27	Demarc Rm. 2013A	30 A	2	1-#10	3/4			1976 VA									2	
29																	3	
					tal Load: al Amps:				4 VA 1 A		3 VA ' A							
													1					
Load HVAC	Classification				nected Lo 2704 VA	ad		nand Fa 100.00%		Esti	2704	Demand			Pa	anel Totals		
Other					3952 VA			100.00%			3952		1	otal Co	onn. Lo	oad: 15906 VA		
	r - General				9250 VA			100.00%			9250					ind: 15906 VA		
													Тс			nn.: 44 A and: 44 A		
Notes	3 :									1								

PANEL SCHEDULE NOTES:

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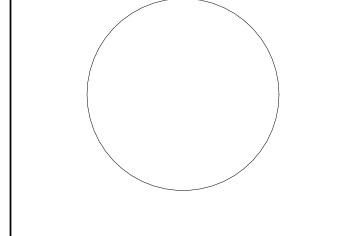
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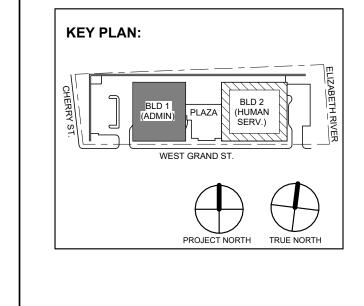


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DESIGNED BY: DRAWN BY: CHECKED BY: REVIEWED BY:
NJA NJA SGS JCM

PROJECT No: DATE: SCALE:
DIGA2301 11/08/2023 AS SHOWN




12.22.2023 Addendum No. 04 12.15.2023 Addendum No. 03 12.01.2023 Addendum No. 01 11.08.2023 For Public Bid

No. Date Description

Revisions / Issues

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UNION COUNTY IMPROVEMENT AUTHORITY

UNION COUNTY GOVERNMENT COMPLEX 81 & 93 WEST GRAND STREET CITY OF ELIZABETH NEW JERSEY, 07202

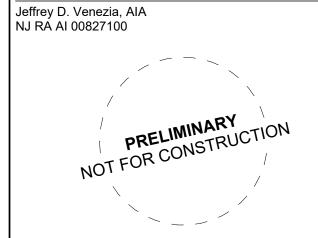Drawing Information: Project No: 20.072
Date: 11.08.2023
Drawn By: JB/AV/PC
Checked By: JM/SH

Sheet Name: **BUILDING NO. 2 - ELECTRICAL**

Sheet No:


SCHEDULES

E-515


Location: ELEC. 2303 Supply From: 2-MSS Mounting: Surface Enclosure: NEMA 1								Volts: Phases: Wires: h Lugs:	4	7 Wye			A.I.C. Rating: 65kA Mains Type: MCB Mains Rating: 100 A MCB Rating: 50 A							
СКТ	Circuit Description	Trip	Poles	Wire Size (H,N,G)	Conduit Size		4	E	3	C	;	Conduit Size	Wire Size (H,N,G)	Poles	Trip	Circuit Description	CH			
1	Level 3 West Side Lighting	20 A	1	1-#12, 1-#12, 1-#12		2567 VA	708 VA						1-#12, 1-#12, 1-#12	1	20 A	Level 3 NW Lighting	2			
3	Level 3 NE Lighting	20 A	1	1-#12, 1-#12, 1-#12				2154 VA	1768 VA				1-#12, 1-#12, 1-#12	1	20 A	Level 3 SE Lighting	4			
5	Level 3 South Side Lighting	20 A	1	1-#12, 1-#12, 1-#12						1514 VA	895 VA		1-#12, 1-#12, 1-#12	1	20 A	Level 3 Core Lighting	6			
7																	8			
9																	10			
11																	12			
13																	14			
15																	16			
17																	18			
19																	20			
21																	22			
23																	24			
25																	26			
27																	28			
29																	30			
					otal Load: tal Amps:		5 VA 2 A	3922 15		2409 9										
	Classification				nected Lo	ad		nand Fa		Esti	mated De				Panel	Totals				
∟ightir Other	ng - Dwelling Unit				300 VA 867 VA			100.00% 100.00%			300 VA 867 VA		1	Γotal Co	onn. Load:	9605 VA				
				8452 VA			100.00%	ı		8452 V	Ą		otal Est	. Demand:	9605 VA					
													То		otal Conn.: . Demand:					


	Branch Pane Locat Supply Fr Mount Enclos	ion: E om: T ing: S	_EC. 23 R-2RP3 urface	303		Feed 7		Volts: Phases: Wires: h Lugs:	3 4	3 Wye			Mai Main	ns Ty _l s Ratir	ng: 22k pe: MC ng: 250 ng: 250	B A	
CK.	T Circuit Description	Trip	Poles	Wire Size (H,N,G)	Conduit Size	A	A	E	3	(3	Conduit Size	Wire Size (H,N,G)	Poles	Trip	Circuit Description	C
1	REC ELEC 2303	20 A	1	1-#12, 1-#12, 1-#12	3/4"	180 VA	720 VA						1-#12, 1-#12, 1-#12	1	20 A	REC TRAINING 2341	
3	WATER COOLER - ELEVATOR LOBBY 2301	20 A	1	1-#12, 1-#12, 1-#12	3/4"			260 VA	900 VA				1-#12, 1-#12, 1-#12	1	20 A	REC GALLEY 2946	
5		20 A	1	1-#10, 1-#10, 1-#10	3/4"					970 VA	900 VA		1-#12, 1-#12, 1-#12	1	20 A	REC TRAINING 2342	
7	REC DIREC. ELECTION 2313	20 A	1	1-#8, 1-#8, 1-#8		1220 VA	1260 VA					3/4"	1-#12, 1-#12, 1-#12	1	20 A	REC TOILET 2305, 2307	
9	REC ELECTIONOFFICE 2310	20 A	1	1-#10, 1-#10, 1-#10				1080 VA	1260 VA				1-#12, 1-#12, 1-#12	1	20 A	REC BREAK ROOM 2340	
11	REC STORAGE	20 A	1	1-#12, 1-#12, 1-#12	3/4"			.,.		1180 VA	3000 VA		1-#8, 1-#8, 1-#10	1	35 A	HWH-1 - JAN. 2306	
13	REC ADA COMP 2311, DD ELECTION 2312	20 A	1	1-#8, 1-#8, 1-#8	3/4"	1830 VA	250 VA			V/X	V/		1-#12, 1-#12, 1-#12	1	20 A	REC. TV - TRAINING 2341	
15	DEC ASSIST DEELCE 2314	20 A	1	1-#8, 1-#8, 1-#8			VA	1580 VA	1580 VA			3/4"	1-#8, 1-#8, 1-#8	1	20 A	REC TAXATION OPEN OFFICE 2325	
17	Non-Continuous INCOME	0 A	1	1-#12, 1-#12,				VA	VA	500	3240		1-#6, 1-#6, 1-#6		20 A	REC CONFRENCE 2316	+
19	MAINTENANCE OPEN OFFI			1-#12		6650	250			VA	VA		1-#12, 1-#12,	1		REC. TV - BREAK ROOM 2340	0
21	TANKLESS WATER HEATER	80 A	2	2-#3, 1-#3, 1-#8		VA	VA	6650	250				1-#12 1-#12, 1-#12,	1	20 A	REC. TV - TRAINING 2343	
23		20 A	1	1-#12, 1-#12,				VA	VA	250	250		1-#12 1-#12, 1-#12,	1	20 A		
25	REC GALLEY / VENDING	20 A		1-#12 1-#12, 1-#12,		1200				VA	VA		1-#12 1-#12, 1-#12,	1		HAND DRYER - MENS 2307	+
	2340.2			1-#12 1-#12, 1-#12,		VA	VA	250	1200				1-#12 1-#12, 1-#12,	'		REC GALLEY / VENDING	1
	REC. TV - BREAK ROOM 2340 REC GALLEY / VENDING		1	1-#12 1-#12, 1-#12,				VA	VA	1200	1300		1-#12 1-#12, 1-#12,	1	20 A	2340.2	_
29	2340.2	20 A	1	1-#12	0/48	1440	600			VA	VA		1-#12 1-#12, 1-#12,	1		HAND DRYER - WOMEN 2305 Other INCOME MAINTENANCE	4
31	2310	20 A	1	1-#8, 1-#8, 1-#8 1-#12, 1-#12,	3/4"	VA	VA	1300	1440				1-#12 1-#10, 1-#10,	1	UA	OPEN OFFICE 2320 REC ELEVATOR LOBBY	
33		20 A	1	1-#12 1-#10, 1-#10,				VA	VA	1440	360	3/4"	1-#10	1	20 A	2301	1
35	REC TRAINING 2343	20 A	1	1-#10, 1-#10,			360			VA	VA		3-#12, 1-#12,			FURN. FEED - TAXATION	
37							VA		200				1-#12	3	20 A	OPEN OFFICE 2325	
39									360 VA								
41																	
43																	
45																	
47																	
49																	
51																	
53																	
55																	
57																	
59																	
61																	
63				_			0.145		- \								
					tal Load: al Amps:	2978 248		3540 298			9 A						
Lo a Mot	ad Classification				ected Lo 23 VA	ad		nand Fac 125.00%		Esti	mated 29 V	Demand			Pa	nnel Totals	
Oth	er			34	4850 VA		•	100.00%			34850	VA				oad: 97183 VA	
_	ceptacle n-Continuous				9350 VA 5760 VA			60.13% 100.00%			29675 5760			T	otal Co	nnd: 74994 VA nn.: 270 A	
													То	tal Es	t. Dema	and: 208 A	_
	res:																

1 ELEVATOR SUMP PUMP SCALE: N.T.S.

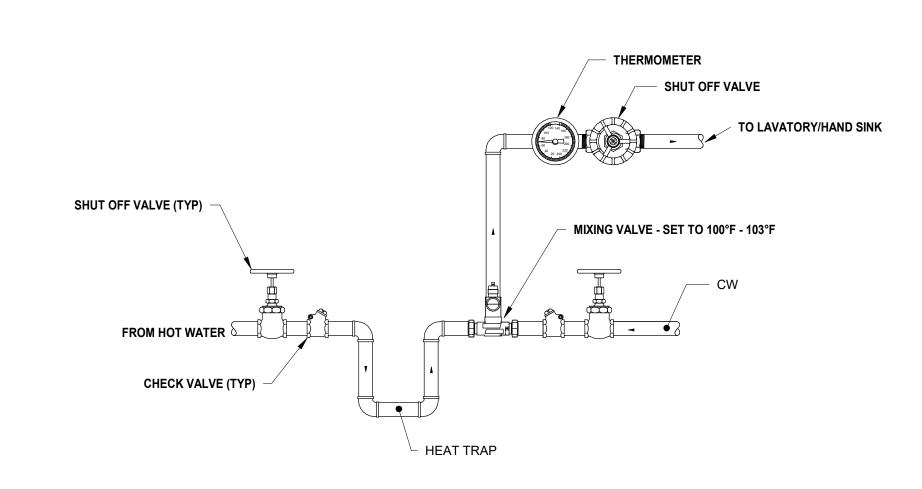

4 P-003 POINT OF USE MIXING VALVE DETAIL SCALE: N.T.S.

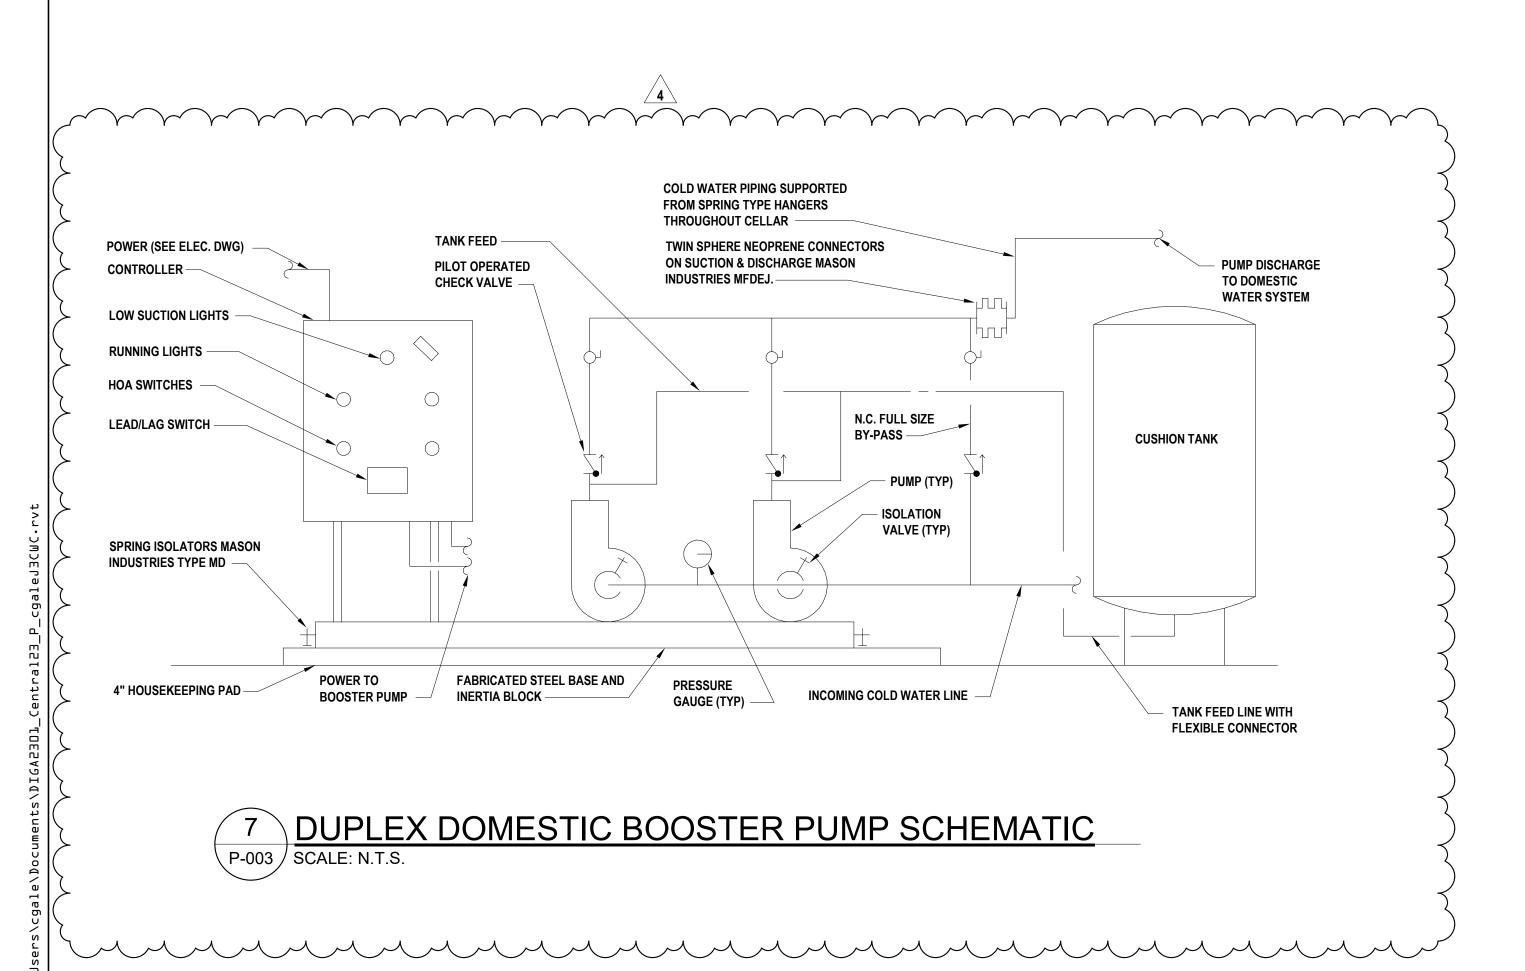

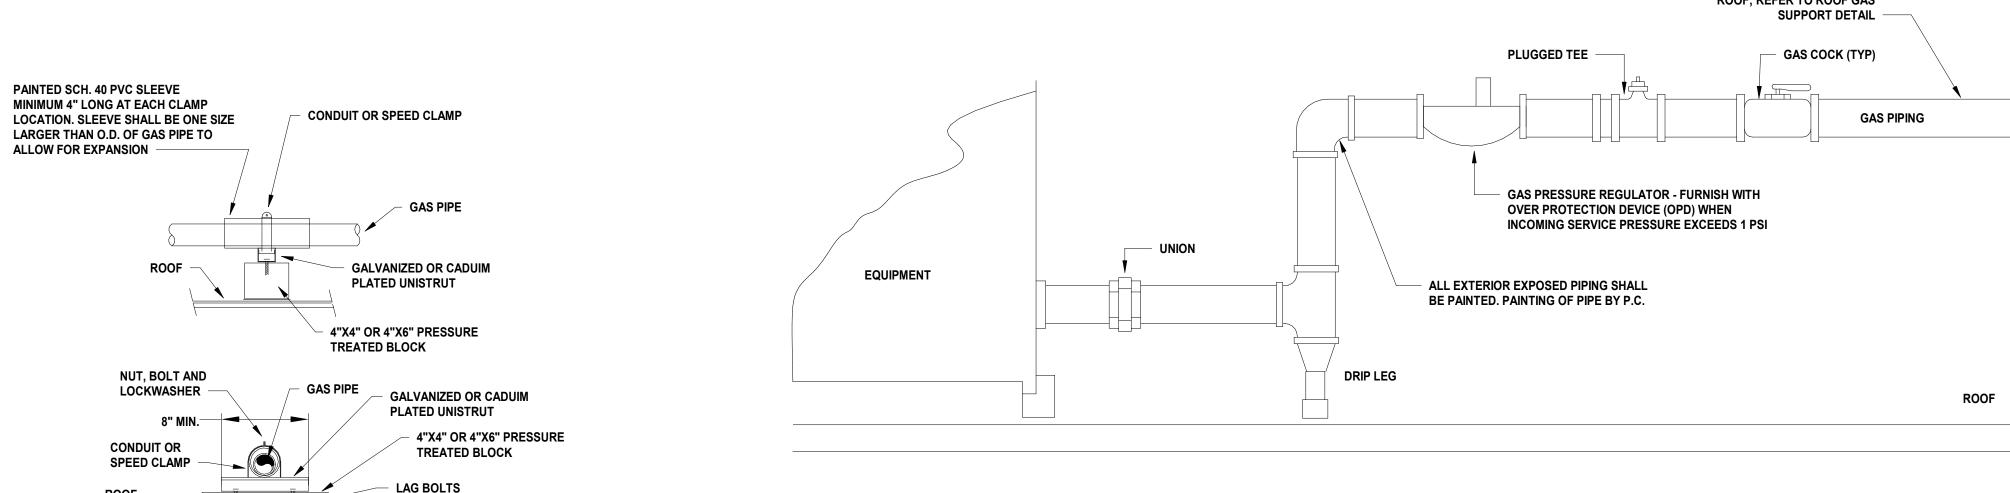

ADDITIONAL LAYER OF ROOFING

BLOCK

NOTE: PROVIDE SUPPORTS AT A MAXIMUM 8'-0" ON CENTER AND

P-003 SCALE: N.T.S.

1/4 TURN BALL VALVE

3/8" NPT CONNECTION

FOR FIXTURE

P-003 SCALE: N.T.S.

AT EACH CHANGE OF DIRECTION AT A MAXIMUM OF 2'-0" ON EACH SIDE

GAS PIPE SUPPORT ON ROOF

RECESSED SUPPLY OUTLET

1/2"CW SUPPLY WITH BFP.
LOCATE BFP IN ACCESSIBLE

LOCATION

SUPPLY OUTLET BOX


SNAP-ON SUPPLY OULET

ASSE 1010 HAMMER ARRESTORS

BOX FACE PLATE

BOX WITH WALL MOUNTS


MATERIAL BELOW PRESSURE TREATED

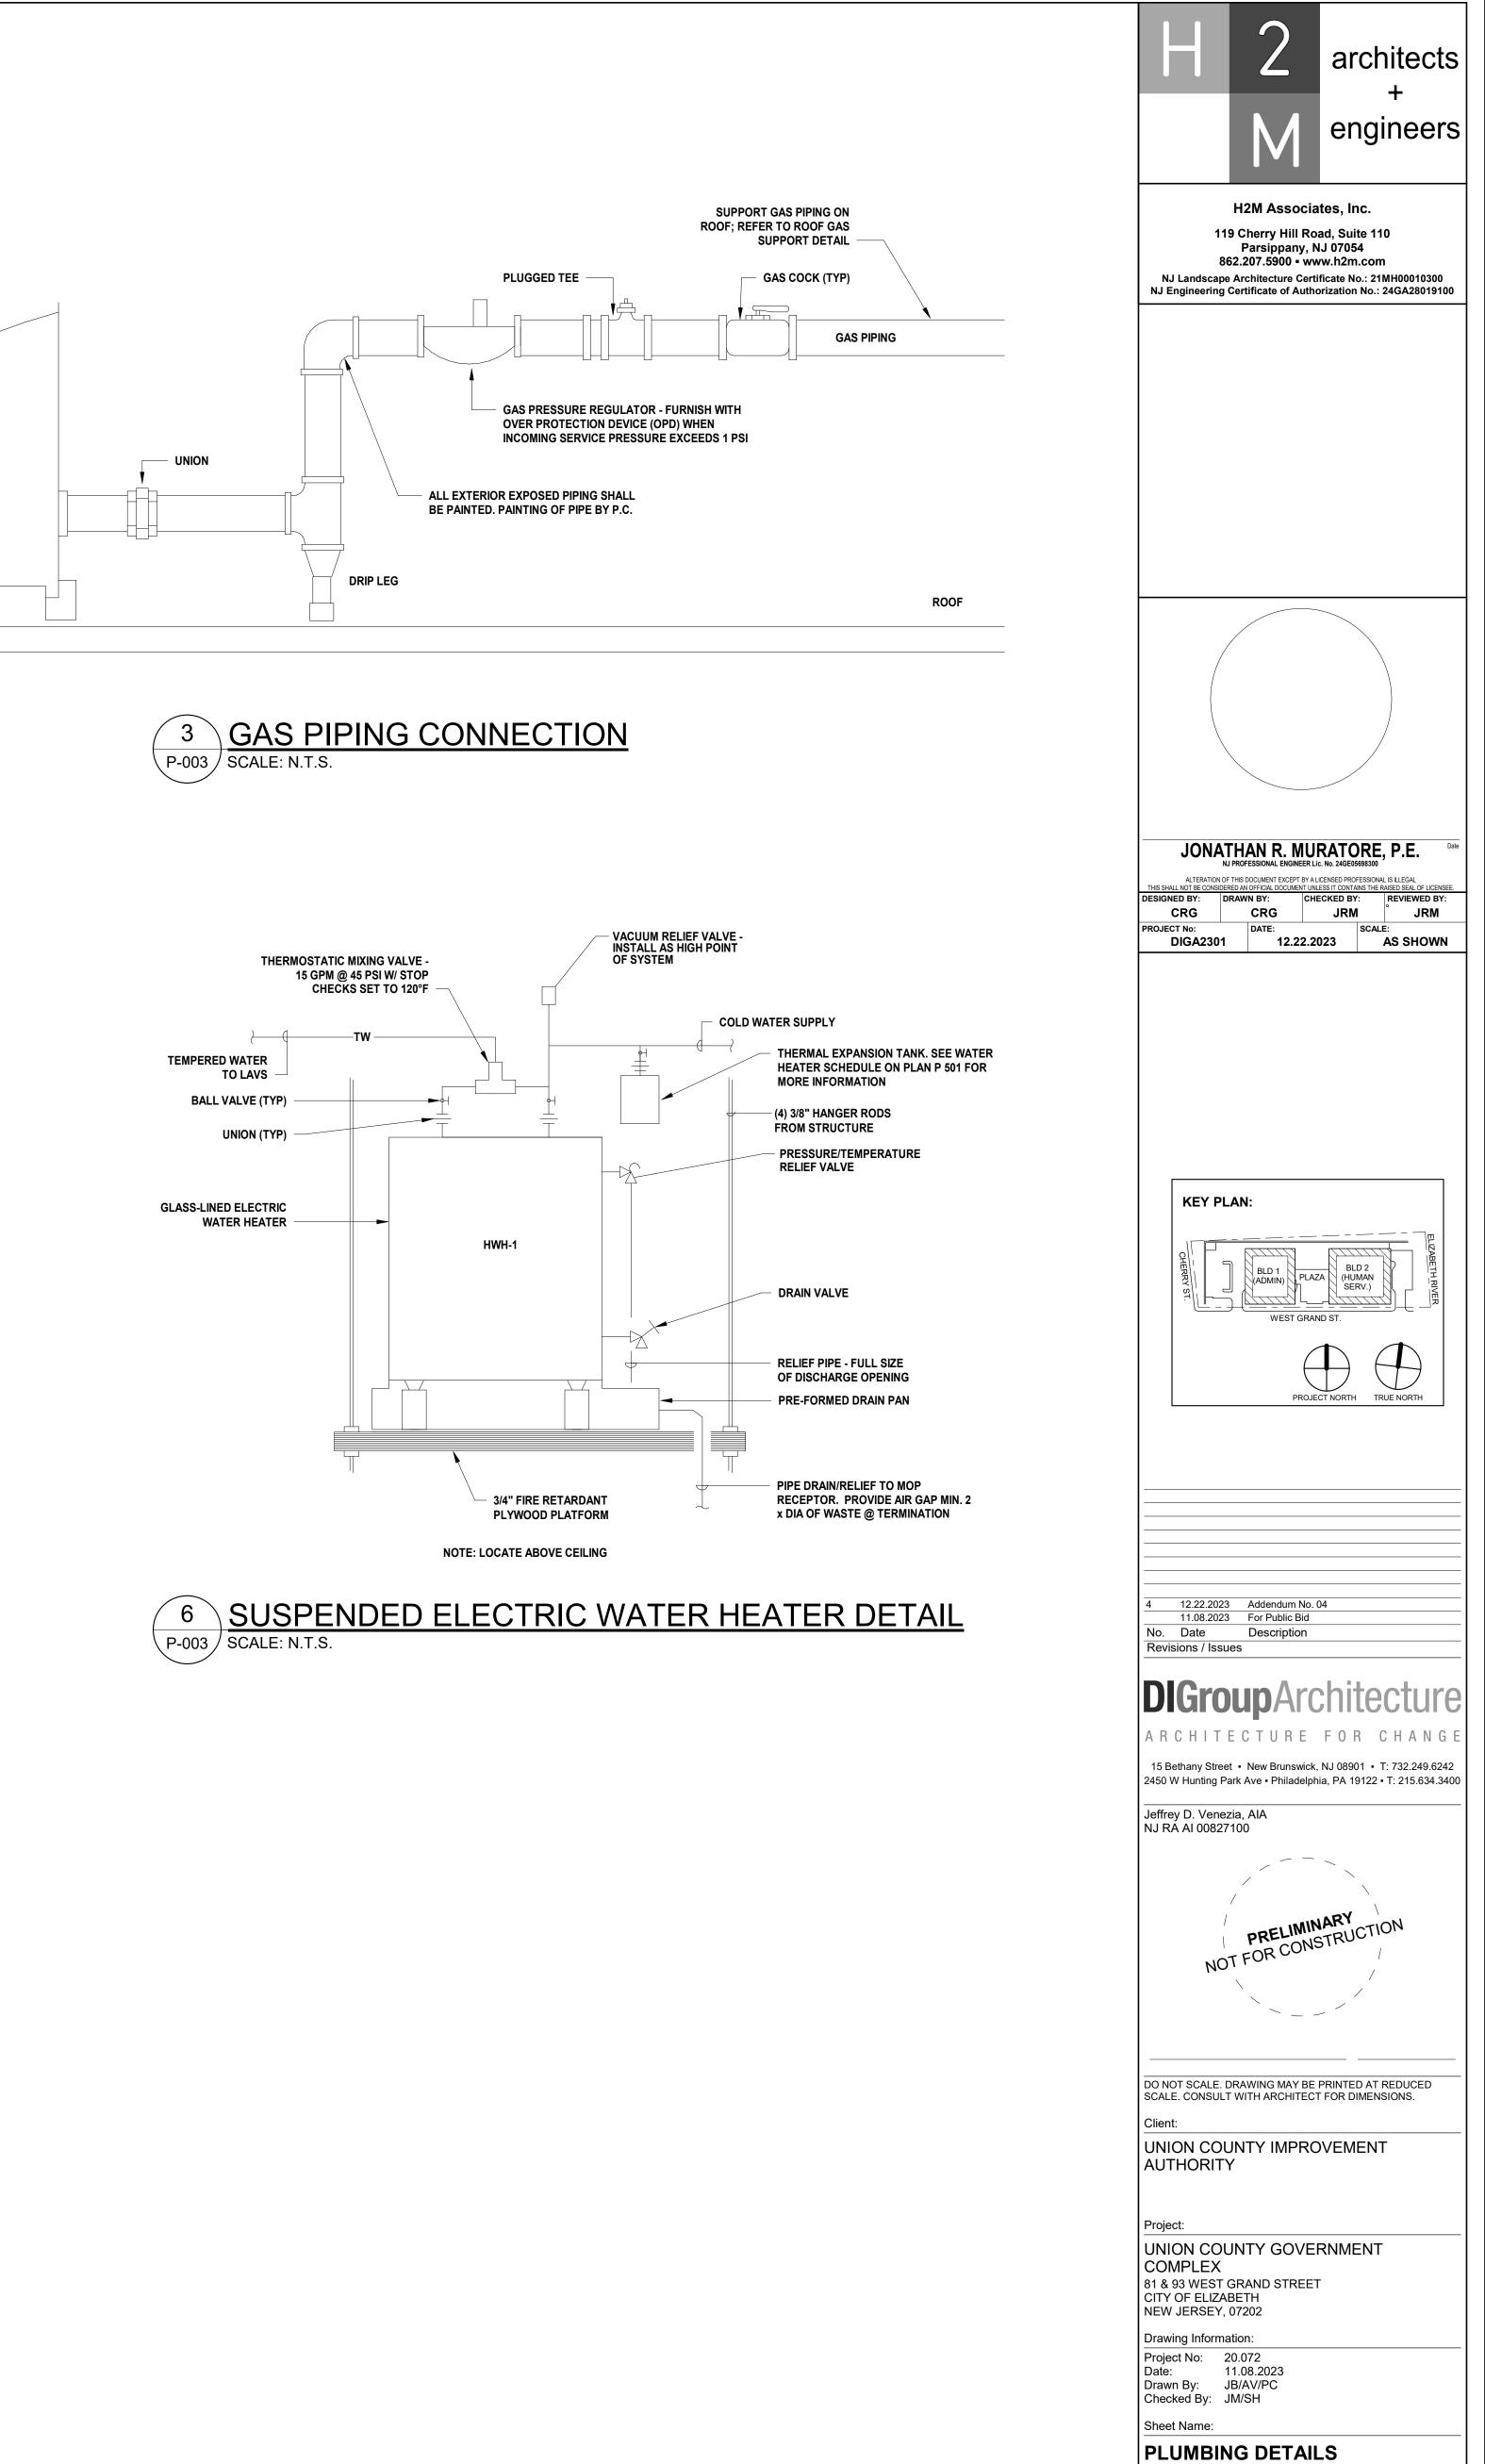


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Sheet No:

P-003

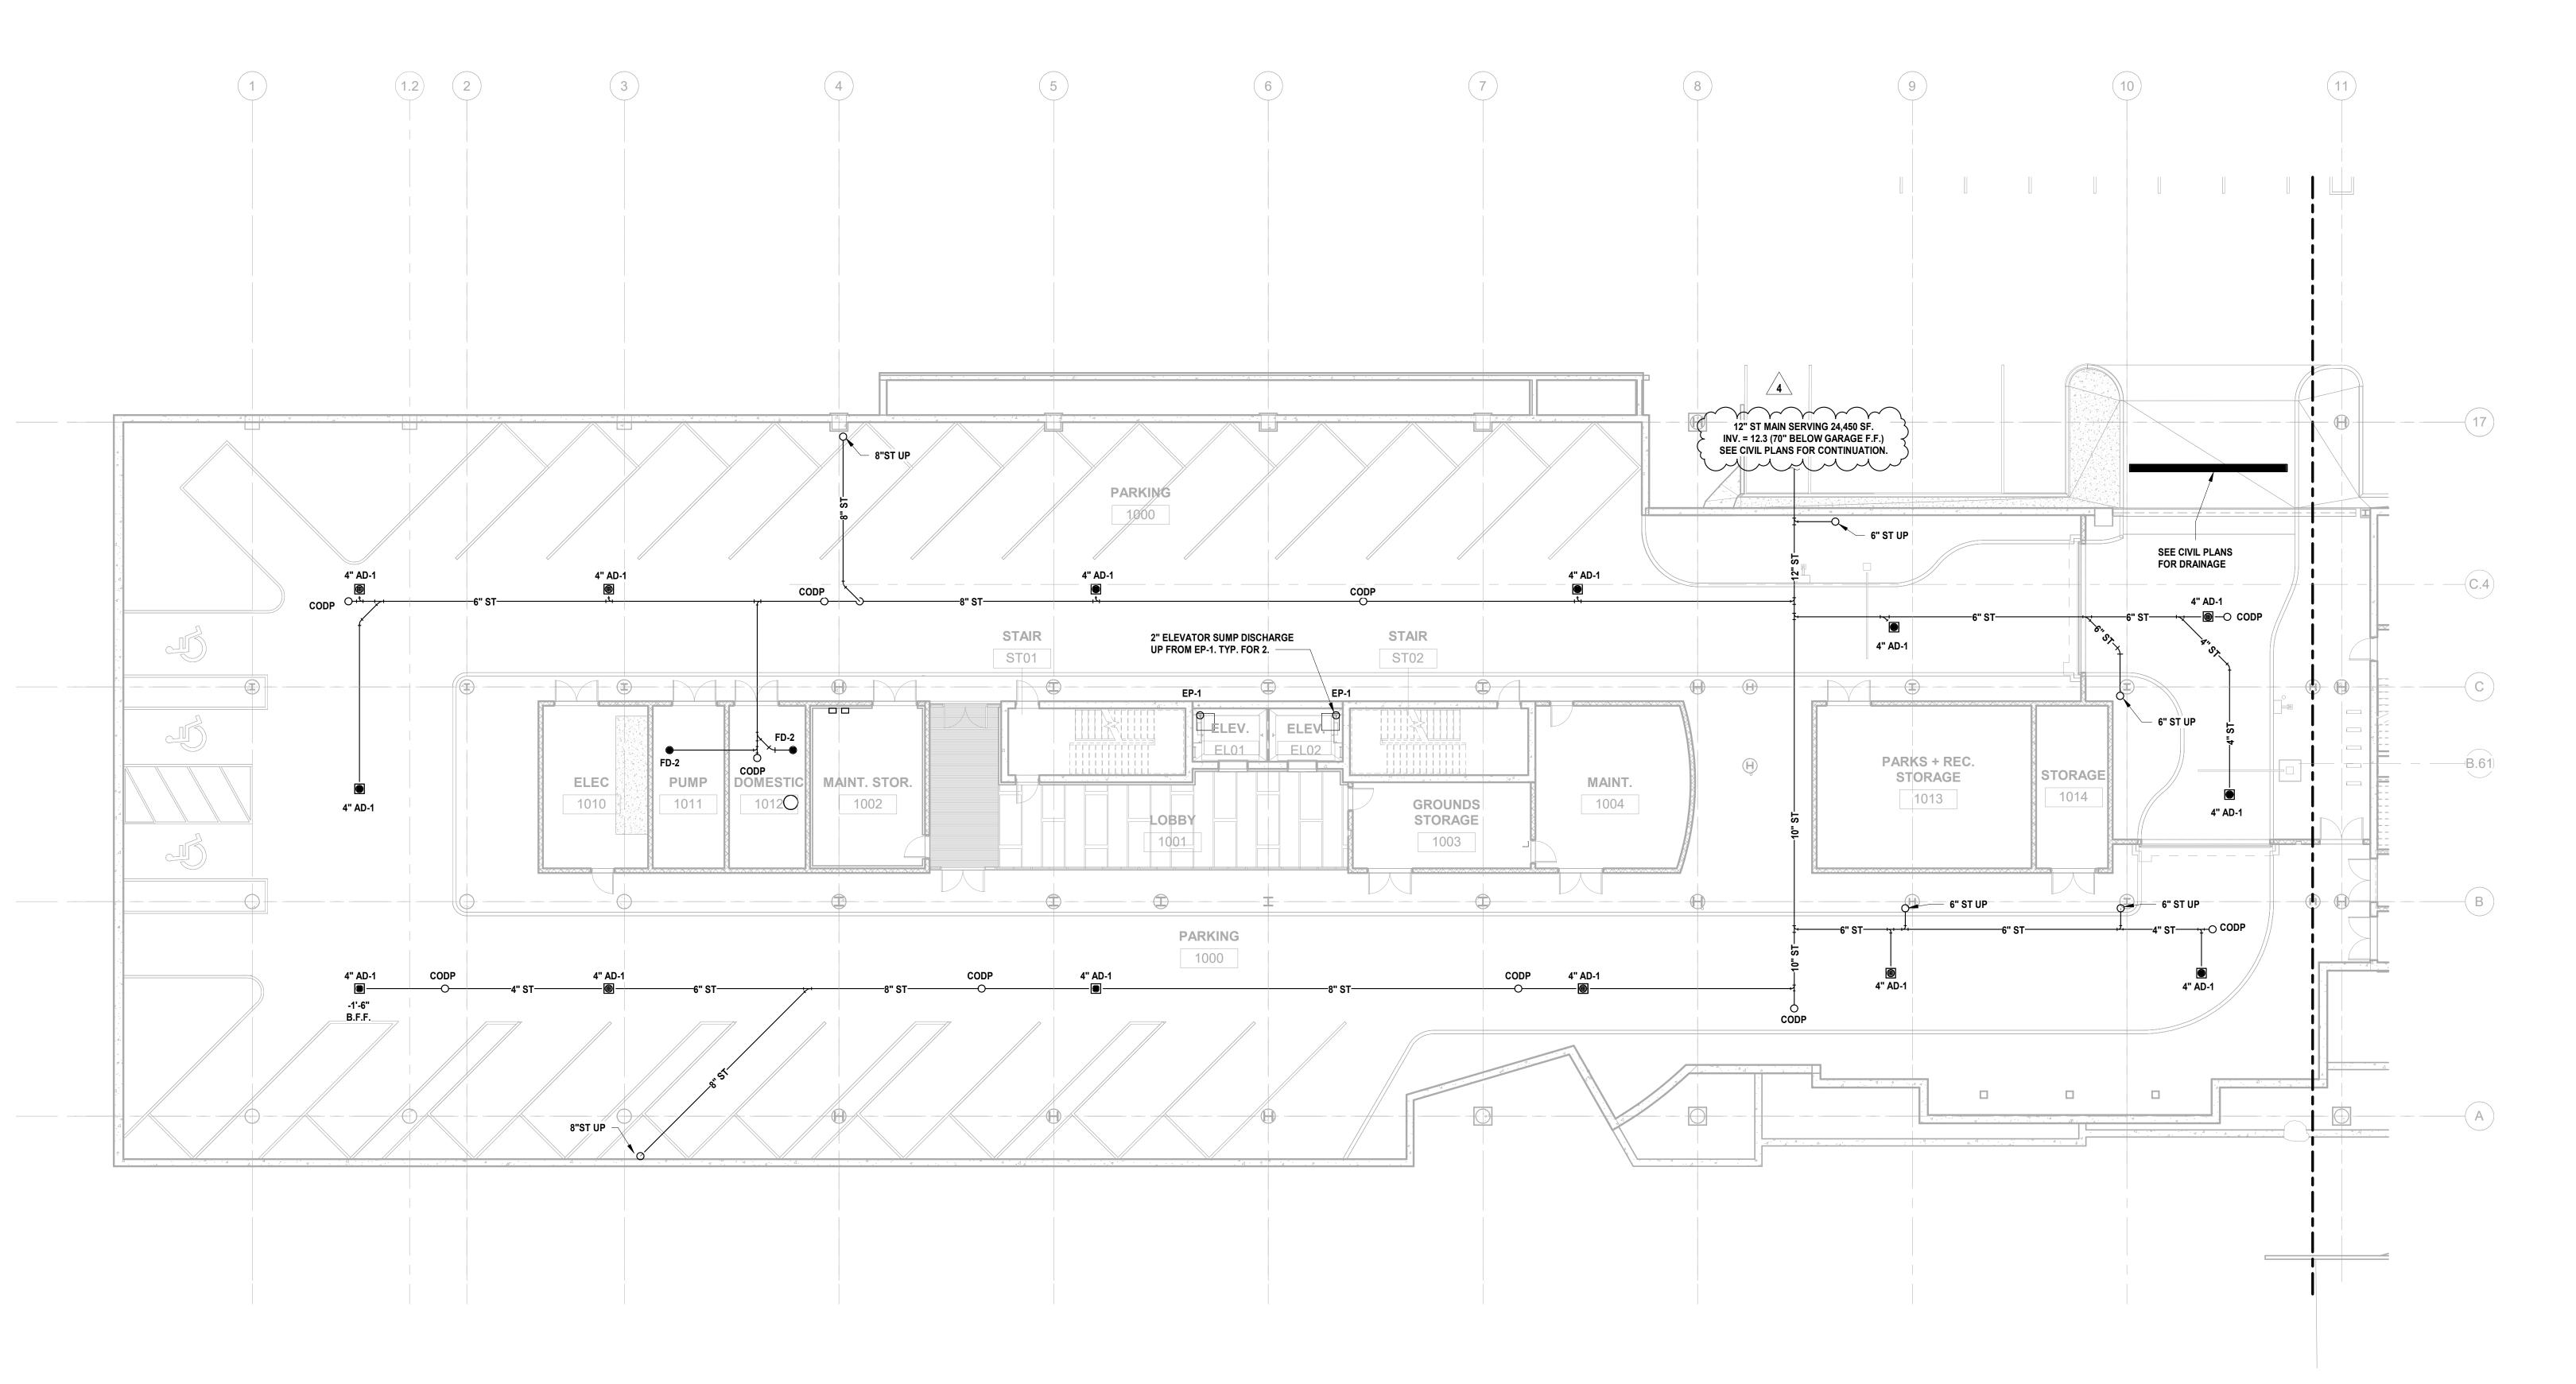


1 BUILDING NO. 1 - UNDERSLAB - SANITARY & STORM SCALE: 3/32" = 1'-0"

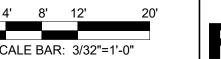

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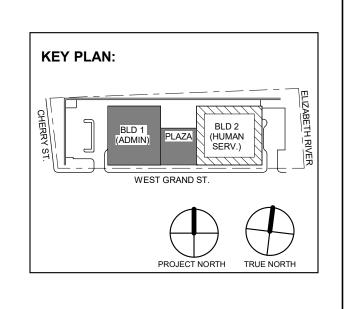
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UNION COUNTY IMPROVEMENT AUTHORITY

Project:
UNION COUNTY GOVERNMENT
COMPLEX

81 & 93 WEST GRAND STREET
CITY OF ELIZABETH
NEW JERSEY, 07202

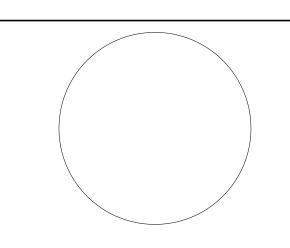
Drawing Information:

Project No: 20.072
Date: 11.08.2023
Drawn By: JB/AV/PC
Checked By: JM/SH


Sheet Name:
BUILDING NO. 1 - UNDERSLAB - SANITARY & STORM PLAN

eet No:

P-100

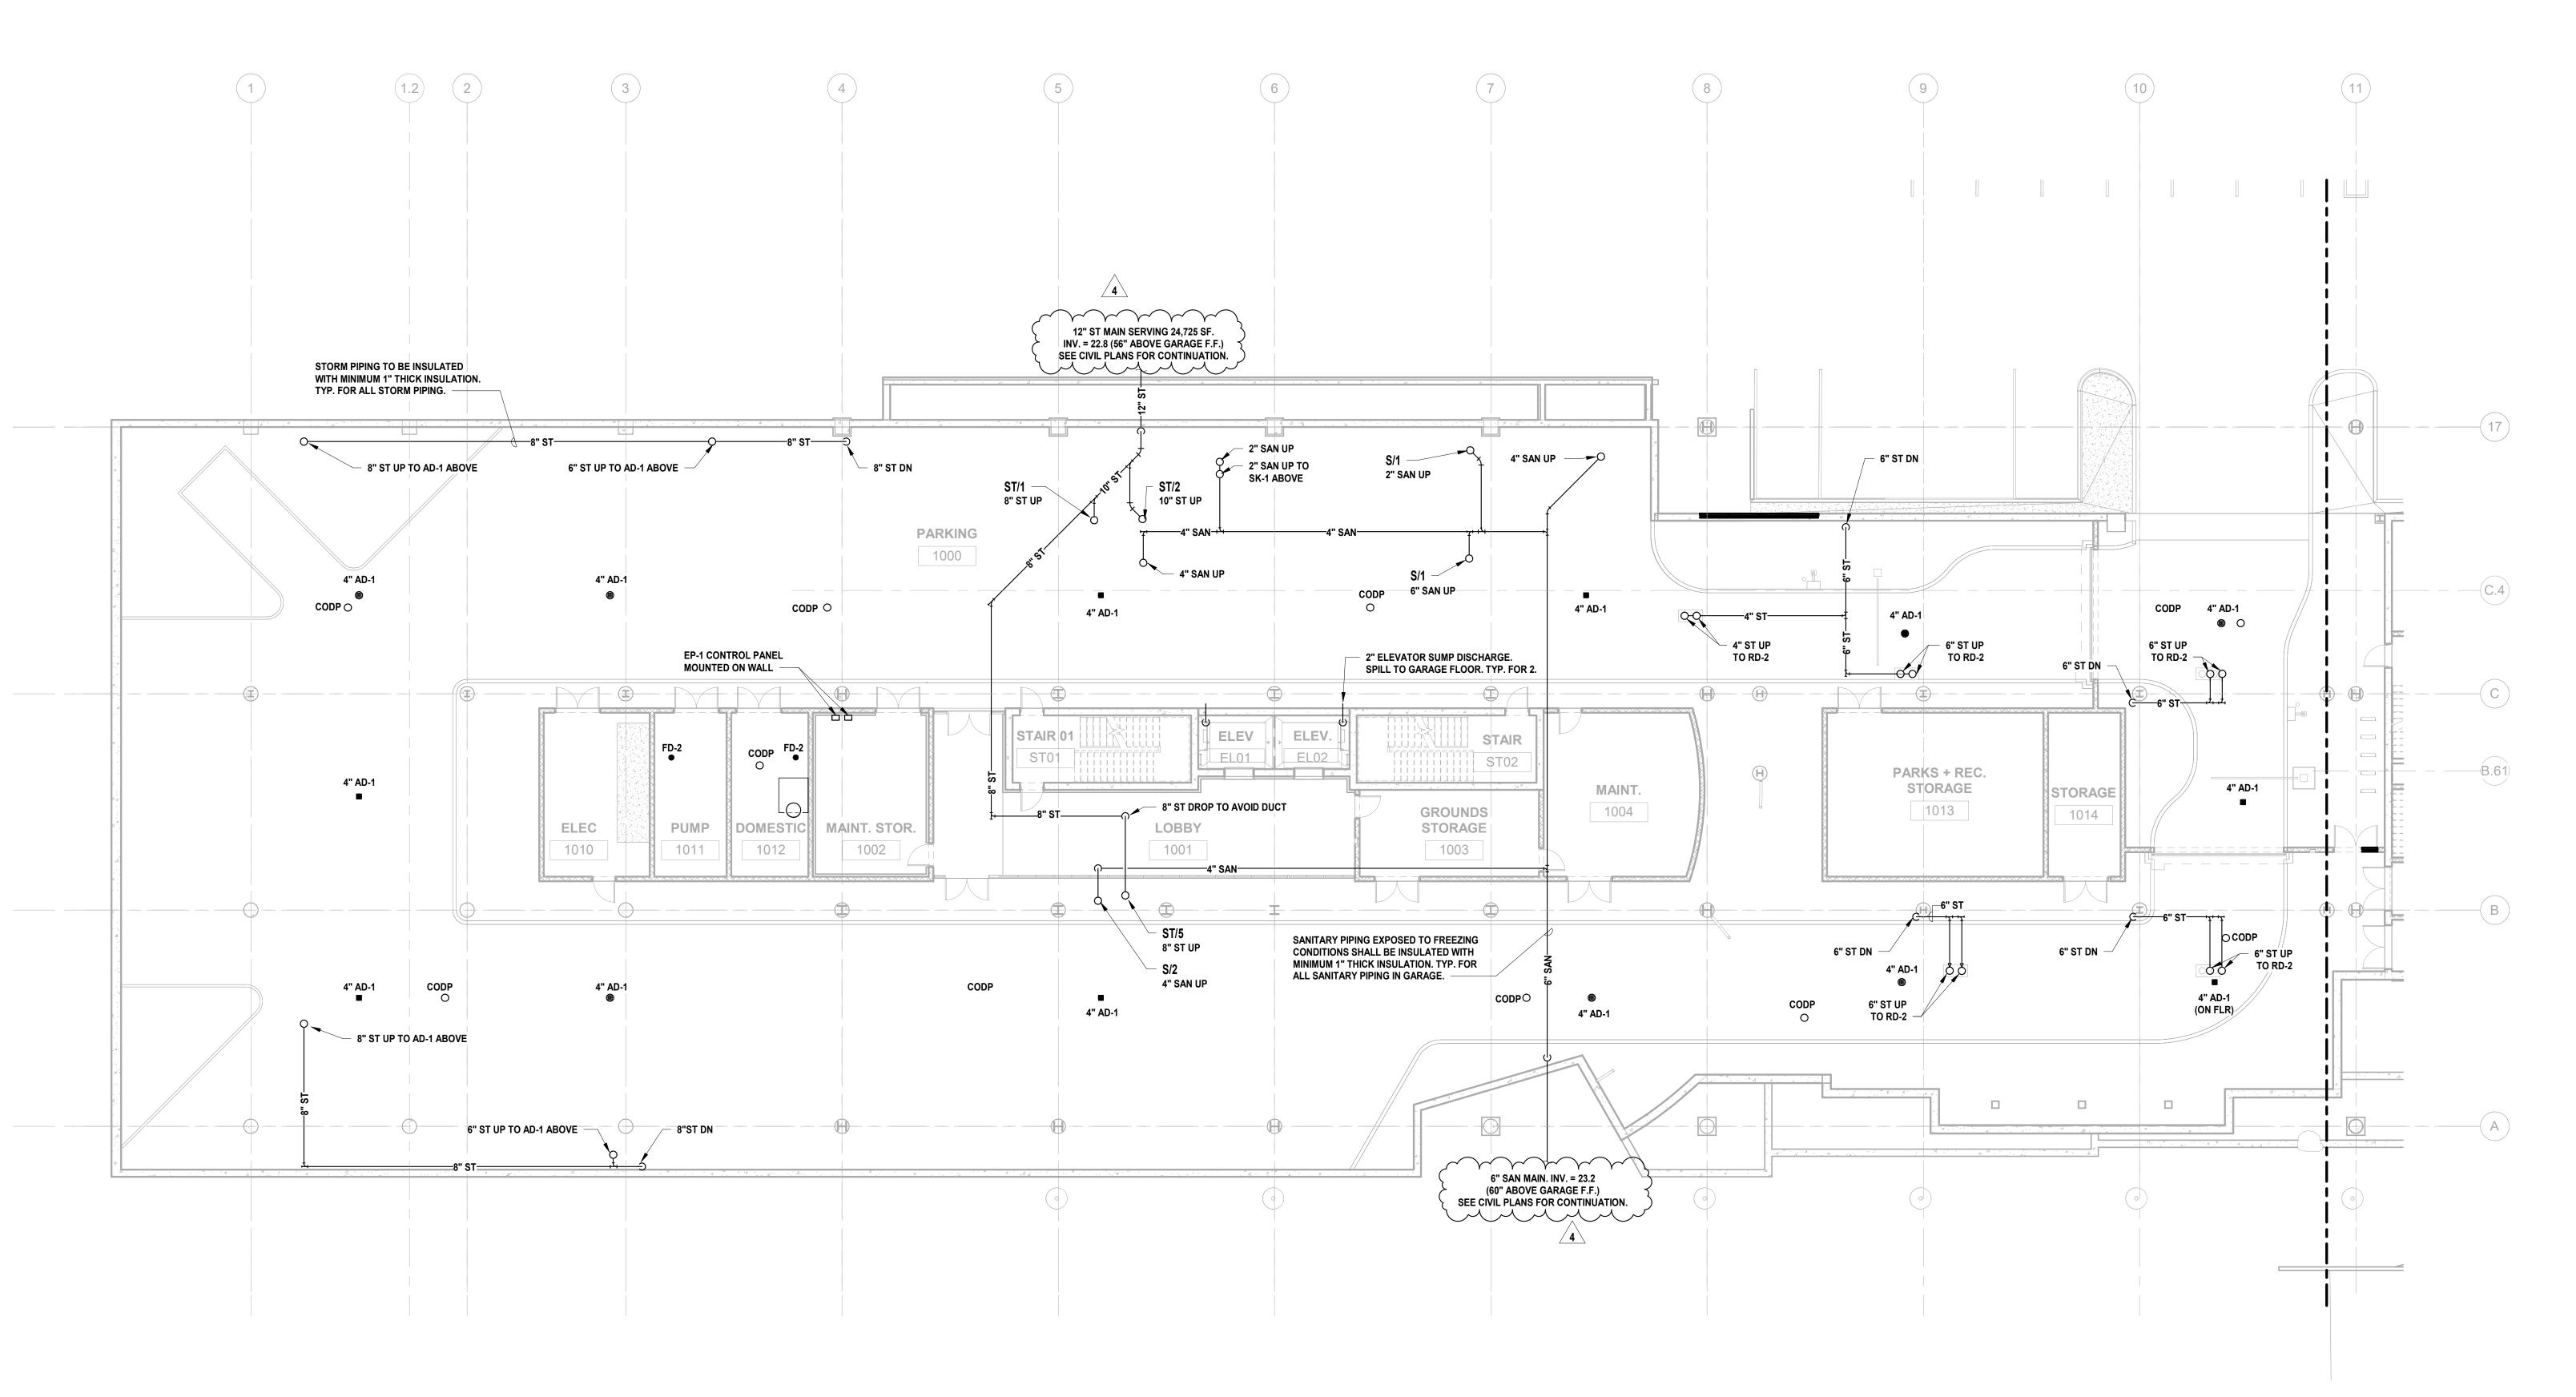

1 BUILDING NO. 1 - LEVEL 0 - SANITARY & STORM
SCALE: 3/32" = 1'-0"

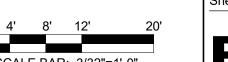

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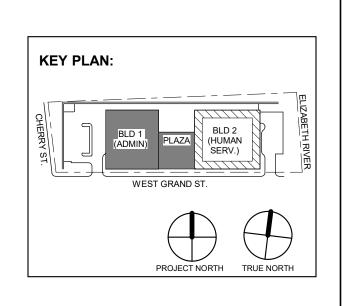
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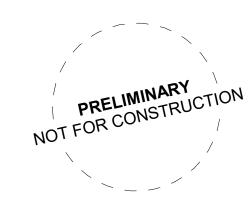


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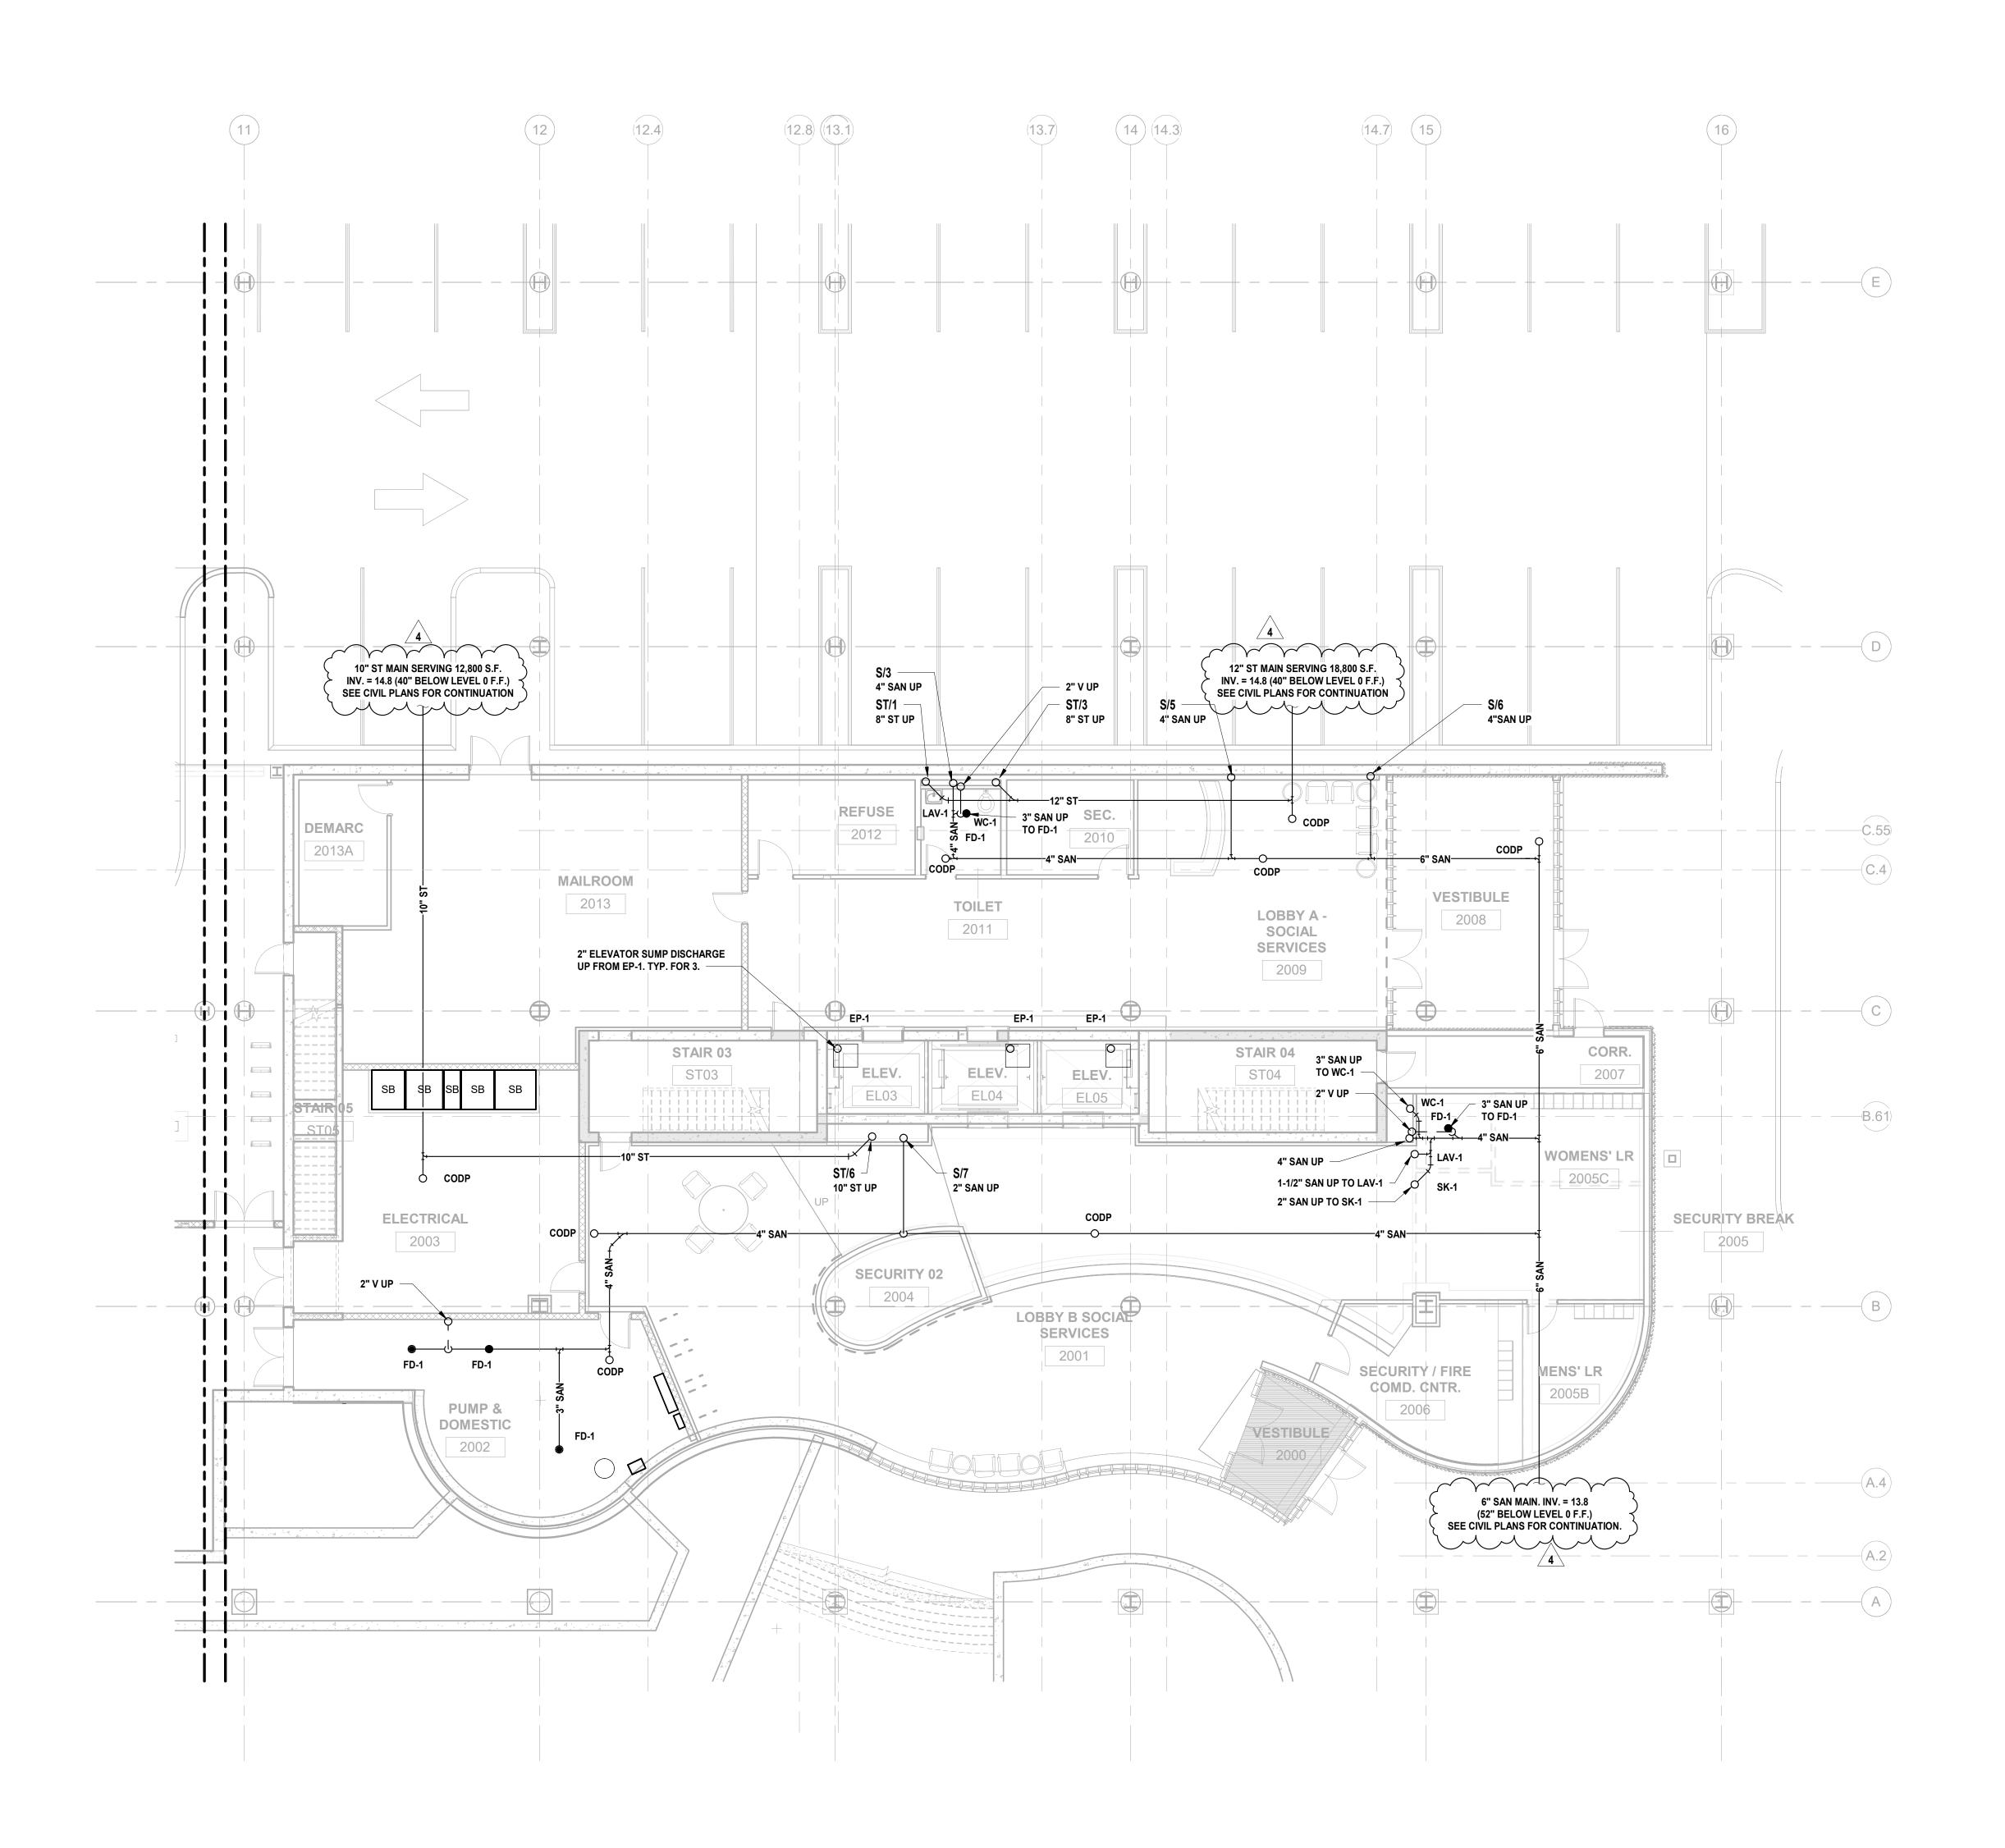
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Date: 11.08.2023
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BUILDING NO. 1 - LEVEL 0 -


SANITARY & STORM PLAN

P-101

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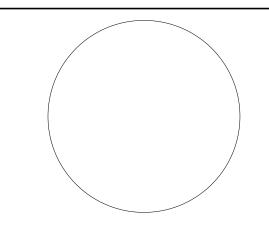


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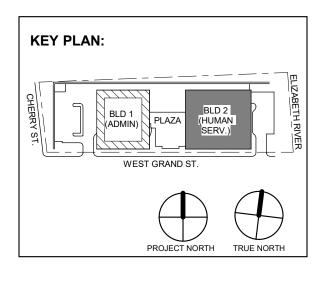


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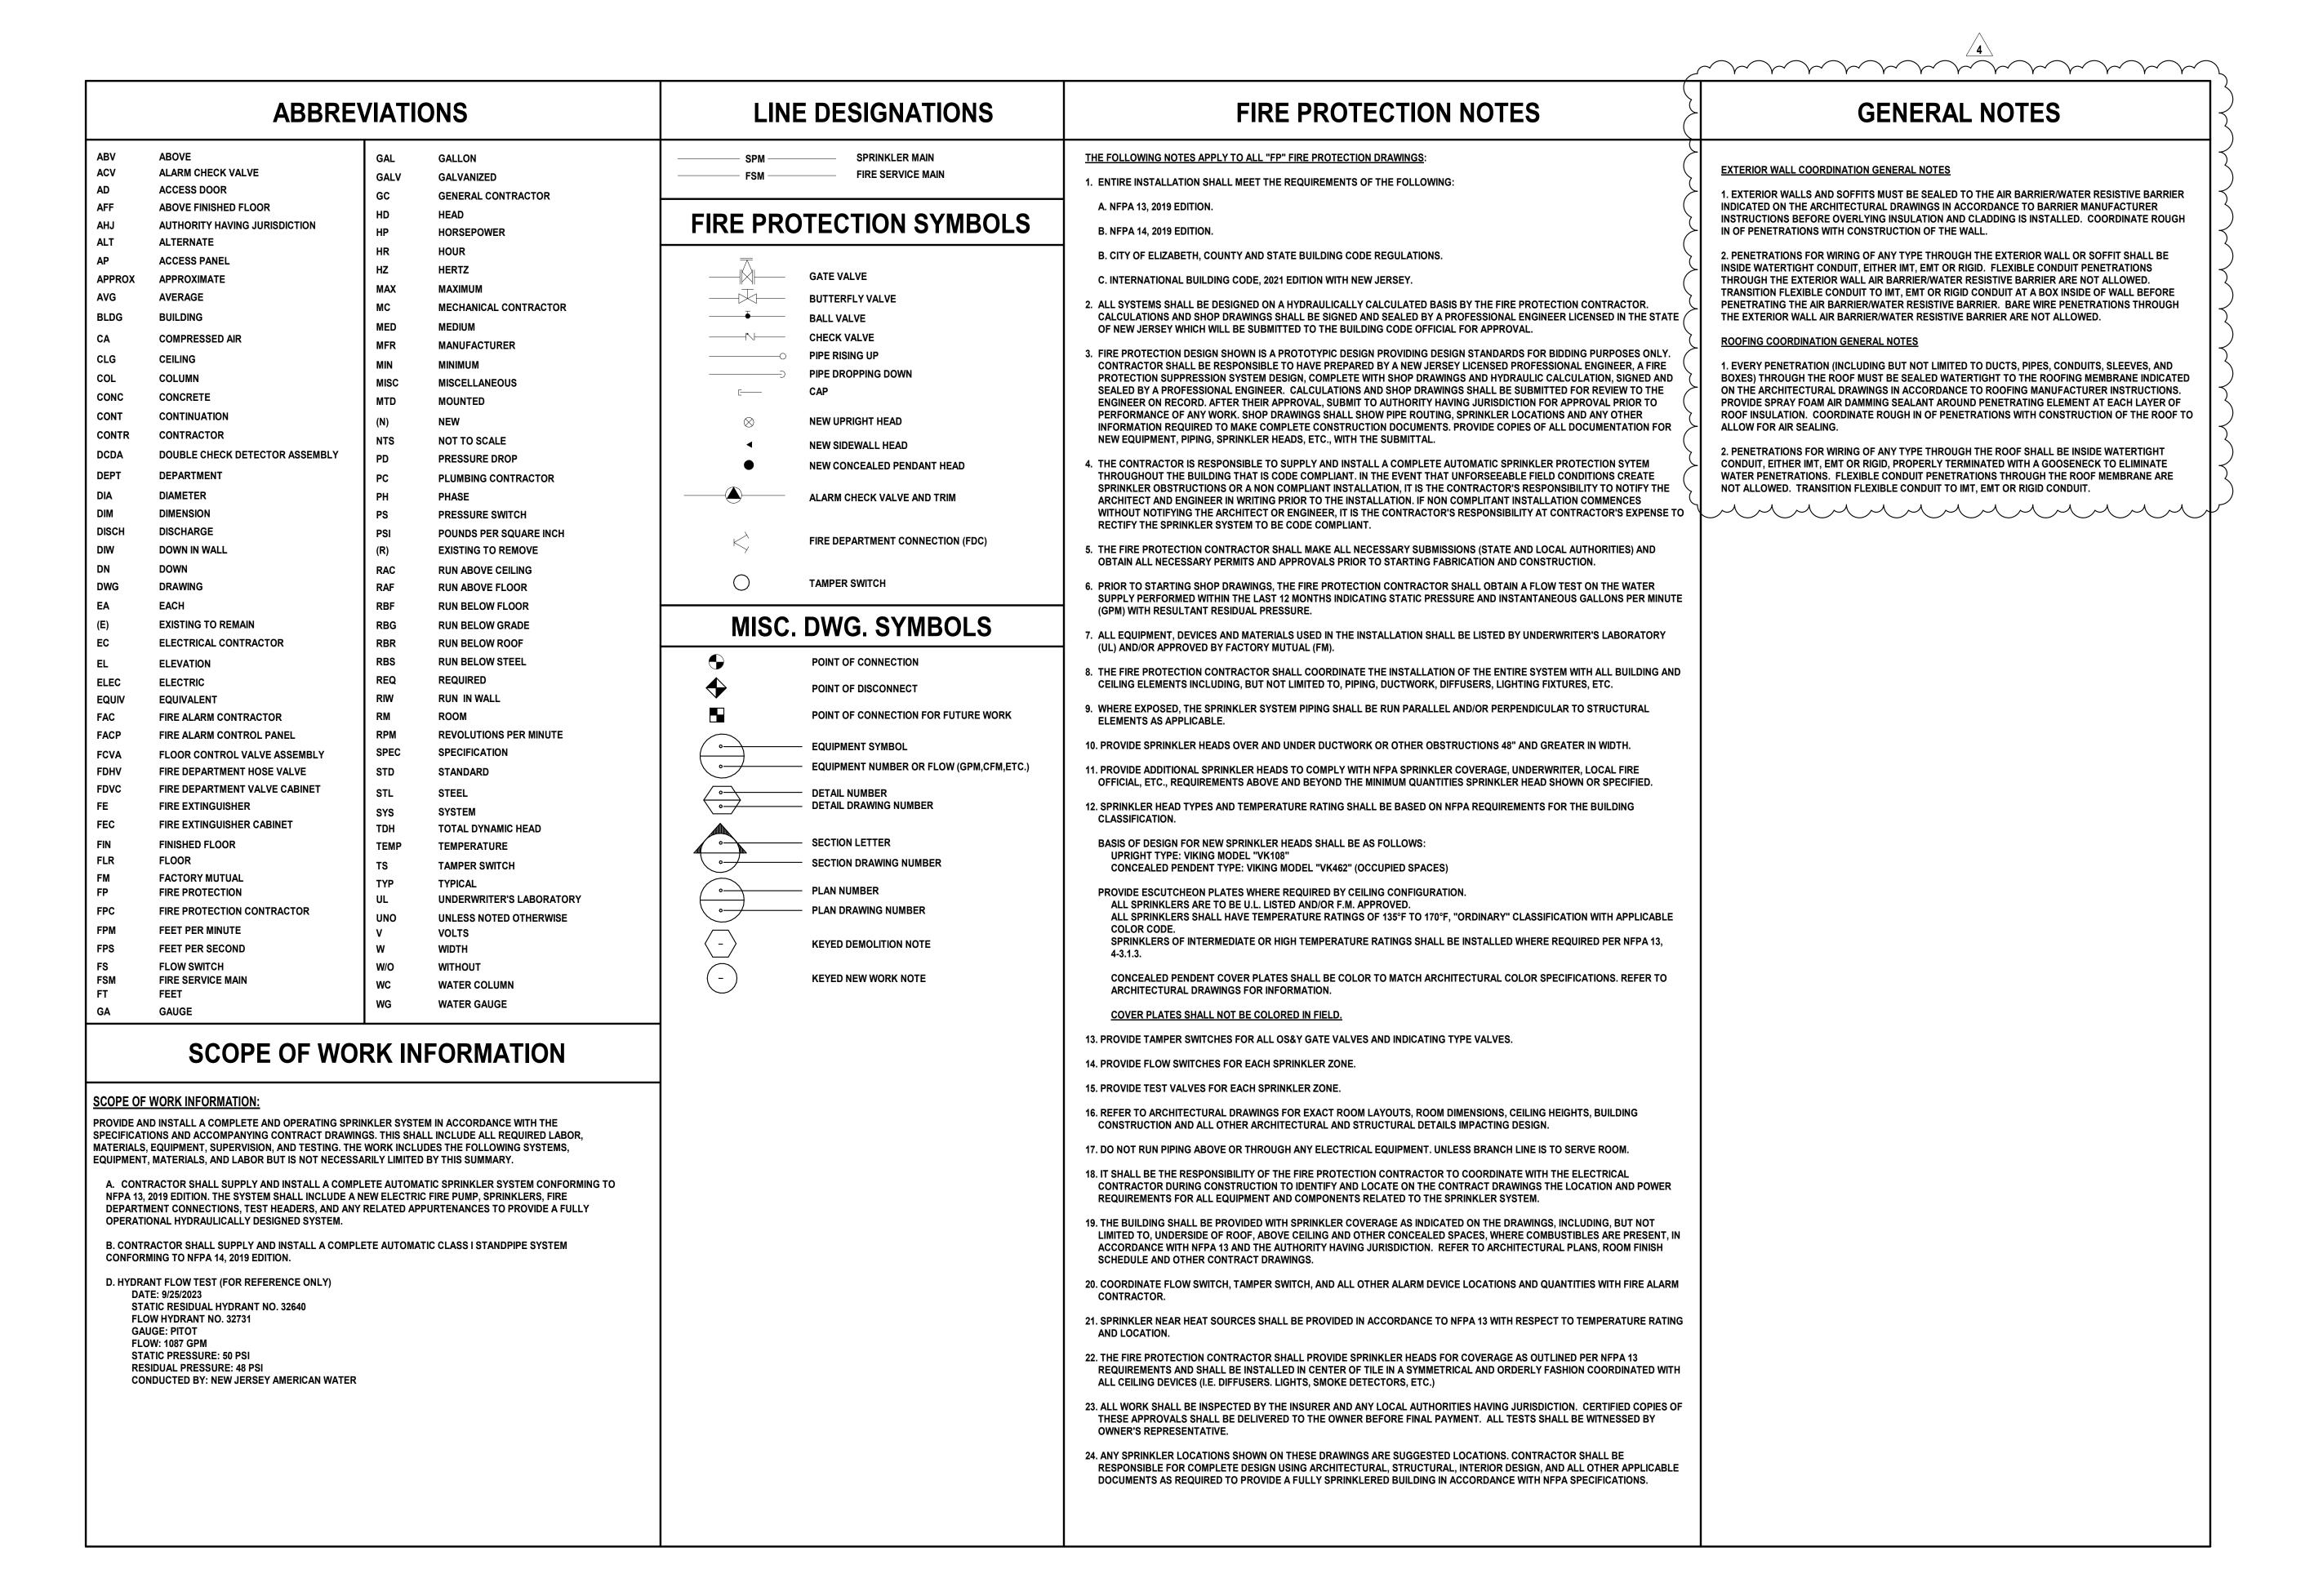
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Sheet No:

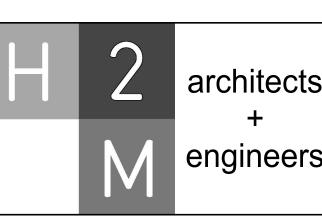
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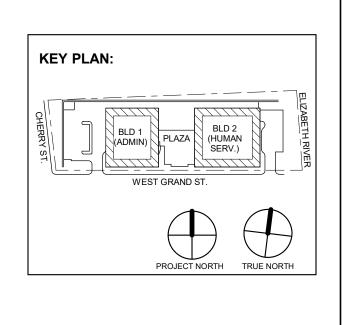


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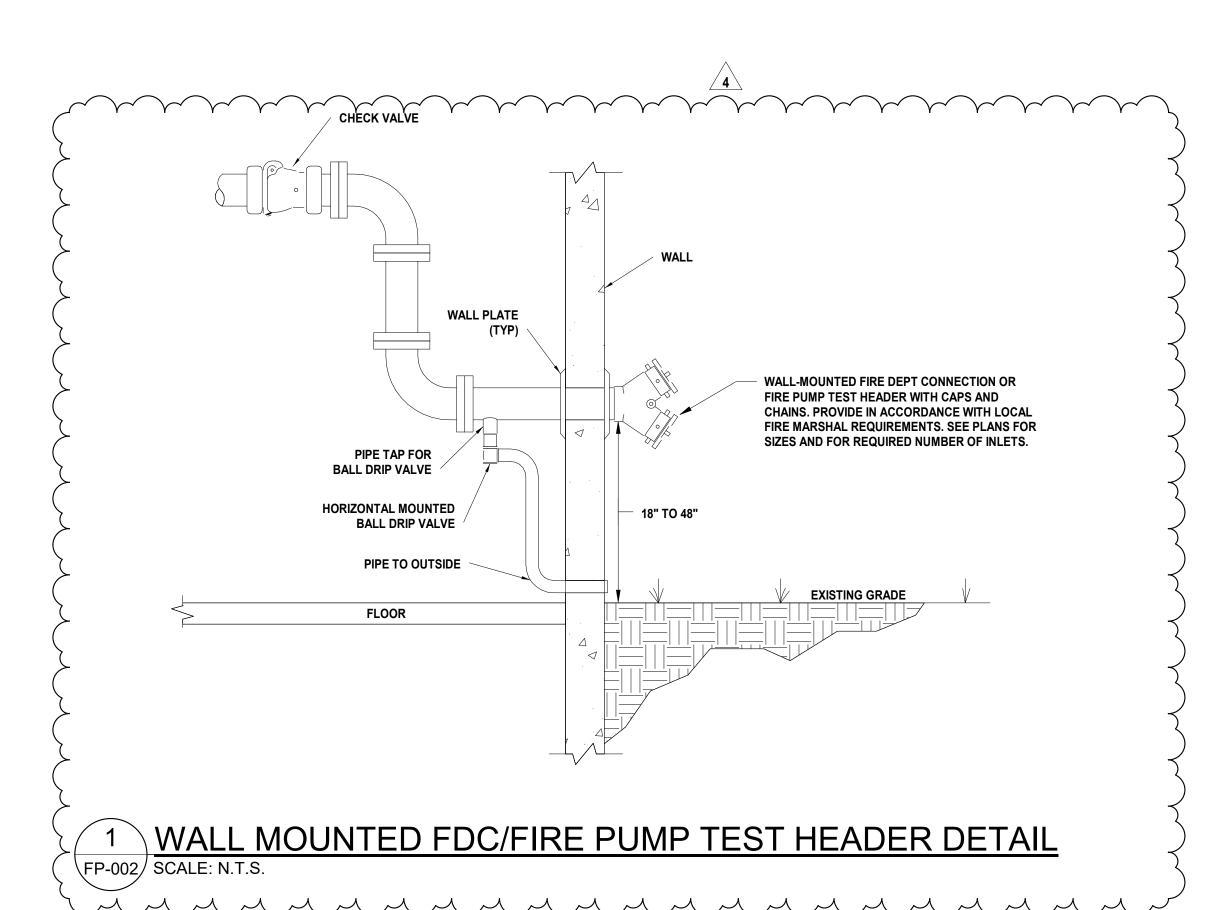
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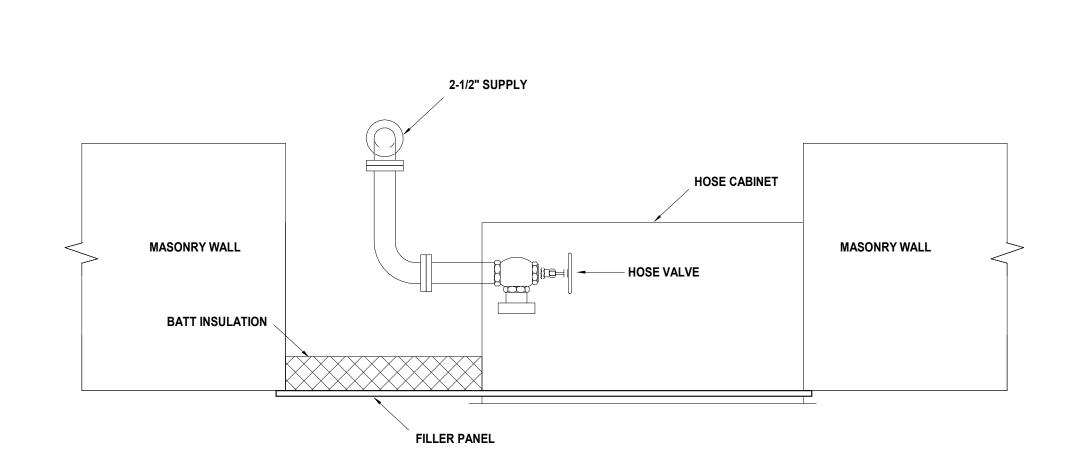
Date: 11.08.2023
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FIRE PROTECTION LEAD SHEET


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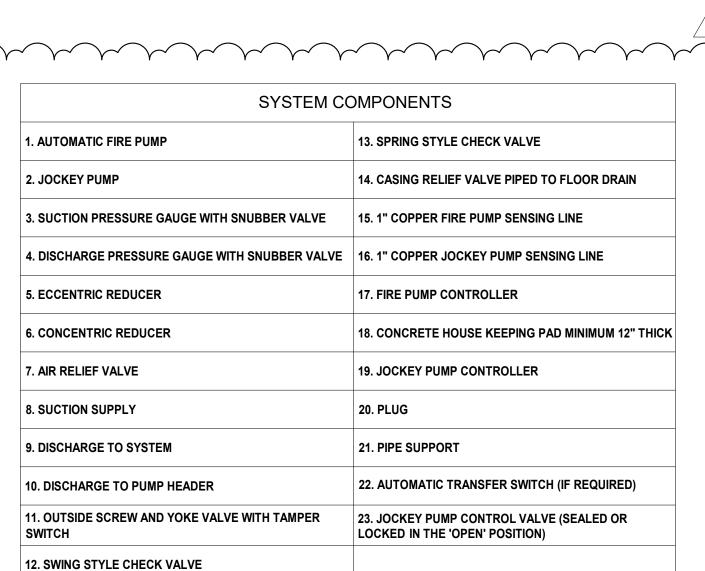
FP-001




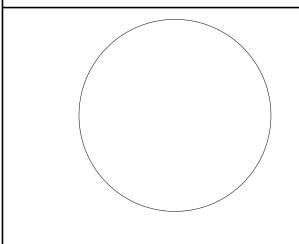



4 HOSE CABINET INSTALLATION FP-002 SCALE: N.T.S.



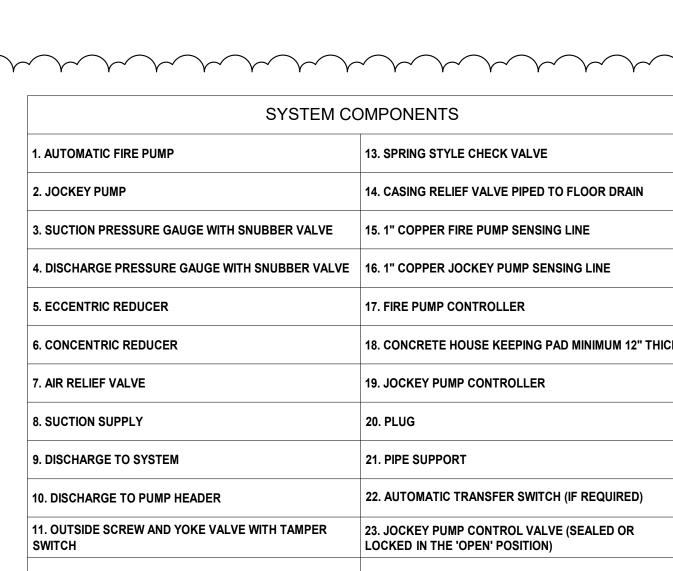

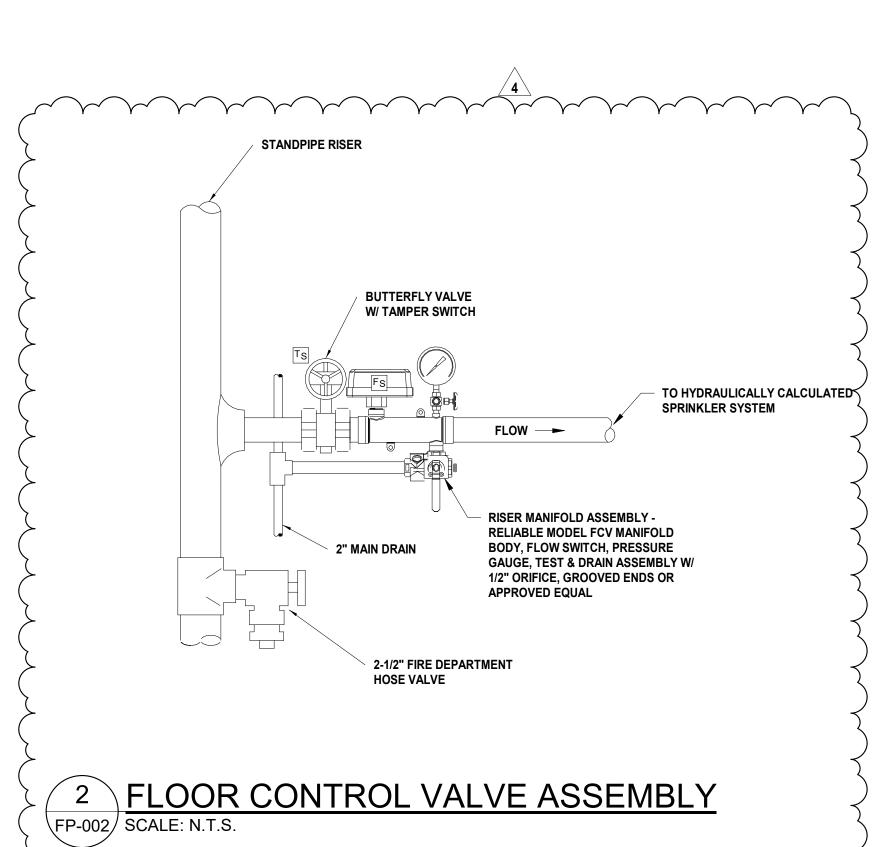

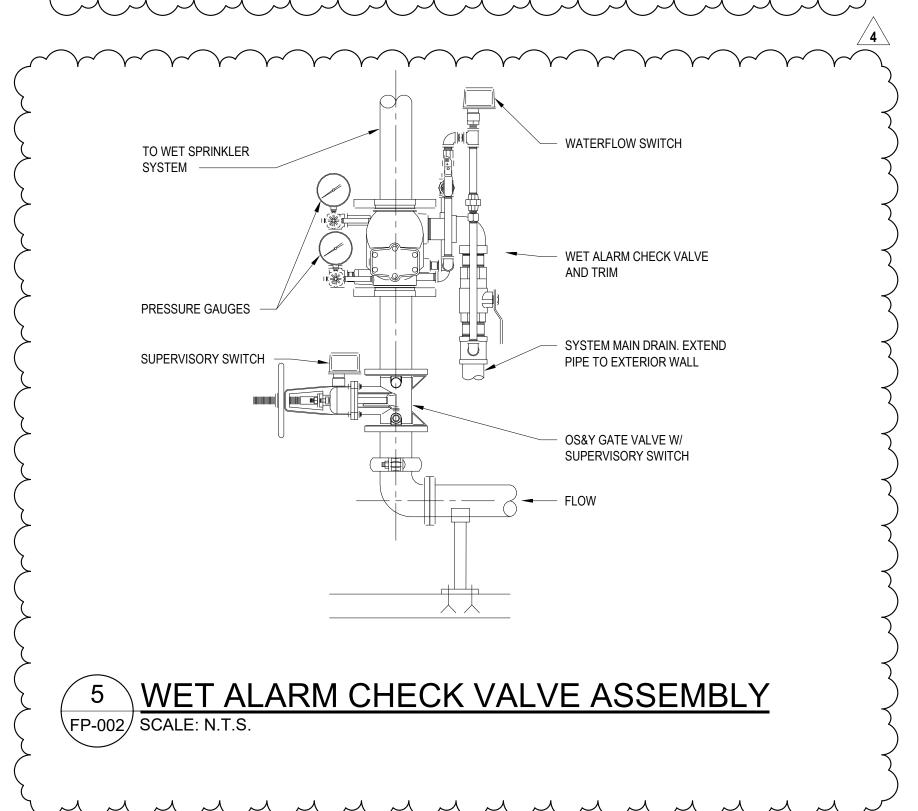

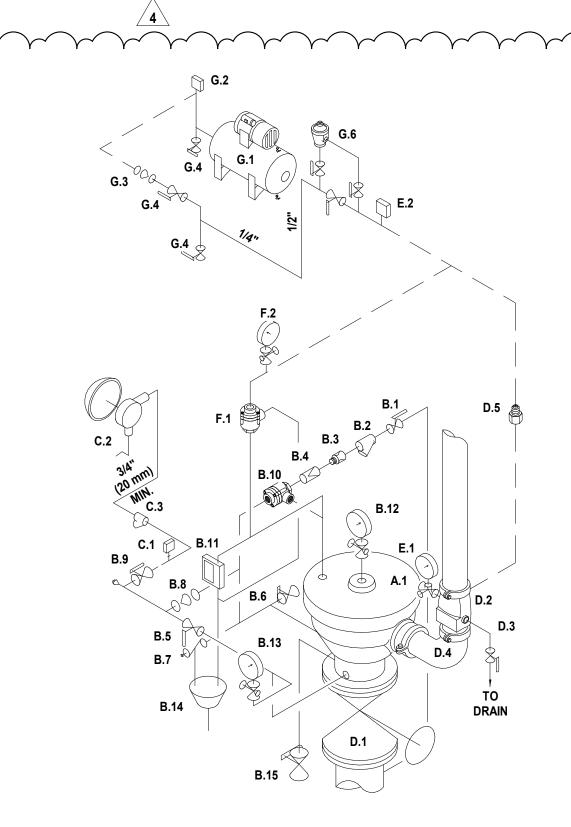

B.6 AUXILIARY DRAIN VALVE (NORMALLY CLOSED) **B.7 DRIP CHECK VALVE B.8 DRAIN CHECK VALVE B.9 ALARM SHUT-OFF VALVE (NORMALL OPEN)** B.10 PRESSURE SHUT-OFF VALVE (PSOV) **B.11 EMERGENCY RELEASE** B.12 PRIMING PRESSURE WATER GAUGE AND VALVE B.13 WATER SUPPLY PRESSURE GAUGE AND VALVE **B.14 DRAIN CUP** B.15 FLOW TEST VALVE (NORMALLY CLOSED) C. WATER FLOW ALARM EQUIPMENT C.1 ALARM PRESSURE SWITCH C.2 WATER MOTOR ALARM (STRAINER REQUIRED) **C.3 STRAINER** D.1 WATER SUPPLY CONTROL VALVE
D.2 EASY RISER CHECK VALVE OR RUBBER SEATED **CHECK VALVE** D.3 SPRINKLER SYSTEM MAIN DRAIN D.4 90 ELL (GROOVED ELL SHOWN. DELUGE VALVE ALSO AVAILABLE WITH FLANGED OUTLET D.5 FLOAT CHECK E. SUPERVISORY AIR SUPPLY E.1 SYSTEM PRESSURE GAUGE AND VALVE E.2 AIR PRESSURE SUPERVISORY SWITCH F. RELEASE SYSTEM F.1 ANTI-FLOOR ASSEMBLY F.2 AIR PRESSURE GAUGE AND VALVE G. AIR SUPPLY G.1 AUTOMATIC AIR SUPPLY. AIR COMPRESSOR AND TANK SHOWN FOR CLARITY. G.2 AIR SUPERVISORY PRESSURE SWITCH (COMPRESSOR ON/OFF CONTROL SWITCH) G.3 SOFT SEAT CHECK VALVE **G.4 SHUT-OFF VALVE** G.5 AIR MAINTENANCE DEVICE & BY-PASS TRIM

SYSTEM COMPONENTS

B.2 STRAINER

B.1 PRIMING VALVE (NORMALLY OPEN)

B.5 ALARM TEST VALVE (NORMALLY CLOSED)


B.3 1/16" RESTRICTED ORIFICE B.4 SPRING LOADED CHECK VALVE

A. VALVE A.1 DRY VALVE B. DRY VALVE EASY TRIM


³ DRY PIPE VALVE ASSEMBLY

IN "SYSTEM COMPONENTS" TABLE.

- DASHED LINES INDICATE PIPE REQUIRED BUT NOT LISTED

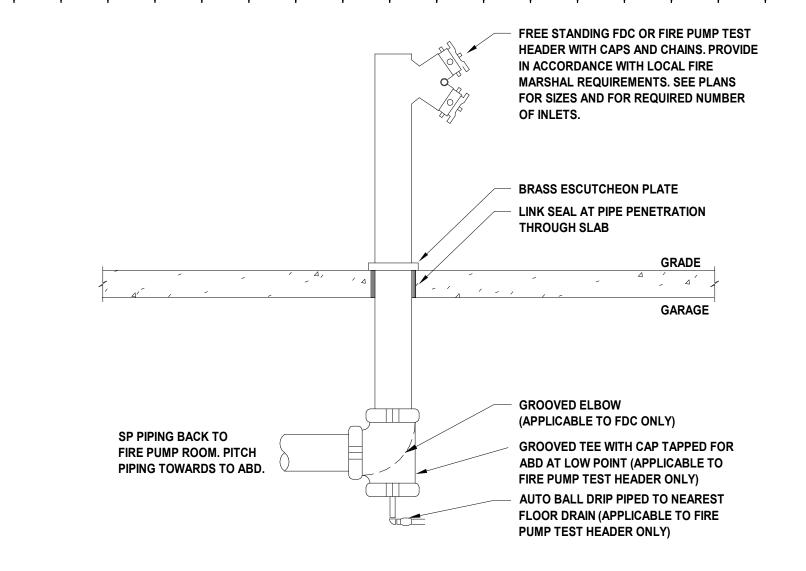

6 FREESTANDING FDC/FIRE PUMP TEST HEADER DETAIL

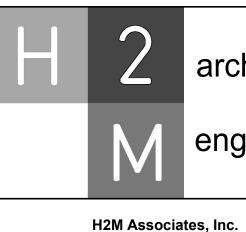


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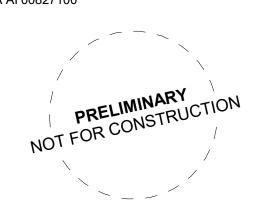


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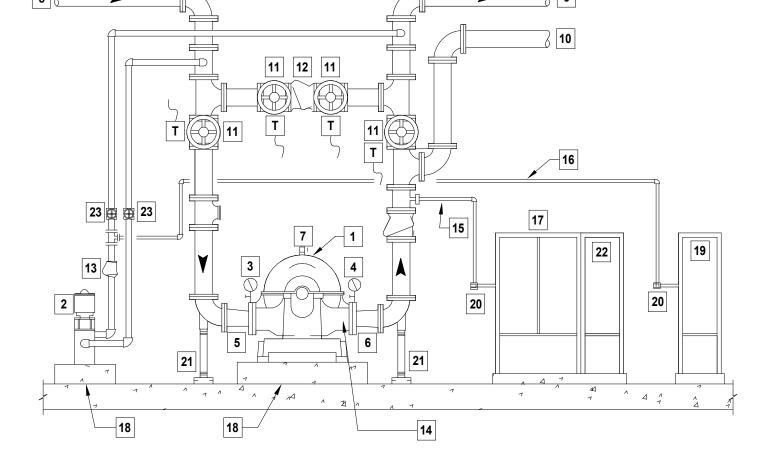
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Sheet Name: FIRE PROTECTION DETAILS

Sheet No:

FP-002

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FIRE PUMP SCHEMATIC
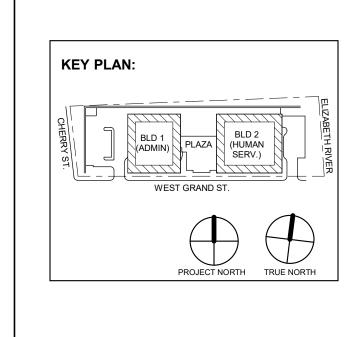
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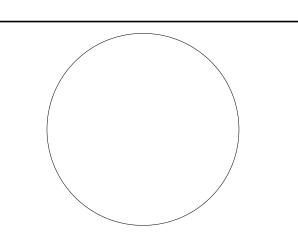
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4. PROVIDE SPRINKLER COVERAGE UNDER OBSTRUCTIONS AS REQUIRED BY NFPA-13. 5. PROVIDE ADDITIONAL SPRINKLER HEADS TO COMPLY WITH NFPA COVERAGE.

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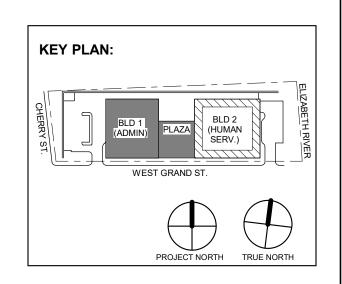
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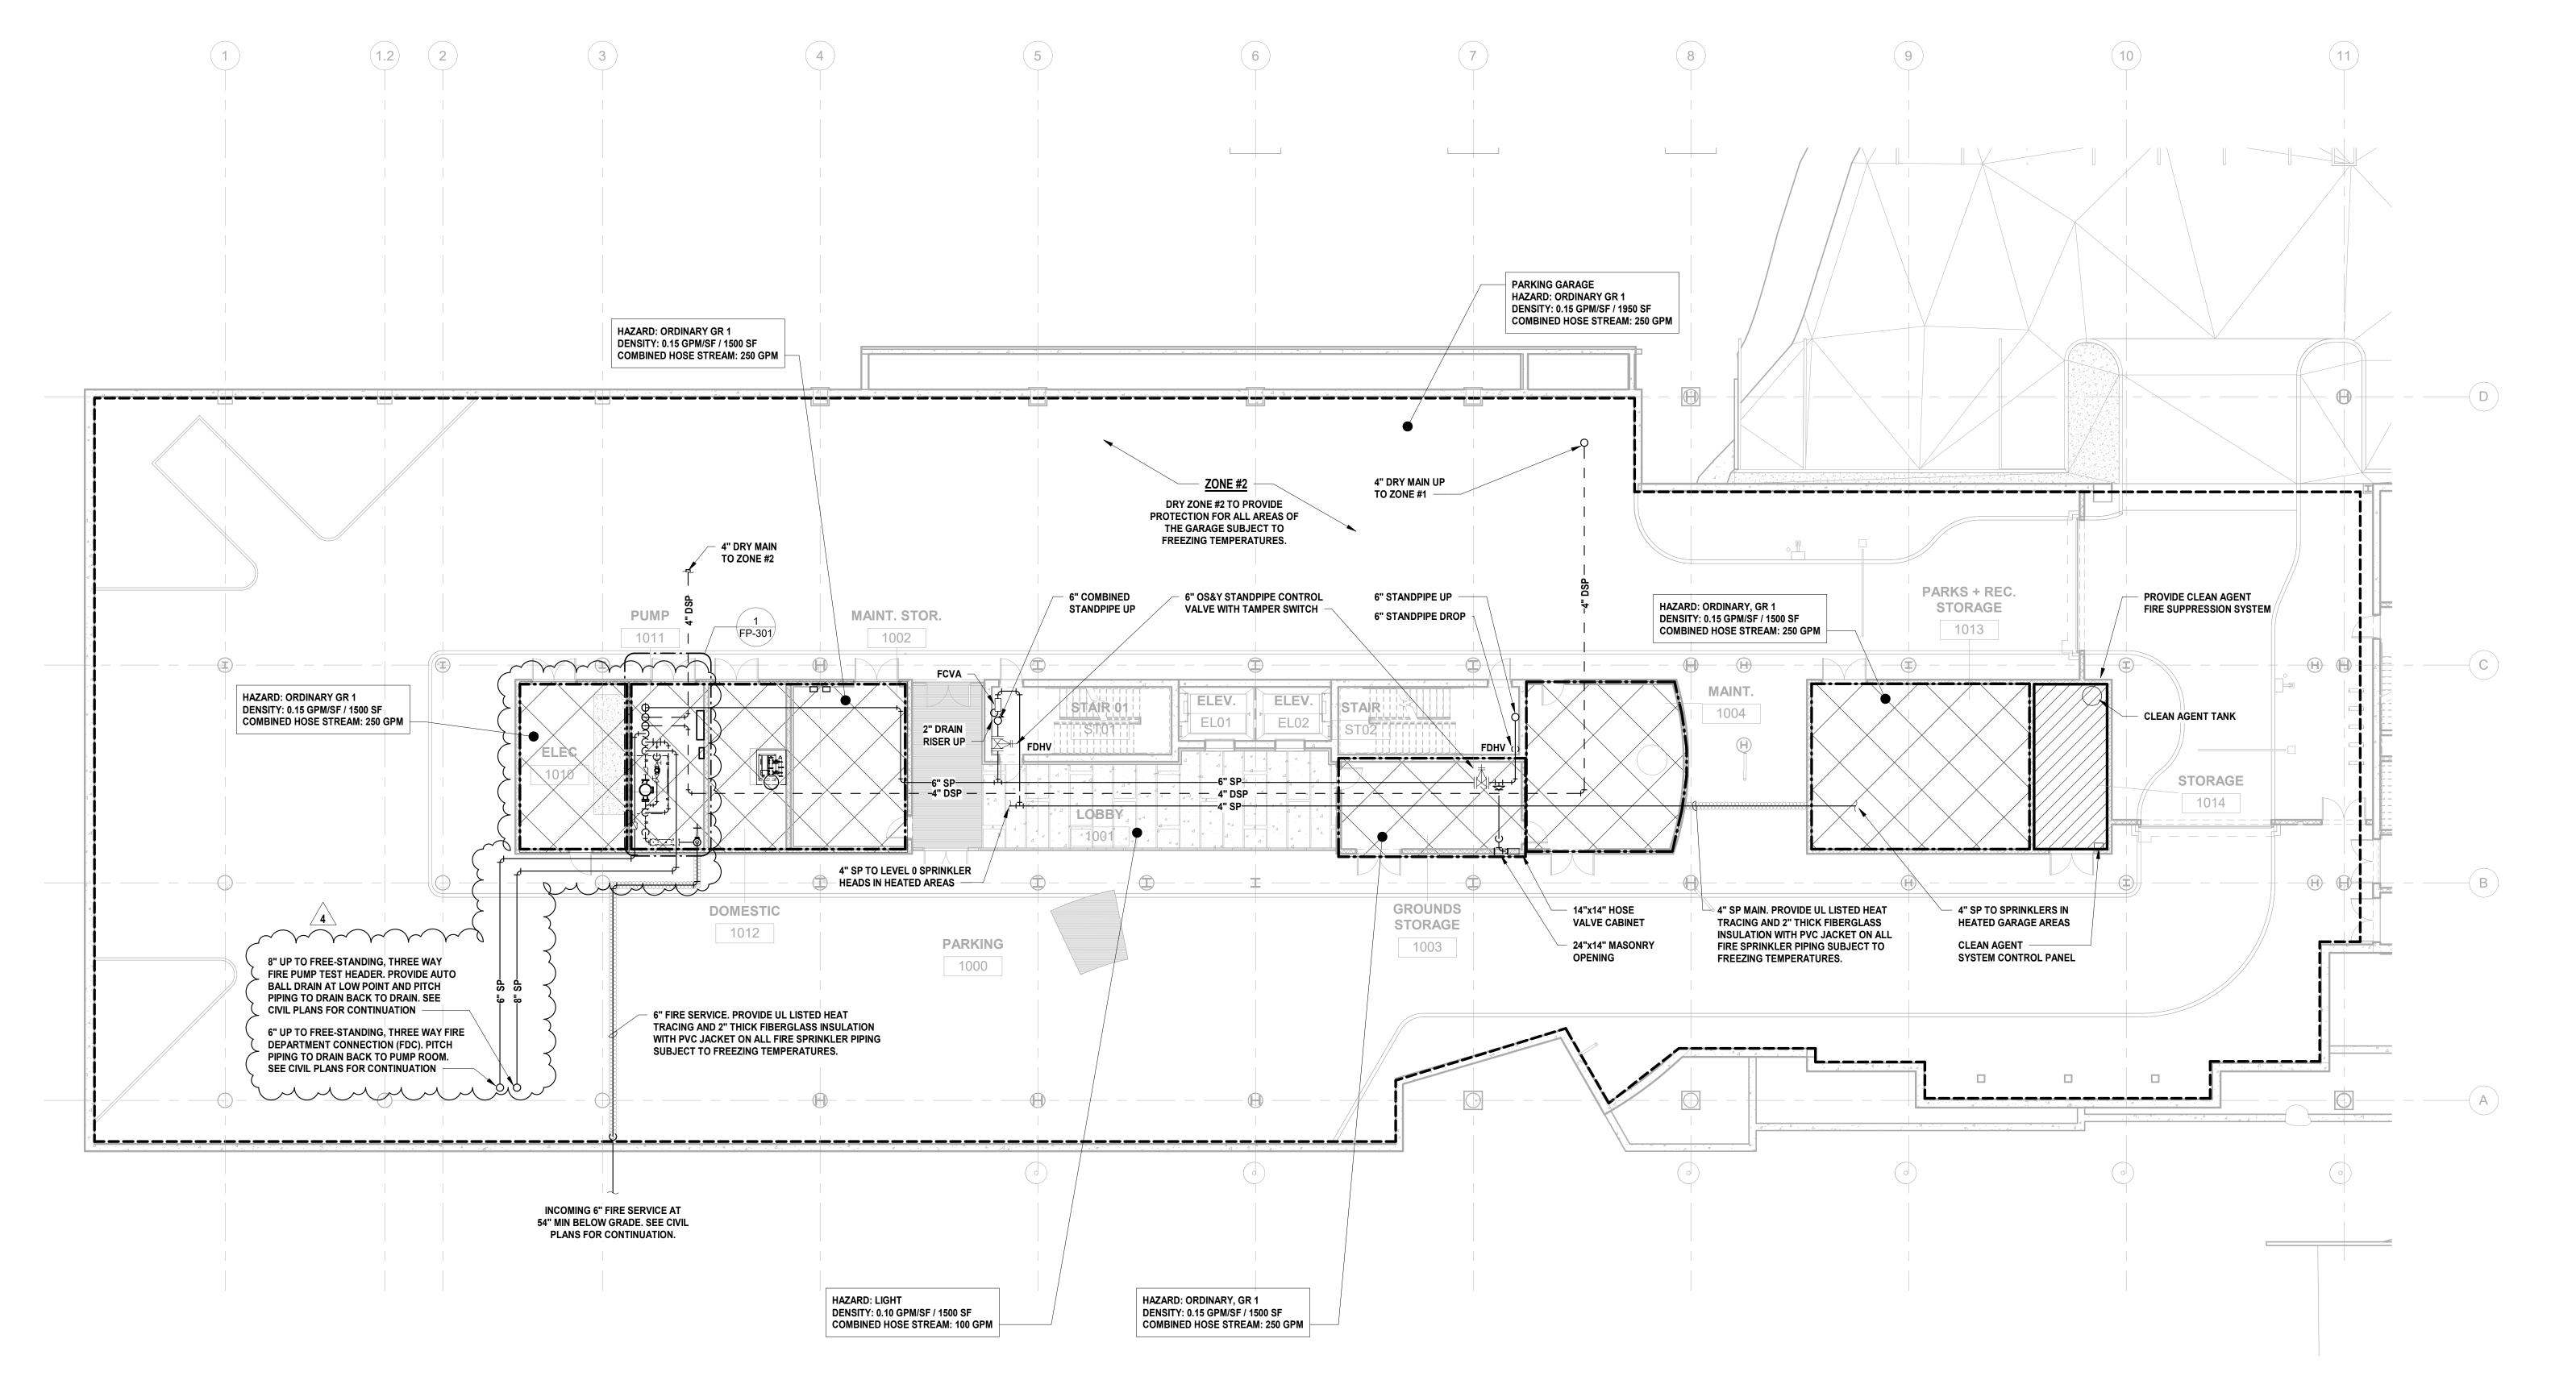
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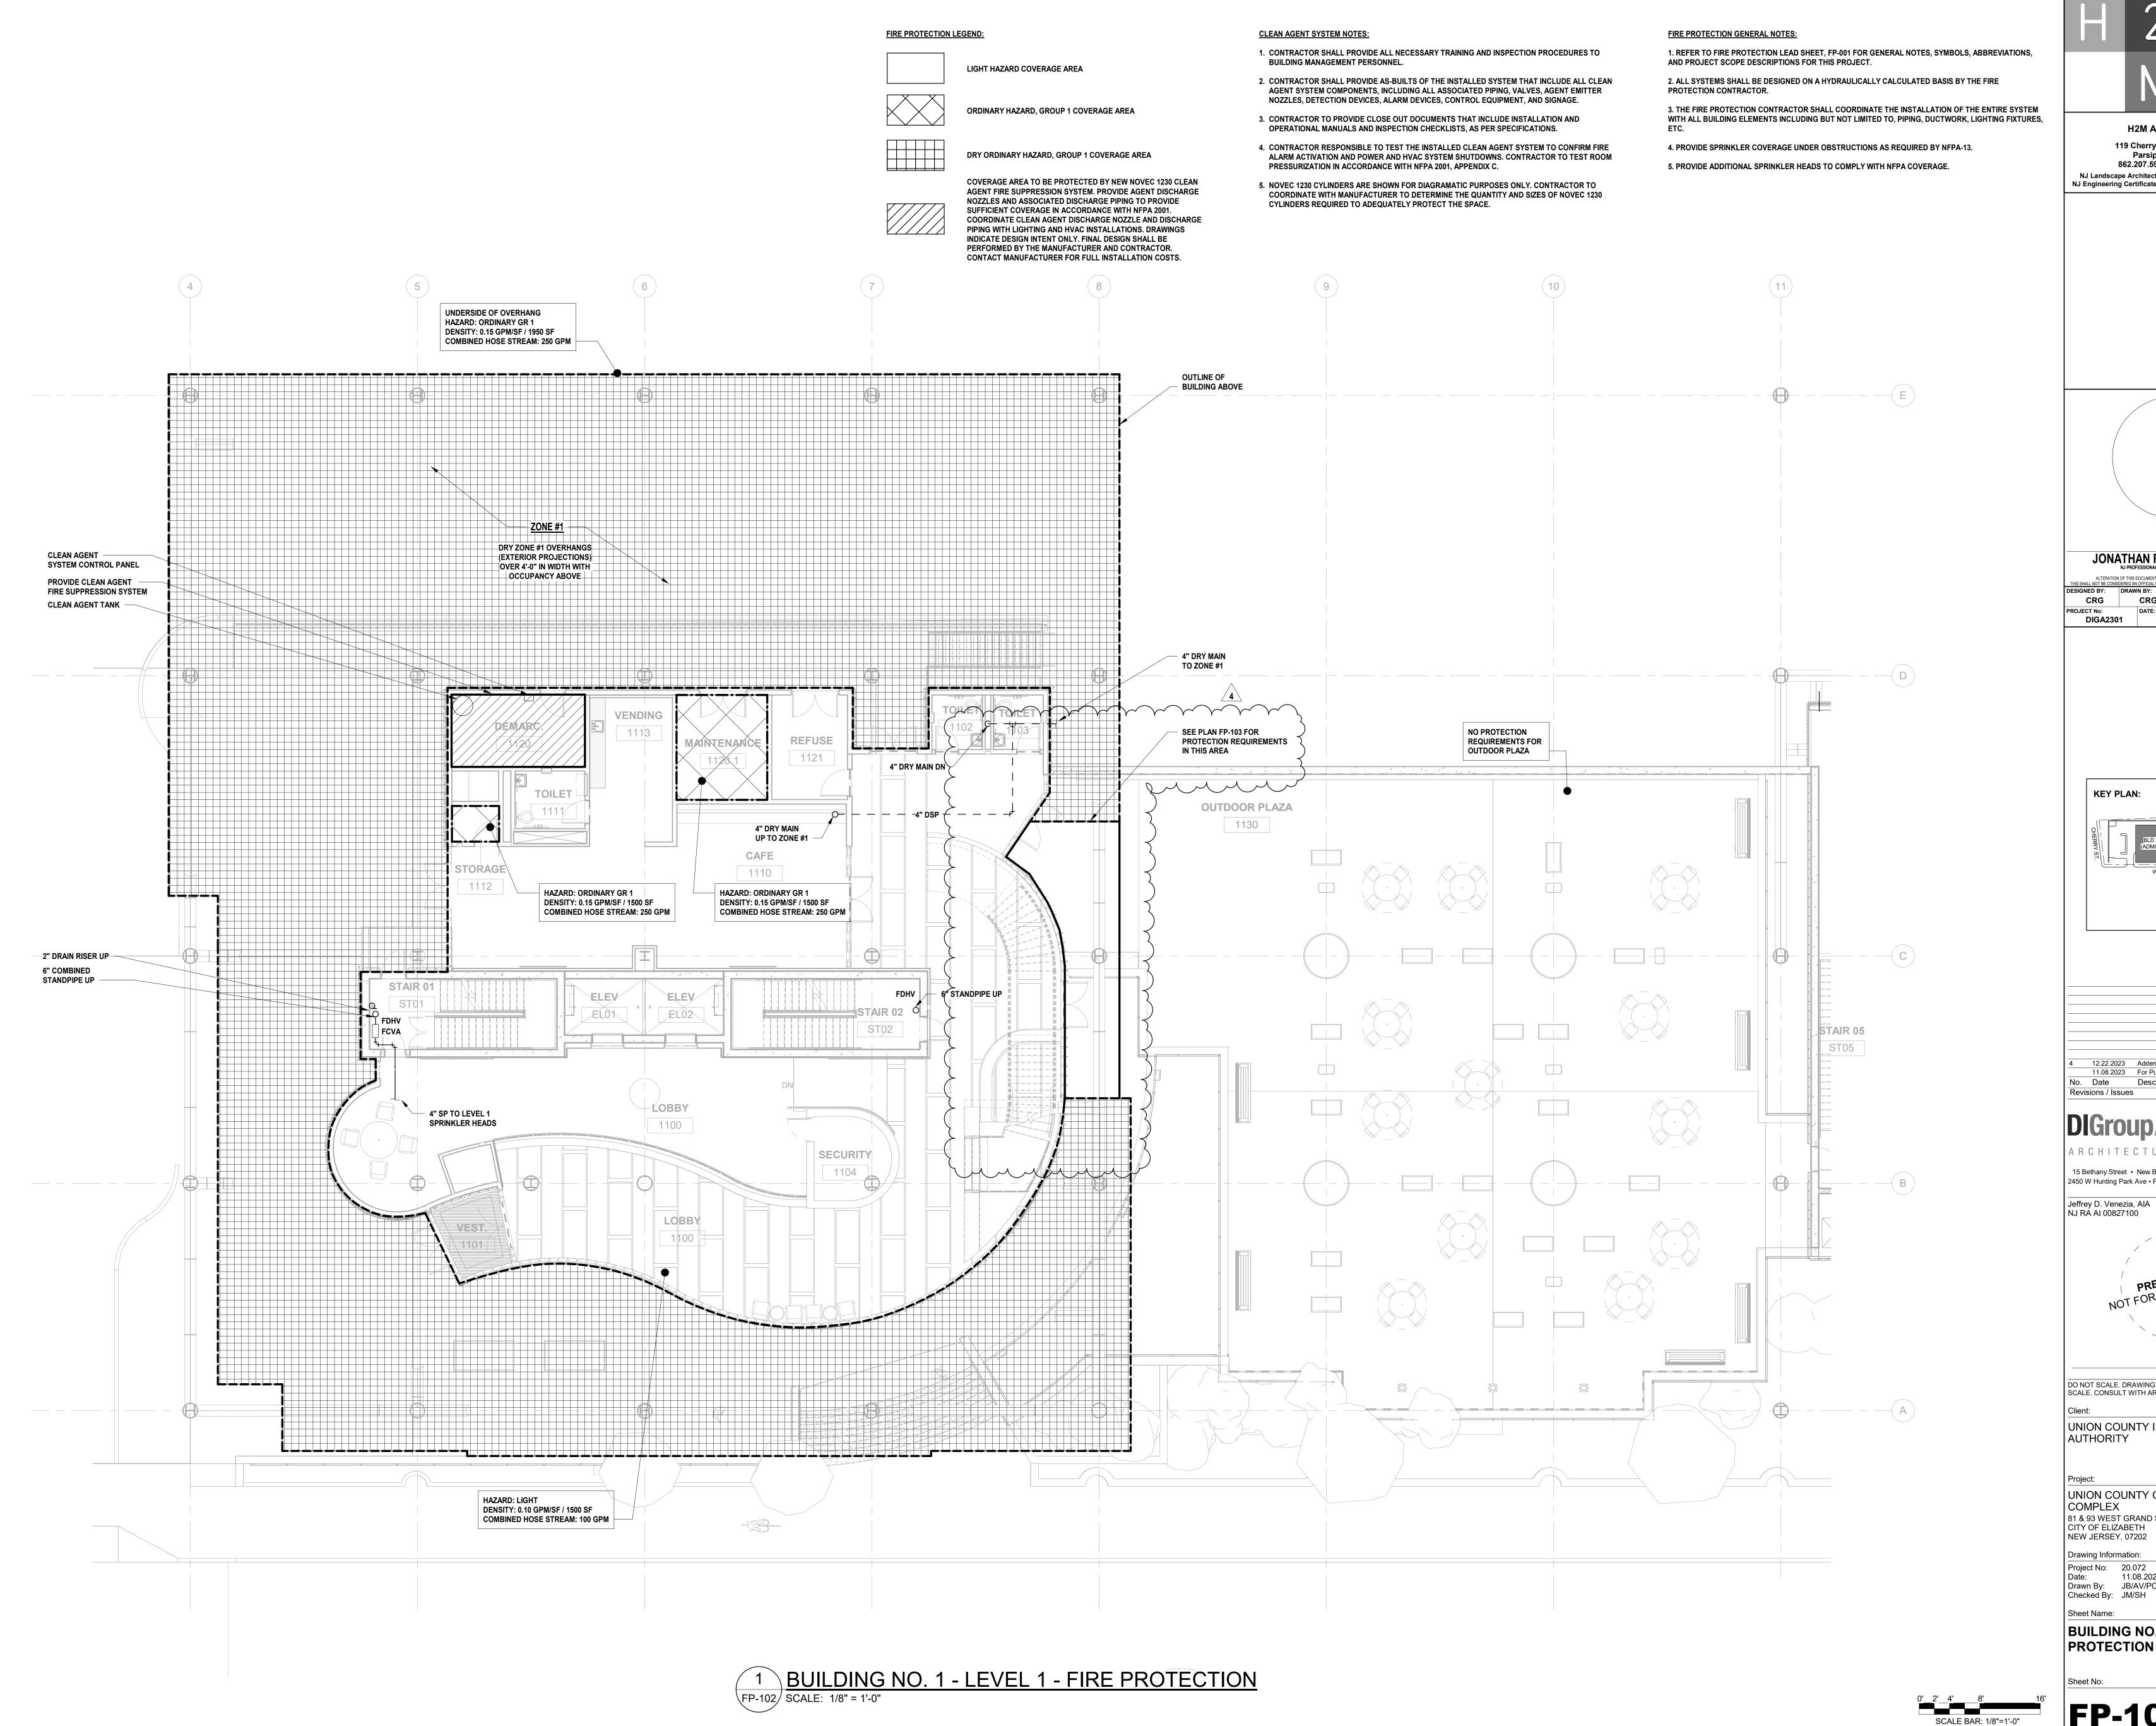
NEW JERSEY, 07202 Drawing Information: Project No: 20.072 Date: 11.08.2023 Drawn By: JB/AV/PC

Checked By: JM/SH

Sheet Name: BUILDING NO. 1 - LEVEL 0 - FIRE PROTECTION PLAN




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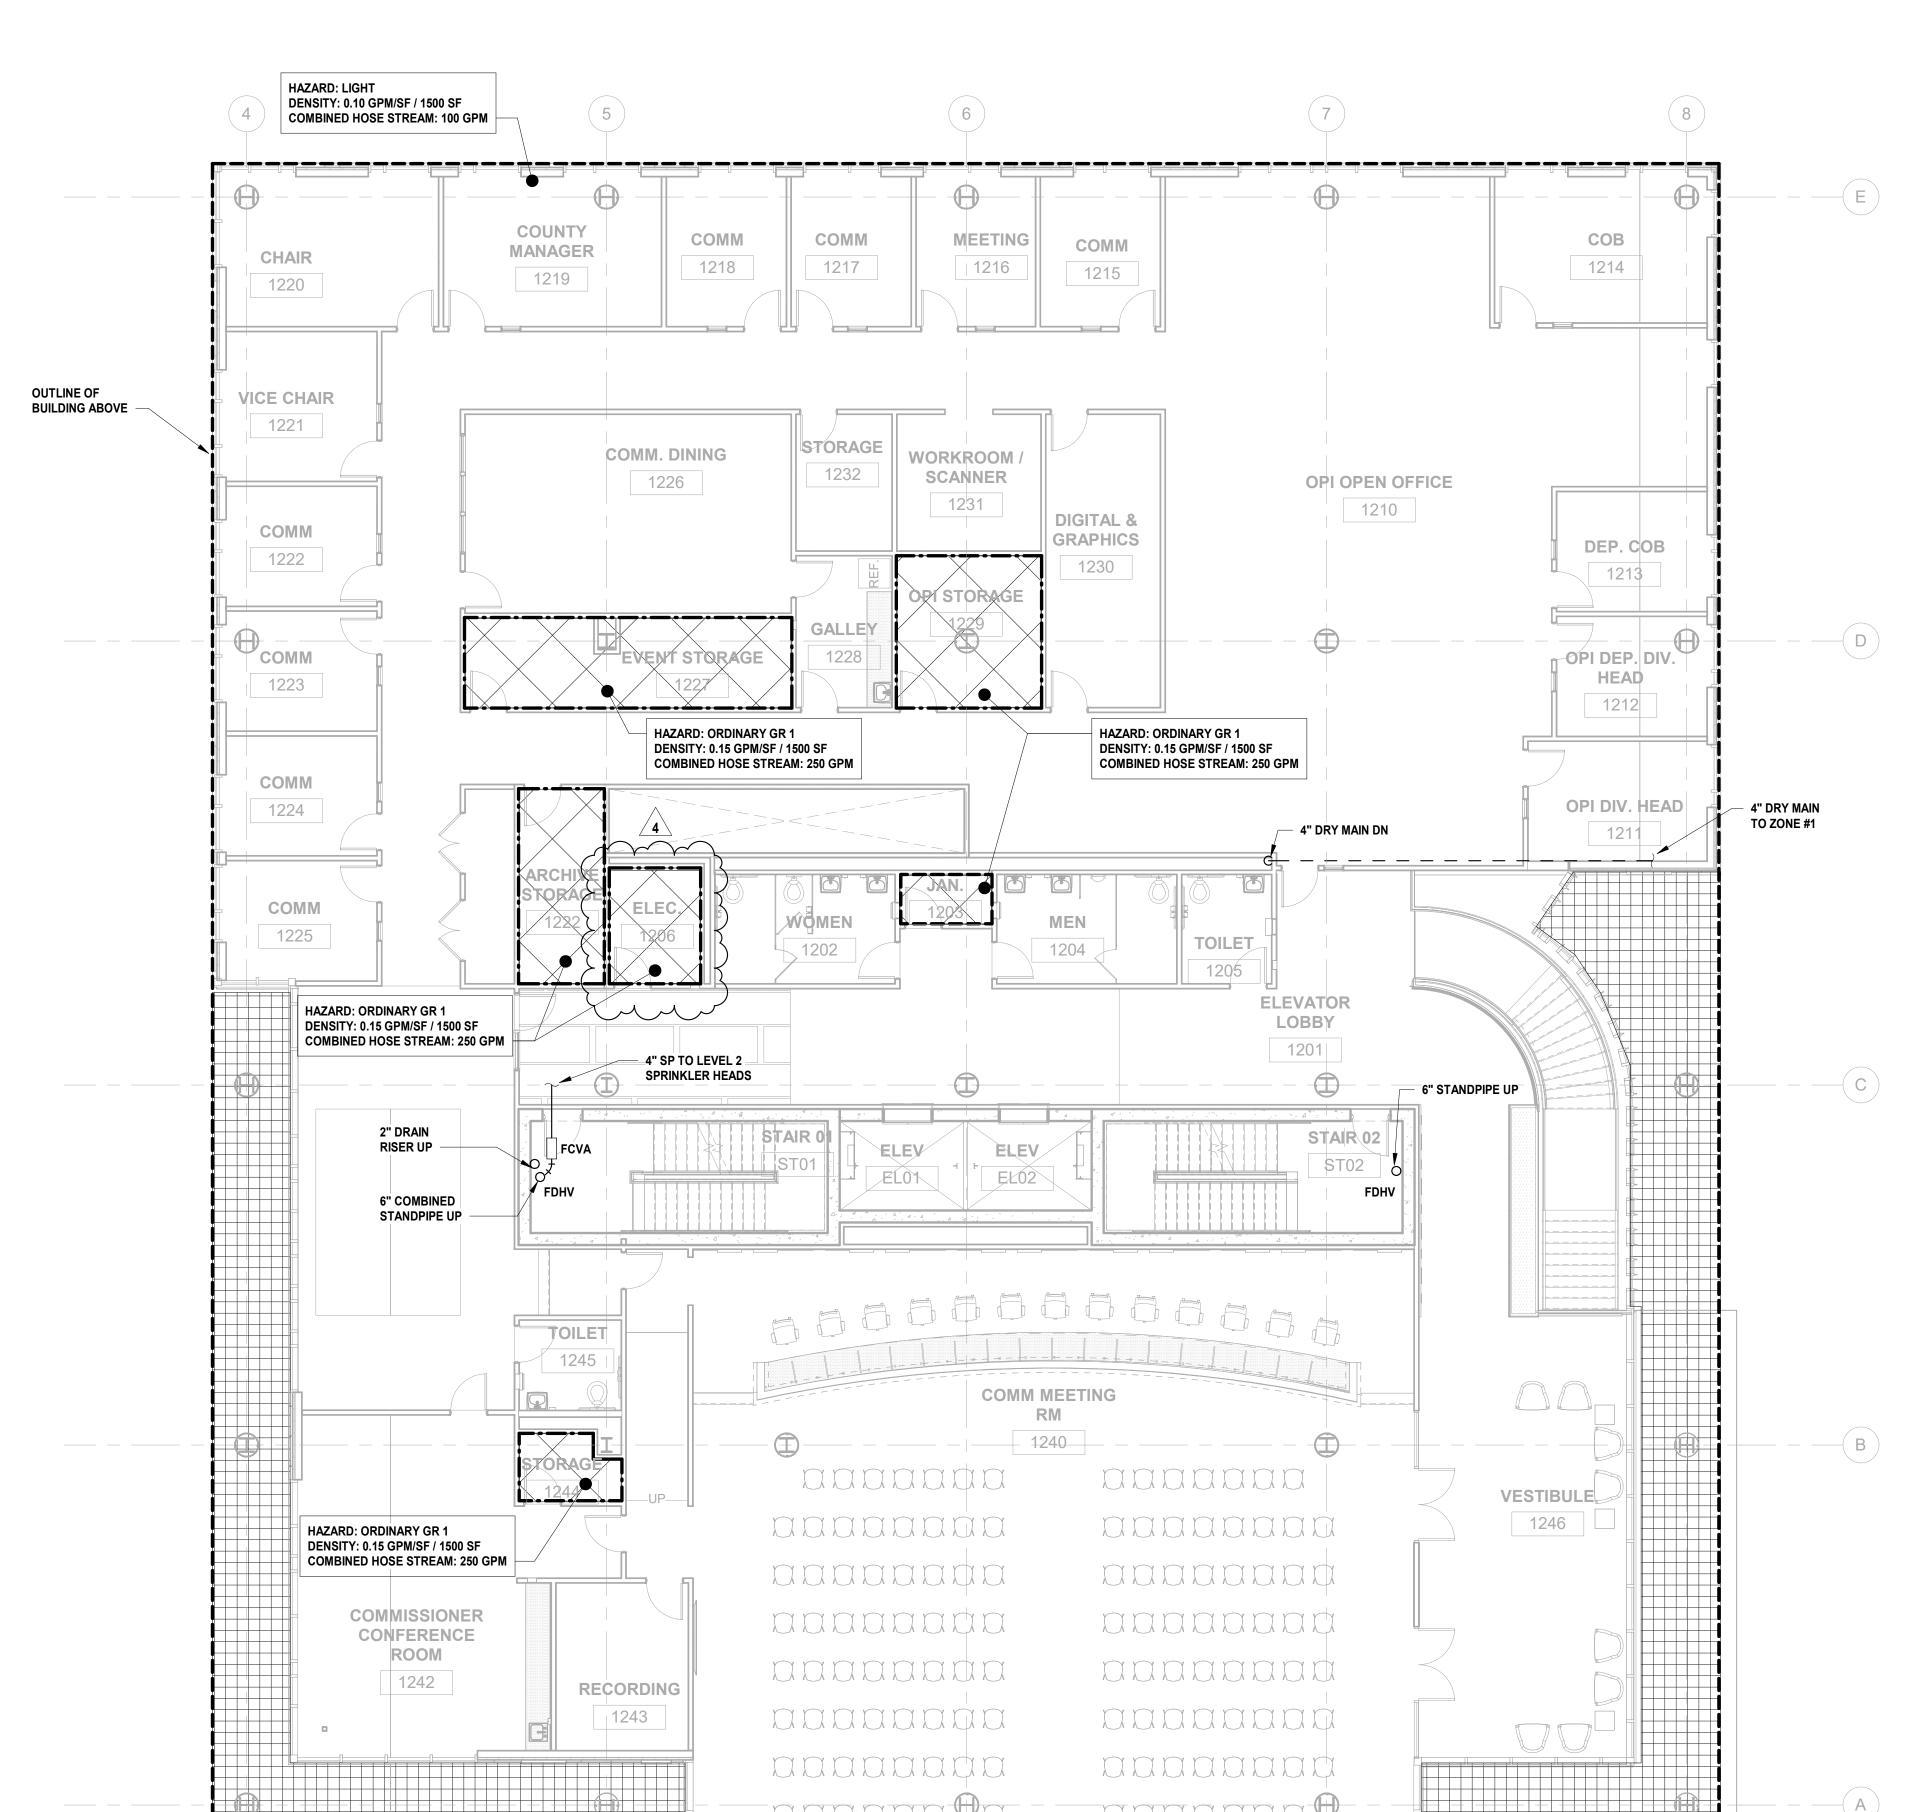
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Drawn By: JB/AV/PC Checked By: JM/SH

Sheet Name: BUILDING NO. 1 - LEVEL 1 - FIRE PROTECTION PLAN



1 BUILDING NO. 1 - LEVEL 2 - FIRE PROTECTION

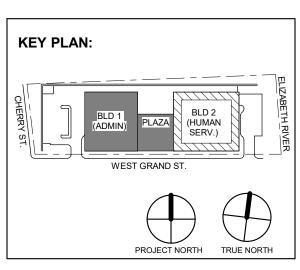SCALE: 1/8" = 1'-0"

(UNDERSIDE OF OVERHANG)

DENSITY: 0.15 GPM/SF / 1950 SF

COMBINED HOSE STREAM: 250 GPM

HAZARD: ORDINARY GR 1

DRY ZONE #1 - OVERHANGS (EXTERIOR PROJECTIONS)

OVER 4'-0" IN WIDTH WITH

OCCUPANCY ABOVE -

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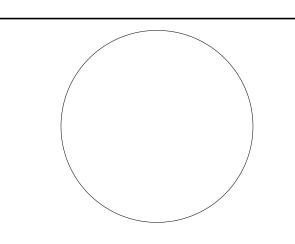
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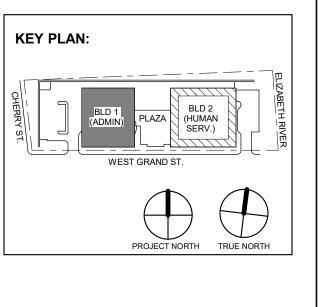
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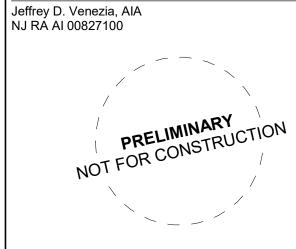
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Date: 11.08.2023
Drawn By: JB/AV/PC
Checked By: JM/SH

Sheet Name:
BUILDING NO. 1 - LEVEL 2 - FIRE
PROTECTION PLAN

eet No:

FP-103



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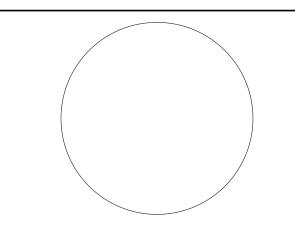
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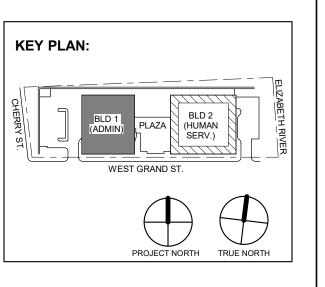
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4 12.22.2023 Addendum No. 04 11.08.2023 For Public Bid No. Date Description


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Project:

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Drawing Information:


Project No: 20.072
Date: 11.08.2023
Drawn By: JB/AV/PC
Checked By: JM/SH

Drawn By: JB/AV/PC
Checked By: JM/SH
Sheet Name:

BUILDING NO. 1 - LEVEL 3 - FIRE PROTECTION PLAN

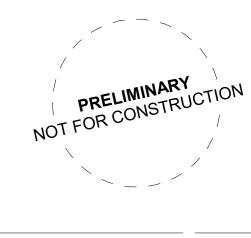et No:



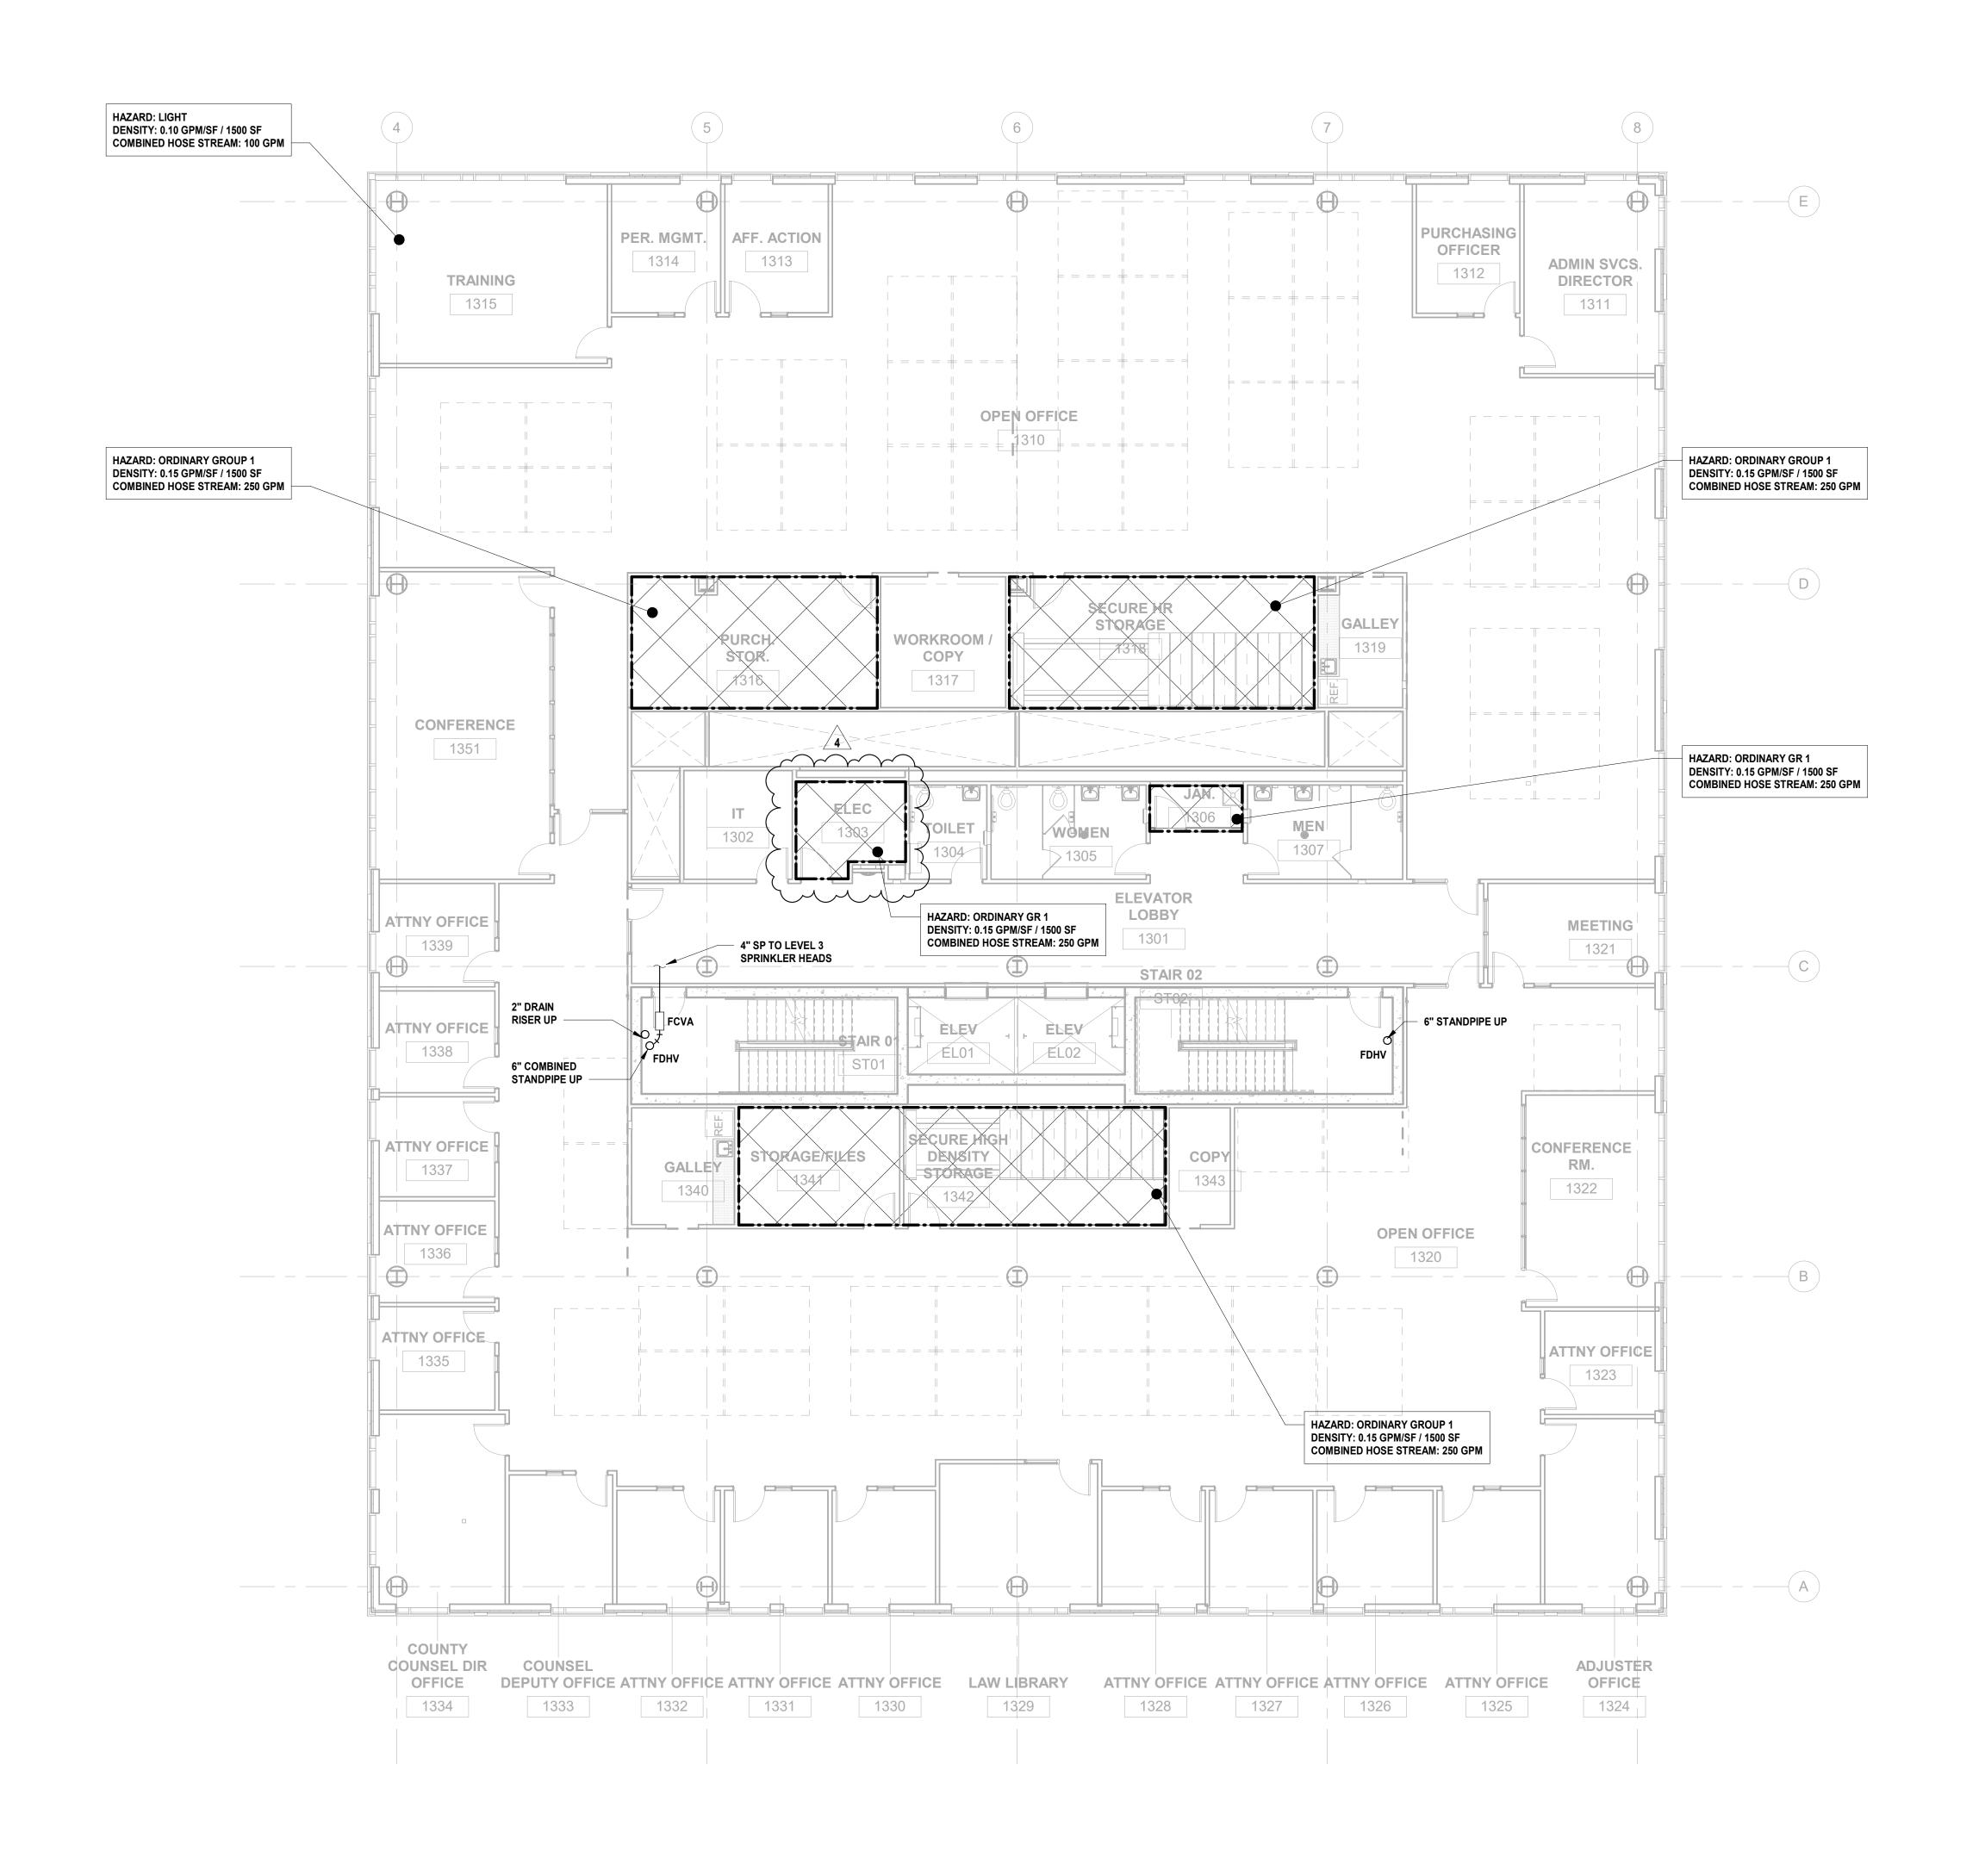

CLEAN AGENT SYSTEM NOTES:

- 1. CONTRACTOR SHALL PROVIDE ALL NECESSARY TRAINING AND INSPECTION PROCEDURES TO BUILDING MANAGEMENT PERSONNEL.
- 2. CONTRACTOR SHALL PROVIDE AS-BUILTS OF THE INSTALLED SYSTEM THAT INCLUDE ALL CLEAN AGENT SYSTEM COMPONENTS, INCLUDING ALL ASSOCIATED PIPING, VALVES, AGENT EMITTER NOZZLES, DETECTION DEVICES, ALARM DEVICES, CONTROL EQUIPMENT, AND SIGNAGE.
- 3. CONTRACTOR TO PROVIDE CLOSE OUT DOCUMENTS THAT INCLUDE INSTALLATION AND OPERATIONAL MANUALS AND INSPECTION CHECKLISTS, AS PER SPECIFICATIONS.
- 4. CONTRACTOR RESPONSIBLE TO TEST THE INSTALLED CLEAN AGENT SYSTEM TO CONFIRM FIRE ALARM ACTIVATION AND POWER AND HVAC SYSTEM SHUTDOWNS. CONTRACTOR TO TEST ROOM PRESSURIZATION IN ACCORDANCE WITH NFPA 2001, APPENDIX C.
- 5. NOVEC 1230 CYLINDERS ARE SHOWN FOR DIAGRAMATIC PURPOSES ONLY. CONTRACTOR TO COORDINATE WITH MANUFACTURER TO DETERMINE THE QUANTITY AND SIZES OF NOVEC 1230 CYLINDERS REQUIRED TO ADEQUATELY PROTECT THE SPACE.

FIRE PROTECTION GENERAL NOTES:

1. REFER TO FIRE PROTECTION LEAD SHEET, FP-001 FOR GENERAL NOTES, SYMBOLS, ABBREVIATIONS, AND PROJECT SCOPE DESCRIPTIONS FOR THIS PROJECT.

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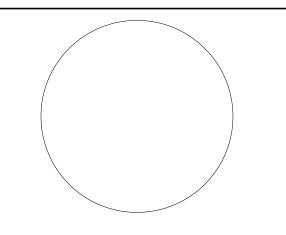
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5. PROVIDE ADDITIONAL SPRINKLER HEADS TO COMPLY WITH NFPA COVERAGE.

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engineers

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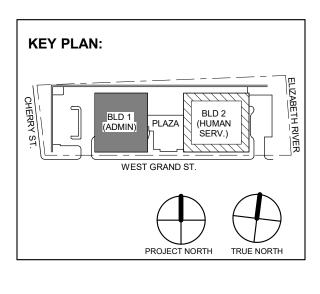
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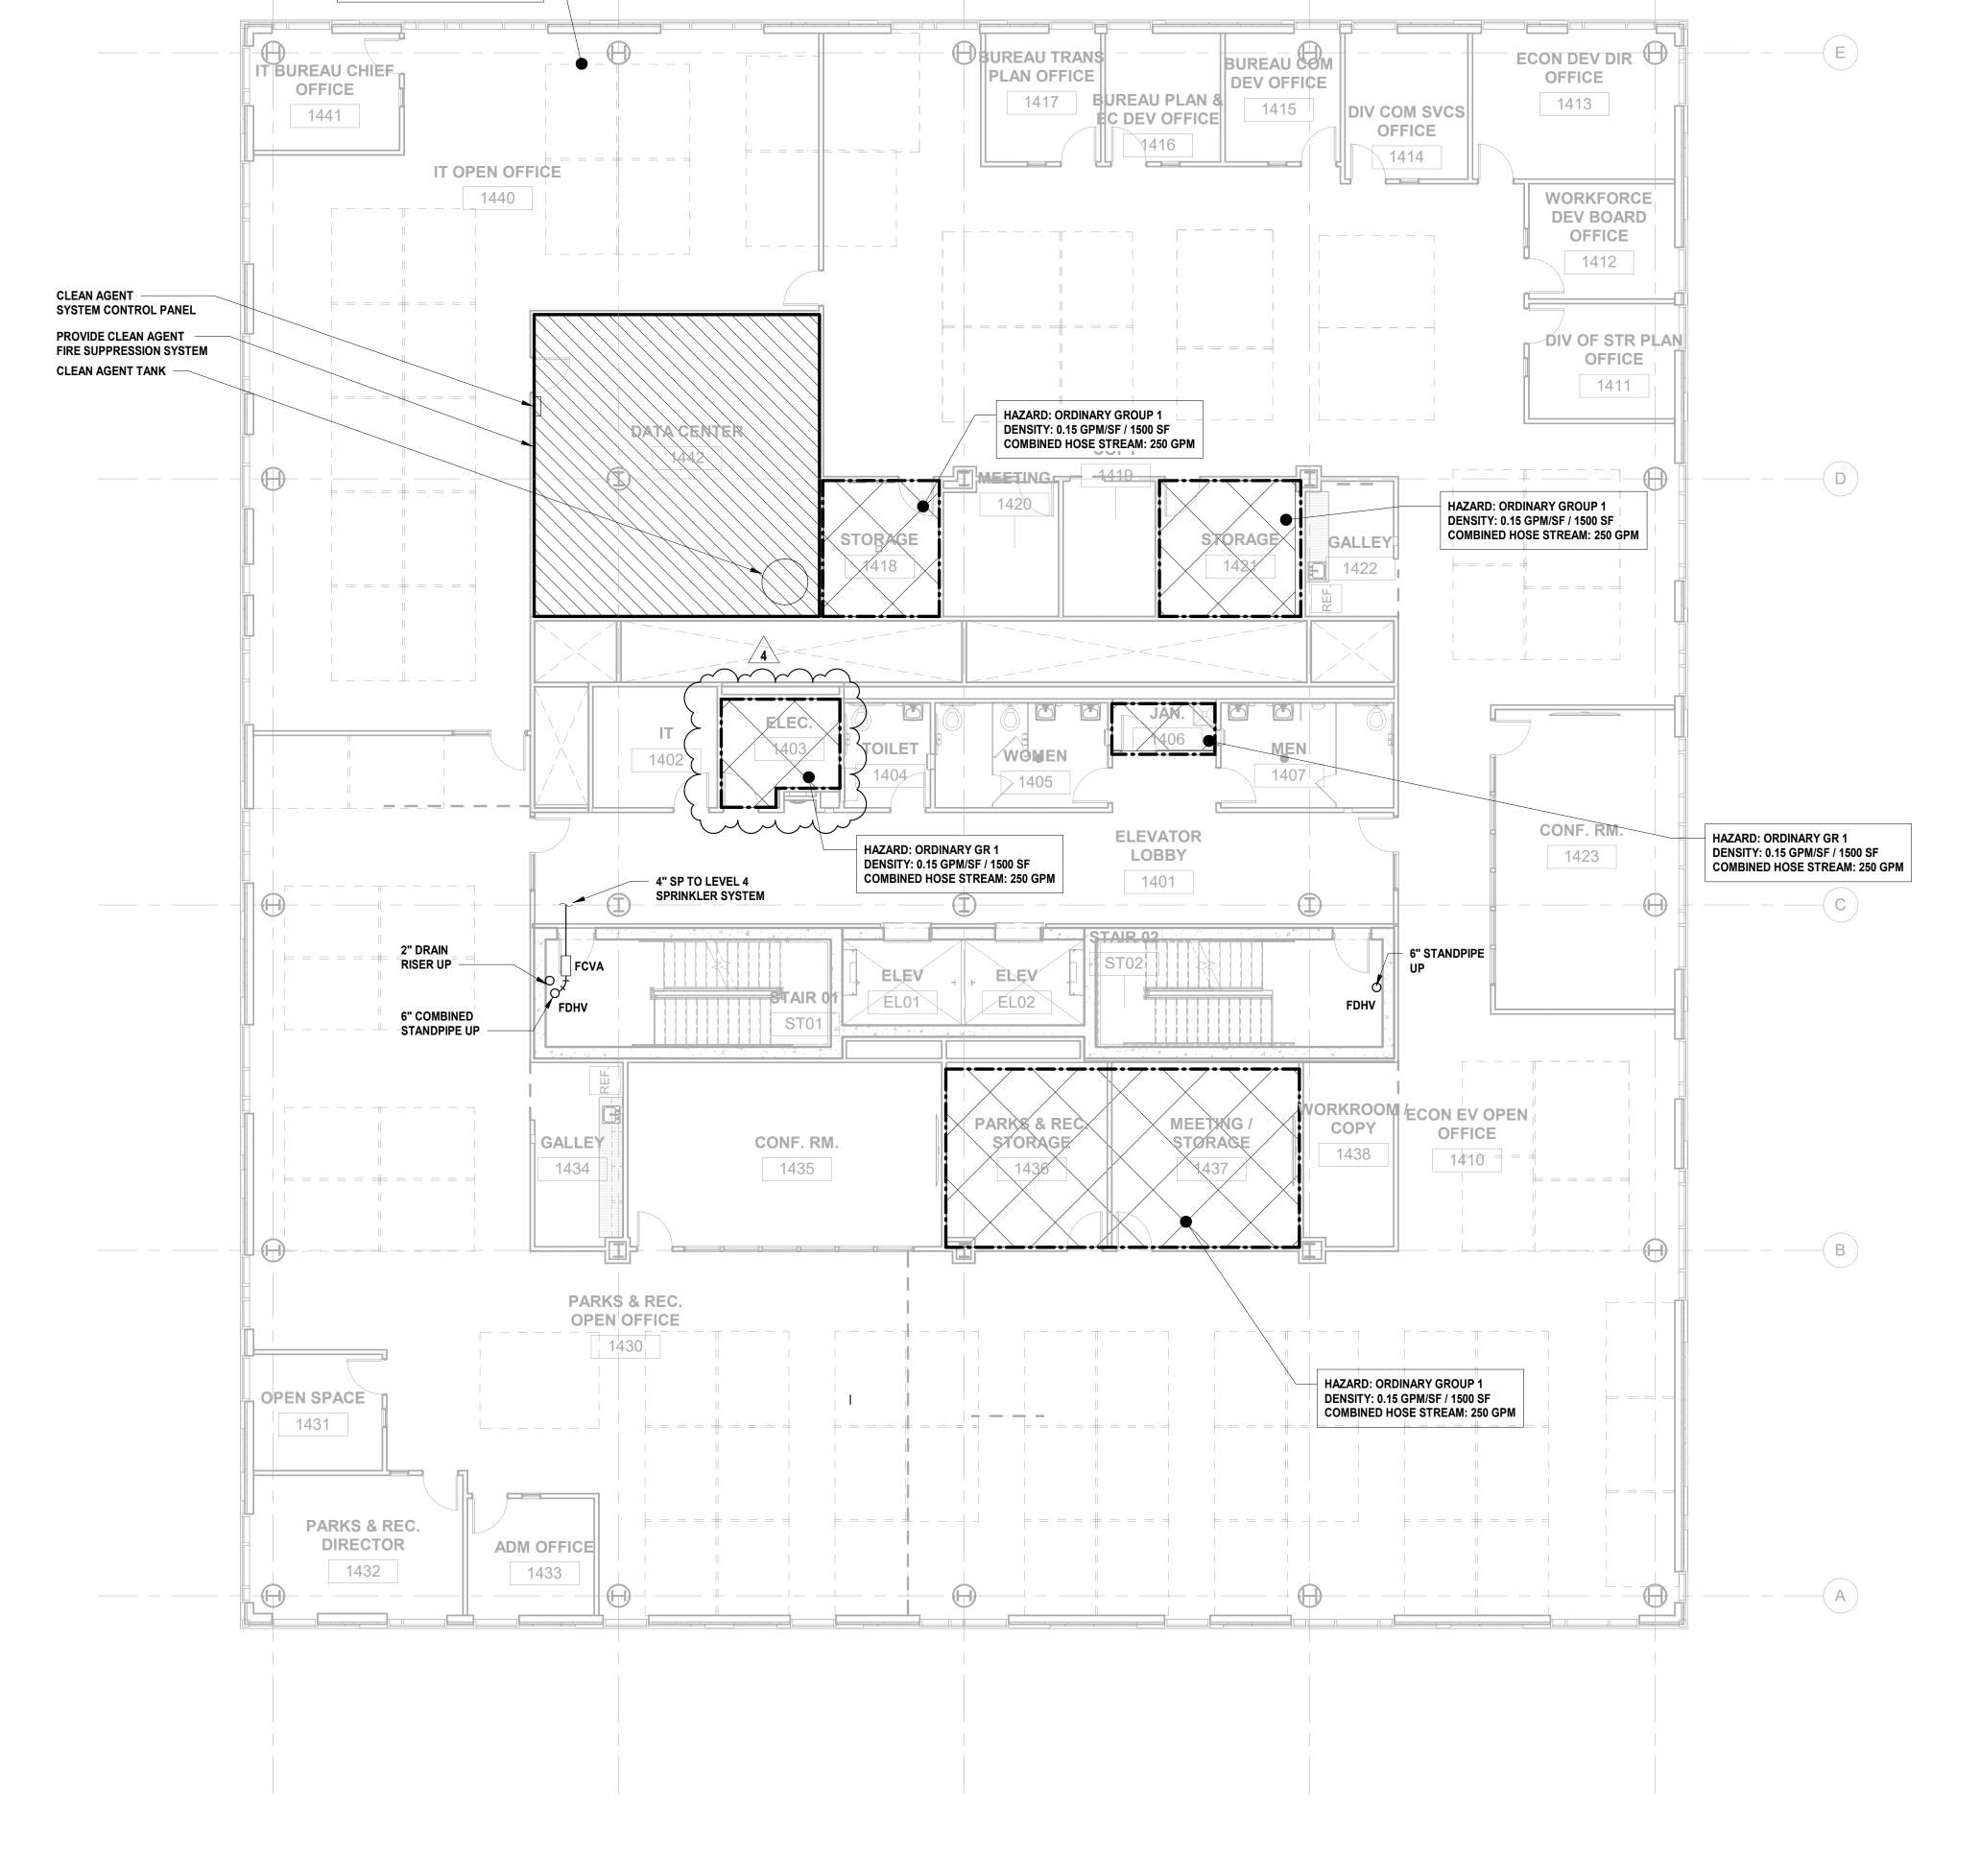
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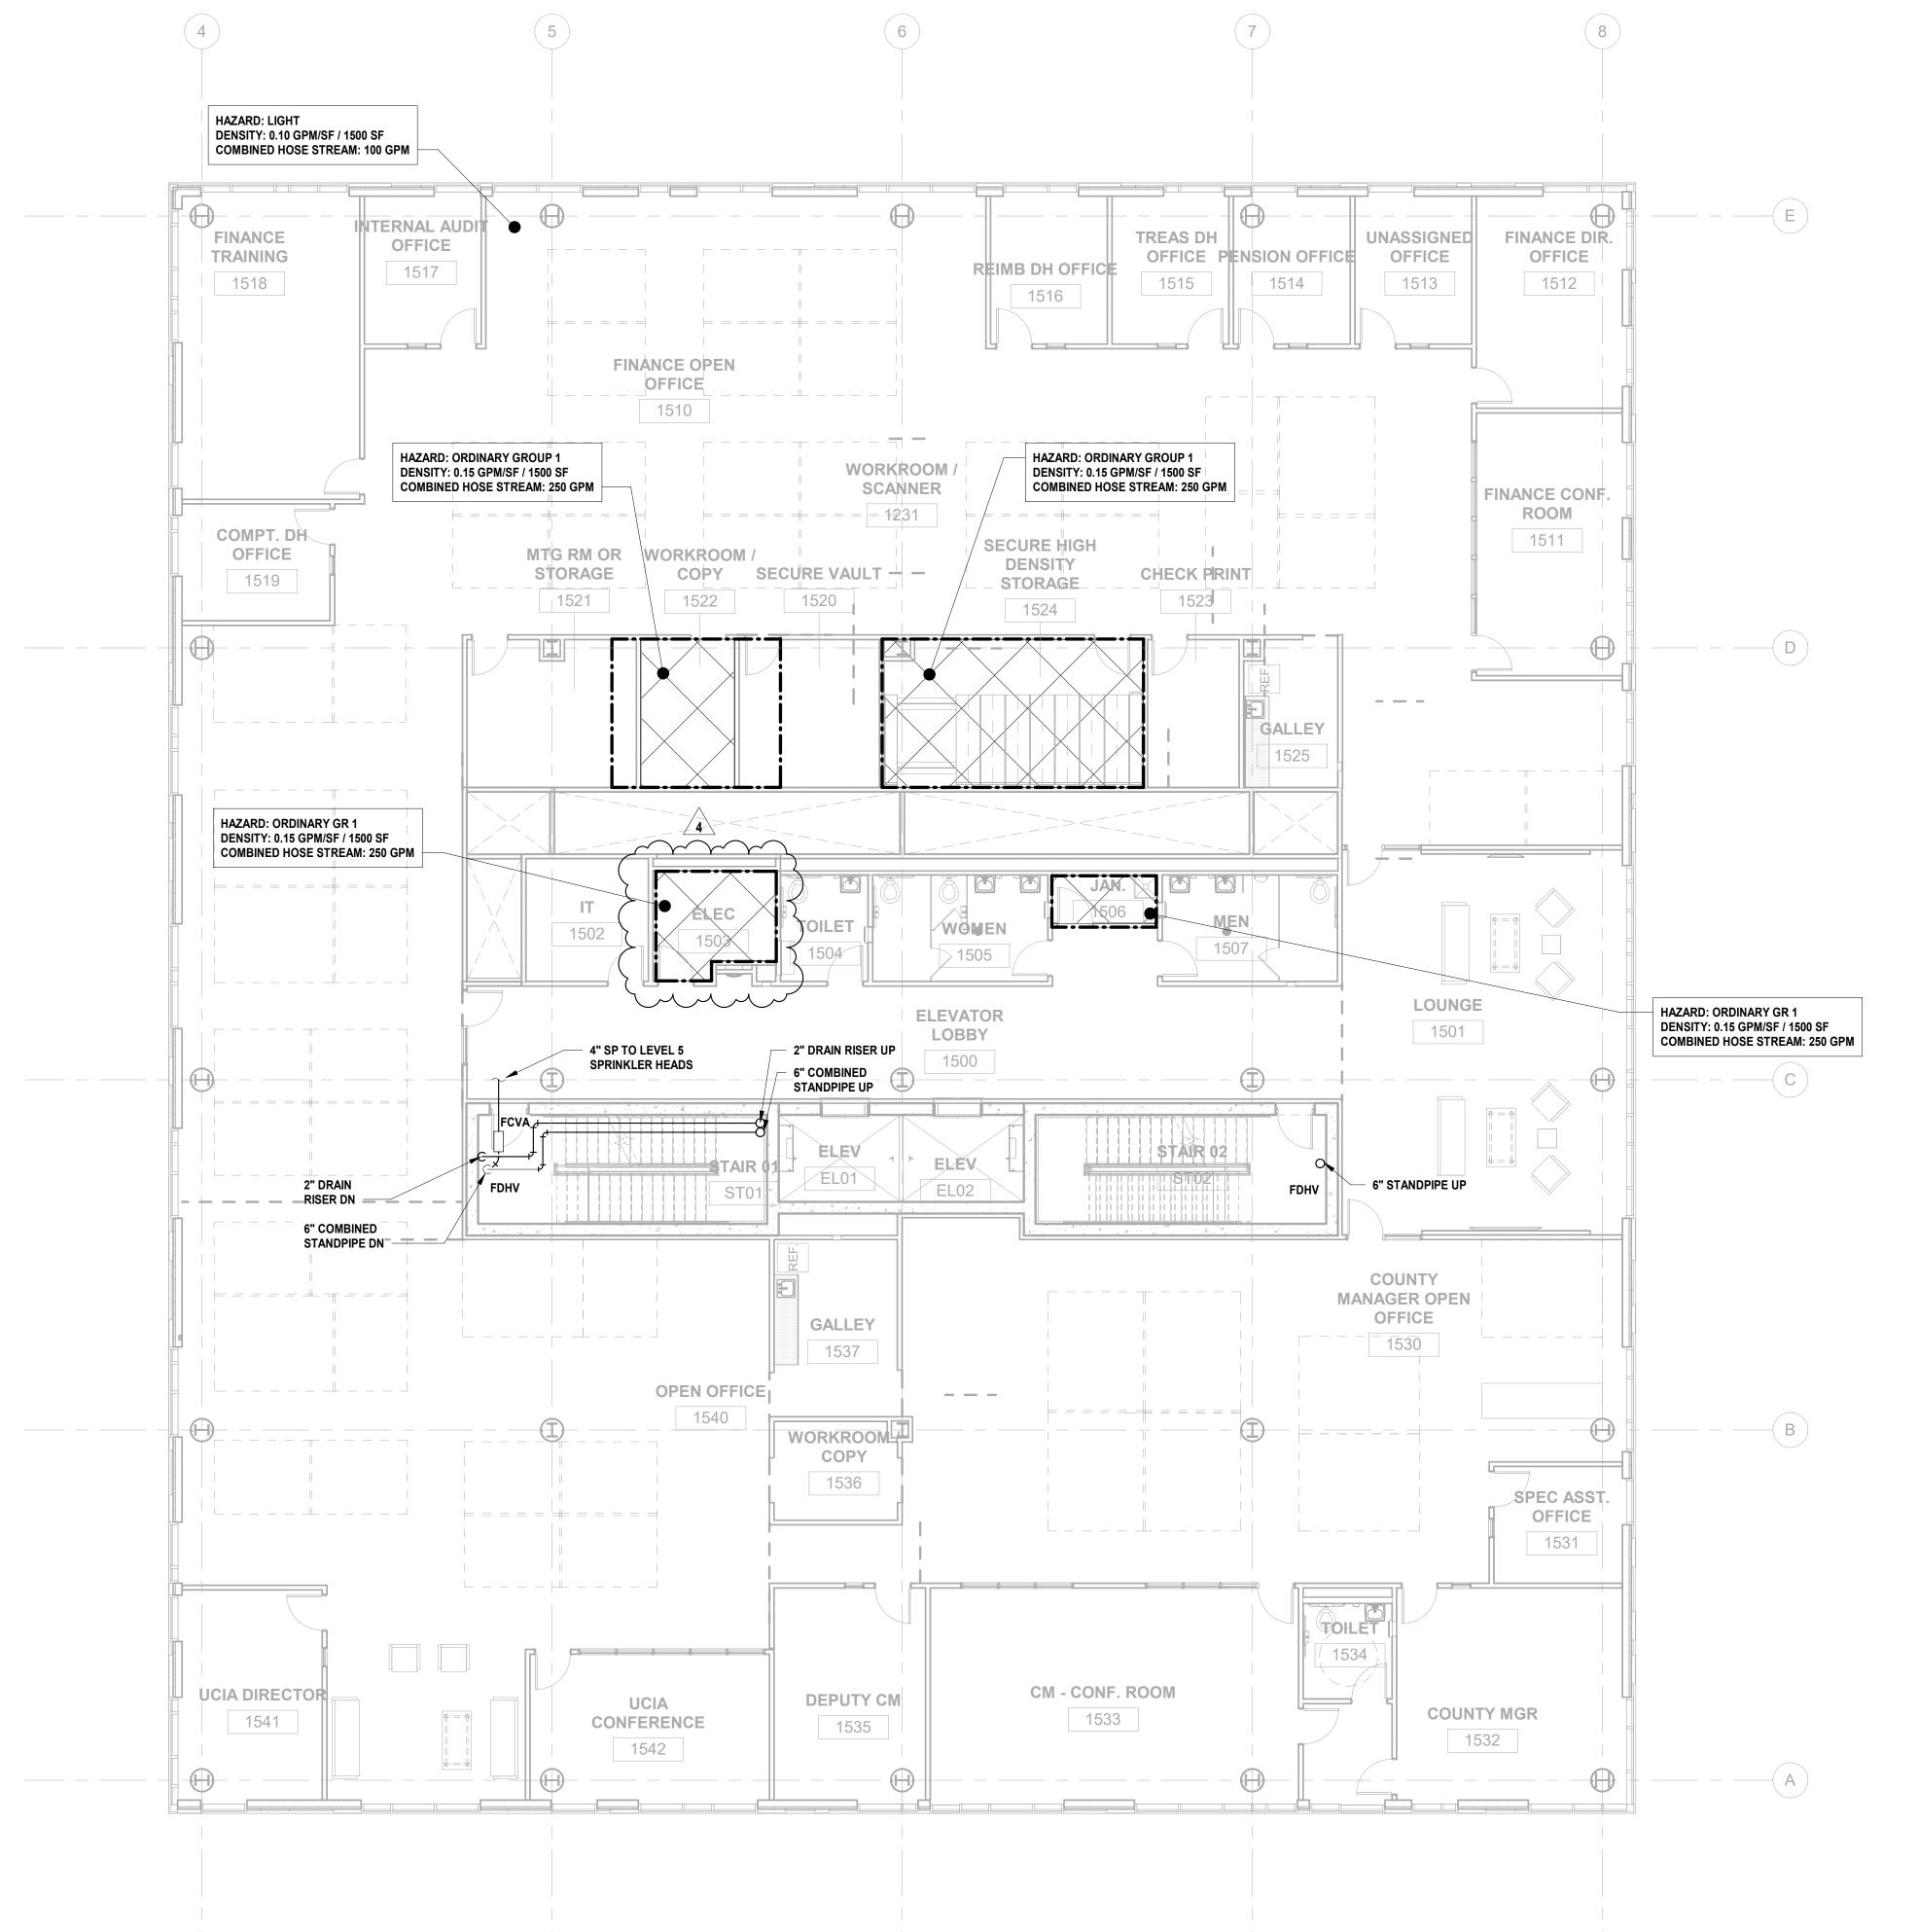
Project No: 20.072
Date: 11.08.2023
Drawn By: JB/AV/PC
Checked By: JM/SH

Sheet Name:
BUILDING NO. 1 - LEVEL 4 - FIRE

eet No:







1 BUILDING NO. 1 - LEVEL 5 - FIRE PROTECTION
SCALE: 1/8" = 1'-0"

FIRE PROTECTION GENERAL NOTES:


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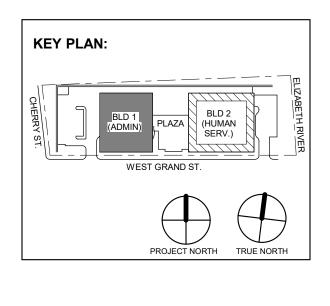
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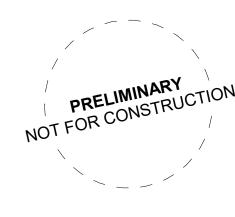


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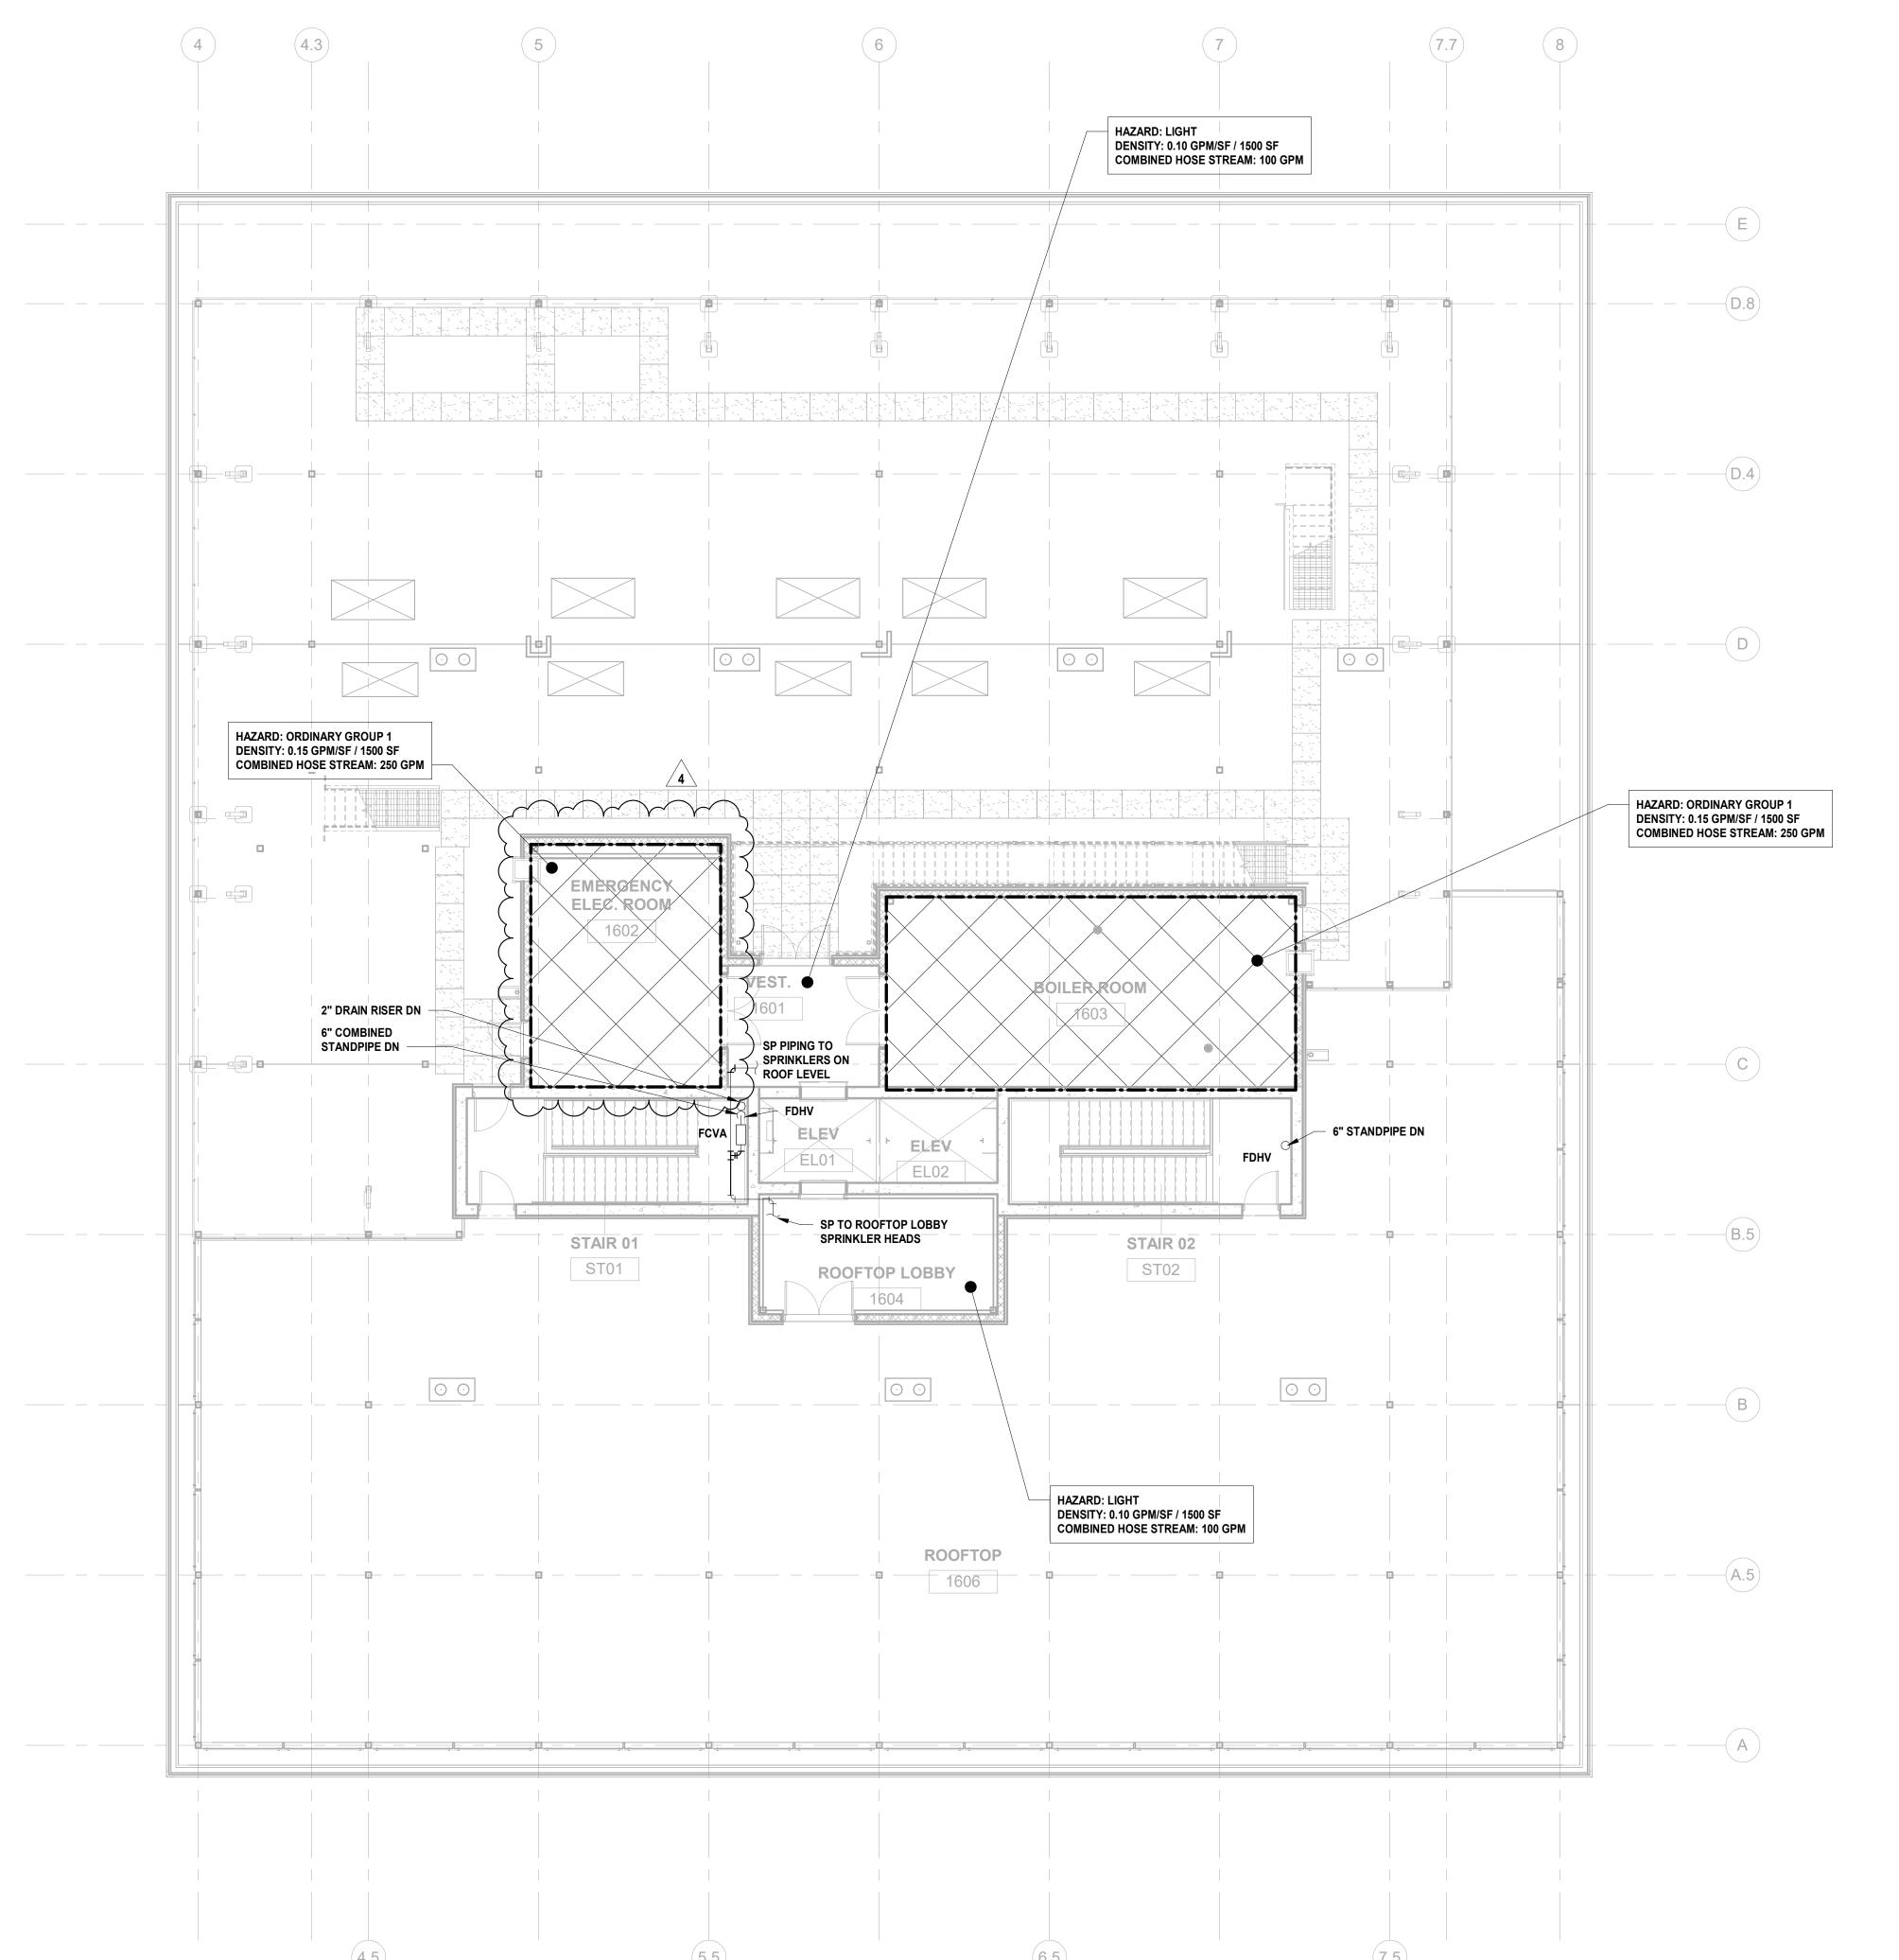
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Drawing Information: Project No: 20.072 Date: 11.08.2023 Drawn By: JB/AV/PC Checked By: JM/SH

BUILDING NO. 1 - LEVEL 5 - FIRE



1 BUILDING NO. 1 - ROOF - FIRE PROTECTION
SCALE: 1/8" = 1'-0"

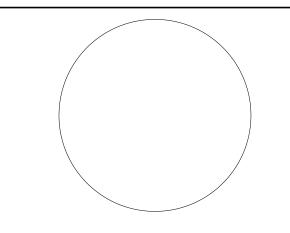FIRE PROTECTION GENERAL NOTES:


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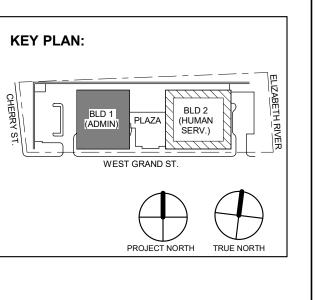
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JRM
PROJECT No:
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DATE:
SCALE:
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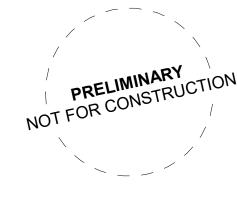
3 12.15.2023 Addendum No. 03 11.08.2023 For Public Bid No. Date Description

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Drawing Information: Project No: 20.072
Date: 11.08.2023
Drawn By: JB/AV/PC
Checked By: JM/SH

BUILDING NO. 1 - ROOF - FIRE

1 BUILDING NO. 2 - LEVEL 0 - FIRE PROTECTION
SCALE: 1/8" = 1'-0"

INCOMING 6" FIRE SERVICE AT 54" MIN BELOW GRADE. SEE CIVIL PLANS FOR CONTINUATION.

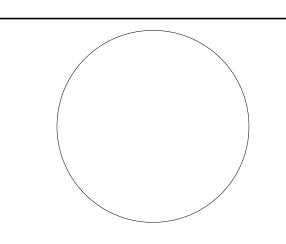FIRE PROTECTION GENERAL NOTES:

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+
engineer


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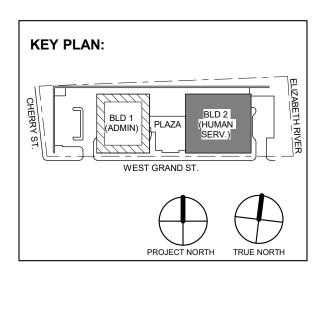


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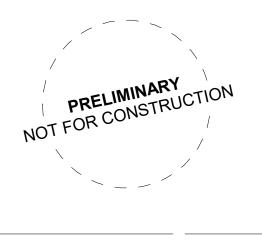
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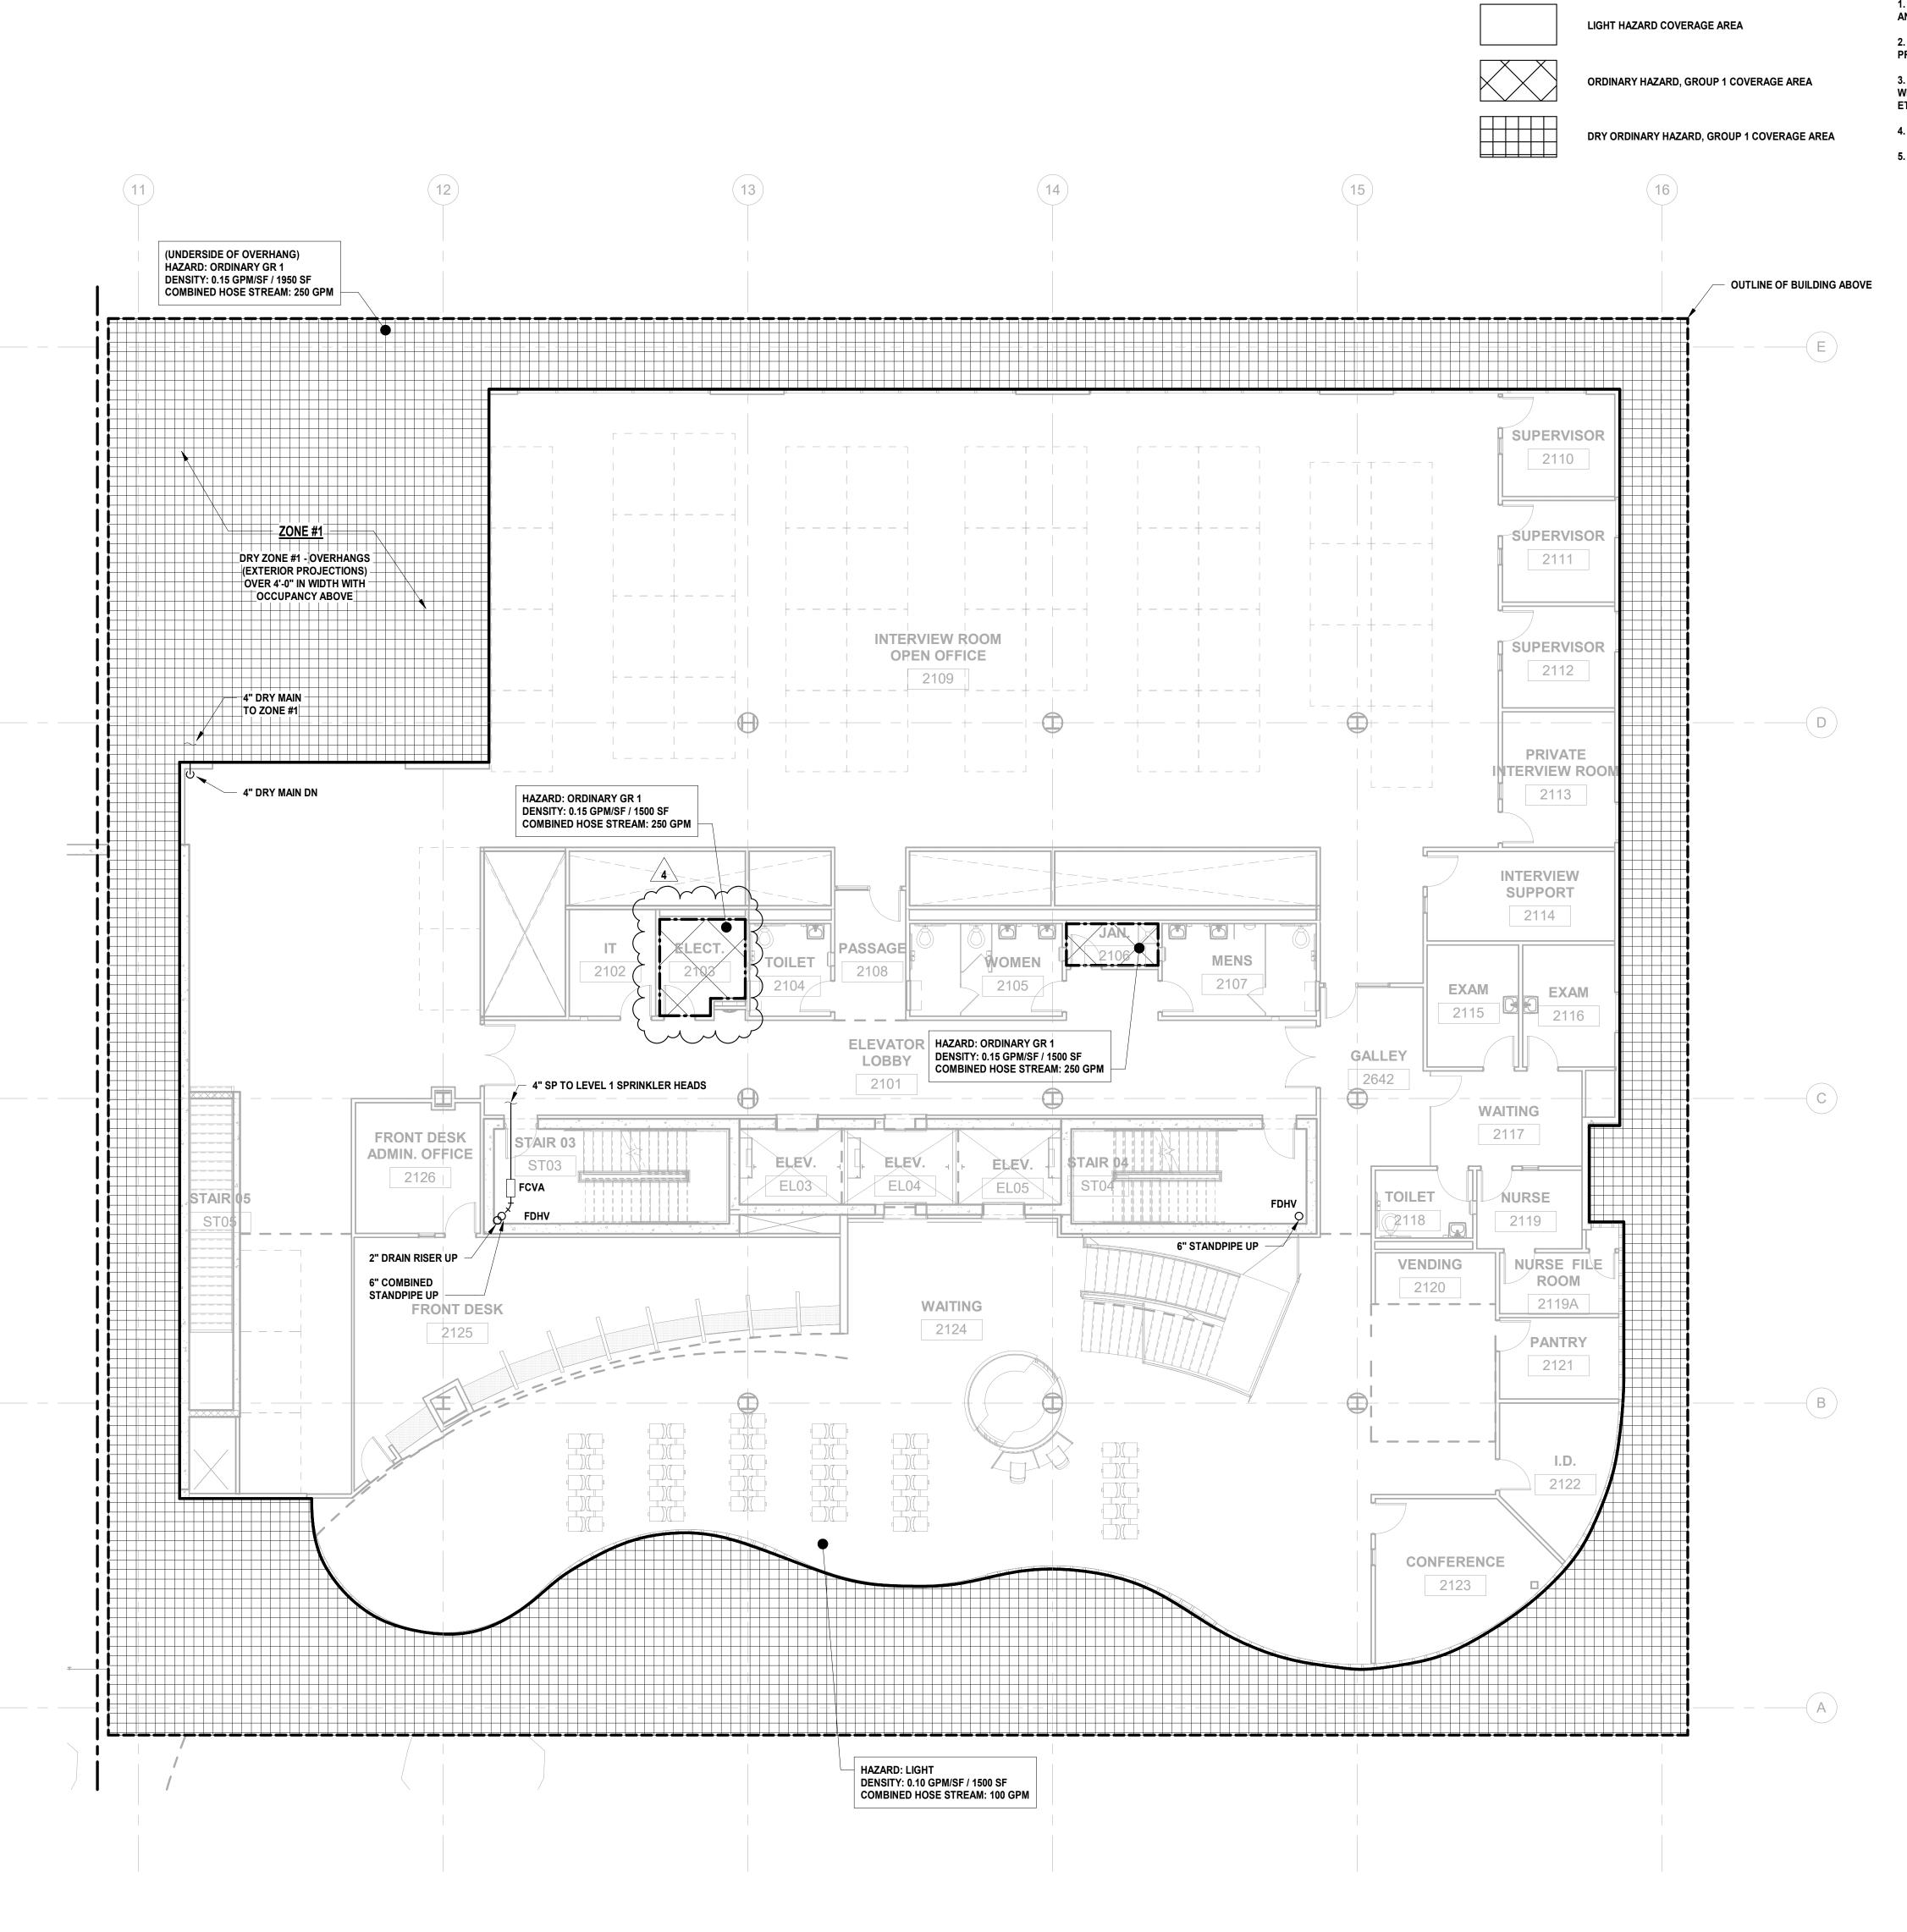
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Checked By: JM/SH

Sheet Name:

BUILDING NO. 2 - LEVEL 0 - FIRE PROTECTION PLAN

eet No:

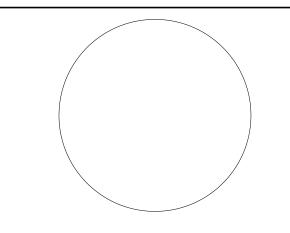FP-109



1 BUILDING NO. 2 - LEVEL 1 - FIRE PROTECTION
SCALE: 1/8" = 1'-0"

FIRE PROTECTION GENERAL NOTES:

FIRE PROTECTION LEGEND:

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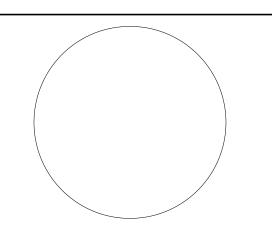
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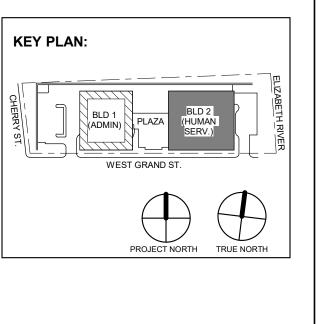
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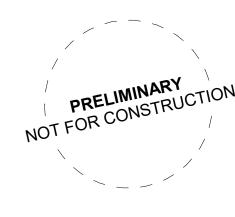
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Drawing Information:

Project No: 20.072
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Drawn By: JB/A/PC

Date: 11.08.2023
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Sheet Name:

BUILDING NO. 2 - LEVEL 1 - FIRE PROTECTION PLAN

et No:


FP-110

1 BUILDING NO. 2 - LEVEL 2 - FIRE PROTECTION SCALE: 1/8" = 1'-0"




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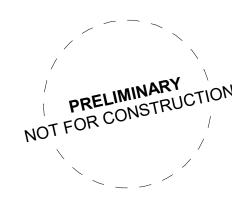


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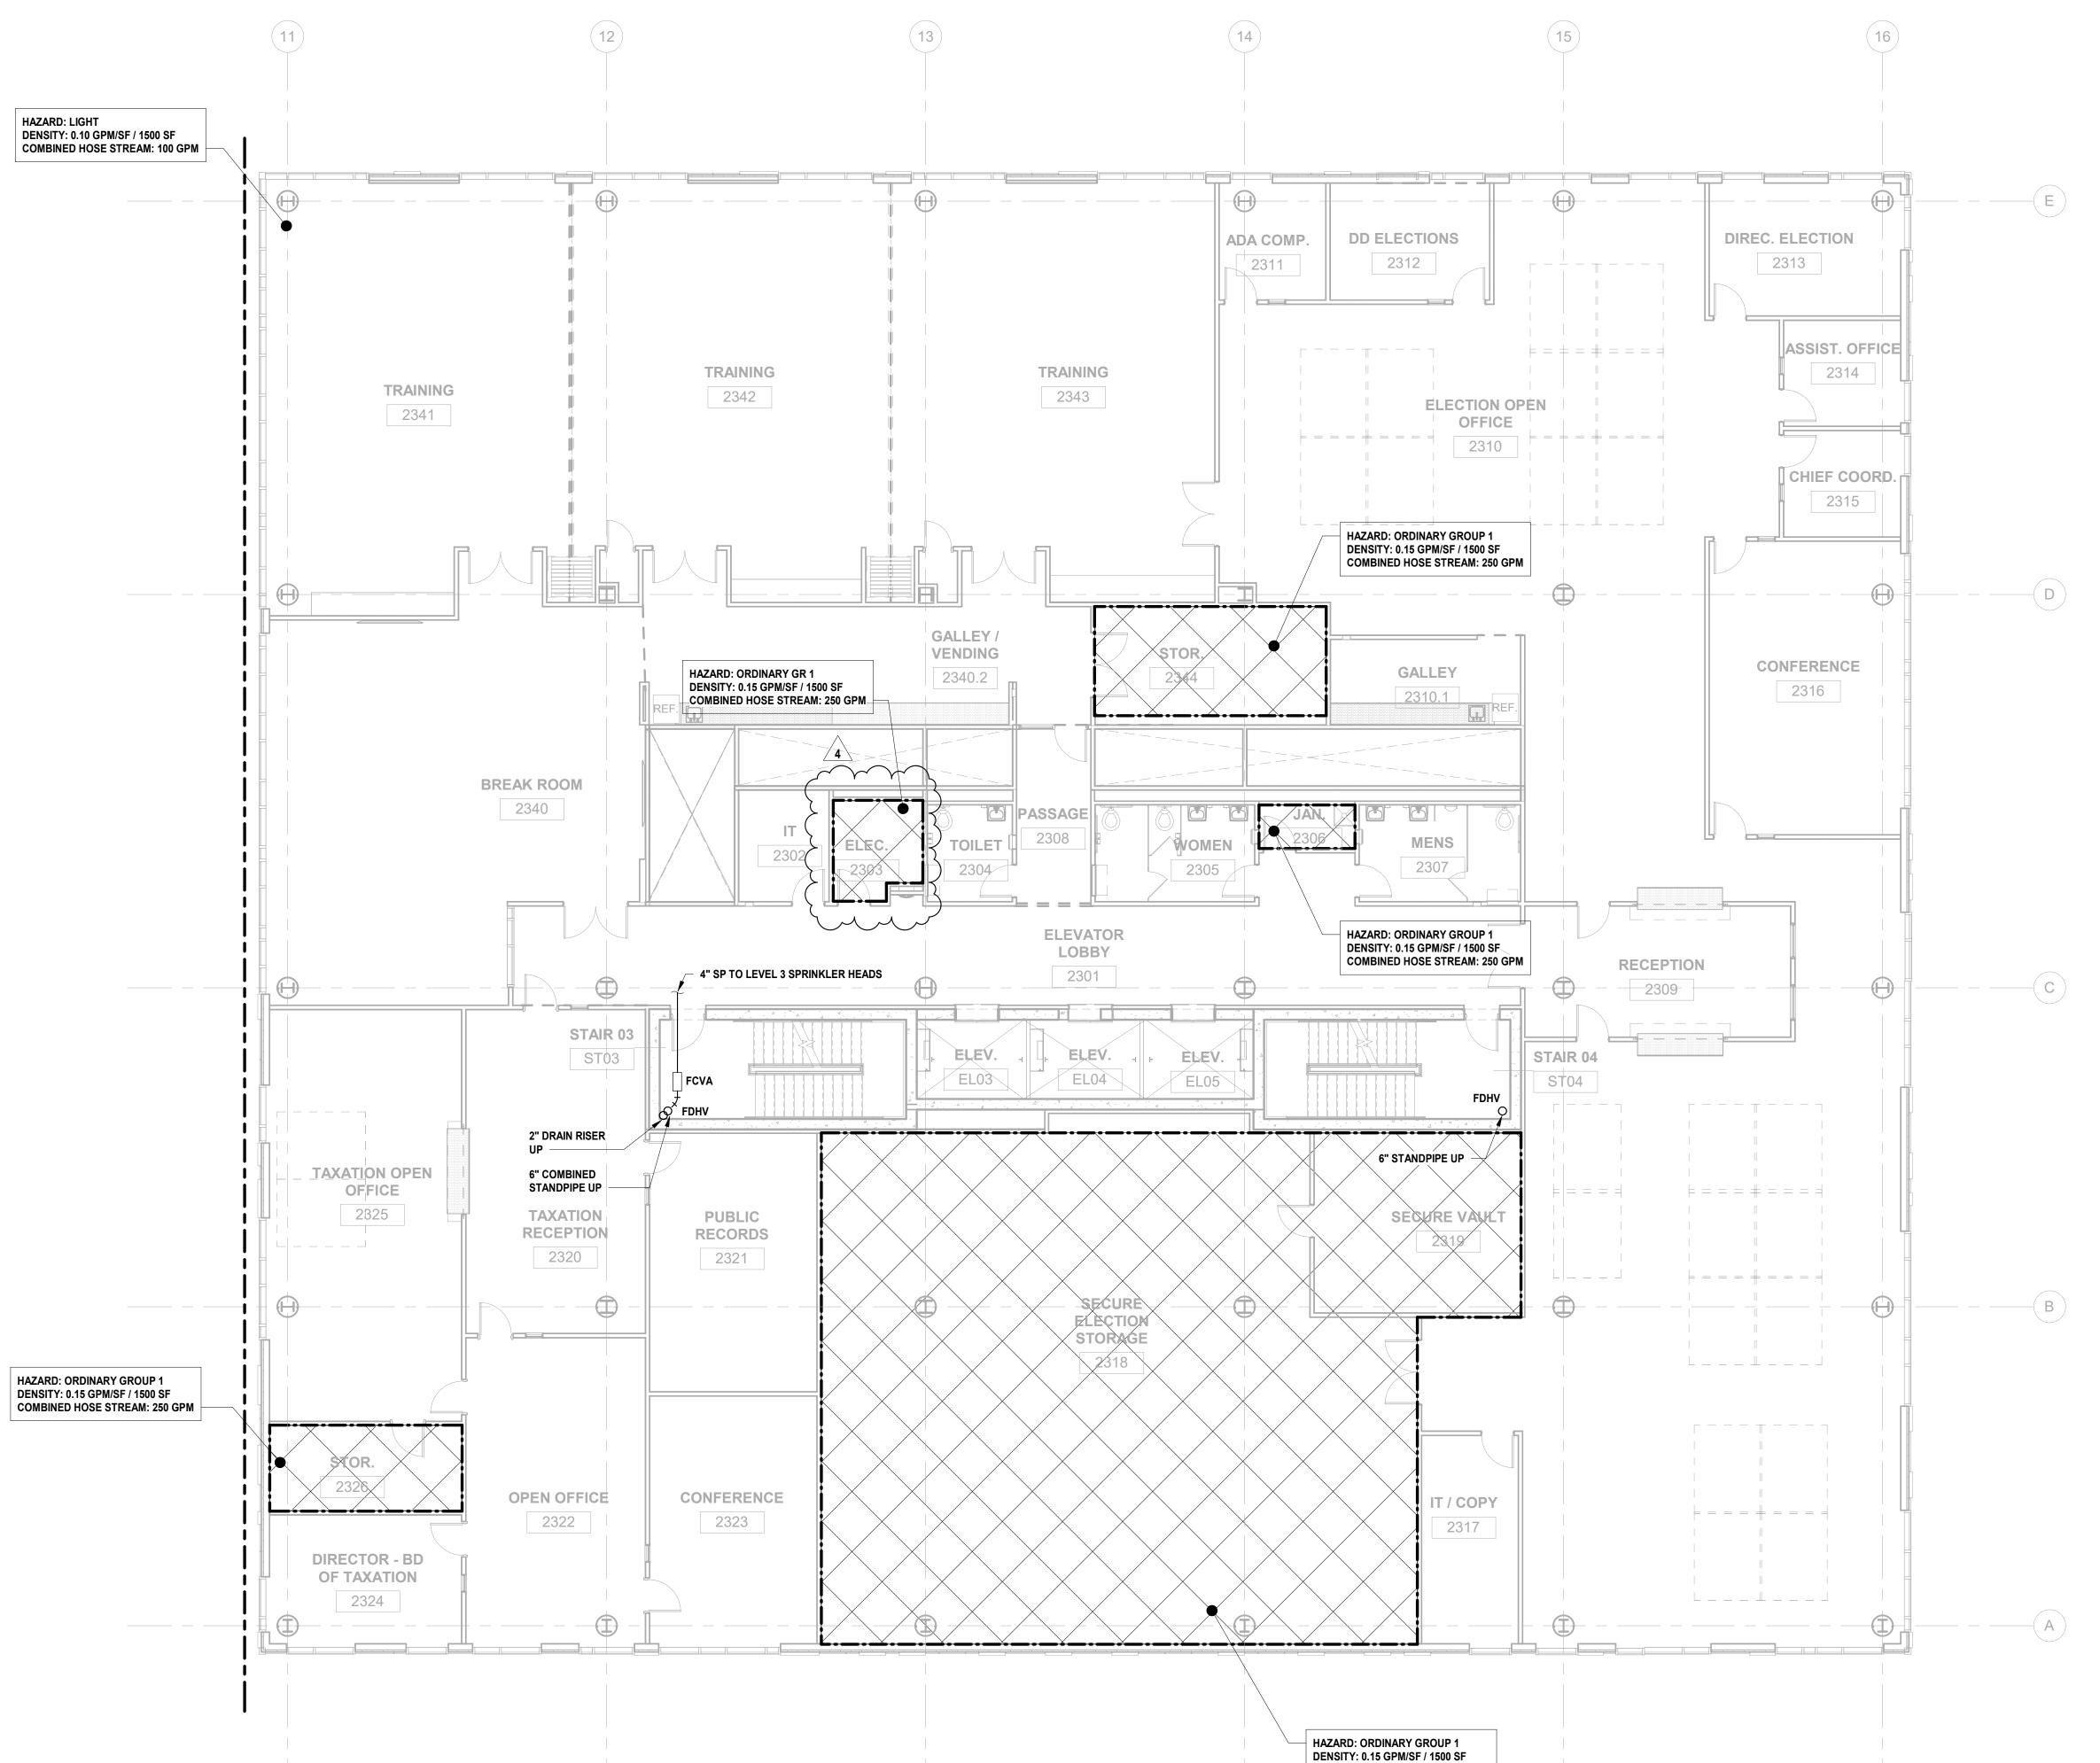
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Drawing Information: Project No: 20.072 Date: 11.08.2023 Drawn By: JB/AV/PC

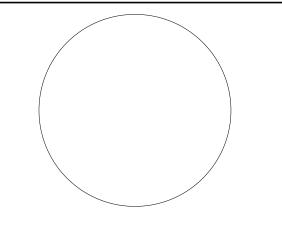Checked By: JM/SH **BUILDING NO. 2 - LEVEL 2 - FIRE**

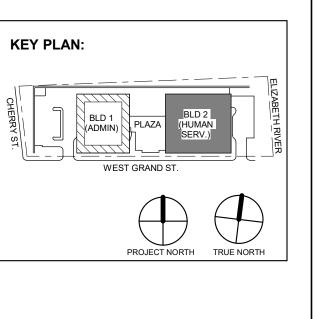

1 BUILDING NO. 2 - LEVEL 3 - FIRE PROTECTION SCALE: 1/8" = 1'-0"

COMBINED HOSE STREAM: 250 GPM

FIRE PROTECTION GENERAL NOTES:


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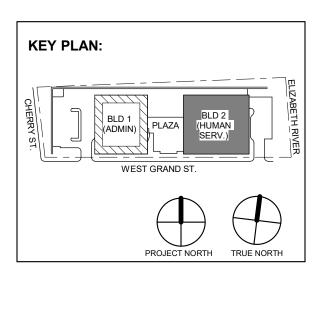
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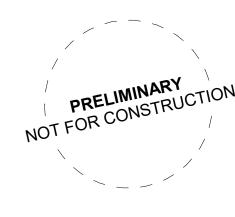


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BUILDING NO. 2 - LEVEL 3 - FIRE

1 BUILDING NO. 2 - LEVEL 4 - FIRE PROTECTION SCALE: 1/8" = 1'-0"

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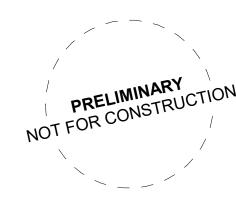
KEY PLAN:

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BUILDING NO. 2 - LEVEL 4 - FIRE

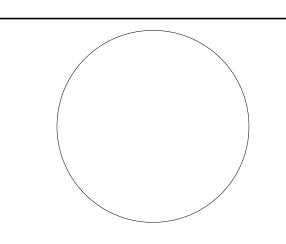1 BUILDING NO. 2 - LEVEL 5 - FIRE PROTECTION SCALE: 1/8" = 1'-0"


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4. PROVIDE SPRINKLER COVERAGE UNDER OBSTRUCTIONS AS REQUIRED BY NFPA-13. 5. PROVIDE ADDITIONAL SPRINKLER HEADS TO COMPLY WITH NFPA COVERAGE.

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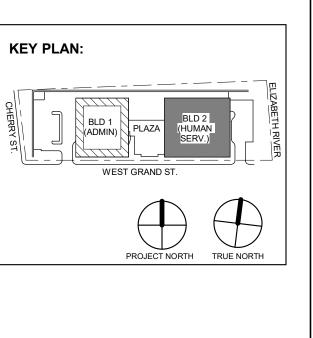
DRAWN BY:

CHECKED BY:

REVIEWED BY:

JRM

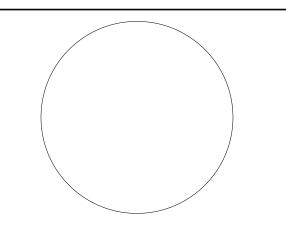JRM DJECT No: DATE: SCALE: AS SHOWN




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ARCHITECTURE FOR CHANG

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Jeffrey D. Venezia, AIA NJ RA AI 00827100

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UNION COUNTY GOVERNMENT COMPLEX 81 & 93 WEST GRAND STREET CITY OF ELIZABETH NEW JERSEY, 07202

Drawing Information: Project No: 20.072 Date: 11.08.2023 Drawn By: JB/AV/PC Checked By: JM/SH

BUILDING NO. 2 - LEVEL 5 - FIRE PROTECTION PLAN

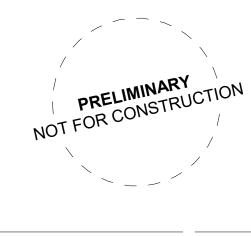1 BUILDING NO. 2 - LEVEL 6 - FIRE PROTECTION
SCALE: 1/8" = 1'-0"

FIRE PROTECTION GENERAL NOTES:

1. REFER TO FIRE PROTECTION LEAD SHEET, FP-001 FOR GENERAL NOTES, SYMBOLS, ABBREVIATIONS, AND PROJECT SCOPE DESCRIPTIONS FOR THIS PROJECT.

2. ALL SYSTEMS SHALL BE DESIGNED ON A HYDRAULICALLY CALCULATED BASIS BY THE FIRE PROTECTION CONTRACTOR.

3. THE FIRE PROTECTION CONTRACTOR SHALL COORDINATE THE INSTALLATION OF THE ENTIRE SYSTEM WITH ALL BUILDING ELEMENTS INCLUDING BUT NOT LIMITED TO, PIPING, DUCTWORK, LIGHTING FIXTURES,


4. PROVIDE SPRINKLER COVERAGE UNDER OBSTRUCTIONS AS REQUIRED BY NFPA-13.

5. PROVIDE ADDITIONAL SPRINKLER HEADS TO COMPLY WITH NFPA COVERAGE.

architect + engineer

H2M Associates, Inc.

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Parsippany, NJ 07054
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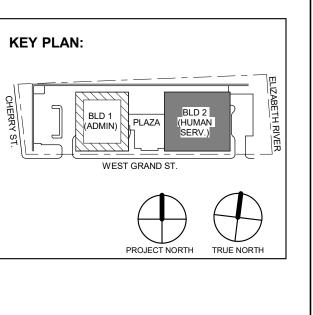


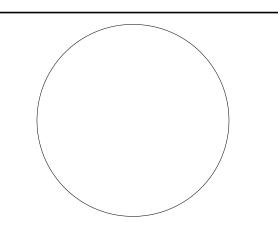JONATHAN R. MURATORE, P.E.

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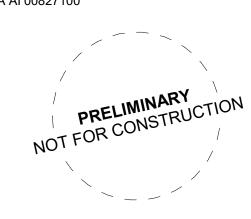
4 12.22.2023 Addendum No. 04 11.08.2023 For Public Bid No. Date Description

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Checked By: JM/SH

Sheet Name:

BUILDING NO. 2 - LEVEL 6 - FIRE PROTECTION PLAN

et No:

FP-115

4' 8' 16'

*ALE BAR: 1/8"=1'-0"

FP-116

PROTECTION PLAN

H2M Associates, Inc.

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NJ Landscape Architecture Certificate No.: 21MH00010300
NJ Engineering Certificate of Authorization No.: 24GA28019100

JONATHAN R. MURATORE, P.E.
NJ PROFESSIONAL ENGINEER LIC. No. 24GE05698300

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CRG

CRG

CRG

CRG

DRAWN BY:

CHECKED BY:

REVIEWED BY:

CRG

JRM

JRM

KEY PLAN:

 4
 12.22.2023
 Addendum No. 04

 11.08.2023
 For Public Bid

 No.
 Date
 Description

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UNION COUNTY GOVERNMENT

BUILDING NO. 2 - ROOF - FIRE

81 & 93 WEST GRAND STREET CITY OF ELIZABETH NEW JERSEY, 07202

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Drawing Information:

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Project No: 20.072
Date: 11.08.2023
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Checked By: JM/SH


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OJECT No: DATE: SCALE:

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BUILDING NO. 1 - ENLARGED FIRE PUMP ROOM

6" DOUBLE CHECK VALVE BACKFLOW PREVENTION 8" SP TO FIRE PUMP TEST HEADER. 4" DSP TO DRY SPRINKLER ZONE #1. DEVICE. CONTRACTOR TO BE RESPONSIBLE TO OBTAIN SEE PLAN FP 109 FOR CONTINUATION. SEE PLAN FP 109 FOR CONTINUATION. ALL PERMITS RELATED TO THE NEW BACKFLOW DEVICE. 6" SP TO BUILDING 2. SEE PLAN FP 109 FOR CONTINUATION. PROVIDE A MINIMUM LENGTH OF 22" OF - 6" SP TO FDC. SEE PLAN FP 109 FOR CONTINUATION. 8' X 5' CONCRETE PAD COORDINATE STRAIGHT PIPE TO ALLOW FOR PAD INSTALLATION WITH G.C. INSTALLATION OF DETECTOR CHECK - FDC CHECK VALVE. PROVIDE BALL DRIP ASSEMBLY BY LIBERTY WATER COMPANY. **JOCKEY PUMP JP2-1** DRAIN AND PIPE TO DISCHARGE TO **NEAREST FLOOR DRAIN** 6" FIRE SERVICE RISE WITH OS&Y FIRE PUMP FP2-1 - 6" SP RISE WITH OS&Y SHUTOFF SHUT OFF VALVE W/ TAMPER SWITCH -**VALVE W/ TAMPER SWITCH AND** WET ALARM CHECK VALVE - AIR COMPRESSOR. FP CONTRACTOR TO DETERMINE FINAL SIZE BASED ON VOLUME OF DRY SPRINKLER SYSTEM PIPING. 6" SP RISE TO FIRE PUMP FIRE PUMP BYPASS LOOP CONTROLLER 2" SP TO JOCKEY PUMP OS&Y SHUT OFF VALVE W/ JOCKEY PUMP TAMPER SWITCH. TYP. CONTROLLER CHECK VALVE. TYP. INCOMING 6" FIRE SERVICE MIN 54" BELOW 4" SP RISE WITH OS&Y SHUTOFF GRADE. SEE CIVIL PLANS FOR CONTINUATION. -VALVE W/ TAMPER SWITCH AND DRY ALARM CHECK VALVE DOMESTIC BOOSTER PUMP (BY P.C.) -

2 BUILDING NO. 2 - ENLARGED FIRE PUMP ROOM

FIRE PROTECTION GENERAL NOTES:

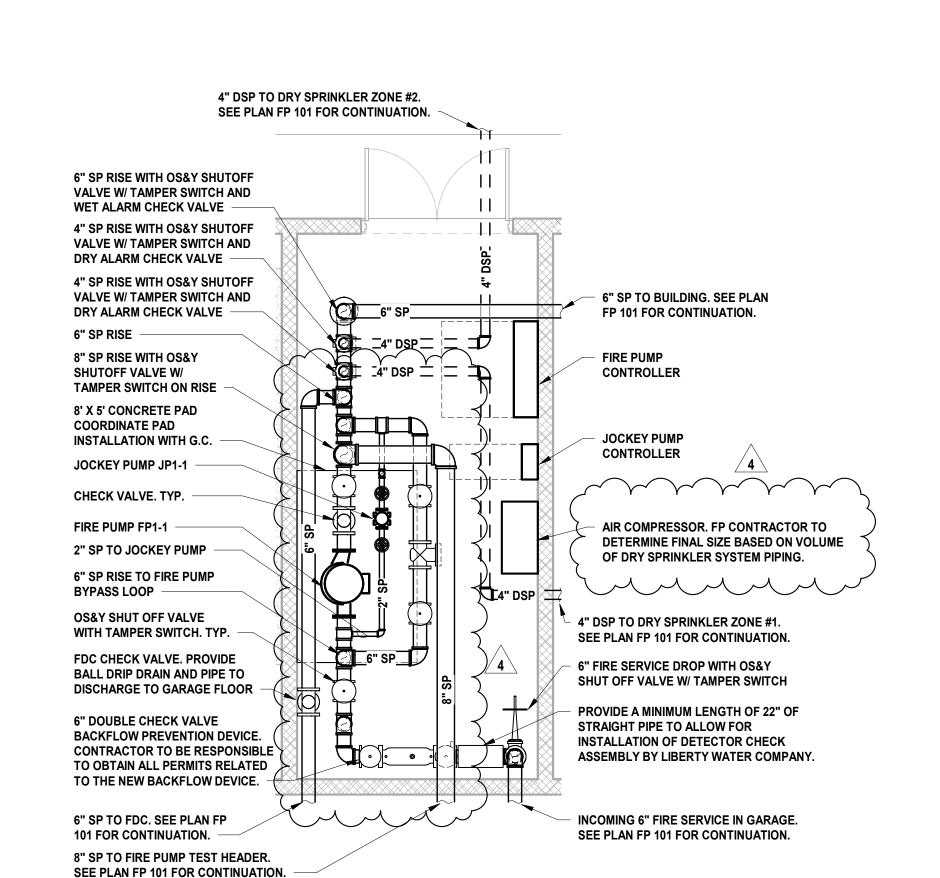1. REFER TO FIRE PROTECTION LEAD SHEET, FP-001 FOR GENERAL NOTES, SYMBOLS, ABBREVIATIONS, AND PROJECT SCOPE DESCRIPTIONS FOR THIS PROJECT.


2. ALL SYSTEMS SHALL BE DESIGNED ON A HYDRAULICALLY CALCULATED BASIS BY THE FIRE PROTECTION CONTRACTOR.

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4. PROVIDE SPRINKLER COVERAGE UNDER OBSTRUCTIONS AS REQUIRED BY NFPA-13. 5. PROVIDE ADDITIONAL SPRINKLER HEADS TO COMPLY WITH NFPA COVERAGE.

engineers

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JONATHAN R. MURATORE, P.E.

ALTERATION C.
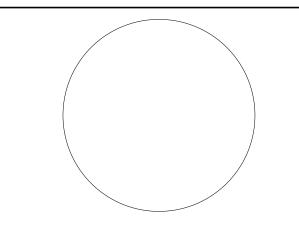
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N BY: CHECKED BY: REVIEWED BY: JRM DIGA2301 12.22.2023 AS SHOWN

KEY PLAN:

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Drawing Information: Project No: 20.072 Date: 11.08.2023 Drawn By: JB/AV/PC Checked By: JM/SH

Sheet Name: BUILDING NO. 1 - FIRE

PROTECTION ENLARGED PLANS Sheet No:

FP-301